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# JAC CONDOS

308-314 Jarvis Street & 225 Mutual Street, Toronto, Ontario, Canada

18.189CS

	SPA DRAWING LIST	
Sheet Number	Sheet Name	
SPA000	COVER SHEET	$\neg$
SPA001A	STATISTICS BYLAW 569-2013	-
SPA001B	STATISTICS BYLAW 569-2013	-
SPA002	SURVEY	$\dashv$
SPA003	CONTEXT PLAN	-
SPA004	TGS CHECKLIST	
SPA005	SITE PLAN / ROOF PLAN	-
SPA006	RESIDENTIAL SOLID WASTE MANAGEMENT	
SPA101	UNDERGROUND LEVEL 02	-
SPA101	UNDERGROUND LEVEL 02	-
SPA102	UNDERGROUND NORTHEAST CORNER	-
SPA151	FLOOR 01	-
SPA151	FLOOR 02	-
SPA152 SPA153	FLOOR 02 FLOOR 03	-
SPA154	FLOOR 04	$\dashv$
SPA155	FLOOR 05-06	
SPA157	FLOOR 07	
SPA158	FLOOR 08	
SPA159	FLOOR 09	
SPA160	FLOOR 10	
SPA161	FLOOR 11	_
SPA162	FLOOR 12-34	_
SPA165	M.P.H.	
SPA301	EAST AND NORTH ELEVATIONS	
SPA302	WEST AND SOUTH ELEVATIONS	
SPA311A	1 TO 50 EAST ELEVATION PART A	
SPA311B	1 TO 50 EAST ELEVATION PART B	
SPA312A	1 TO 50 WEST ELEVATION PART A	
SPA312B	1 TO 50 WEST ELEVATION PART B	
SPA313A	1 TO 50 SOUTH ELEVATION PART A	
SPA313B	1 TO 50 SOUTH ELEVATION PART B	
SPA314A	1 TO 50 NORTH ELEVATION PART A	
SPA314B	1 TO 50 NORTH ELEVATION PART B	
SPA315	OVERHEARD GARAGE DOORS	
SPA321	BIRD FRIENDLY ELEVATIONS	
SPA331	JARVIS STREET ELEVATION	
SPA332	MUTUAL STREET ELEVATION	
SPA401	NORTH-SOUTH SECTION	
SPA402	WEST-EAST SECTION	
SPA801	3D PERSPECTIVES	
SPA802	3D PERSPECTIVES	
SPA811	SHADOW STUDY - MARCH	
SPA812	SHADOW STUDY - MARCH	
SPA813	SHADOW STUDY - MARCH	
SPA815	SHADOW STUDY - JUNE	
SPA816	SHADOW STUDY - JUNE	
SPA817	SHADOW STUDY - JUNE	
SPA819	SHADOW STUDY - SEPTEMBER	
SPA820	SHADOW STUDY - SEPTEMBER	$\neg$
SPA821	SHADOW STUDY - SEPTEMBER	$\neg$
SPA900	SARIS BIKE RACK DETAILS	$\neg$



LOCATION PLAN NTS



# TURNER FLEISCHER

**67 Lesmill Road** Toronto, ON, M3B 2T8 turnerfleischer.com

# **ISSUED FOR SPA** 08/21/2020



TURNER FLEISCHER **ARCHITECT** 

**Turner Fleischer Architects Inc** 67 Lesmill Road Toronto, Ontario, M3B 2T8

Tel: 416 425 2222 Fax: 416 425 6717 Contact: Anita Yu E-mail: anita@turnerfleischer.com



**ALEXANDER BUDREVICS + ASSOCIATES LTD** 895 Don Mills Road, Second Tower, Suite 212 Tel: 416 444 5201 E-mail: daniel@odantech.com Contact: Arnis Budrevics E-mail: arnis@budrevics.ca



SITE SERVICES

The Odan/Detech Group Inc. 701 Rossland Road, Suite 201 Whitby, Ontario, L1N 8Y9 Tel: 905 632 3811 Contact: Daniel Bancroft



**MECHANICAL / ELECTRICAL** 

M.V. Shore Associates Limited 402-1200 Eglinton Ave E North York, Ontario, M3C 1H9 Tel: 416 443 1995 Contact: Bill Chan E-mail: bc@mvshore.com



**TRANSPORTATION** 

BA CONSULTING GROUP LTD. 45 St. Clair Ave. W. Suite 300 Toronto, Ontario, M4V 1K9 Tel: 416 961 7110 Contact: Steve Krossey E-mail: Krossey@bagroup.com



**STRUCTURE** 

**Jablonsky Ast & Partners** 1129 Leslie St, North York, Ontario M3C 2K5 Tel: 416 447 7405 Contact: Paul Ast & Jeff Watson E-mail: jap@astint.on.ca jwatson@astint.on.ca



**INTERIOR DESIGN** 

**Tomas Pearce Interior Design** Consulting Inc. 131 Miranda Ave, Toronto, ON M6B 3W8 Tel: 416 588 2088 Contact: Melandro Quilatan E-mail: mel@tomaspearce.com



**ENERGY MODEL** 

**EQ Building Performance** 20 Floral Pkwy, Concord, Ontario Ĺ4K 4R1 Tel: 416 645 1186 Contact: Craig McIntyre E-mail: cmcintyre@eqbuilding.com



Goldsmith Borgal & **Company Ltd. Architects** 362 Davenport Road, Suite 100, Toronto ON M5R 1K6 Tel: 416 929 6556 Contact: Sharon Vattay E-mail: sharon@gbca.ca  $KRCM\overline{\Lambda}R$ 

**SURVEYOR** 

**Krcmar Surveyors Ltd** 1137 Centre St Thornhill, Ontario, L4J 3M6 Tel: 905 738 0053 Contact: Sasa Krcmar E-mail: sasa@krcmar.ca

## 18.189CS - 308-314 Jarvis Street + 225 Mutual Street

TORONTO, ONTARIO

#### **PROJECT SUMMARY**

LAND USE	m²	ft²	%
BUILDING COVERAGE (GROUND FLOOR)	1,823.6	19,629	56.9%
OUTDOOR AMENITY	225.0	2,422	7.0%
LANDSCAPED OPEN SPACE	335.9	3,616	10.5%
PAVED AREA	820.2	8,828	25.6%
TOTAL SITE AREA	3,204.6	34,495	100.0%

#### PROJECT INFORMATION

ESTABLISHED GRADE

	REQUIRED	PROVIDED
BUILDING HEIGHT EXCLU. M.P.H.	103.5M (34 STOREYS)	103.5M (34 STOREYS)
BUILDING HEIGHT INCLU. M.P.H.	108.5M	108.5M
PODIUM HEIGHT JARVIS STREET	31.5M (10 STOREYS)	31.5M (10 STOREYS)
PODIUM HEIGHT MUTUAL STREET	10.5M (3 STOREYS)	10.5M (3 STOREYS)

PODIUM SETBACKS	REQUIRED	PROVIDED
EAST SETBACK (FRONTING JARVIS STREET)	5.5 M	5.5 M
EAST STEPBACK 7TH FLOOR	14.25 M	15.00 M
EAST STEPBACK 10TH FLOOR	11.05 M	11.05 M
WEST SETBACK (FRONTING MUTUAL STREET)	3.5 M TO 3.7 M	3.55 M TO 3.75 M

99.0 M

978.0

TOTAL

10,527

99.0 M

### **GROSS FLOOR AREA SUMMARY AS PER BY-LAW NO.569-2013**

USE	GFA	FSI	
	m²	ft²	
RETAIL/OFFICE	242.7	2,613	0.1
TOTAL NON-RESIDENTIAL	242.7	2,613	0.1
NON SALEABLE (RESIDENTIAL)	4,125.6	44,407	1.3
SALEABLE (RESIDENTIAL)	27,965.9	301,022	8.7
TOTAL RESIDENTIAL (INCLUDING EXCESS INDOOR AMENITY)	32,091.5	345,430	10.0
TOTAL (INCLUDING EXCESS INDOOR AMENITY)	32,334.3	348,043	10.1
TOTAL FLOOR AREA [TFA] (NO EXLUSIONS)	41,520.3	446,920.3	
INDOOR AMENITY PROVIDED	978.0	10,528	0.3

TOWER SETBACKS	REQUIRED	PROVIDED	
NORTH SETBACK	1.6 M	1.65 M	
SOUTH SETBACK	24.2 M	24.2 M	
EAST SETBACK (FRONTING JARVIS STREET)	23.2 M	23.5 M	
SOUTH-WEST SETBACK	10.3 M	10.3 M	
WEST SETBACK (FRONTING MUTUAL STREET)	10.7 M	10.8 M	

#### **GROSS FLOOR AREA SUMMARY AS PER BY-LAW NO.438-86**

USE	GF/	\	FSI	
	m²	ft²		
RETAIL/OFFICE	242.7	2,613	0.1	
TOTAL NON-RESIDENTIAL	242.7	2,613	0.1	
TOTAL RESIDENTIAL (INCLUDING EXCESS INDOOR AMENITY)	32,844.1	353,531	10.2	
TOTAL GFA (INCLUDING EXCESS INDOOR AMENITY)	33,086.9	356,144	10.3	
TOTAL FLOOR AREA [TFA] (NO EXLUSIONS)	41,520.3	446,920.3		
TOTAL GFA IN SETTLEMENT NOVEMBER 28, 2017	33,676.0	362,485	10.5	

#### AREA CALCULATION BREAKDOWN (BY-LAW NO.569-2013)

SUMMARY

INDOOR AMENITY (REQUIRED) EXCL. FROM GFA

INDOOR AMENITY (EXCESS) INCL. IN GFA

FLOOR	1,000	TAL	TOTA	2,0440	GROSS FLOOR A	AUGUST AND
TLOOK	RETAIL/	OFFICE	RESIDEN	ITIAL	(TFA - EXCLU	JSIONS)
	m²	ft²	m²	ft²	m²	ft²
UG2			70.3	757	70.3	757
UG1			67.2	1,122	67.2	723
BASEMENT(HB)			14.7		14.7	159
1	242.7	2,613	874.7	9,415	1,117.4	12,028
2			1,842.7	19,835	1,842.7	19,835
3			1,961.8	21,116	1,961.8	21,116
4			1,736.4	18,690	1,736.4	18,690
5			1,736.4	18,690	1,736.4	18,690
6			1,736.4	18,690	1,736.4	18,690
7			1,210.8	13,033	1,210.8	13,033
8			1,379.9	14,853	1,379.9	14,853
9			1,379.9	14,853	1,379.9	14,853
10			842.3	9,067	842.3	9,067
11			718.3	7,731	718.3	7,731
12			718.3	7,731	718.3	7,731
13			718.3	7,731	718.3	7,731
14			718.3	7,731	718.3	7,731
15			718.3	7,731	718.3	7,731
16			718.3	7,731	718.3	7,731
17			718.3	7,731	718.3	7,731
18			718.3	7,731	718.3	7,731
19			718.3	7,731	718.3	7,731
20			718.3	7,731	718.3	7,731
21			718.3	7,731	718.3	7,731
22			718.3	7,731	718.3	7,731
23			718.3	7,731	718.3	7,731
24			718.3	7,731	718.3	7,731
25			718.3	7,731	718.3	7,731
26			718.3	7,731	718.3	7,731
27			718.3	7,731	718.3	7,731
28			718.3	7,731	718.3	7,731
29			718.3	7,731	718.3	7,731
30			718.3	7,731	718.3	7,731
31			718.3	7,731	718.3	7,731
32			718.3	7,731	718.3	7,731
33			718.3	7,731	718.3	7,731
34			718.3	7,731	718.3	7,731
M.P.H.						
TOTAL	242.7	2,613	32,091.5	345,430	32,334.2	348,043

#### **AMENITY AREA BREAKDOWN**

OUTDOOR AI	MENITY	(EXCLUDED. FROM GFA)		
m²	ft²	m²	ft²	
225.0	2,422	264.1	2,843	
225.0	->	231.5	2,492	
340.2	3,662	169.2	1,821	
340.2	3,002	109.2	1,821	
189.7	2,042	313.3	3,372	
103.7	2,042	313.3	3,372	
	20			
	7 F			
***				
IF				
754.9	8,126	978.0	10,528	

#### **EXCLUSIONS BREAKDOWN**

AREA EXCL	JSIONS	TOTAL FLOOR	ARFA [TFA]
TOTAL EXCL	USIONS	(NO EXCL	
m²	ft²	m2	ft2
2,669.1	28,730	2,739.4	29,487
2,672.3	27,871	2,739.4	28,993
20.4	27,871	35.1	28,993
442.0	4,758	1,823.6	19,629
125.8	1,354	2,200.0	23,681
76.2	820	2,038.0	21,936
76.2	820	1,812.6	19,510
76.2	820	1,812.6	19,510
76.2	820	1,812.6	19,510
76.2	820	1,456.1	15,673
65.0	700	1,445.0	15,553
65.0	700	1,445.0	15,553
82.9	893	1,238.5	13,331
52.6	567	770.9	8,298
52.6	567	770.9	8,298
52.6	567	770.9	8,298
52.6	567	770.9	8,298
52.6	567	770.9	8,298
52.6	567	770.9	8,298
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52.6	567	770.9	8,298
52.6	567	770.9	8,298
52.6	567	770.9	8,298
52.6	567	770.9	8,298
52.6	567	770.9	8,298
52.6	567	770.9	8,298
421.4	4,536	421.4	4,536
3.2277			
7,786.6	26,101	41,520.3	470,505

#### TOTAL FLOOD ADEA CLINANAADY

FLOORS	TFA	
	m²	ft²
U/G 1 - U/G 2 - BASEMENT	5,514.0	59,352
FLOOR 1 - FLOOR 34	36,006.3	387,568
TOTAL	41,520.3	446,920

#### GROSS FLOOR AREA DEFINITION

CITY OF TORONTO ZONING BY-LAW NO.569-2013

Gross Floor Area Calculations for a Mixed Use Building in the Commercial Residential Zone Category

In the Commercial Residential Zone category the gross floor area of a mixed use building is reduced by the area in the building used for: (A) parking, loading and bicycle parking below-ground;

(B) required loading spaces at the ground level and required bicycle parking spaces at or above-ground;

(C) storage rooms, washrooms, electrical, utility, mechanical and ventilation rooms in the basement;

(D) shower and change facilities required by this By-law for required bicycle parking spaces; (E) amenity space required by this By-law;

(F) elevator shafts;

(G) garbage shafts;

(H) mechanical penthouse; and

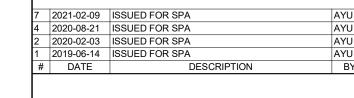
(I) exit stairwells in the building.

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JAC CONDOS

308-314 Jarvis Street & 225 Mutual Street, Toronto, Ontario, Canada

STATISTICS BYLAW 569-2013

PROJECT NO. 18.189CS PROJECT DATE 2021-02-09 DRAWN BY MNZ CHECKED BY

AYU SCALE



SPA001A

#### **UNIT MIX - PROVIDED**

FLOOR	UNIT	UNIT						TOTAL	
	STUDIO	1B	1B+D	2B	2B+D	3B+D	3B+D (G)	TH (G)	
1								5	5
2		3		3	5	4	2		17
3	1	4	4	3	4	2	4		22
4	1	4	4	3	4	2	4		22
5	1	4	4	3	4	2	4		22
6	1	4	4	3	4	2	4		22
7	1	4	2	4	3	2	1		17
8	1	4	2	3	4	4	1		19
9	1	4	2	3	4	4	1		19
10	1	2	2	3	3	1			12
11	3	3	2	1	4				13
12	3	3	2	1	4				13
13	3	3	2	1	4				13
14	3	3	2	1	4				13
15	3	3	2	1	4				13
16	3	3	2	1	4				13
17	3	3	2	1	4				13
18	3	3	2	1	4				13
19	3	3	2	1	4				13
20	3	3	2	1	4				13
21	3	3	2	1	4				13
22	3	3	2	1	4				13
23	3	3	2	1	4		1		13
24	3	3	2	1	4				13
25	3	3	2	1	4		1		13
26	3	3	2	1	4				13
27	3	3	2	1	4		1		13
28	3	3	2	1	4		T V		13
29	3	3	2	1	4				13
30	3	3	2	1	4				13
31	3	3	2	1	4				13
32	3	3	2	1	4				13
33	3	3	2	1	4				13
34	3	3	2	1	4				13
J.			_	•	42.4				
BTOTAL	80	105	72	52	131	23	21	5	
	16.4%	21.5%	14.7%	10.6%	26.8%	4.7%	4.3%	1.0%	489
TAL UNITS	80	177	i	183	3		49		
UNIT MIX	16.4%	36.2	%	37.4	%		10.0%		100.0%

## **AVERAGE UNIT SIZE PER UNIT TYPE**

AVG. UNIT SIZE	STUDIO	1B	2B	3B & MORE	TOTAL
m2	30.9	48.0	66.1	100.2	57.2
ft2	332	516	711	1,079	616

## **BARRIER-FREE UNIT PER UNIT TYPE**

AVG. UNIT SIZE	STUDIO	1B	2B	3B & MORE	TOTAL
REQUIRED	12	27	28	8	75
PROVIDED	12	27	30	9	78

## AMENITY AREAS - REQUIRED & PROVIDED

TYPE	REQUIRED*			PROVIDED			
	RATIO	m2	ft2	RATIO		m2	ft2
INDOOR	2 sm/unit	978.0	10,527.19	2	.0 sm/unit	978.0	10,527.62
OUTDOOR	1.5 sm/unit	733.5	7,895.39	1	.5 sm/unit	754.9	8,125.68
TOTAL	3.5 sm/unit	1,711.5	18,422.59	3	.5 sm/unit	1,732.9	18,653.30

<sup>\*</sup> AMENITY RATIO AS PER SETTLEMENT NOVEMBER 28, 2017.

### **BICYCLE PARKING - REQUIRED & PROVIDED**

RESIDENTIAL	REQUIRED		PROVIDED	
	RATIO	SPACES	RATIO	SPACES
LONG-TERM	0.9 per unit	441	0.90 per unit	441
SHORT-TERM	0.1 per unit	49	0.10 per unit	50
TOTAL	1.0 per unit	490	1.00 per unit	491
COMMERCIAL				
LONG-TERM	0.2 per 100 m2	1		1
SHORT-TERM	3+0.3 per 100 m2	4		4
TOTAL	per 100 m2	5		5
			TOTAL	496

### **VEHICLE PARKING - PROPOSED\* & PROVIDED**

RESIDENTIAL	PROPOSED		PROVIDED	
	RATIO	SPACES	RATIO	SPACES
RESIDENT	0.17 per unit	83	0.17 per unit	83
VISITOR	0.05 per unit	24	0.05 per unit	24
TOTAL	0.22 per unit	107	0.22 per unit	107

<sup>\*</sup> REFER TO TRAFFIC IMPACT STUDY PRREPARED BY BA GROUP

#### **ACCESSIBLE PARKING\***

/ TOOLOGIDE	
REQUIRED	PROVIDED
SPACES	SPACES
6	6

:	INCLUDED	IN TOTAL	DADKING	COLINIT
	INCLUDED	INTOTAL	PAUVING	COOM

## LEV, EVSE & ROUGHED-IN EV PARKING\*

	REQUIRED	PROVIDED
	SPACES	SPACES
LEV	NA	NA
EVSE	22	22
ROUGHED-IN EV	85	85

### "GROWING UP" UNITS

	REQUIRED	PROVIDED
TOTAL	25	26
RATIO	5.0%	5.3%

<sup>\*</sup> Size per The Growing Up Urban Design Guidelines

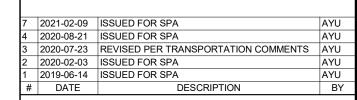
### **3B UNITS**

	REQUIRED	PROVIDED
TOTAL	49	49
RATIO	10.0%	10.0%



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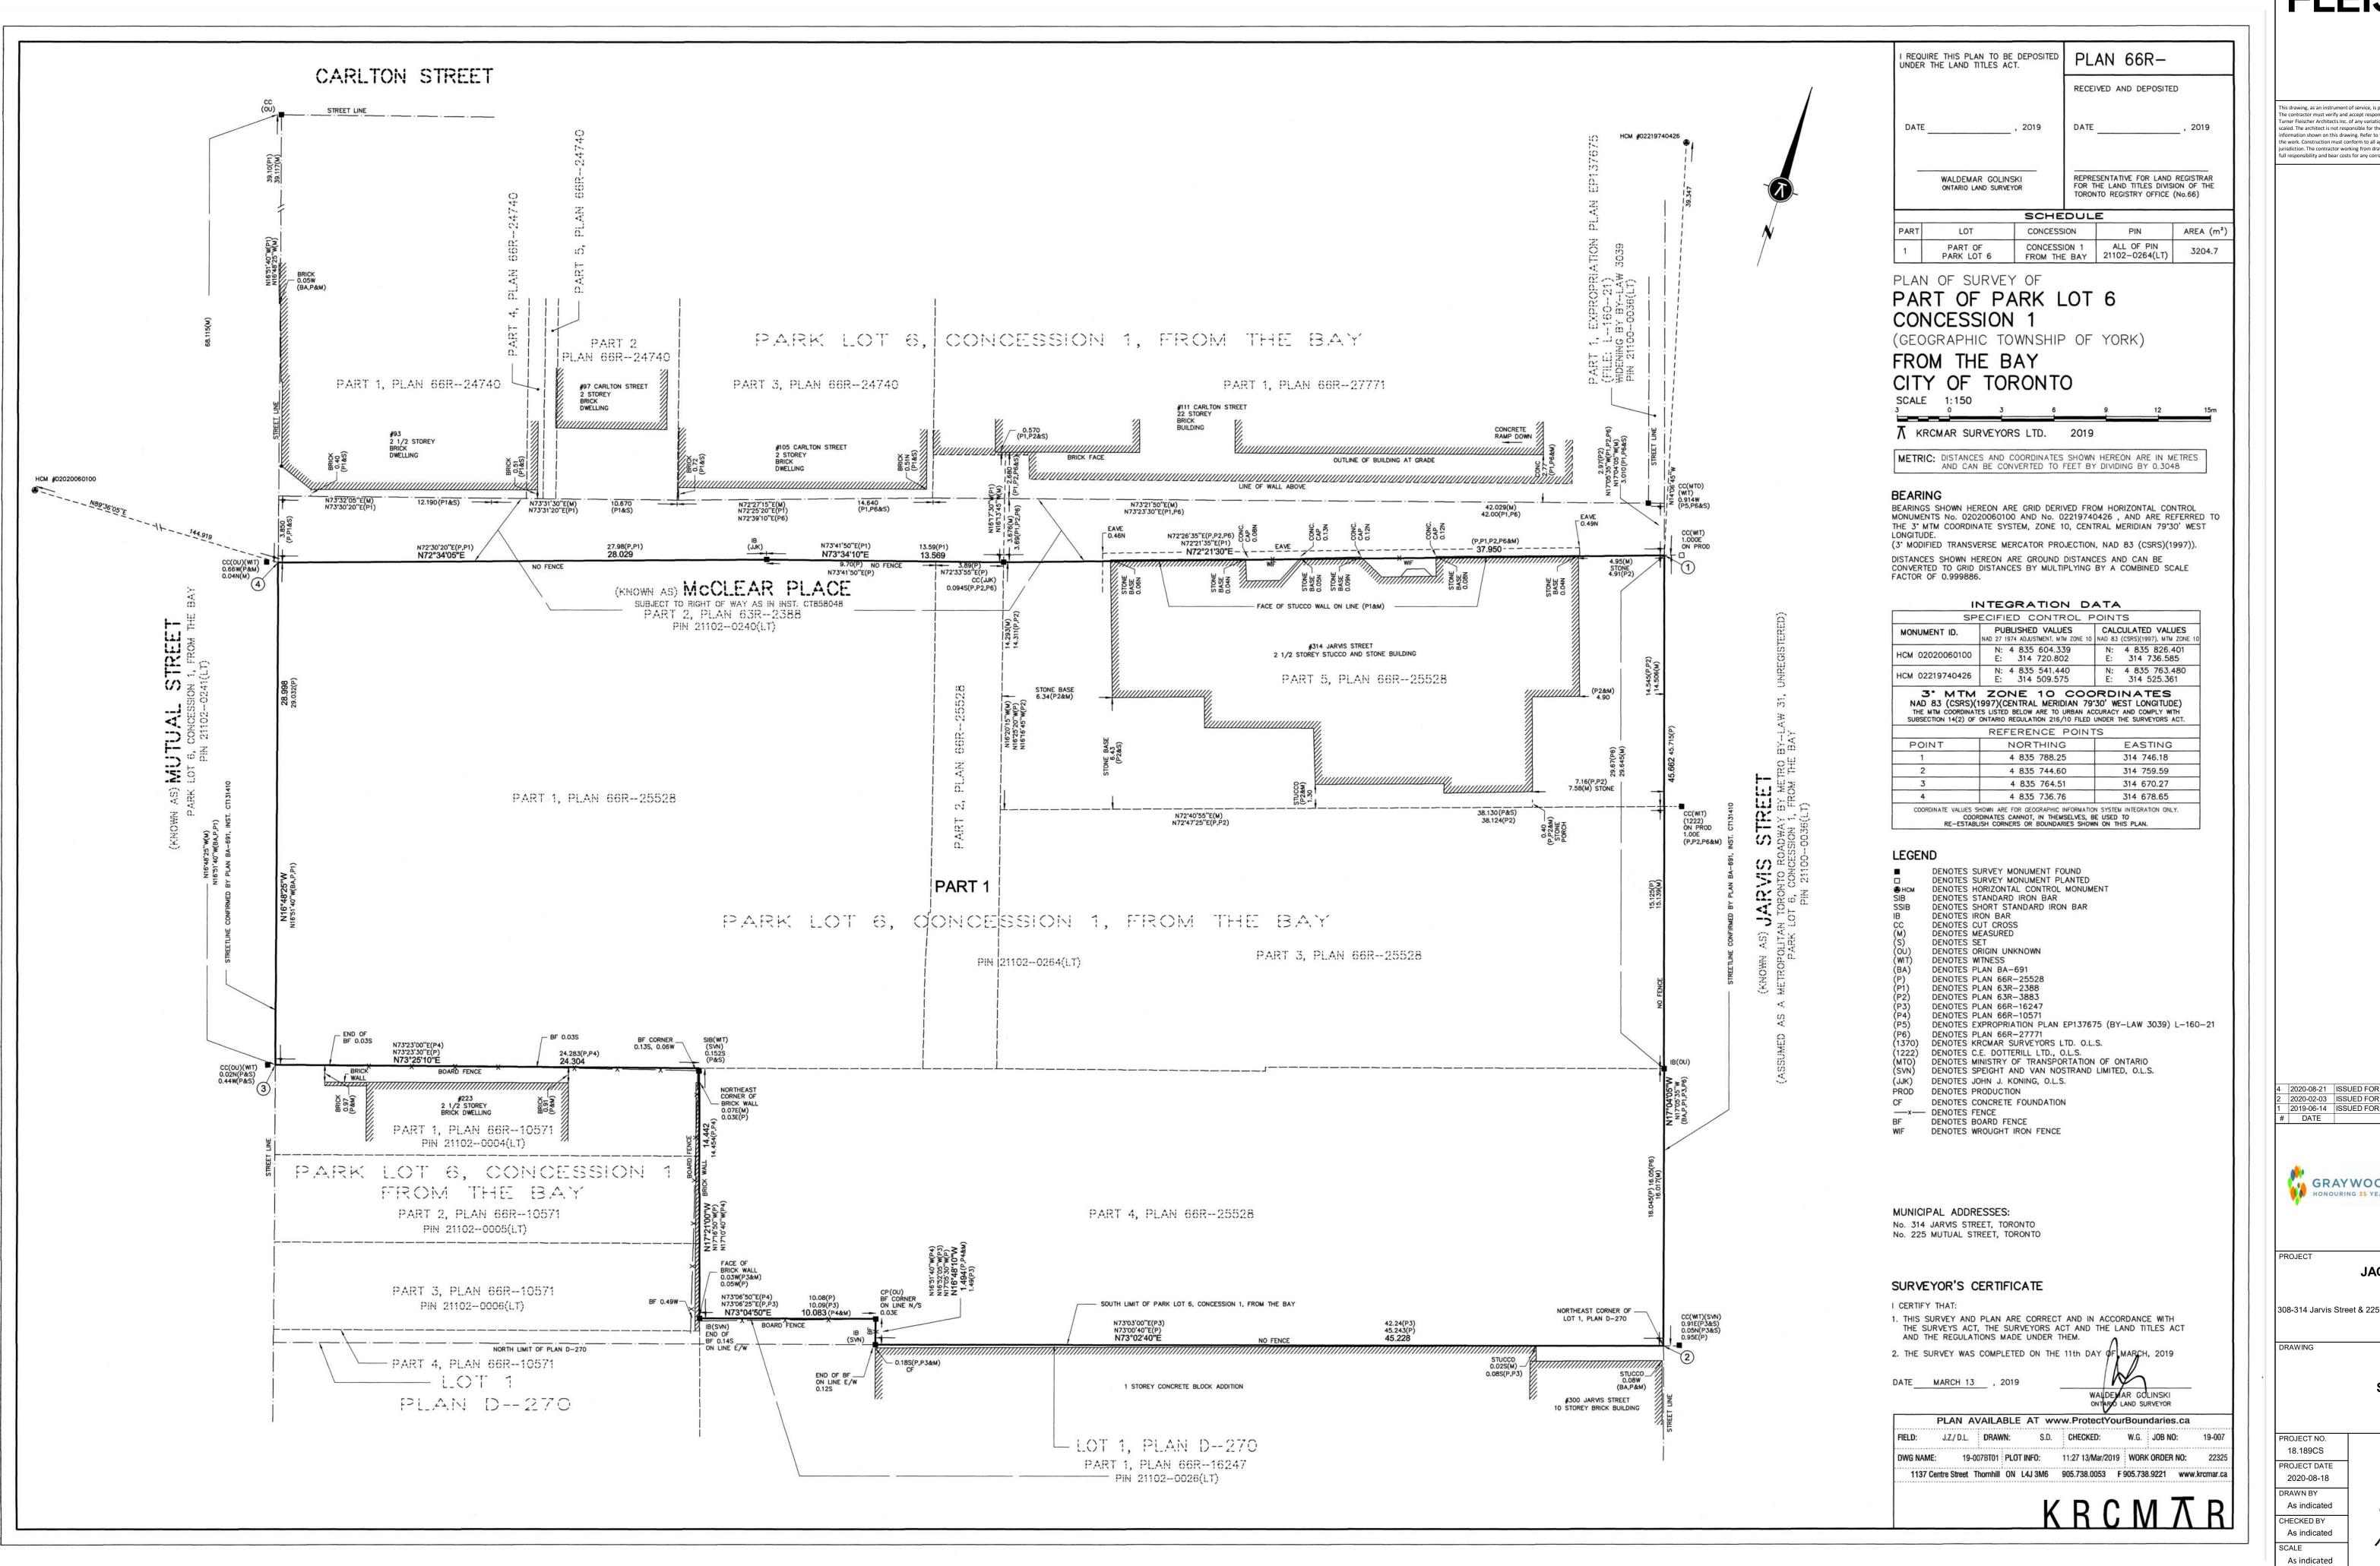
308-314 Jarvis Street & 225 Mutual Street, Toronto, Ontario, Canada

STATISTICS BYLAW 569-2013

PROJECT NO.
18.189CS
PROJECT DATE
2021-02-09
DRAWN BY
MNZ
CHECKED BY
AYU
SCALE



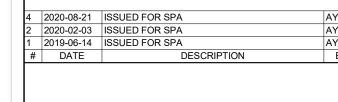
SPA001B



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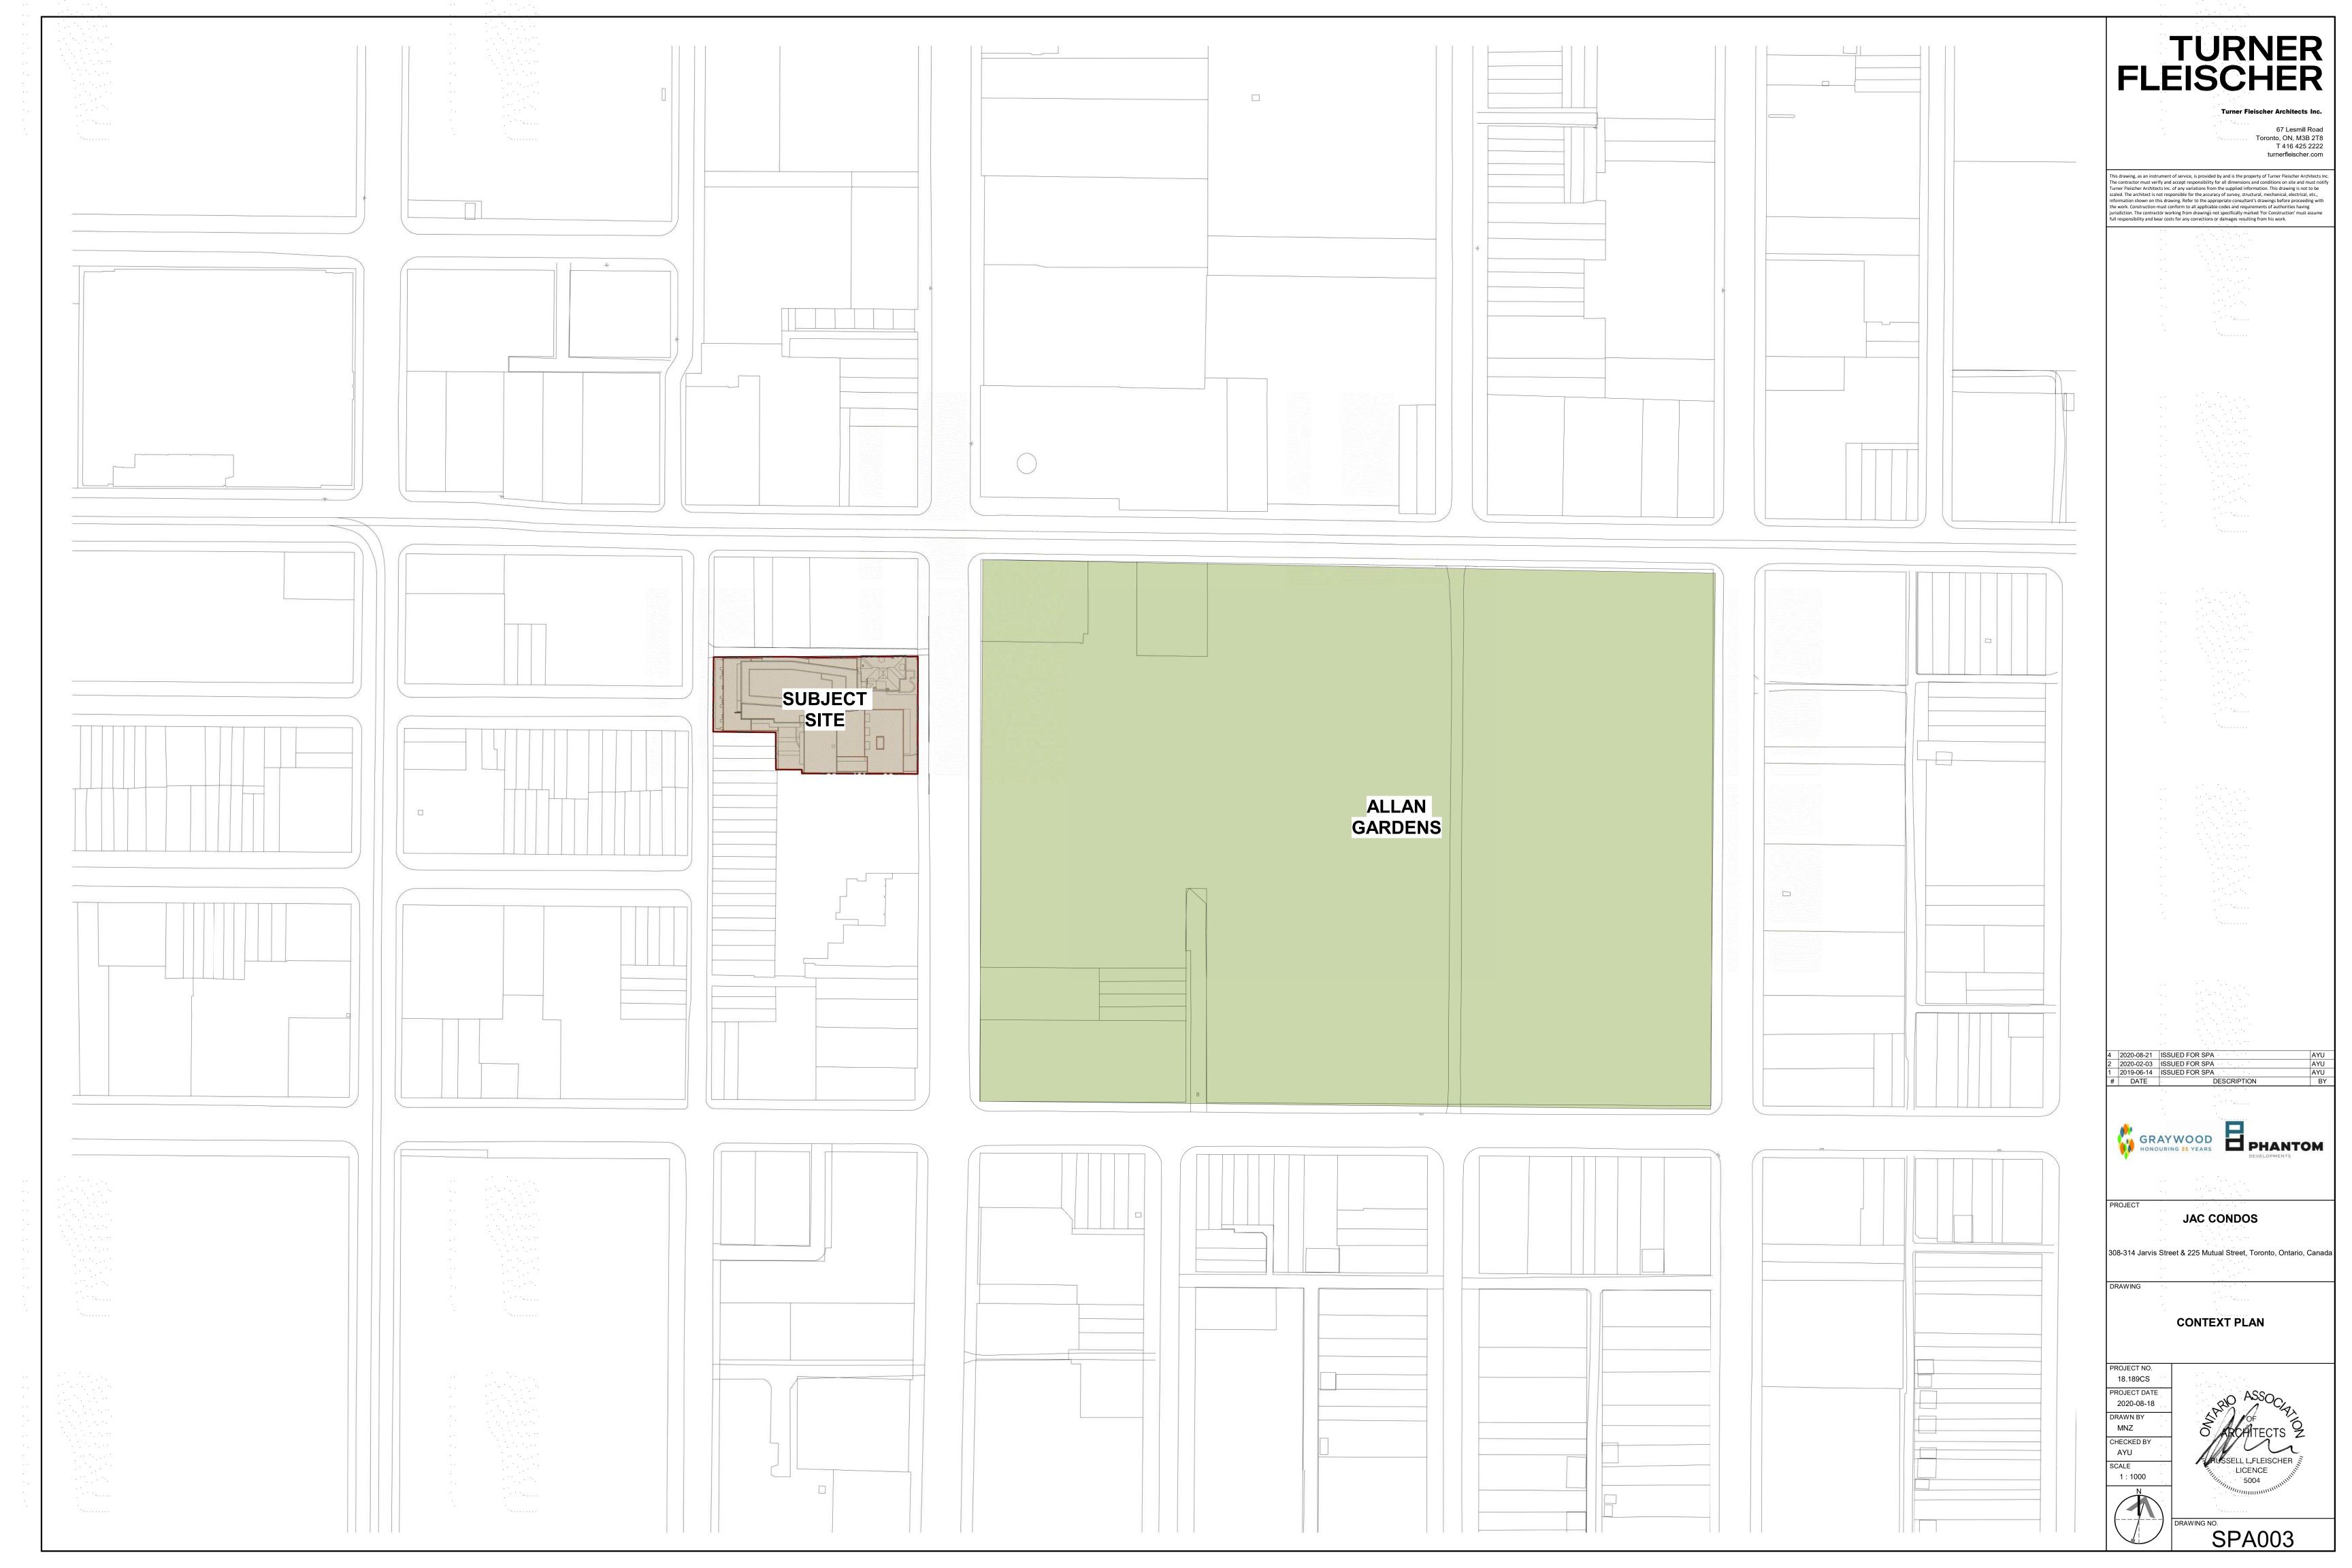
JAC CONDOS

308-314 Jarvis Street & 225 Mutual Street, Toronto, Ontario, Canada

DRAWING

SURVEY





Complete in Fier 1 perforr Fier 2, 3 and	mance measures a 4 higher performa	he full Toronto Green Standard Version 3.0 or re required by the City and must be included ance levels are voluntary and are associated	ntial and all New Non-Reside (TGS V3.0) and Specifications. d as part of your approved development ap	oplication.
	ce Level:	Tier 1 (Required) Tier 2	Tier 3 Tier 4	
	n Information: nn Control	Zoning Bylaw Amendment	Draft Plan of Subdivision	
Is this chec Gross Floo Non Reside	y Planner (First, Lacklist revised from r Area (m²): 33,07 ential Gross Floor	an earlier submission? ✓ Yes ☐ No 9.7 (BY-LAW NO.438-86) Number of Storeys: <b>34</b>	Number of Units: 48	9
damaged facing Jai	by fire at the north- rvis Street. Some gre	consists of a 34-storey residential tower including east corner of the site will be repaired for amenity een attributes or performance measures include: use of sustainable materials and finishes and wa	use. The proposal will provide 489 units includir implementation of bird-friendly guidelines, provis	ng 5 condo townhouses
Property a	nd Applicant I	nformation		
	me: JAC Condos	reet Number and Name): 308-314 Jarvis St	reet + 225 Mutual Street, Toronto, ON	
Name (Firs	st, Last Name): <b>Go</b>		elephone Number: (416) 322-6364	
			Telephone Number: (416) 322-6364 If Owner (First, Last Name): Phantom Deve	
Business E	mail: mcharkow@	Mid to High Rise Reside	Checklist - Toronton tial and all New Non-Reside	Page of Green Standards Version ntial Developm
Business E	mail: mcharkow@	goldberggroup.ca Registered	Checklist - Toronte	Page
Business E	mail: mcharkow@	Mid to High Rise Resider  Tier 1 Performance Measure (See full standards and specifications for	Checklist - Torontom Land all New Non-Resider  Documentation for site plan approval (Sections marked with an asterisk are required for rezoning applications)  TGS V3.0 statistics template.  Green Roof Statistics Template on roof plan.	Page of Green Standards Version ntial Developm
Business E	Development Feature  Green & Cool	Mid to High Rise Resider  Tier 1 Performance Measure (See full standards and specifications for details and definitions)  One of the following is provided (select all that apply):  Green Roof required under the	Checklist - Torontom Developmental and all New Non-Resider  Documentation for site plan approval (Sections marked with an asterisk are required for rezoning applications)  TGS V3.0 statistics template.	Page  o Green Standards Version tial Developm  Plans and Drawings  Plan #SPA005 SPA301 SPA302
Business E	Development Feature  Green & Cool	Mid to High Rise Resider  Tier 1 Performance Measure (See full standards and specifications for details and definitions)  One of the following is provided (select all that apply):  Green Roof required under the Green Roof By-Law  Green roof for 50% of roof;	Checklist - Toronto  Checklist - Toronto  Tial and all New Non-Reside  Documentation for site plan approval (Sections marked with an asterisk are required for rezoning applications)  TGS V3.0 statistics template.  Green Roof Statistics Template on roof plan.  Notations include green roof locations identified on elevations	Page  o Green Standards Version tial Developm  Plans and Drawings  Plan #SPA005 SPA301 SPA302
Section  AQ 4.2	Development Feature  Green & Cool Roofs	Mid to High Rise Resider  Tier 1 Performance Measure (See full standards and specifications for details and definitions)  One of the following is provided (select all that apply):  Green Roof required under the Green Roof By-Law  Green roof for 50% of roof; Cool roof installed for 100% of roof; A combination of a green roof, and cool roof and solar panels for at	Checklist - Toronte  Tial and all New Non-Reside  Documentation for site plan approval (Sections marked with an asterisk are required for rezoning applications)  TGS V3.0 statistics template.  Green Roof Statistics Template on roof plan.  Notations include green roof locations identified on elevations and roof plans.  Notations include SRI of cool roof on roof plan and location of solar	Page  o Green Standards Version tial Developm  Plans and Drawings  Plan #SPA005 SPA301 SPA302
Section  AQ 4.2	Development Feature  Green & Cool Roofs	Mid to High Rise Resider  Tier 1 Performance Measure (See full standards and specifications for details and definitions)  One of the following is provided (select all that apply):  Green Roof required under the Green Roof By-Law  Green Roof By-Law  Green roof for 50% of roof; Cool roof installed for 100% of roof; A combination of a green roof, and cool roof and solar panels for at least 75% of roof.	Checklist - Toronte  Tial and all New Non-Reside  Documentation for site plan approval (Sections marked with an asterisk are required for rezoning applications)  TGS V3.0 statistics template.  Green Roof Statistics Template on roof plan.  Notations include green roof locations identified on elevations and roof plans.  Notations include SRI of cool roof on roof plan and location of solar	Page  o Green Standards Version tial Developm  Plans and Drawings  Plan #SPA005 SPA301 SPA302
Section  AQ 4.2  Tier 1: Er	Development Feature  Green & Cool Roofs  Development	Mid to High Rise Resider  Tier 1 Performance Measure (See full standards and specifications for details and definitions)  One of the following is provided (select all that apply):  Green Roof required under the Green Roof By-Law  Green roof for 50% of roof; Cool roof installed for 100% of roof; A combination of a green roof, and cool roof and solar panels for at least 75% of roof.  GHGs & Resilience  Tier 1 Performance Measure (See full standards and specifications for	Checklist - Torontom Tital and all New Non-Resider  Documentation for site plan approval (Sections marked with an asterisk are required for rezoning applications)  TGS V3.0 statistics template.  Green Roof Statistics Template on roof plan.  Notations include green roof locations identified on elevations and roof plans.  Notations include SRI of cool roof on roof plan and location of solar panels.  Documentation for site plan approval (Sections marked with an asterisk are	Page o Green Standards Version Itial Developm Plans and Drawings Plan #SPA005 SPA301 SPA302 L4
Section  AQ 4.2  Tier 1: Er  Section  GHG 1.1	Development Feature  Green & Cool Roofs  Development Feature  Development Feature  Buildings Energy Performance	Mid to High Rise Resider  Tier 1 Performance Measure (See full standards and specifications for details and definitions)  One of the following is provided (select all that apply):  Green Roof required under the Green Roof By-Law  Green Roof for 50% of roof; Cool roof installed for 100% of roof; A combination of a green roof, and cool roof and solar panels for at least 75% of roof.  GHGs & Resilience  Tier 1 Performance Measure (See full standards and specifications for details and definitions)  Design the building to achieve 15% improvement above OBC, SB-10, Division 3 (2017); OR TEUI, TEDI and GHGI targets by building	Checklist - Toronton tial and all New Non-Resider  Documentation for site plan approval (Sections marked with an asterisk are required for rezoning applications)  TGS V3.0 statistics template.  Green Roof Statistics Template on roof plan.  Notations include green roof locations identified on elevations and roof plans.  Notations include SRI of cool roof on roof plan and location of solar panels.  Documentation for site plan approval (Sections marked with an asterisk are required for rezoning applications)  Energy (Modelling) Report and Energy Workbook prior to NOAC (if	Plans and Drawings  Plans and Drawings  Plans and Drawings  Plans and Drawings  Plans and Drawings
Section  AQ 4.2  Tier 1: Er  Section  GHG 1.1	Development Feature  Green & Cool Roofs  Development Feature  Development Feature  Buildings Energy Performance	Mid to High Rise Resider  Tier 1 Performance Measure (See full standards and specifications for details and definitions)  One of the following is provided (select all that apply):  Green Roof required under the Green Roof By-Law  Green roof for 50% of roof; Cool roof installed for 100% of roof; A combination of a green roof, and cool roof and solar panels for at least 75% of roof.  GHGs & Resilience  Tier 1 Performance Measure (See full standards and specifications for details and definitions)  Design the building to achieve 15% improvement above OBC, SB-10, Division 3 (2017); OR TEUI, TEDI and GHGI targets by building type. (required for Tier 2)	Checklist - Toronton tial and all New Non-Resider  Documentation for site plan approval (Sections marked with an asterisk are required for rezoning applications)  TGS V3.0 statistics template.  Green Roof Statistics Template on roof plan.  Notations include green roof locations identified on elevations and roof plans.  Notations include SRI of cool roof on roof plan and location of solar panels.  Documentation for site plan approval (Sections marked with an asterisk are required for rezoning applications)  Energy (Modelling) Report and Energy Workbook prior to NOAC (if	Plans and Drawings  Plans and Drawings  Plans and Drawings  Plans and Drawings  Plans and Drawings

Section	Development Feature	Tier 1 Performance Measure (See full standards and specifications for	Documentation for site plan approval (Sections marked with an asterisk are	Plans and Drawings
EC 4.2	Rooftop Vegetation	details and definitions)  Glazing 4 m above rooftop vegetation is treated to reduce bird collisions.	Notations include required treated area, type of treatment, density and colour of visual markers.	Plan # SPA301 SPA302 SPA321
EC 4.3	Grate Porosity	Maximum porosity of ventilation grates is 20 mm X 20 mm.	Notations indicate porosity of ground level grates.	Plan #SPA151
EC 5.1	Exterior Lighting	Dark Sky compliant fixtures.	Notations indicate Dark Sky compliant fixtures.	Plan #
ier 1: So	lid Waste			1
Section	Development Feature	Tier 1 Performance Measure (See full standards and specifications for details and definitions)	Documentation for site plan approval (Sections marked with an asterisk are required for rezoning applications)	Plans and Drawings
SW 1.1	Waste Collection & Sorting	Waste sorting system for garbage, recycling and organics. (Residential)	Notations indicate type and location of waste sorting sytstem.	Plan #SPA006 SPA151
SW 1.2	Waste Storage Space	Waste storage rooms	Notations indicate area and location of waste storage rooms.	Plan #SPA006 SPA151
SW 1.3	Bulky Waste	Provide 10m² for bulky and special collection items. (Residential)	Notations indicate area and location for bulky items collection.	Plan #SPA006 SPA151
SW 1.4	Compaction	Waste storage room with space for containers and the compactor unit. (Residential)	Notations indicate area and location of waste storage rooms and compactor unit.	Plan # SPA006 SPA151

11-0062 2018-05

11-0062 2018-05 Page 7 of 8

Checklist - Toronto Green Standards Version 3.0

Page 2 of 8

Page 5 of 8

11-0062 2018-05

Mid to High Rise Residential and all New Non-Residential Development

TGS Documentation includes the submission of the completed Tier 1 TGS Checklist and the Statistics template updated with each planning submission. All sections must be complete for SPA. The TGS Statistics template is provided on the Project Statistics Plan with each submission in addition to the TGS Checklist.

For project pursuing Tier 2, 3 and 4, a separate TGS High Performance checklist must be submitted.

Section	Development Feature	Tier 1 Performance Measure (See full standards and specifications for details and definitions)	Documentation for site plan approval (Sections marked with an asterisk are required for rezoning applications)	Plans and Drawings
*AQ 1.1	Single- Occupant Vehicle Trips	Reduce single occupancy vehicles trips by 15%.	Transportation Impact Study (TIS) includes TDM analysis (if applicable)	Plan #
*AQ 1.2	LEV and Sustainable Mobility	Dedicate parking spaces above the minimum required for low-emitting vehicles (LEV).	TGS V3.0 statistics template.  Summary table includes number and location of LEV spaces.	Plan # SPA101 SPA102
*AQ 1.3	Electric Vehicle Infrastructure	Install EVSE for 20% of the parking spaces. Roughed-in conduits for the remaining spaces.	TGS V3.0 statistics template.  Project parking statistics include number and location of EVSE spaces.  Notations indicate location of EVSE spaces and roughed-in spaces on parking plans.	Plan # SPA001B SPA101 SPA102
*AQ 2.1	Bicycle Parking Rates	Bicycle parking rates in accordance with Zoning Bylaw 569-2013	<ul> <li>✓ TGS V3.0 statistics template.</li> <li>✓ Project statistics include rates, number and type (long-term/short-term) of bicycle parking spaces.</li> <li>Summary table includes number, type and % of net floor area occupied by bicycle parking for each bicycle parking floor and at-grade.</li> </ul>	Plan # SPA001B SPA101 SPA151
*AQ 2.2	Long-term Bicycle Parking Location	Long-term bicycle parking in accordance with Zoning Bylaw 569-2013	Notations indicate the number of long-term parking spaces in each bicycle parking area.	Plan # SPA101 SPA151

11-0062 2018-05

Checklist - Toronto Green Standards Version 3.0

Mid to High Rise Residential and all New Non-Residential Development

Section	Development Feature	Tier 1 Performance Measure (See full standards and specifications for details and definitions)	Documentation for site plan approval (Sections marked with an asterisk are required for rezoning applications)	Plans and Drawings
WQ 2.1	Stormwater Retention & Reuse	Retain 5 mm depth of rainfall on-site (10 mm required for Tier 2)	Stormwater Report  Plans (Landscape, Grading, Roof and Green Roof details etc.) consistent with Stormwater Report	Plan #FSR Section 5.0 vi)
WQ 3.1	Total Suspended Solids (TSS)	Remove 80% of total suspended solids from all runoff leaving the site.	Stormwater Report	Plan #FSR Section 5.0 vii)
WQ 3.2	E. Coli Reduction	Control E. Coli directly entering Lake Ontario and waterfront areas	Stormwater Report	Plan # N/A
WQ 4.1	Drought- Tolerant Landscapes	Drought-tolerant plants used for 50% of the landscaped area	Plant list identifies drought tolerant species (if applicable)  Notation indicate potable or non-potable irrigation system on Landscape Plan	Plan # D1

Section	Development Feature	Tier 1 Performance Measure (See full standards and specifications for details and definitions)	Documentation for site plan approval (Sections marked with an asterisk are required for rezoning applications)	Plans and Drawings
EC 1.1	Tree Planting Areas and Soil Volume	Total volume of soil for tree planting areas= 40% of the site area divided by 66 m² x 30 m³. Each tree planting area has 30m³ of soil.	TGS V3.0 statistics template  Notations indicate soil volume (soil depth and area,) species and quantity for each planting area.	Plan # -
EC 1.2	Trees Along Street Frontages	Trees planted along street frontages with access to 30 m³ of soil/tree.	Notations indicate soil volume (soil depth and area,) species and quantity for each planting area.  Planting details	Plan # -

11-0062 2018-05

Checklist - Toronto Green Standards Version 3.0 Mid to High Rise Residential and all New Non-Residential Development

Section	Development Feature	Tier 1 Performance Measure (See full standards and specifications for details and definitions)	Documentation for site plan approval (Sections marked with an asterisk are required for rezoning applications)	Plans and Drawings
SW 3.1	Construction Waste Management	Manage construction and demolition waste in accordance with O. Reg. 103/94	Documentation in accordance with O.Reg 103/94	Plan #

Page 8 of 8

Checklist - Toronto Green Standards Version 3.0 Mid to High Rise Residential and all New Non-Residential Development

	- 1			446
Section	Development Feature	Tier 1 Performance Measure (See full standards and specifications for details and definitions)	Documentation for site plan approval (Sections marked with an asterisk are required for rezoning applications)	Plans and Drawings
*AQ 2.3	Short-term Bicycle Parking Location	Short-term bicycle parking in accordance with Zoning Bylaw 569-2013	Notations indicate location and the number of short-term spaces in each bicycle parking area.	Plan # SPA151 L1
*AQ 2.4	Shower & Change Facilities	Shower and change facilities in accordance with Zoning Bylaw 569-2013	Notations indicate location and number of shower and change facilities.	Plan # N/A
AQ 3.1	Connectivity	Pedestrian walkways	Notations on Plans and Drawings.	Plan # SPA005 SPA151 L1
AQ 3.2	Sidewalk Space	Minimum 2.1 meter pedestrian clearway	Notations on Plans and Drawings.	Plan # SPA151 L1
AQ 3.3	Weather Protection	Covered outdoor waiting areas	Notations on Plans and Drawings.	Plan #
AQ 3.4	Pedestrian Lighting	Pedestrian-scale lighting	Notations on Plans and Drawings.	Plan #SPA151
AQ 4.1	UHI Non-roof Hardscape	Treat 50% of non-roof hardscape to reduce the urban heat island (75% required for Tier 2); OR 75% of the required parking spaces under cover. (Non-residential only)	TGS V3.0 statistics template.  Materials list includes SRI of high albedo paving  Notations indicate location of treated hardscape.	Plan # L1

Checklist - Toronto Green Standards Version 3.0 Mid to High Rise Residential and all New Non-Residential Development

Page 3 of 8

Section	Development Feature	Tier 1 Performance Measure (See full standards and specifications for details and definitions)	Documentation for site plan approval (Sections marked with an asterisk are required for rezoning applications)	Plans and Drawings
EC 1.3	Parking Lots	1 shade tree planted parking lots area for every 5 parking spaces	Notations indicate soil volume (soil depth and area), species and quantity on the Planting Plan for parking areas	Plan #
EC 1.4	Watering Program	Watering program for trees.	Notations on the Planting Plan include watering program methods and watering schedule.	Plan #Irrigation system and hose bibs will be provided
EC 2.1	Ravine Areas and Natural Heritage System	Natural Heritage System and the Ravine Protected Area planted with 100% native plants.	Plant list identifies native or non- native species.	Plan #
EC 2.2	Ravine and Protected Area Buffers	Stewardship plan implemented for setbacks	Stewardship Plan (if applicable)	Plan #
EC 3.1	Native and Pollinator Supportive Species	Landscape includes 50% native plants.	Plant list includes common name, scientific name, size, quantity, stock type, and native or non-native species.	Plan #D1
EC 3.2	Invasive Species	No invasive species planted	Plant list includes common name and scientific name.	Plan # D1
EC 4.1	Bird Friendly Glazing	85% of all exterior glazing within the required area is treated to reduce bird collisions.  Fly-through conditions treated at all heights of the building.	TGS V3.0 statistics template  Notations include treated area required, type of treatment, density and colour of visual markers.  Summary table of bird friendly glass treatments for each elevation.	Plan #SPA321

11-0062 2018-05 Page 6 of 8

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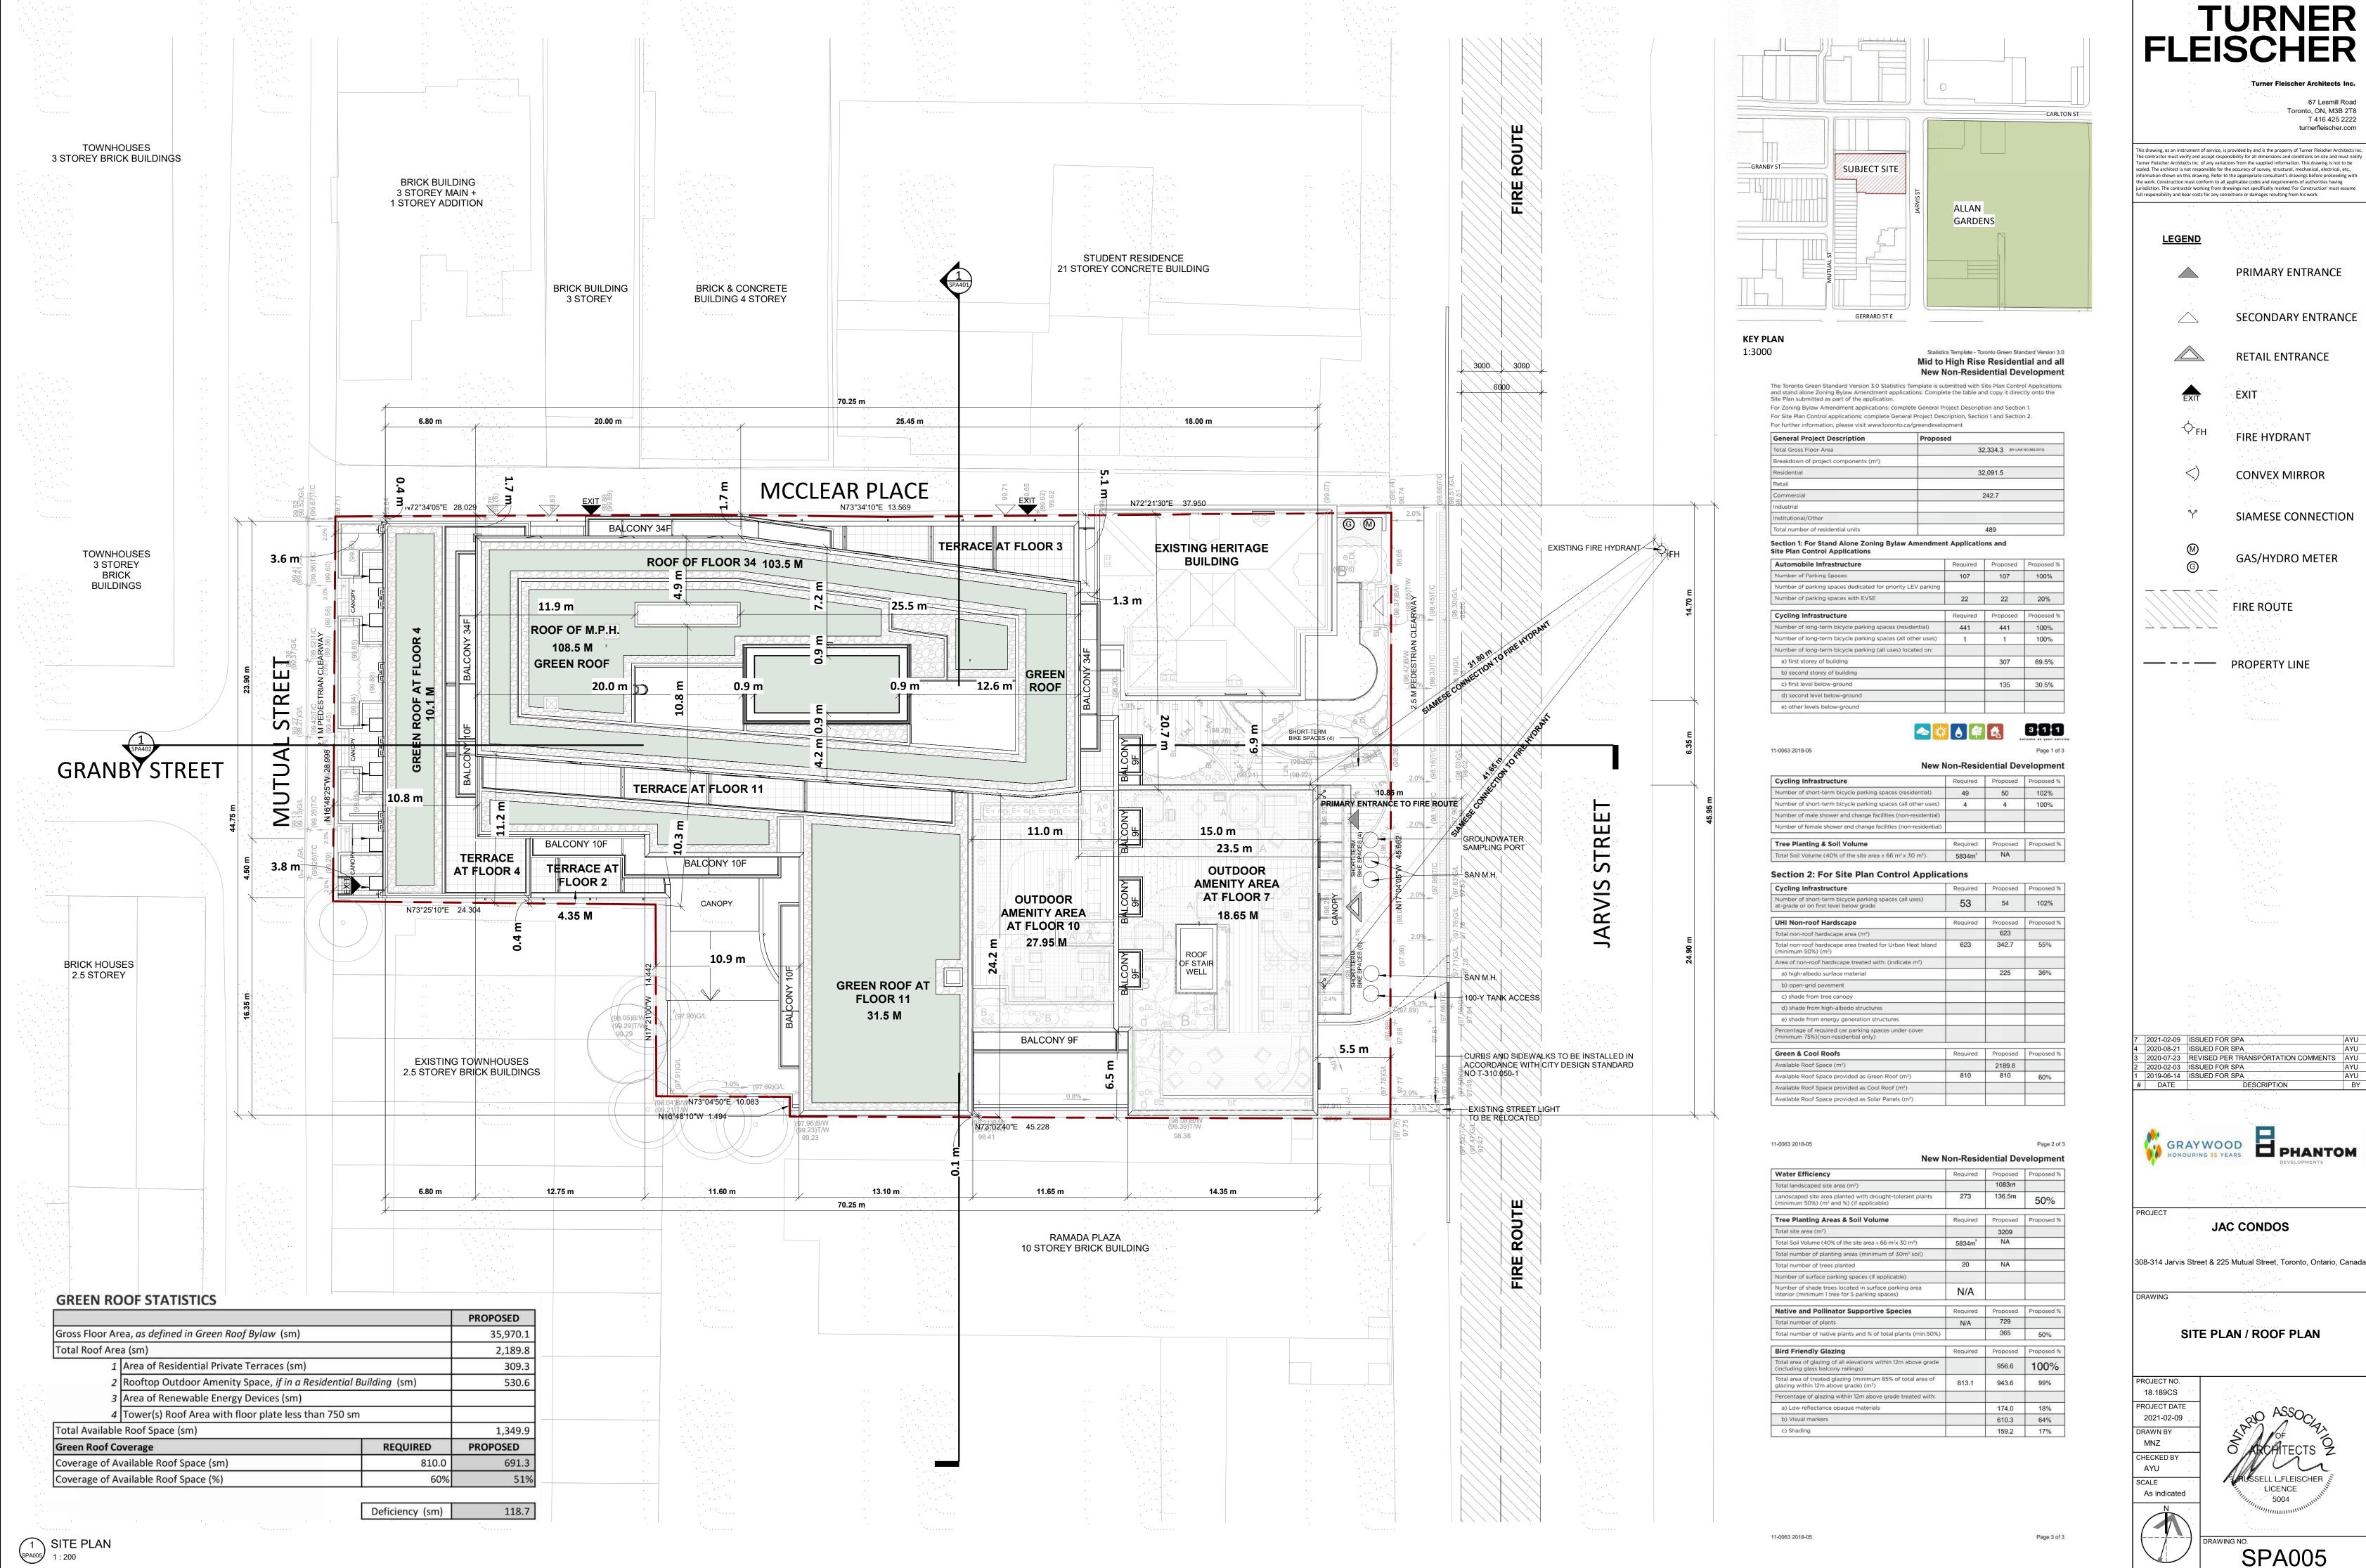
308-314 Jarvis Street & 225 Mutual Street, Toronto, Ontario, Canada

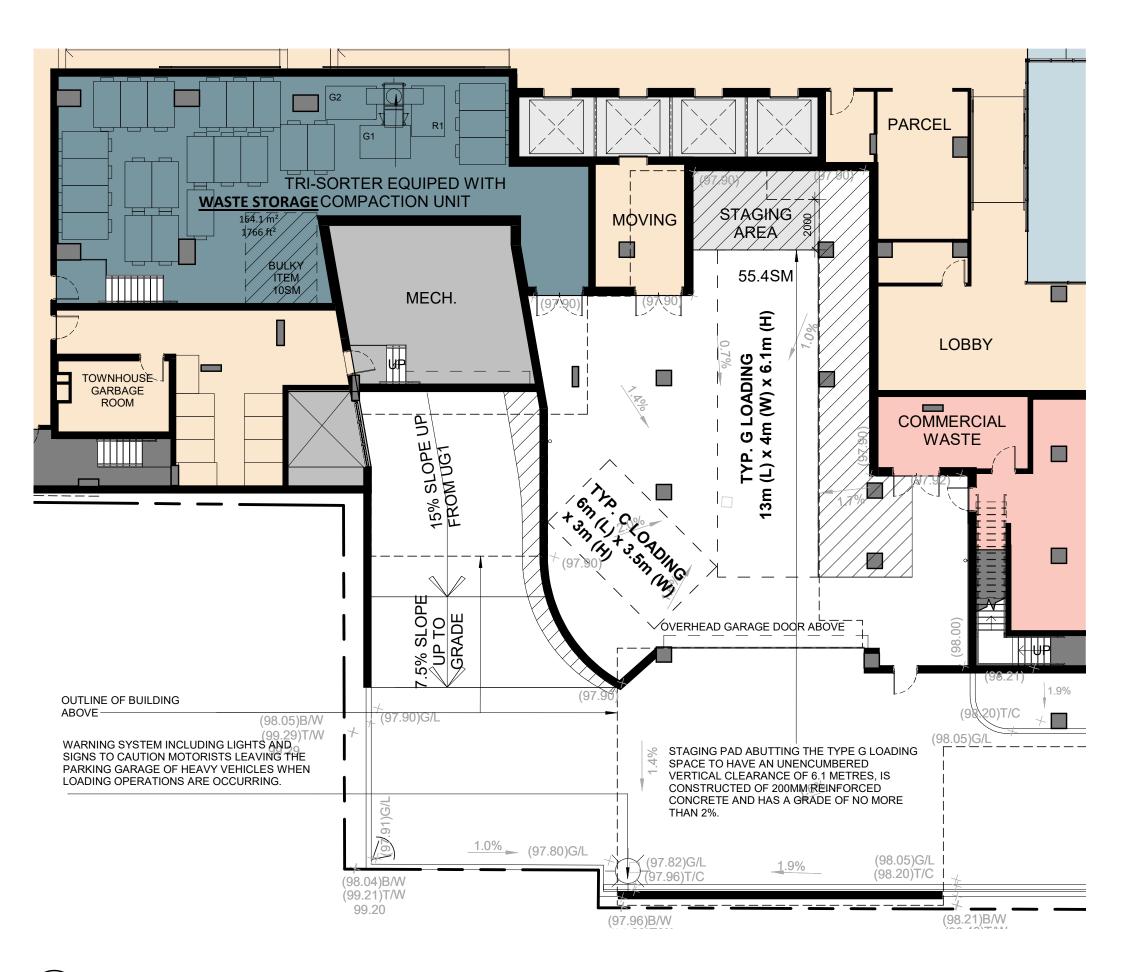
TGS CHECKLIST

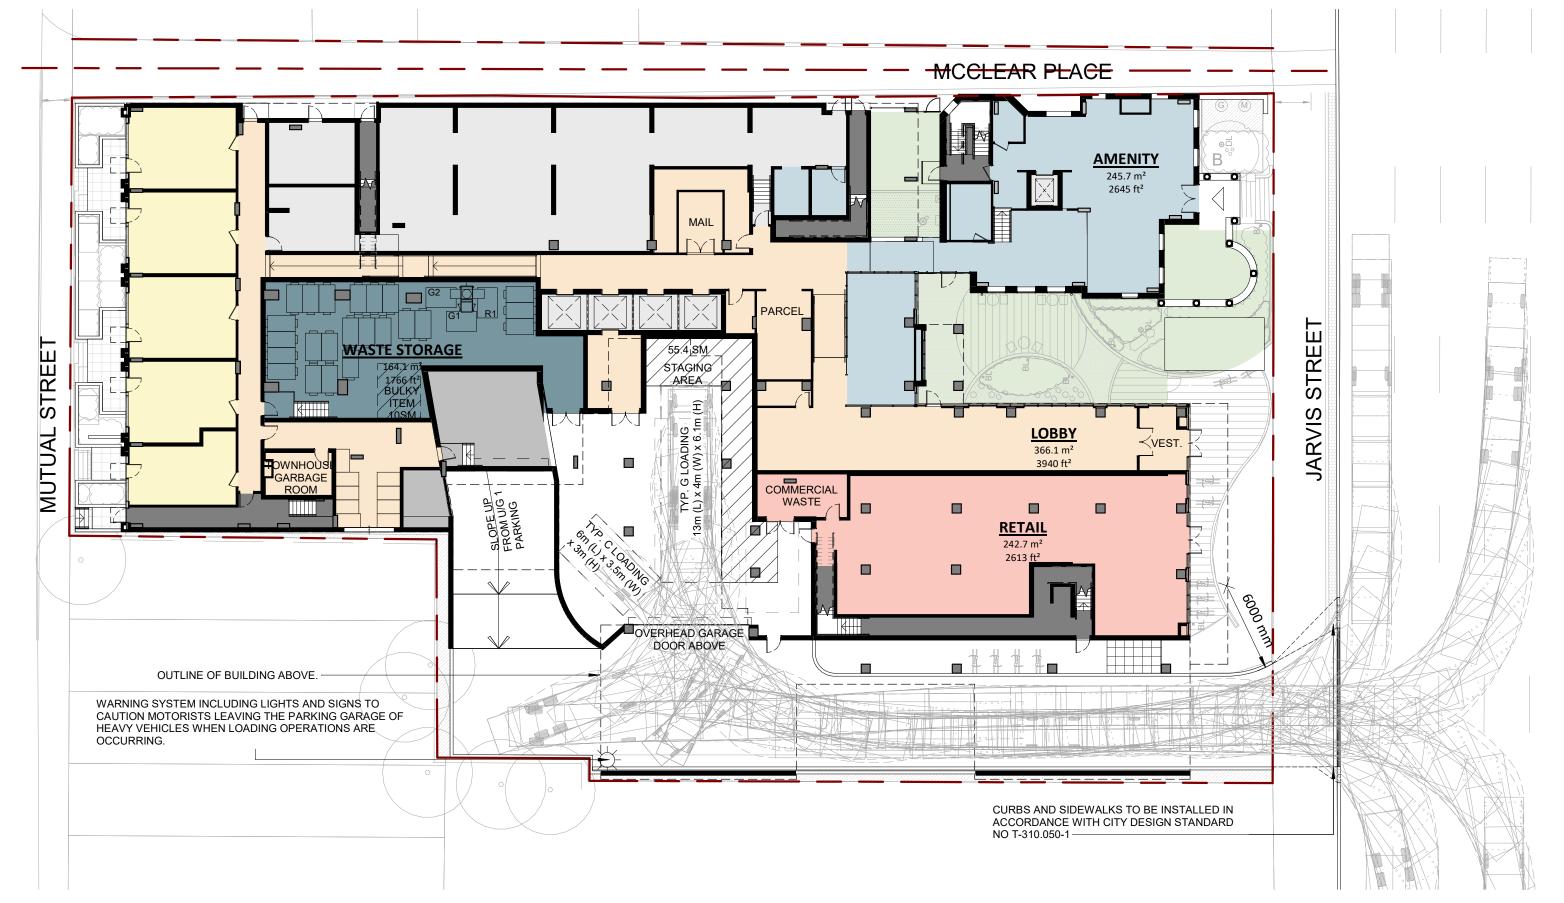
PROJECT NO. 18.189CS PROJECT DATE 2020-08-18 DRAWN BY MNZ CHECKED BY AYU











**∖** GROUND FLOOR - RESIDENTIAL SOLID WASTE MANAGEMENT SPA006

√3 GROUND FLOOR - TRUCK TURNING DIAGRAM

#### **RESIDENTIAL SOLID WASTE MANAGEMENT NOTES:**

1. ALL ACCESS DRIVEWAYS TO BE USED BY THE COLLECTION VEHICLE WILL BE LEVEL (+/-8%), AT LEAST 4.5 METERS WIDE THROUGHOUT THE SITE AND 6 METERS WIDE AT ENTRANCES AND EXITS, AND WILL HAVE A MINIMUM OVERHEAD TRAVELING CLEARANCE OF 4.4 METERS INCLUDING WHEN TRAVELING THROUGH OVER HEAD

2. TYPE G LOADING SPACE WILL BE AT LEAST 4 METRES WIDE, 13 METRES LONG, WITH AN UNOBSTRUCTED VERTICAL CLEARANCE OF 6.1 METRES, IS LEVEL (+/-2%), AND IS CONSTRUCTED OF AT LEAST 200MM OF REINFORCED CONCRETE.

3. A TRAINED ON-SITE STAFF MEMBER WILL BE AVAILABLE TO MANEUVER BIN FOR THE COLLECTION DRIVER AND ALSO ACT AS A FLAG MAN WHEN THE TRUCK IS REVERSING. IN THE EVENT THE ON-SITE STAFF IS UNAVAILABLE AT THE TIME THE CITY COLLECTION VEHICLES ARRIVE AT THE SITE. THE COLLECTION VEHICLE WILL LEAVE THE SITE AND NOT RETURN UNTIL THE NEXT SCHEDULED COLLECTION DAY.

4. SHARING OF TYPE G LOADING SPACE - RESIDENTIAL USE OF LOADING SPACE FOR PURPOSES OF MOVING WILL BE SCHEDULED ACCORDING TO GARBAGE PICK UP TIMES. SHOULD THE TYPE G SPACE BE NEEDED FOR USE BY COMMERCIAL SECTORS, THE COMMERCIAL COMPONENT MUST ARRANGE THIS USE SUCH THAT IT DOES NOT CONFLICT WITH ANY RESIDENTIAL USES.

5. IF THE LOADING AREA / EGRESS ROUTES ARE OVER SUPPORTED STRUCTURES, IE. OVER AN UNDERGROUND GARAGE OR A MECHANICAL SHAFT, THE FACILITY MUST CONFORM TO THE FOLLOWING:

- DESIGN CODE- ONTARIO BUILDING CODE.
- DESIGN LOAD- CITY BULK LIFT VEHICLE IN ADDITION BUILDING CODE REQUIREMENTS.
- IMPACT FACTOR- 5% FOR MAXIMUM VEHICULAR SPEEDS TO 15 KM/H AND 30% FOR HIGHER SPEEDS. CITY COLLECTION VEHICLE IS REQUIRED TO DRIVE ONTO OR OVER A SUPPORTED STRUCTURE (SUCH AS

AN UNDERGROUND PARKING GARAGE). THE UNDERGROUND PARKING GARAGE ROOF SLAB IS TO BE

DESIGNED TAKING INTO ACCOUNT THE COLLECTION VEHICLE WEIGHT. THE CITY MUST PROVIDE, PRIOR TO COMMENCEMENT OF CITY SOLID WASTE PICK UP, A LETTER CERTIFIED BY A QUALIFIED ENGINEER THAT THE STRUCTURE CAN SAFELY SUPPORT A FULLY LOADED COLLECTION VEHICLE WEIGHING 35,000 KILOGRAMS.

6. PRIVATE CONTRACTOR MUST COLLECT ALL SOLID WASTE FROM THE RETAIL COMPONENT.

7. WASTE BINS TO BE JOCKEYED ON COLLECTION DAY, IF REQUIRED. STAFF JOCKEYING THE BINS DURING SOLID WASTE PICK UP AND THE REQUIRED STAGING AREA IS TO BE LOCATED IN CLOSE PROXIMITY TO THE LOADING AREA TO AVOID ANY DELAYS DURING PICK UP.

8. NON-RESIDENTIAL COMPONENT WILL ONLY SCHEDULE USE OF THE TYPE G LOADING SPACE ON OPPOSITE DAYS FROM THE COLLECTION DAYS OF THE RESIDENTIAL COMPONENT TO ENSURE THAT THE TYPE G LOADING SPACE WILL BE VACANT FOR CITY WASTE COLLECTION. IF LOADING SPACE IS TO BE SHARED, THE COMMERCIAL BINS MUST BE LABELLED "RETAIL WASTE ONLY"

#### **RESIDENTIAL WASTE MANAGEMENT CALCULATIONS:**

AS PER CITY OF TORONTO REQUIREMENTS FOR GARBAGE, RECYCLING. AND ORGANIC COLLECTION SERVICES FOR NEW DEVELOPMENTS AND REDEVELOPMENTS (MAY 2012)

#### **RESIDENTIAL WASTE STORAGE AREA REQUIRED:**

MINIMUM 25 m2 FOR THE FIRST 50 UNITS + 13 m2 FOR EACH ADDITIONAL 50 UNITS + MINIMUM OF 10 m2 FOR BULKY ITEMS

#### NUMBER OF UNITS = 458

- = 489 50 = 439 / 50 UN ITS
- = 8.74 (ROUND UP) = 9 X 13 m2
- = 117 m2 + 25 m2 = 142 m2
- **BULKY ITEMS**

= 142 m2 + 10 m2 = 152 m2

#### TOTAL AREA REQUIRED:

= 152 m2 WASTE STORAGE AREA REQUIRED

#### **WASTE STORAGE AREA PROVIDED:**

RESIDENTIAL 164.1 m2

TOTAL RESIDENTIAL WASTE STORAGE AREA PROVIDED: = 164.1 m2 WASTE STORAGE AREA

#### **GARBAGE BINS REQUIRED** ONE 3-CUBIC YARD BIN PER **EVERY 50 UNITS FOR GARBAGE**

NUMBER OF UNITS = 495 489/50 = 9.9 (ROUND UP) = 10

PROVIDED = 10 BINS

#### RECYCLING BINS REQUIRED ONE 4-CUBIC YARD BIN PER **EVERY 50 UNITS FOR RECYCLING**

NUMBER OF UNITS = 495 489/50 = 9.9 (ROUND UP) = 10

PROVIDED = 10 BINS

#### ORGANIC BINS REQUIRED ONE 3-CUBIC YARD BIN PER **EVERY 150 UNITS FOR GARBAGE**

NUMBER OF UNITS = 489 489/150 = 3.3 (ROUND DOWN) = 3

PROVIDED = 3 BINS

#### **STAGING AREA REQUIRED:**

IN ADDITION TO THE TYPE 'G' LOADING SPACE THE AREA REQUIRED FOR STAGING VARIES WITH THE NUMBER OF UNITS. AS SUCH, 5 SQUARE METRES IS REQUIRED FOR EVERY 50 UNITS OVER 50.

#### **RESIDENTIAL:**

= 489 UNITS - 50 = 439 / 50 = 8.74 (ROUND UP) = 9 x 5 m2 = 45 m2

#### **STAGING AREA REQUIRED:**

STAGING AREA PROVIDED: 55.4 m2

### **NON-RESIDENTIAL WASTE COLLECTION**

THE NON-RESIDENTIAL COMPONENT OF THIS DEVELOPMENT WILL BE STORED AND TRANSPORTED SEPARATELY FROM THE RESIDENTIAL COMPONENT.

**LOADING SPACE(S) REQUIRED:** 

DEFINITION IN BY-LAW 569-2013:

**LOADING SPACE(S) PROVIDED:** 

TOTAL LOADING SPACE(S)

RESIDENTIAL

TYPE "G"

TYPE "C"

MINIMUM OF ONE TYPE "G "AND ONE TYPE "C" LOADING

MINIMUM LENGTH OF 13.0 M; MINIMUM WIDTH OF 4.0

MINIMUM LENGTH OF 6.0 M; MINIMUM WIDTH OF 3.5

i) TYPE "G" LOADING SPACE MUST HAVE A

ii) TYPE "C" LOADING SPACE MUST HAVE A

AND MINIMUM VERTICAL CLEARANCE OF 3.0 M.

M: AND MINIMUM VERTICAL CLEARANCE OF 6.1 M.

COLLECTION OF WASTES FROM THE COMMERCIAL SECTOR OF THIS SITE WILL BE IN ACCORDANCE WITH CHAPTER 841, SOLID WASTE OF THE MUNICIPAL CODE.

# **TURNER**

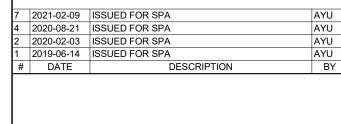
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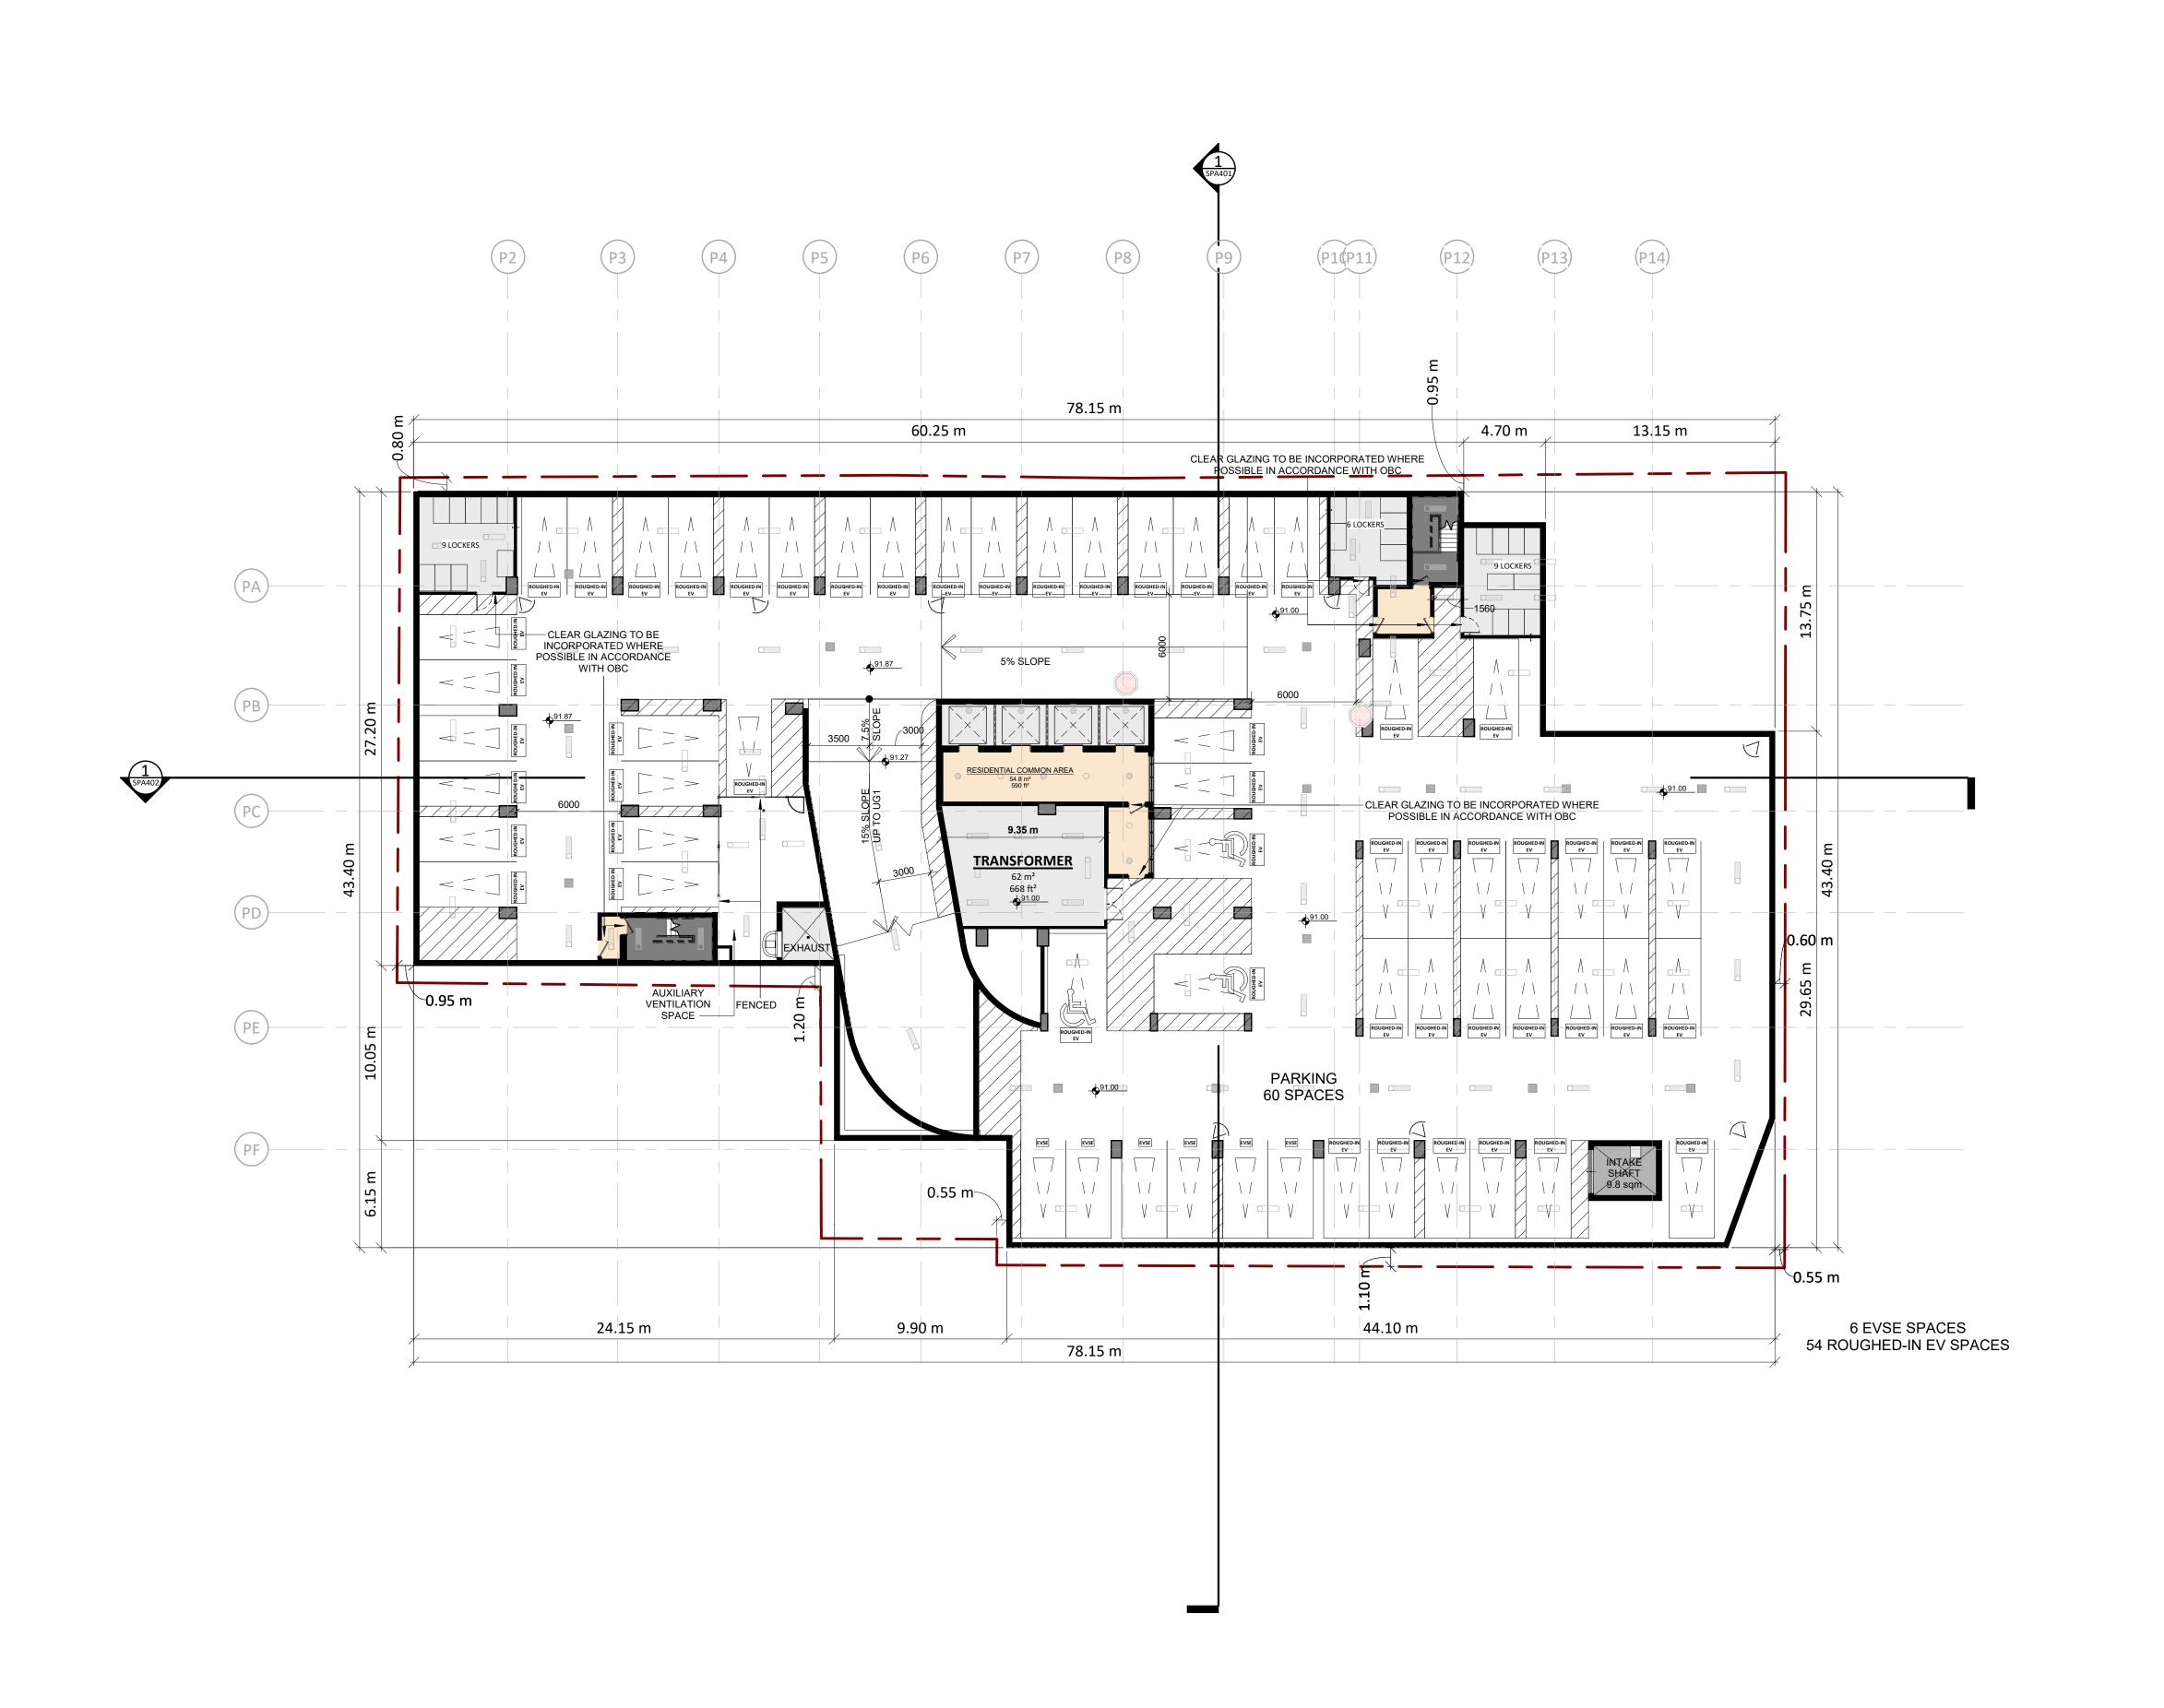
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RESIDENTIAL SOLID WASTE **MANAGEMENT** 

PROJECT NO. 18.189CS PROJECT DATE 2021-02-09 DRAWN BY MNZ CHECKED BY AYU

As indicated





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 7
 2021-02-09
 ISSUED FOR SPA
 AYU

 4
 2020-08-21
 ISSUED FOR SPA
 AYU

 3
 2020-07-23
 REVISED PER TRANSPORTATION COMMENTS
 AYU

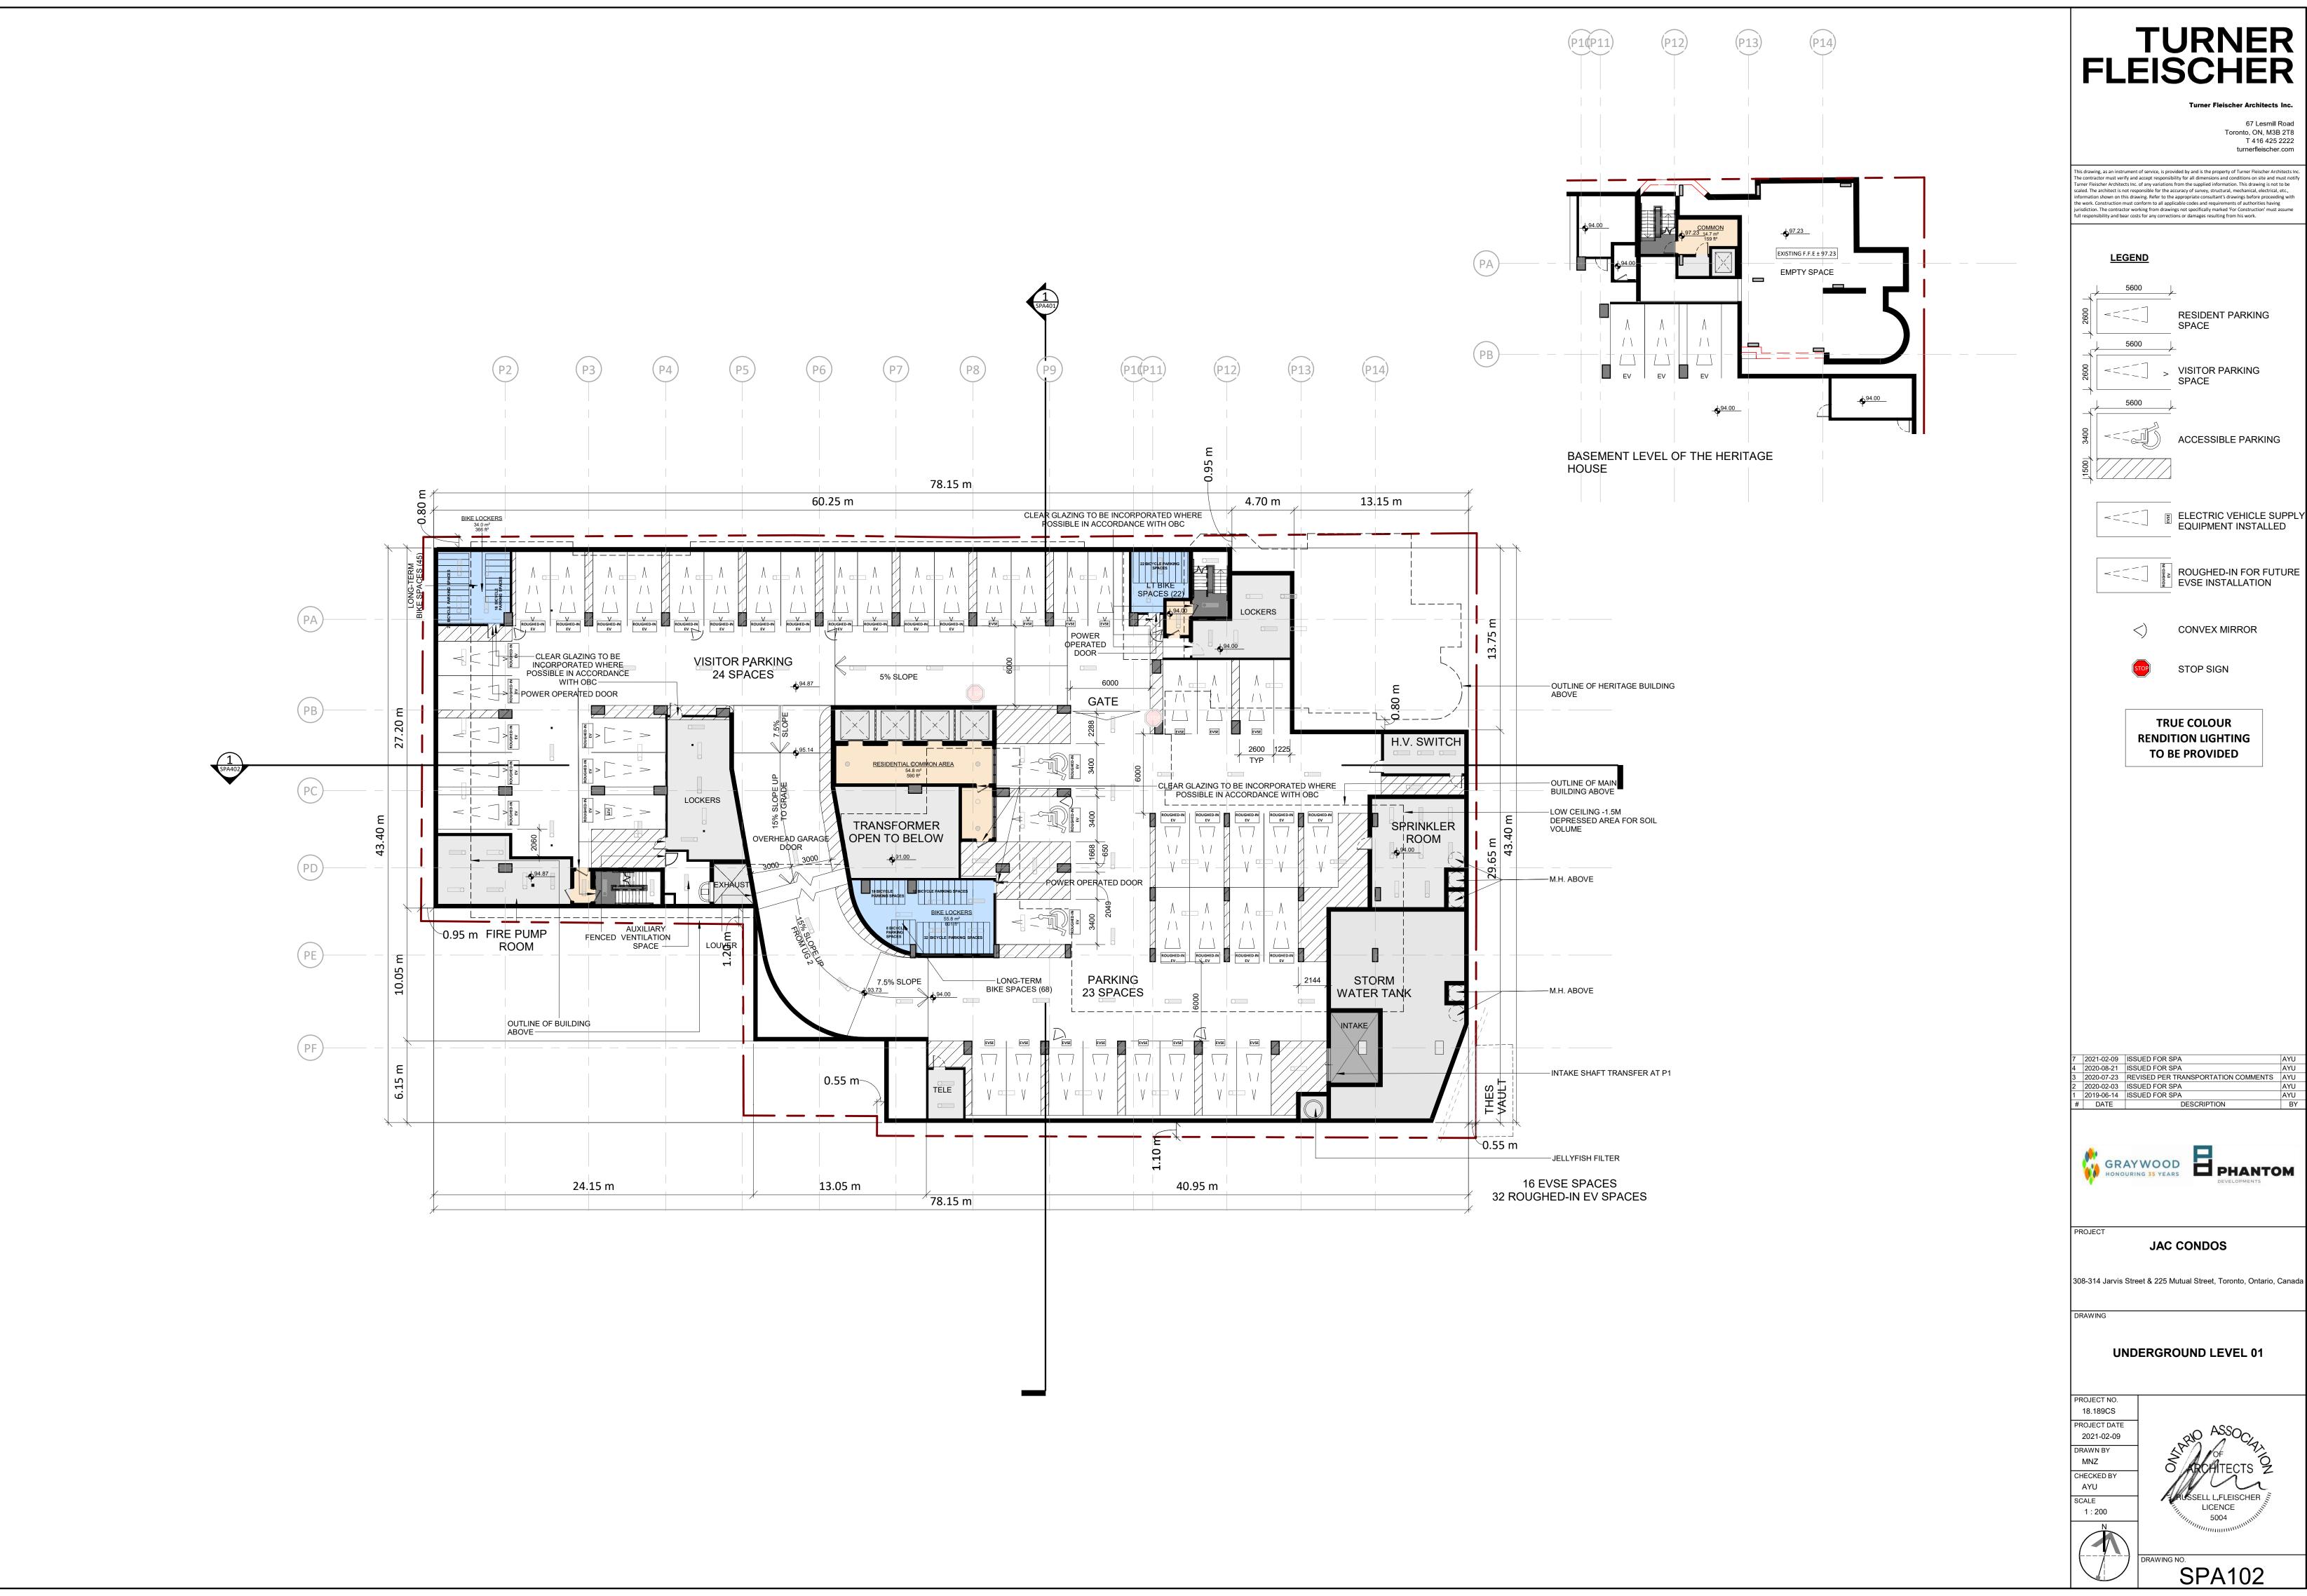
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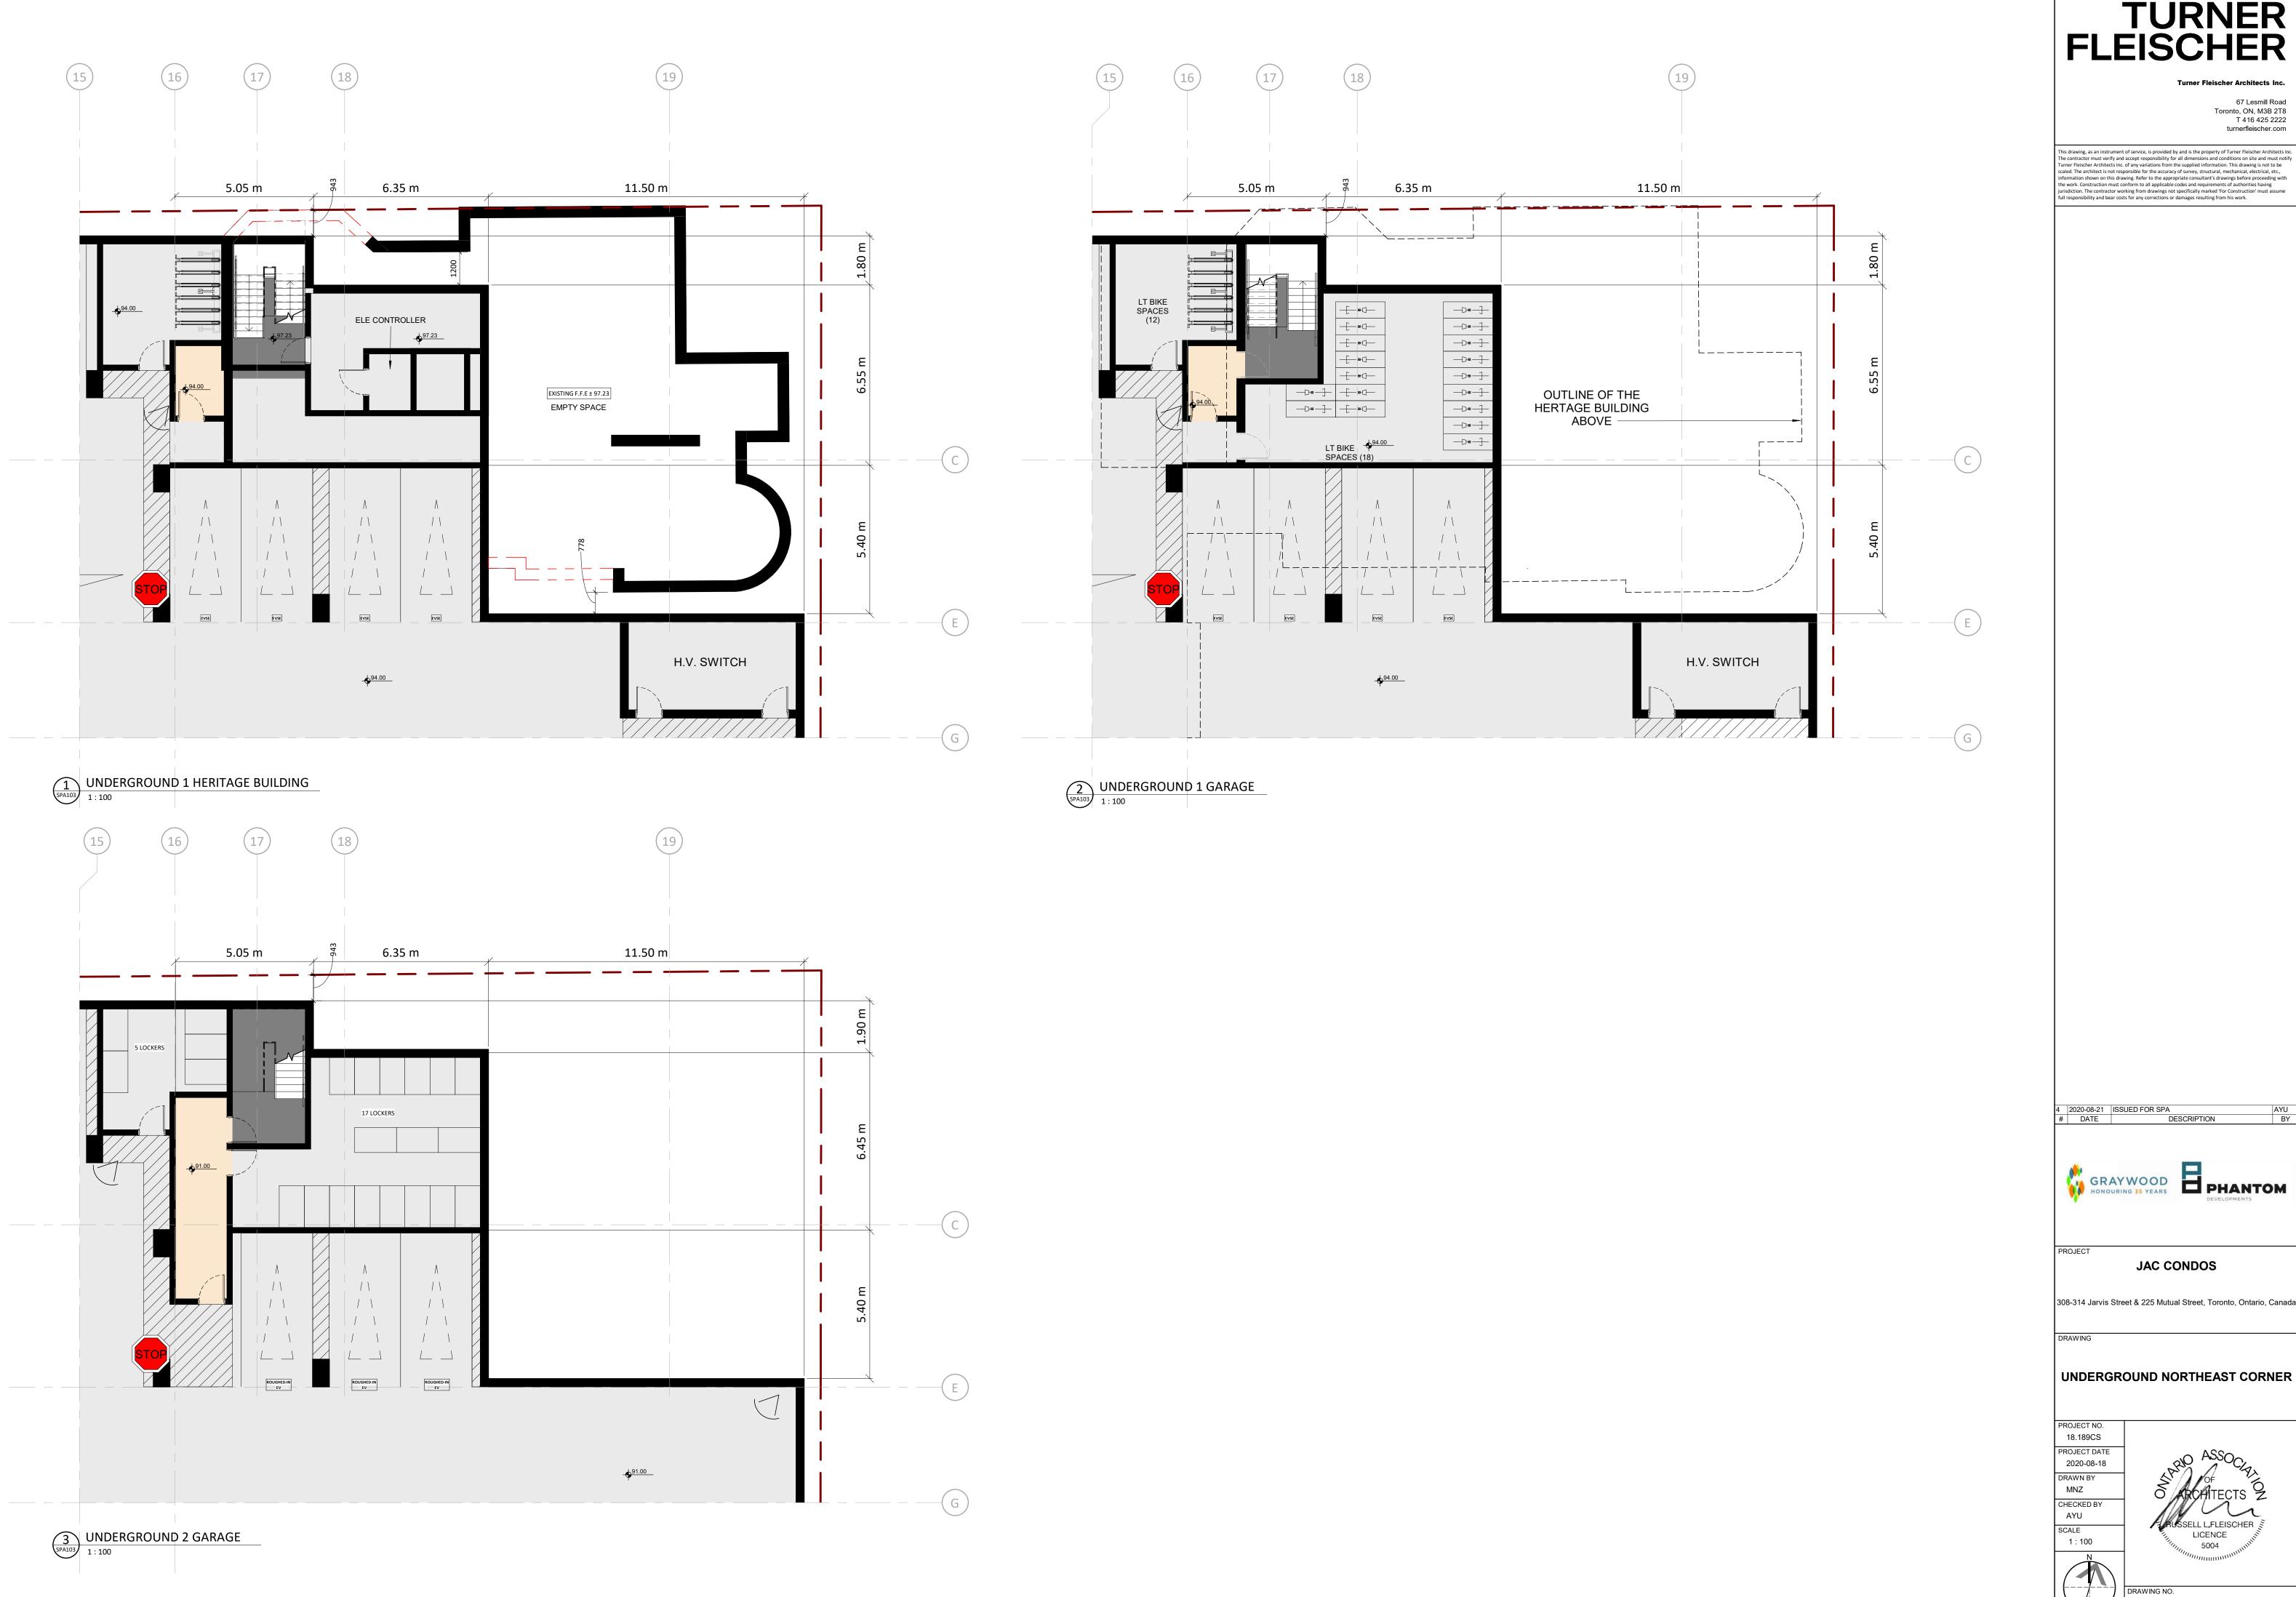
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 2019-06-14
 ISSUED FOR SPA
 AYU

 #
 DATE
 DESCRIPTION
 BY
 GRAYWOOD HONOURING 35 YEARS PHANTOM JAC CONDOS 308-314 Jarvis Street & 225 Mutual Street, Toronto, Ontario, Canada **UNDERGROUND LEVEL 02** PROJECT NO.

18.189CS PROJECT DATE 2021-02-09 DRAWN BY MNZ CHECKED BY AYU SCALE 1:200





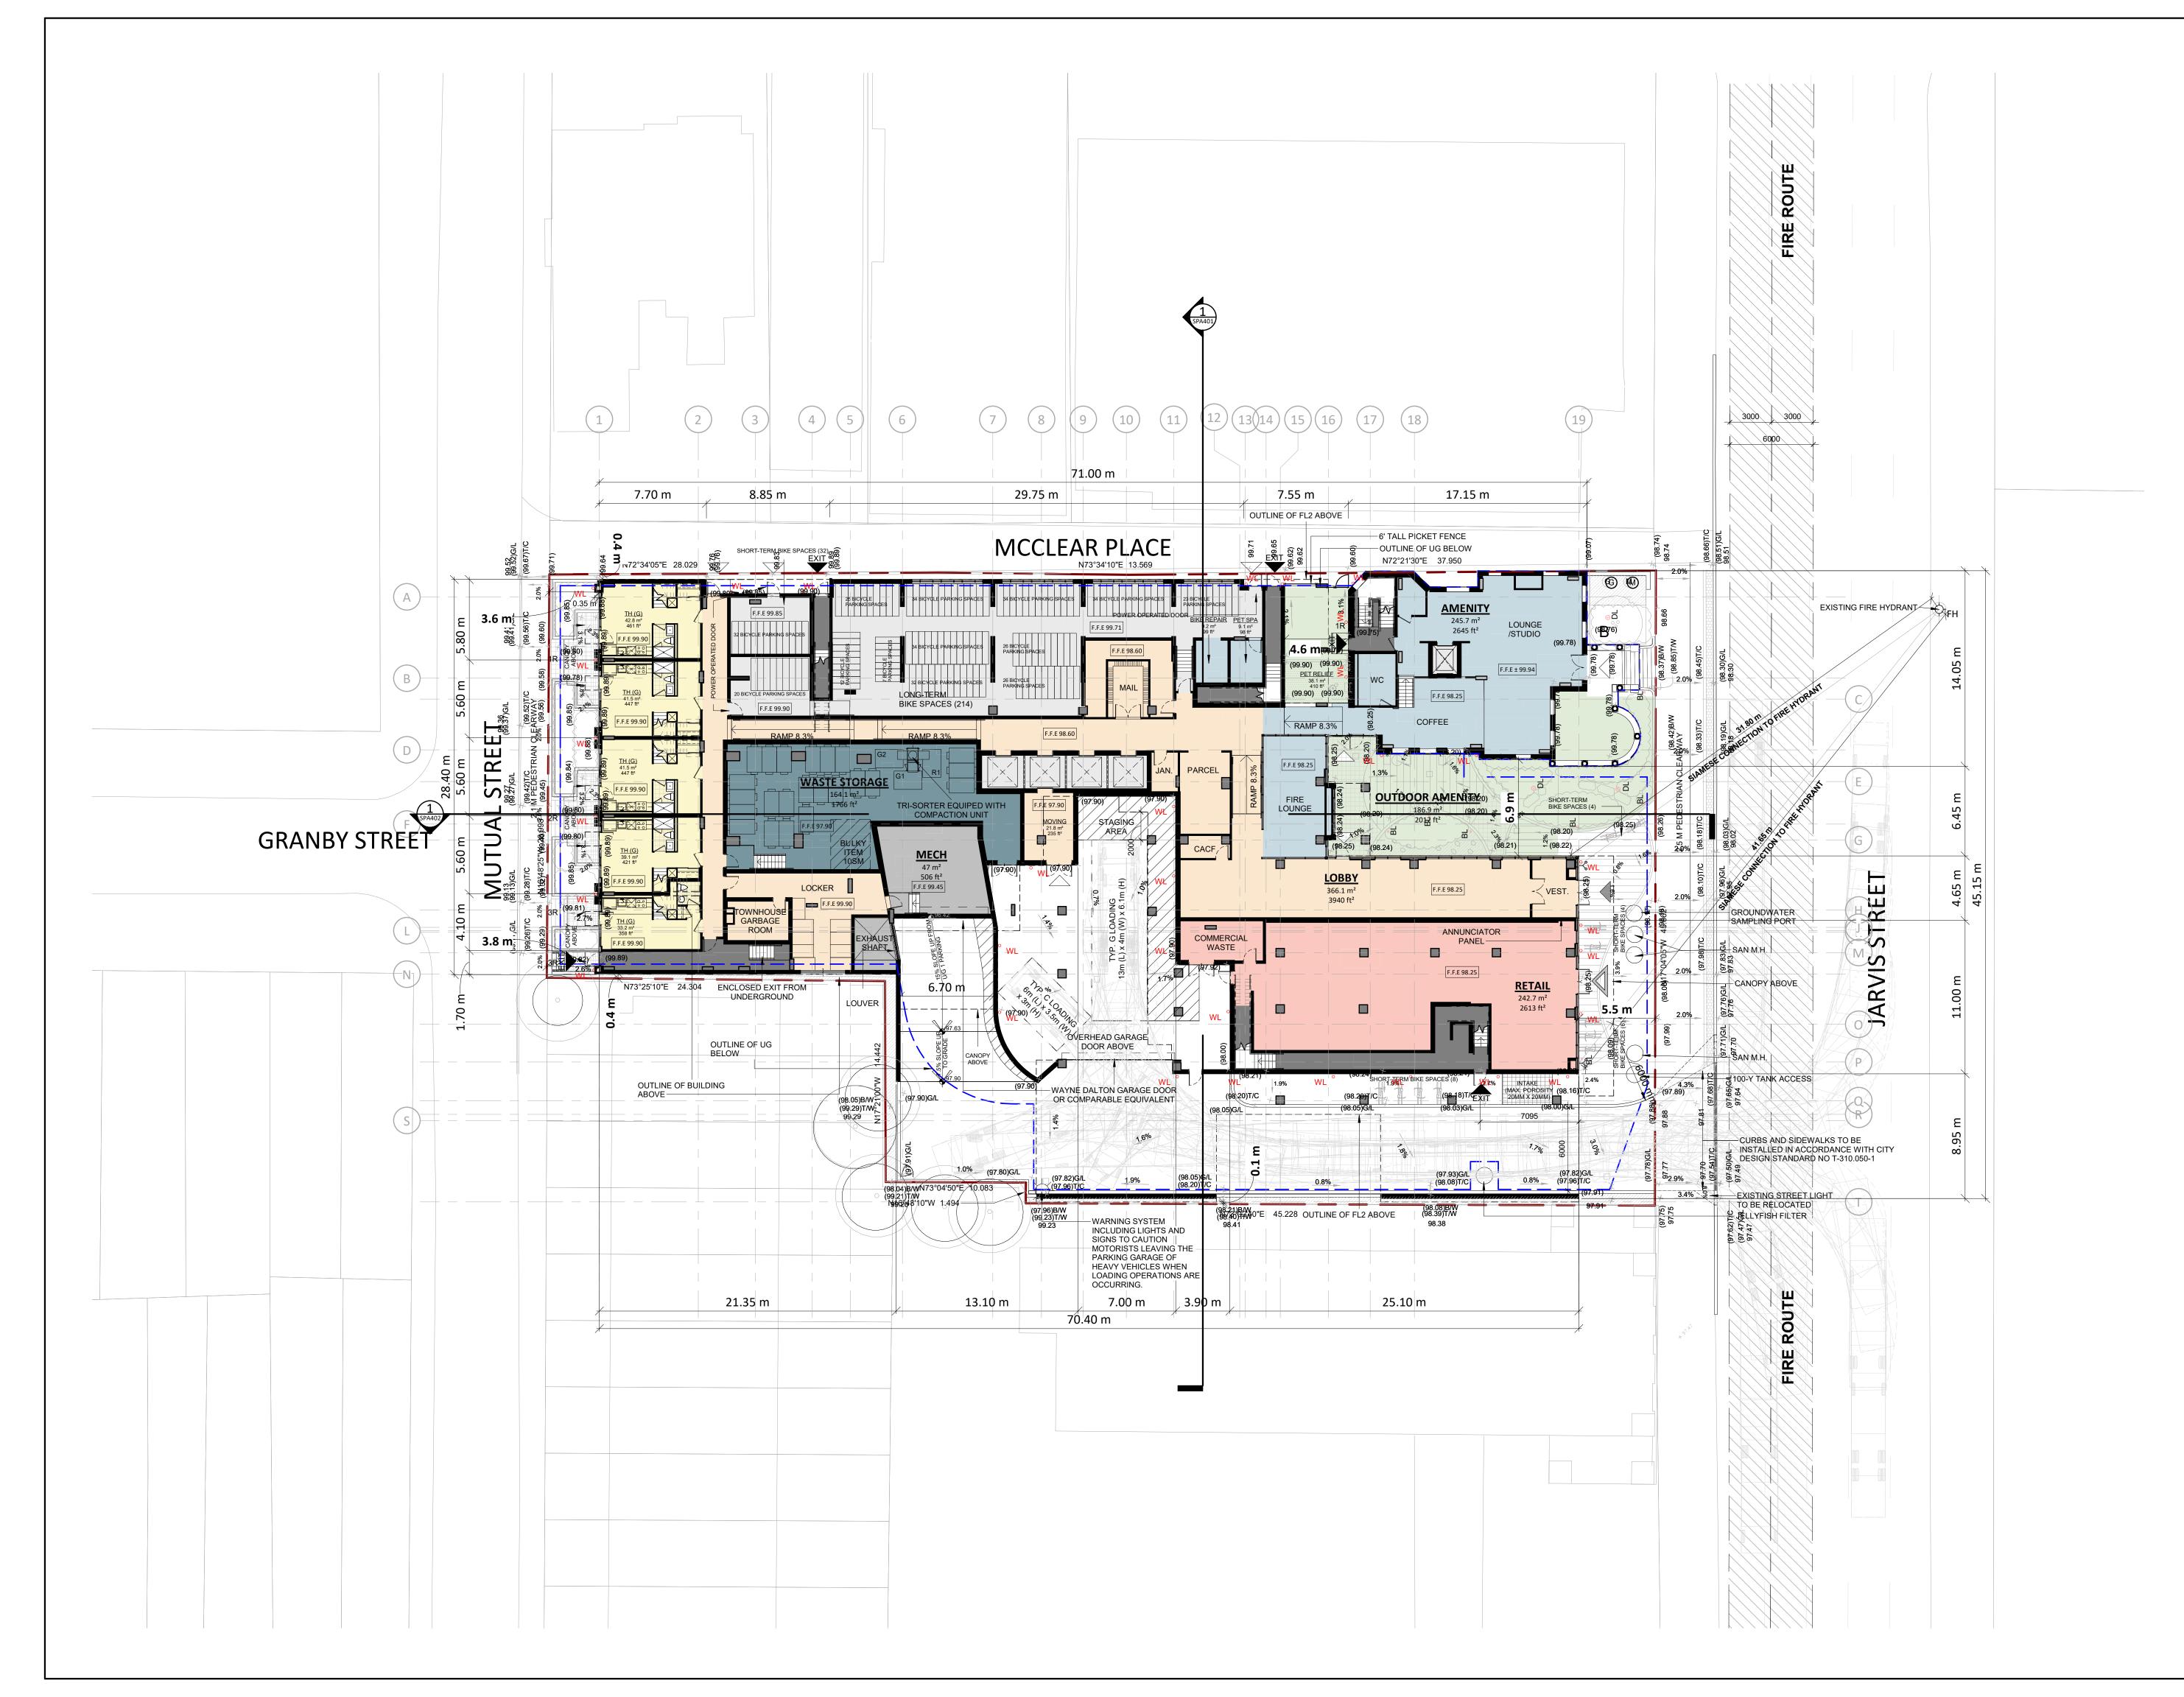


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<u>LEGEND</u>

PRIMARY ENTRANCE

SECONDARY ENTRANCE

RETAIL ENTRANCE

FIRE HYDRANT

**CONVEX MIRROR** 

GAS/HYDRO METER

SIAMESE CONNECTION

FIRE ROUTE

— – – — PROPERTY LINE

**EXTERIOR LIGHTING LEGEND** 

DIRECTIONAL LIGHTING

**BOLLARD LIGHT** 

WALL SCONCE

TRUE COLOUR **RENDITION LIGHTING** TO BE PROVIDED

7 | 2021-02-09 | ISSUED FOR SPA 4 | 2020-08-21 | ISSUED FOR SPA 2 | 2020-02-03 | ISSUED FOR SPA 1 | 2019-06-14 | ISSUED FOR SPA # DATE DES





JAC CONDOS

308-314 Jarvis Street & 225 Mutual Street, Toronto, Ontario, Canada

FLOOR 01

PROJECT NO. 18.189CS PROJECT DATE 2021-02-09 DRAWN BY MNZ CHECKED BY

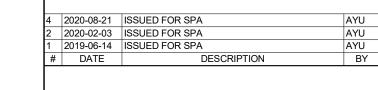
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PROJECT JAC CONDOS

308-314 Jarvis Street & 225 Mutual Street, Toronto, Ontario, Canada

DRAW

FLOOR 02

PROJECT NO.
18.189CS
PROJECT DATE
2020-08-18
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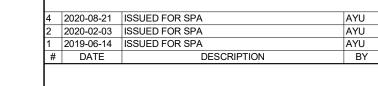


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PROJECT JAC CONDOS

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DRAW

FLOOR 03

PROJECT NO.
18.189CS
PROJECT DATE
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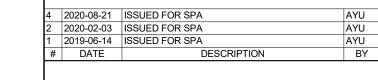




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DRAW

FLOOR 04

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4 2020-08-21 ISSUED FOR SPA # DATE DESCRIPTION





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FLOOR 05-06

PROJECT NO. 18.189CS PROJECT DATE 2020-08-18 DRAWN BY
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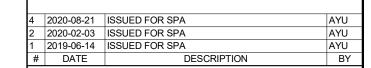
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EXTERIOR LIGHTING LEGEND

**BL** BOLLARD LIGHT

∘WL WALL SCONCE

TRUE COLOUR
RENDITION LIGHTING
TO BE PROVIDED





JAC CONDOS

308-314 Jarvis Street & 225 Mutual Street, Toronto, Ontario, Canada

DRAV

FLOOR 07

PROJECT NO.
18.189CS
PROJECT DATE
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 2020-08-21
 ISSUED FOR SPA
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 2
 2020-02-03
 ISSUED FOR SPA
 AY

 1
 2019-06-14
 ISSUED FOR SPA
 AY

 #
 DATE
 DESCRIPTION



DJECT

JAC CONDOS

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FLOOR 08

PROJECT NO.
18.189CS
PROJECT DATE
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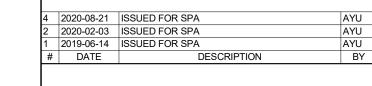




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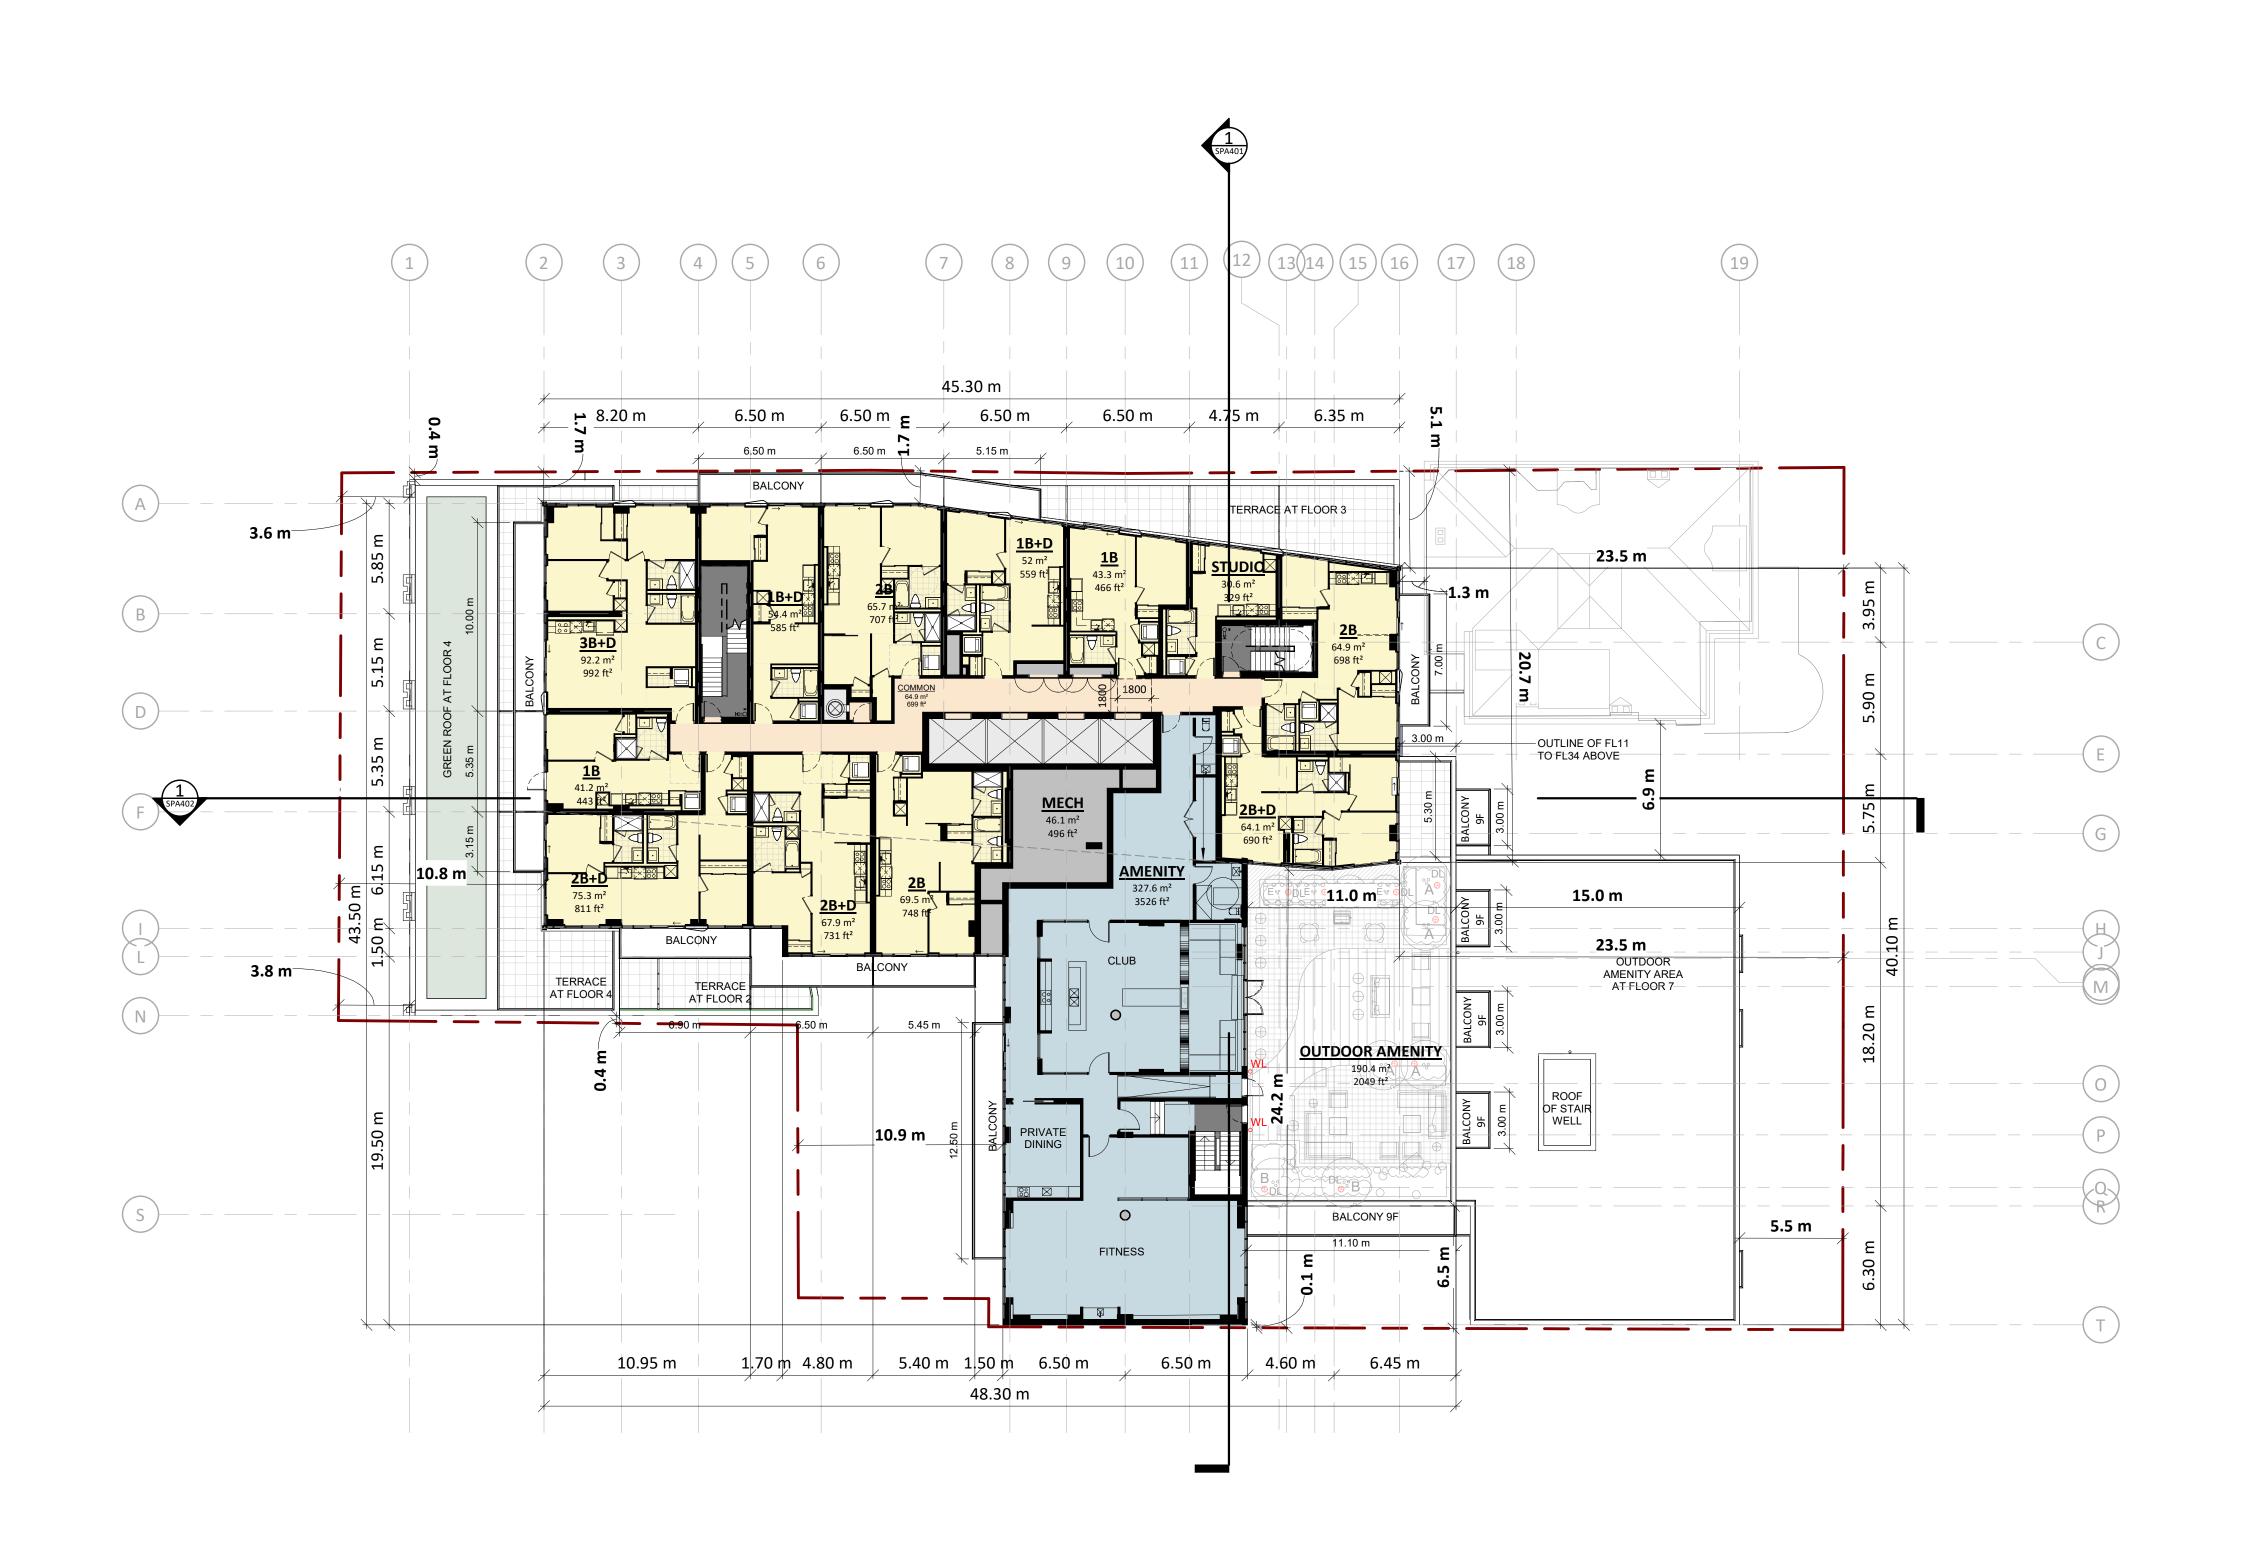
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FLOOR 09

PROJECT NO.
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EXTERIOR LIGHTING LEGEND

BL BOLLARD LIGHT

• WL WALL SCONCE

TRUE COLOUR
RENDITION LIGHTING
TO BE PROVIDED







JAC CONDOS

308-314 Jarvis Street & 225 Mutual Street, Toronto, Ontario, Canada

DRAW

FLOOR 10

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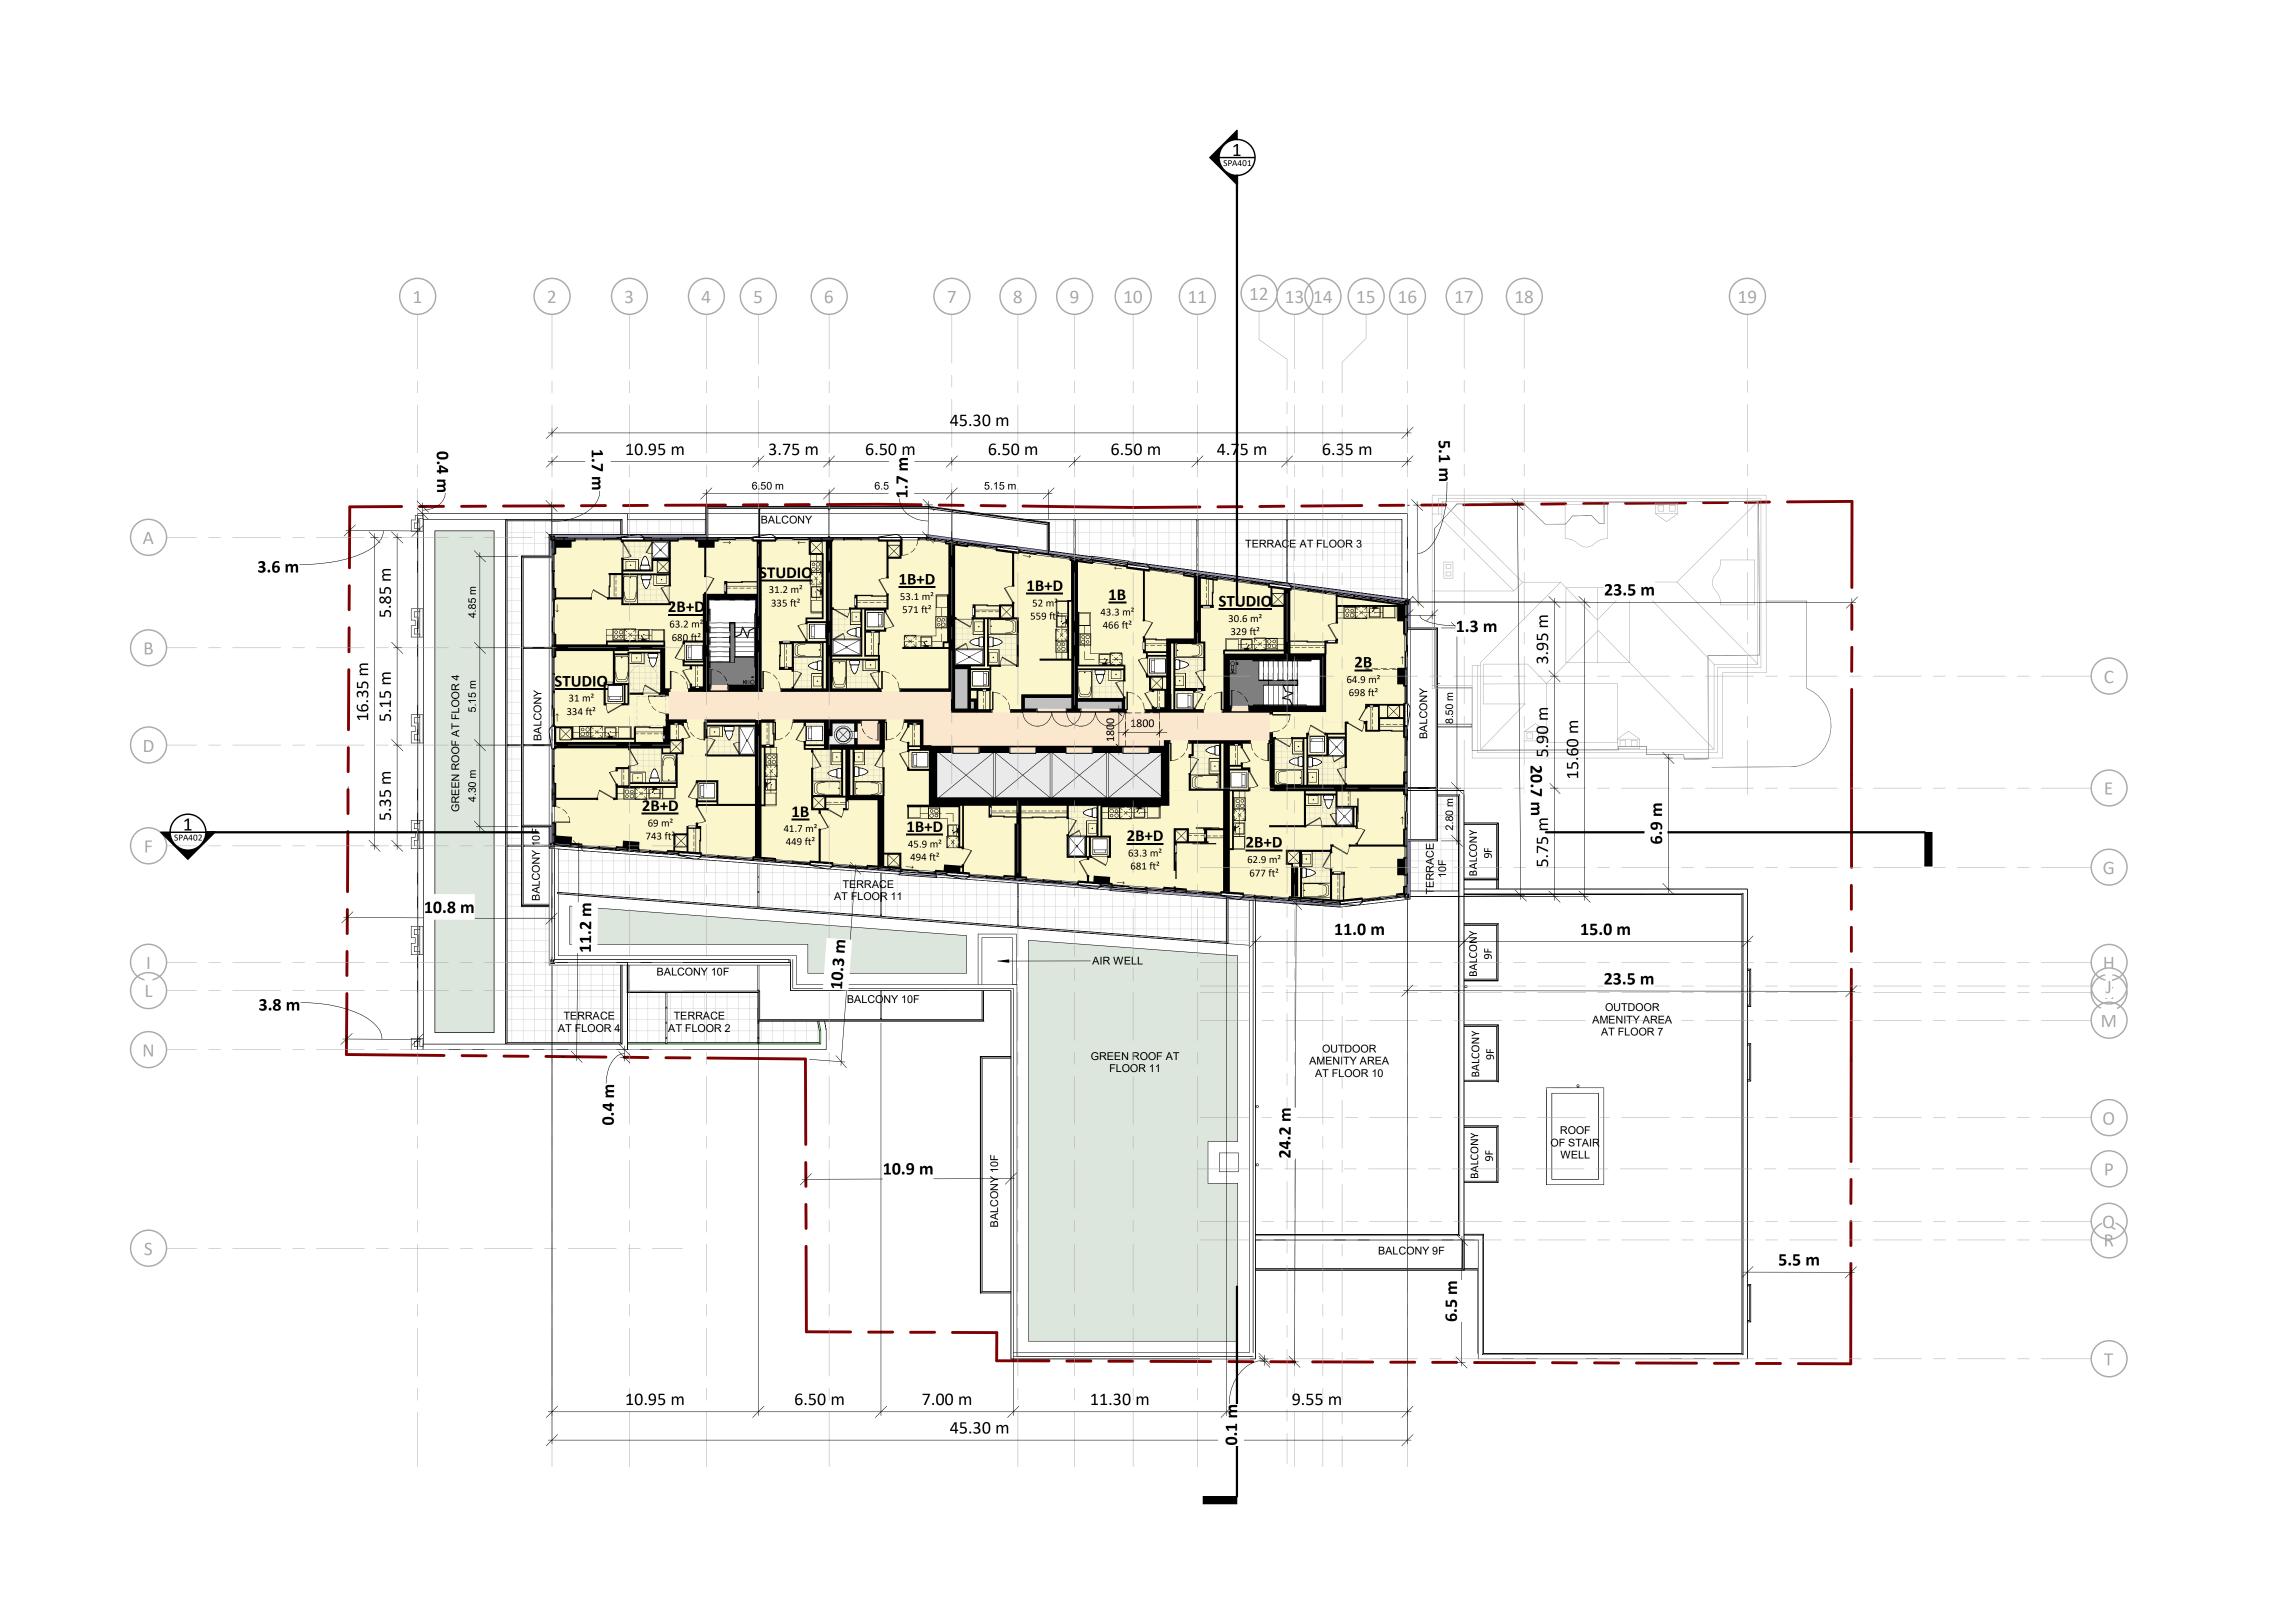
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FLOOR 11

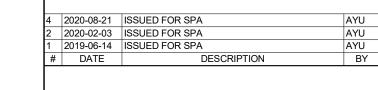
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FLOOR 12-34

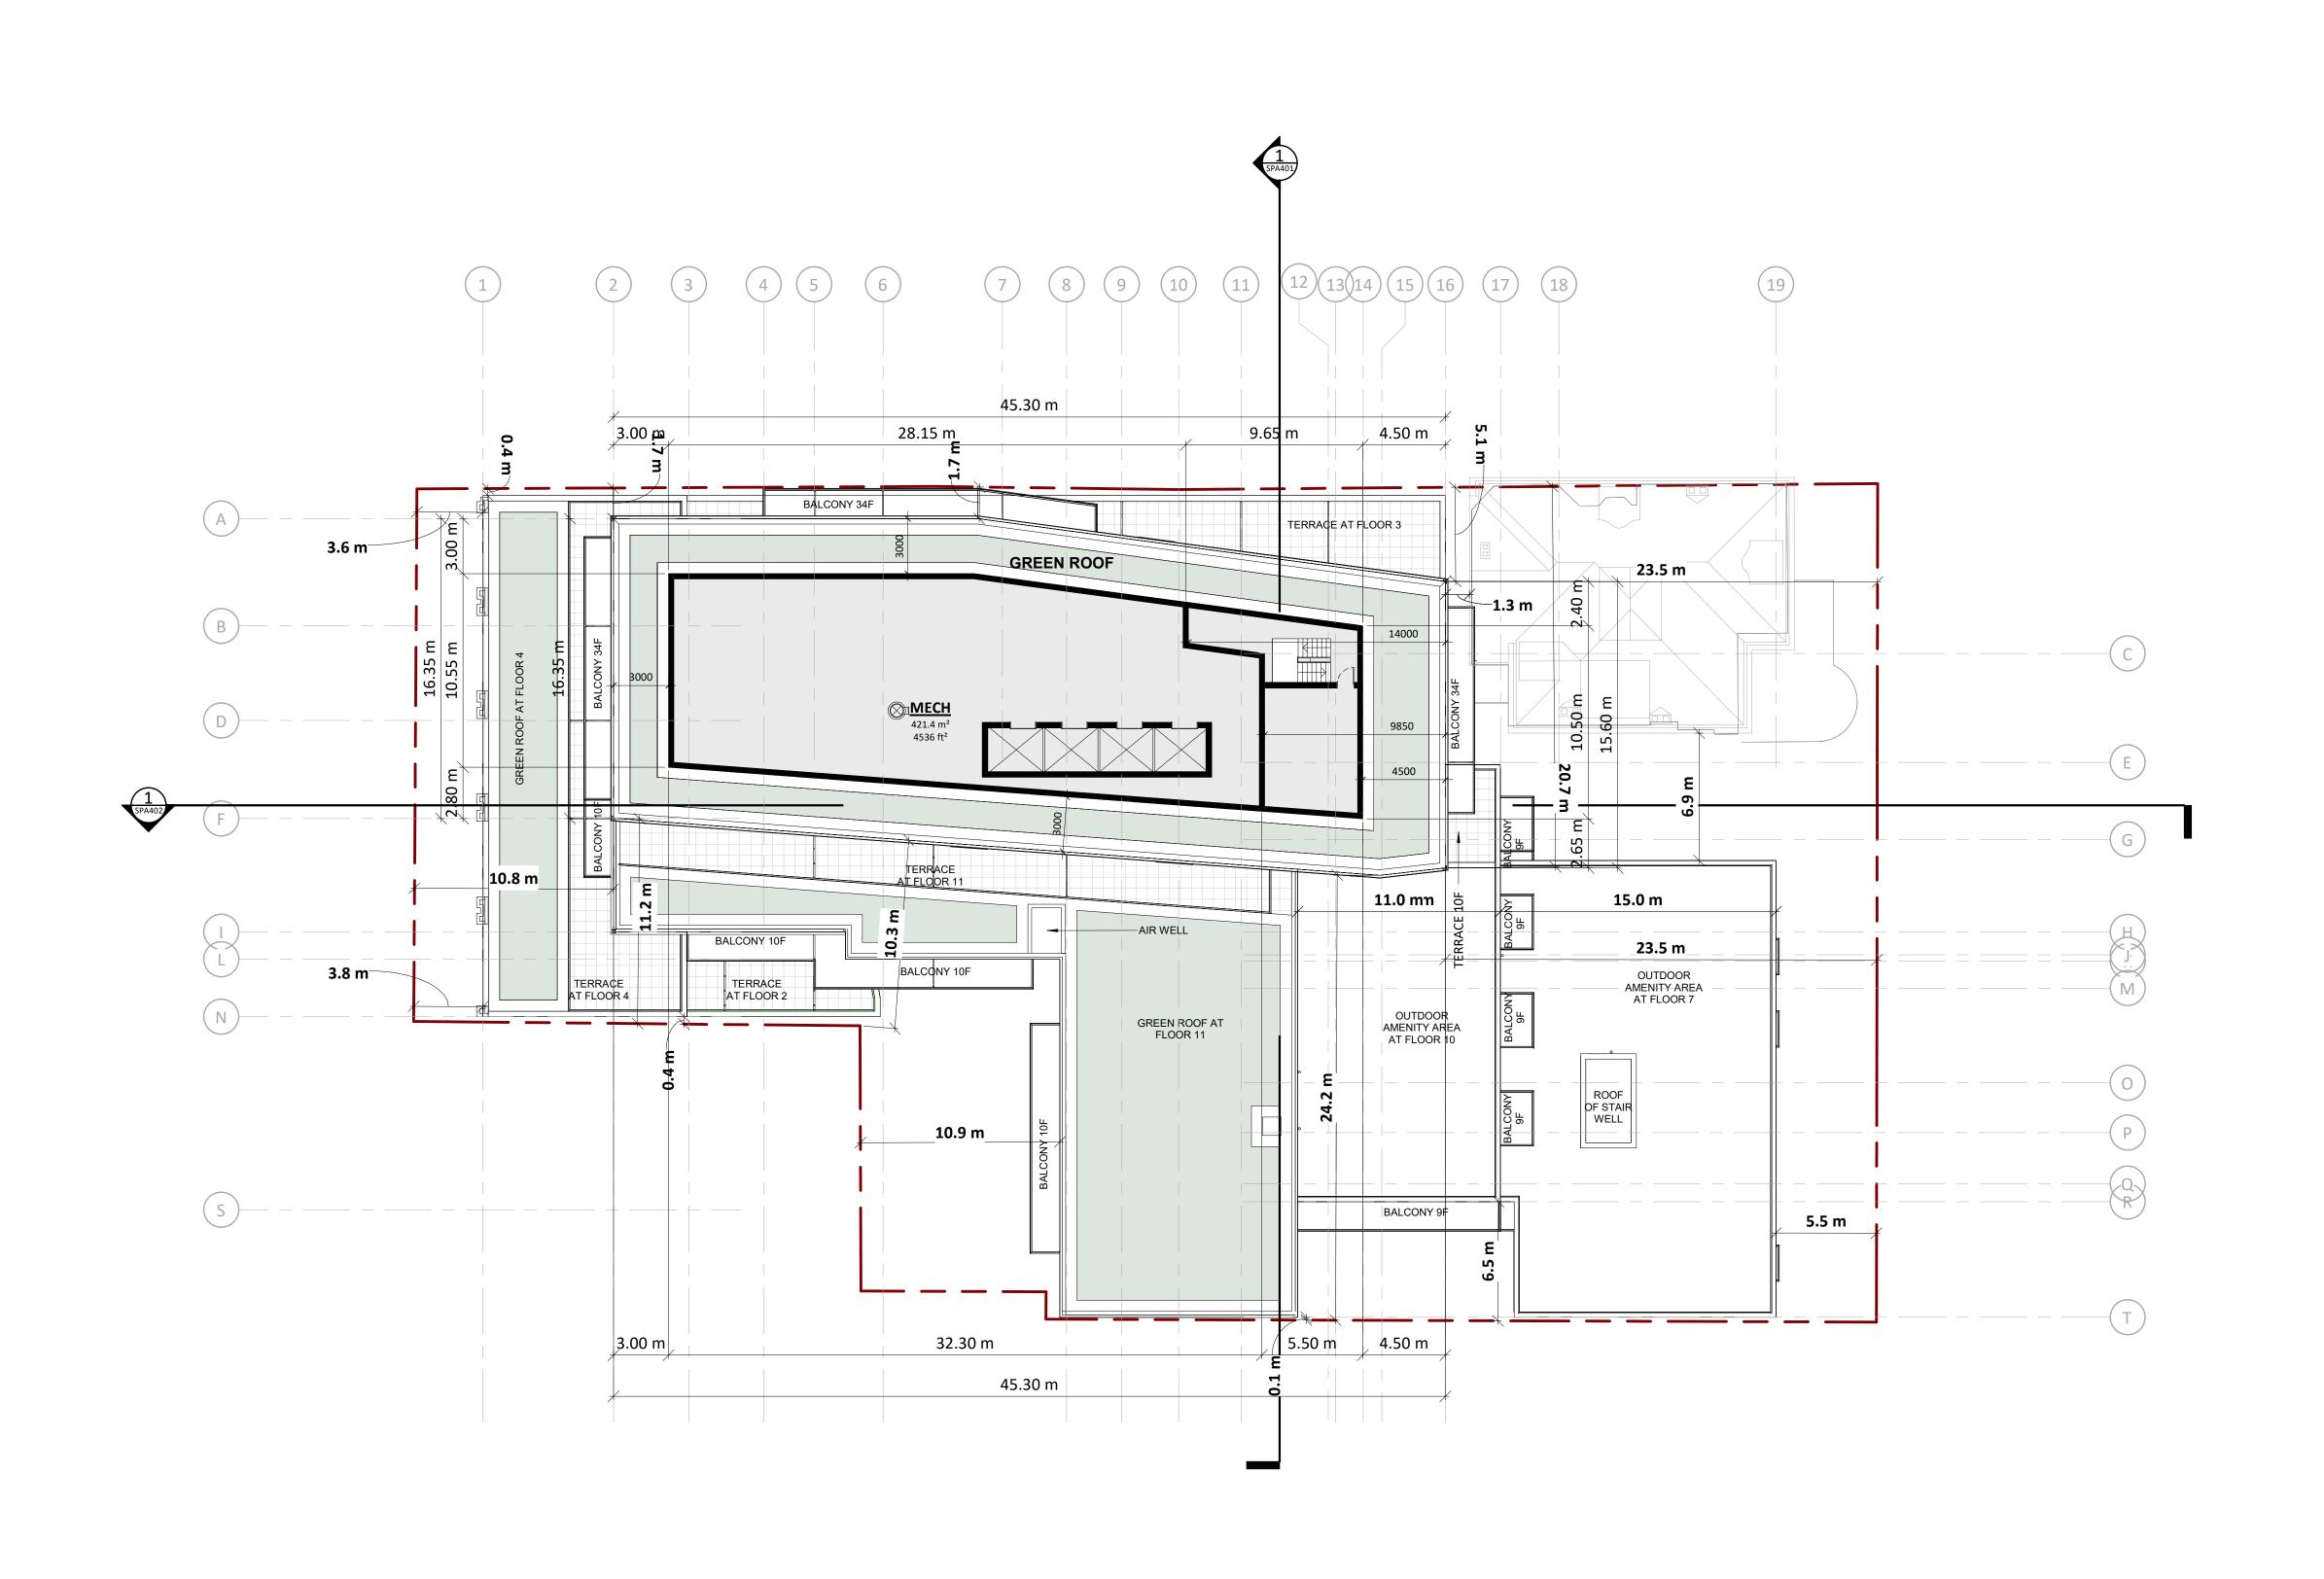
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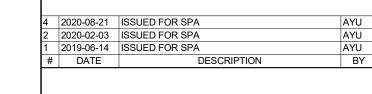
SSELL L.FLEISCHER



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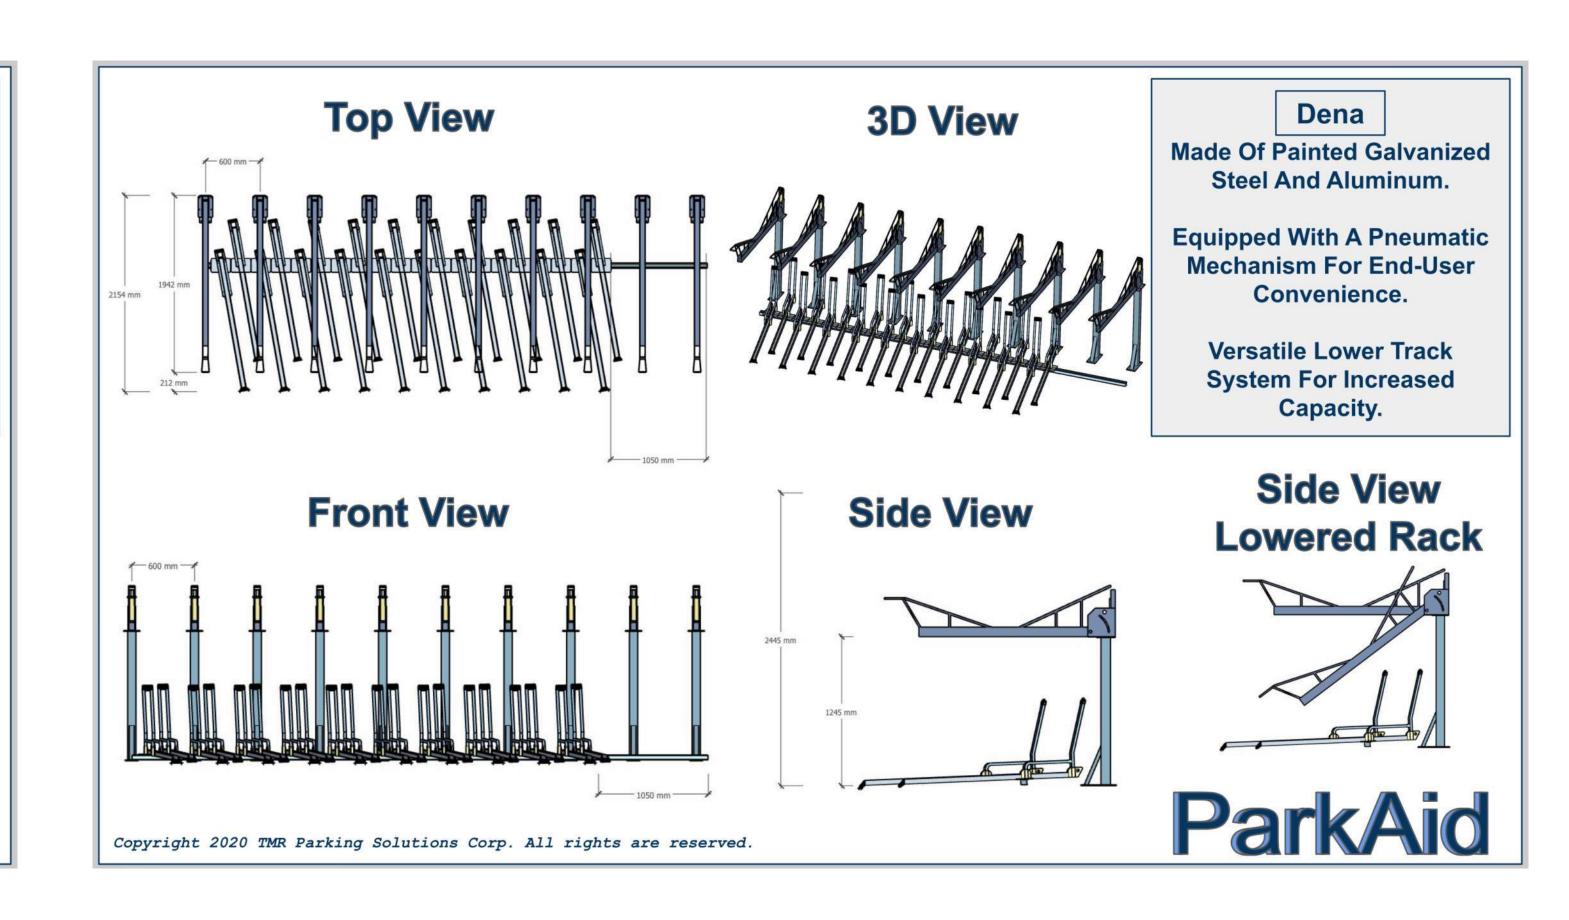
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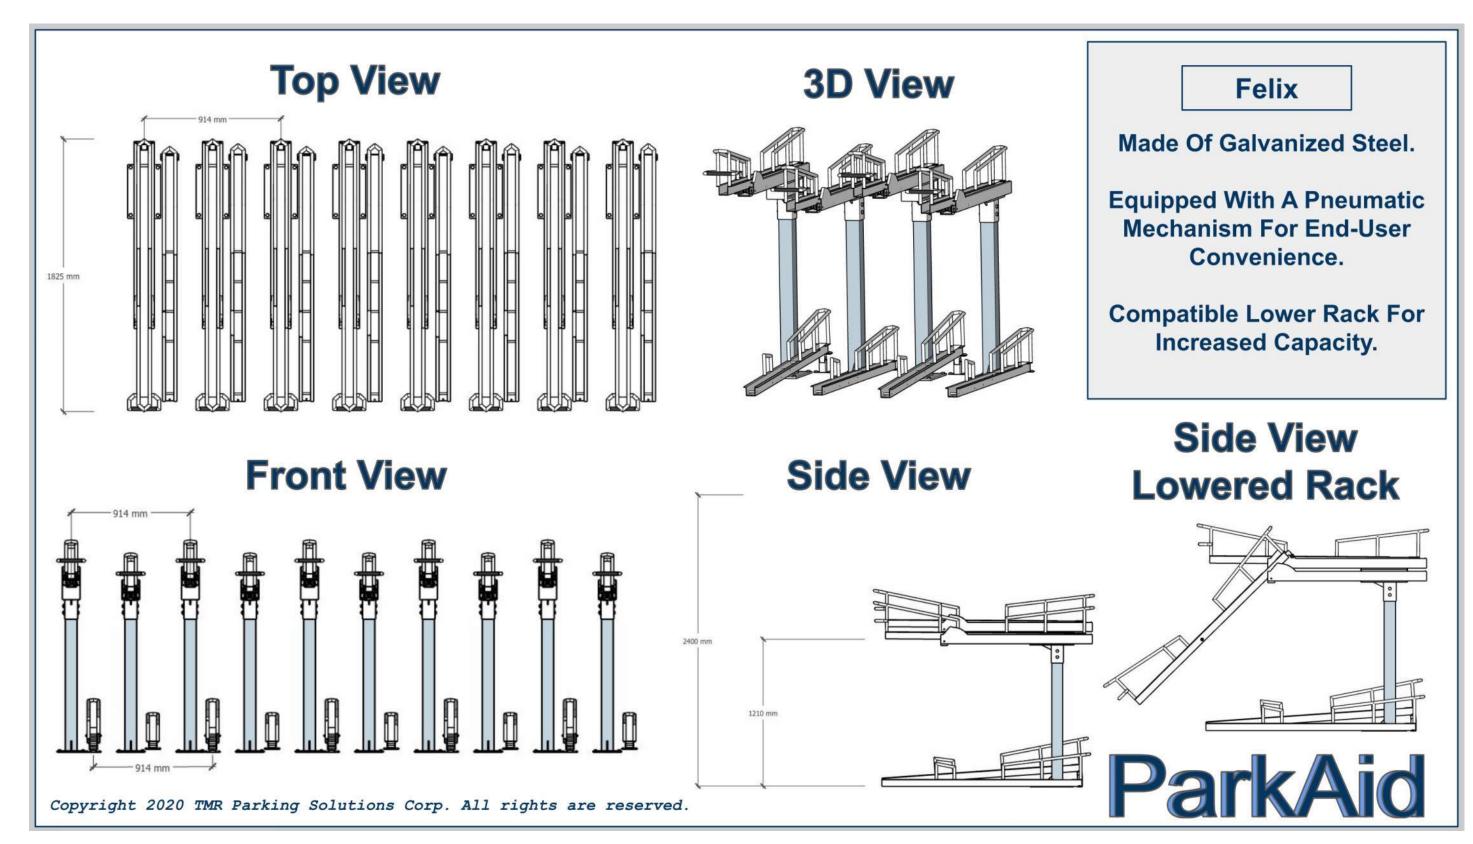
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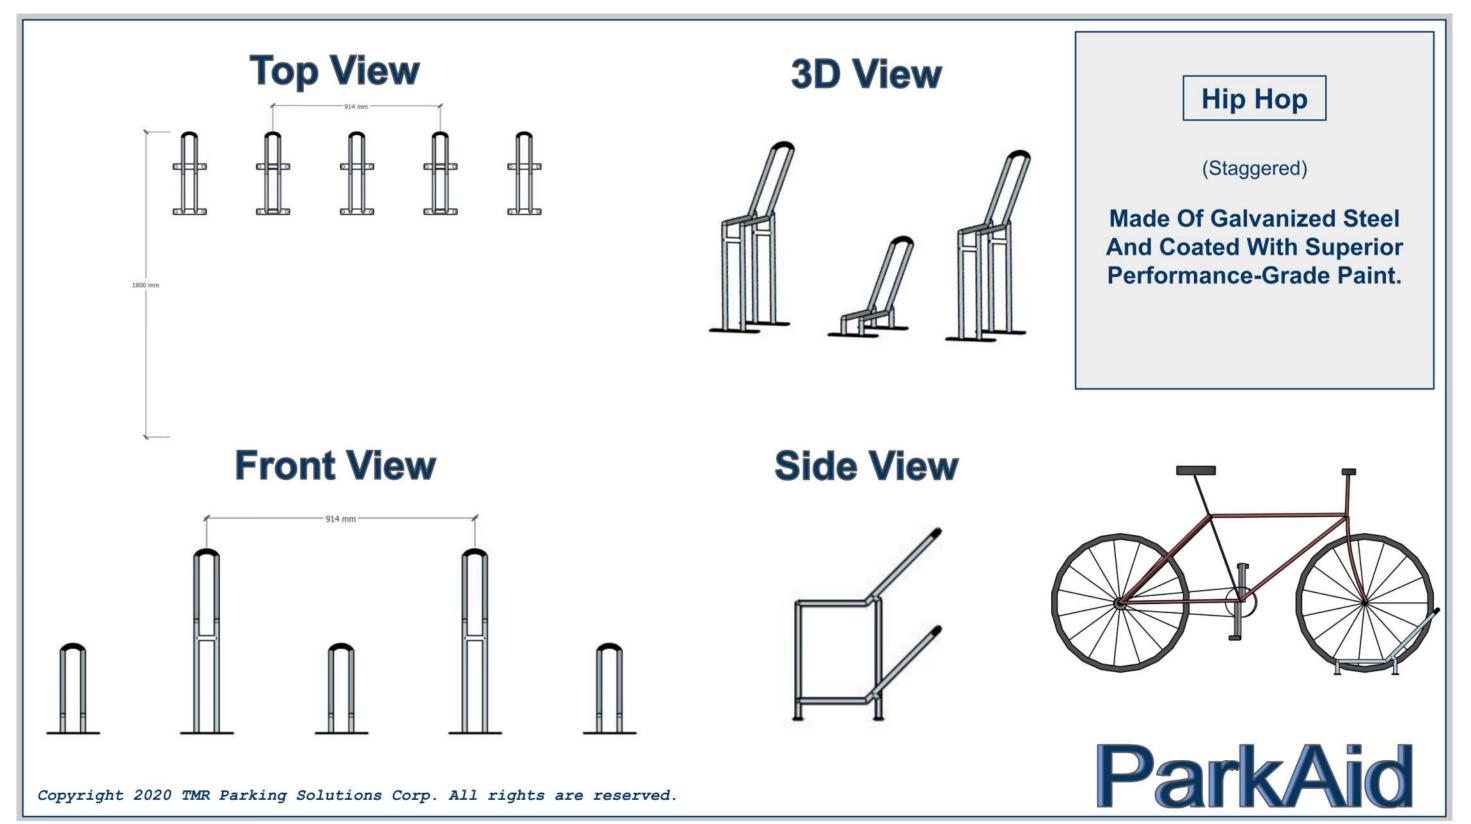
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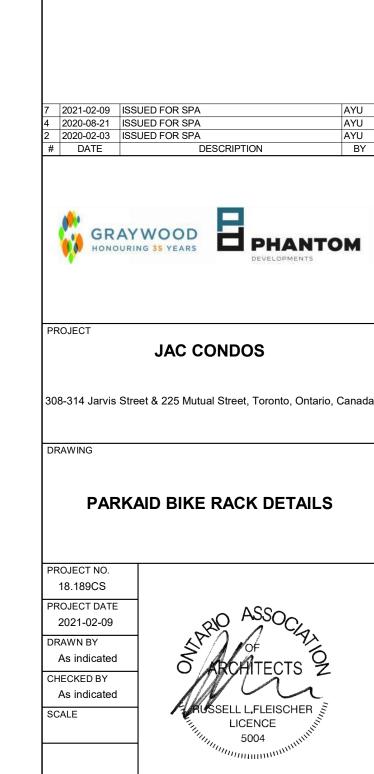


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SPA900

TURNER FLEISCHER

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