Public Attachment 2 35-39 HOLMES AVENUE 17 STOREY RESIDENTIAL BUILDING GFFE :192.59 0 0 GFFE :191.25 MORE THAN 6.1M VERTICAL CLEARANCE P.I.N. 10080-0319 (LT) L O A101/ N.T.S SIDEWALK UNDER PODIUM 0 4 LAWN/SNOW \ STORAGE | B/W 187.87 T/W 191.38 SITE STATISTICS B/W [190.42] T/W 191.16 RAMP UP TO GRADE 2,376.40 190.70 SLOPE UP AT 7.5% SLOPE UP AT 15% SLOPE UP AT 7.5% 1.0m 400 DROPPED CURB CURRENT EASEMENT ACCESS TO 60 BYNG T/W 191.23 T/W 191.23 PROPOSED: B/W 188.49 B/W 187.87 DETAIL 1 191.09 OUTLINE OF UG BELOW 685.80 **Building Footprint at Grade** 28.86% _____ Ashphalt/Driving Surfaces 346.40 14.58% 144.40 6.08% Intake & Exhaust & Transformer 10.40 0.44% Total Hard Landscape 615.10 25.88% **Total Soft Landscape** 550.90 23.18% 23.40 0.98% **Total Permeable Surface** Total Landscaped 1,189.40 50.05% *Please note percentages above based on NET site area 17.32 TO IS TO STATE OF THE PROPERTY Required Area for Snow Strage 18.00 **Provided Area for Snow Strage** DECUME DISCOURS SERVICES SOALE N.T.S.

DECUME DISCOURS SERVICES UNIT SUNCE, 2001 URBAN ENTRANCES **M** Toronto 04 URBAN ENTRANCE DETAIL 03\SITE STATISTICS 1. THE EXISTING CURBS AT THE PROPOSED ENTRANCES ARE REMOVED AND REPLACE WITH CONCRETE CURBS AND GUTTERS 1. STATISTICS FOR BOTH TORONTO BY-LAW 569-2013 AND NORTH YORK BY-LAW 7625 CAN BE FOUND ON SHEET A102. AS PER CITY STANDARD T-600.05-1 2. FOR COMPLETE GRADING AND SERVICING INFORMATION, REFER TO DRAWINGS PROVIDED BY C.F. CROZIER & ASSOCIATES INC. 2. THE ENTRANCE WILL BE CONSTRUCTED AS PER CITY STANDARD T-350.01. 3. FOR COMPLETE LANDSCAPING INFORMATION, REFER TO DRAWINGS PROVIDED BY STANTEC CONSULTING LTD. 3. THE ENTRANCE RETURN CURBS WILL BE CONSTRUCTED UP TO THE EDGE OF PROPOSED SIDEWALK RATHER THAN ACROSS 4. FOR COMPLETE TRAFFIC INFORMATION, REFER TO REPORTS AND DRAWINGS PROVIDED BY LEA CONSULTING LTD. THE PROPOSED SIDEWALK LL DRAWNGS AND RELATED DOCUMENTS ARE THE OPYRIGHT PROPERTY OF ICON ARCHITECTS INC. NO ASSOCIATIO CONTEXT PLAN, SITE PLAN, SITE AND MUST BE RETURNED UPON REQUEST.
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ARCHITECTS Z

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35-39 HOLMES AVENUE

TORONTO, ONTARIO

Đ ≥ F PLOT DATE November 20, 2020

Drawn by: **HT**

HG

A101

Checked by:

Drawing No.

1:200

Project No.

17113

NOVEMBER 20 2020

Statistics

	m2	ft2
Site Area	2,376.40	25,580
Total GFA	10,717.30	115,361
Total PSI (Total Site Area)	4.51	
Total Units	154	
Coverage	689.20	29.00%
tal Height (North York By-Law)	53,30	



	Area		Te I	Max GFA as per Secondary Plan		
	m2	ft2	FSI	m2	ft2	
35 Holmes	899.00	9676.8	3.46	3110.54	33481.9	
37 Holmes	711.50	7658.6	3.46	2461.79	26498.7	
39 Holmes	765.90	8244.1	3.46	2650.01	28524.8	
Total				8222.34	88505.3	

	CT A 18FAL	out deductions			GFA deductions						то.		Units		
Floors	GA WILII	out negations	elevators and main pipe shaft	Fresh air	pipe spaces/u	heating units/u	electrical closet	chute	Total deductable	GFA			Units		Total
m2 ft2	10.00	1.30	1.40	0.50	3.00	3.20		m2	ft2	1B/1B+D	2B/2B+D	3B			
UG2	52.70	567								52.70	567	0	0	0	0
UG1	44.60	480				<u></u>				44.60	480	0	0	0	0
1	557.20	5,998	10.00	0.00	4.20	1.50	0.00	0.00	15.70	541. 50	5,829	0	2	1	3
2	565.50	6,087	10.00	1.30	1.40	0.50	3.00	3.20	19.40	546.10	5,878	1	0	O	1
3	796.50	8,574	10.00	1.30	16.80	6.00	3.00	3, 20	40.30	756.20	8,140	9	2	1	12
4	663,10	7,138	10.00	1.30	11.20	4.00	3.00	3, 20	32.70	630.40	6,786	6	1	1	8
5	663.10	7,138	10.00	1.30	14.00	5.00	3.00	3, 20	36.50	626.60	6,745	7	2	1	10
6	663.10	7,138	10.00	1.30	14.00	5.00	3.00	3, 20	36.50	626.60	6,745	7	2	1	10
7	663.10	7,138	10.00	1.30	14.00	5.00	3.00	3, 20	36.50	626.60	6,745	7	2	1	10
8	663.10	7,138	10.00	1.30	14.00	5.00	3.00	3, 20	36.50	626.60	6,745	7	2	1	10
9	663.10	7,138	10.00	1.30	14.00	5.00	3.00	3, 20	36.50	626.60	6,745	7	2	1	10
10	663.10	7,138	10.00	1.30	14.00	5.00	3.00	3, 20	36.50	626.60	6,745	7	2	1	10
11	663.10	7,138	10.00	1.30	14.00	5.00	3.00	3, 20	36.50	626.60	6,745	7	2	1	10
12	663.10	7,138	10.00	1.30	14.00	5.00	3.00	3.20	36.50	626.60	6,745	7	2	1	10
13	663.10	7,138	10.00	1.30	14.00	5.00	3.00	3, 20	36.50	626.60	6,745	7	2	1	10
14	663.10	7,138	10.00	1.30	14.00	5.00	3.00	3, 20	36.50	626.60	6,745	7	2	1	10
15	663.10	7,138	10.00	1.30	14.00	5.00	3.00	3.20	36.50	626.60	6,745	7	2	1	10
16	663.10	7,138	10.00	1.30	14.00	5.00	3.00	3, 20	36.50	626.60	6,745	7	2	1	10
17	663,10	7,138	10.00	1.30	14.00	5.00	3.00	3.20	36.50	626.60	6,745	7	2	1	10
MPH	0.00	0.00								0.00	0.00	0	0	0	0
Total	11,299.90	121,632.12							582.60	10,717.30	115, 361.02	107	31	16	154

Туре	York Center Secondary Plan) Number of units	Ratio	Parking spaces
Residents	154	0.9	138
Visitors	154	0.1	15
tal Required			153

wided		T 2500 T	C		I arrest a I	
Floor	Spaces	Туре	Car share Ratio	Total	Total of Each Type	Ratio
	15	Visitors	N/A	15	15	0.10
UG-1	25	Residents	N/A	25		
	2	Car Share-Residents	4	8		0.53
UG-2	48	Residents	N/A	48		
Total Provided					96	0.62

Amenity Required	
Туре	

Туре	Number of units	Ratio (m2)	m2	ft2
Indoor Amenity	154	1.5	231.00	2,486
Outdoor Amenity	154	15	231.00	2,486
Total			462.00	4,973

ity Provided		
Туре	m2	ft2
Indoor Amenity	238.40	2,566
Outdoor Amenity	430.70	4,636

Piercle Parking Peguired

Туре	Units	Ratio	Spaces
Long term	154	0,68	104.7
Short term	154	0.07	10.78
Total Required	[4]		115.5

Туре	Location	Spaces	% of Net Floor Area Occupied by Bicy de Room
	UG1	20	3.96%
Long term	Ground Floor	53	20.77%
	Second Floor	32	12.71%
Shart term	Grade	11	N/A
Total Provided		116	CV.

NOTE: Above Net Floor Area excludes area of elevator shafts, drive aisles, exit stairs, air ducts, loading area, garbage shoute mechanical and

NORTH YORK BY-LAW 7625 STATISTICS

N.T.S

- GROSS FLOOR AREA shall mean the aggregate of the areas of each floor, measured between the exterior faces of the exterior walls of the building or structure at the level of each floor, including any areas used as balconies, but excluding:
- (i) any part of the building used for mechanical floor area
- (j) any space in a parking garage at or below grade used exclusively for motor vehicle or bicycle parking or access thereto; and
- (k) the floor area of unenclosed residential balconies

For greater clarify, but not so as to restrict generality:

The calculation of GROSS FLOOR AREA may exclude:

- 1. architectural features affixed to or extending beyond the exterior faces of the exterior walls.
- 2. floor slab openings and other voids, including pipe space enclosures throughout, including within residential units;
- 3. mechanical areas within residential units, including HVAC spaces;
- 4. storm water storage tanks;
- 5. parking ramps and aisles to or within a parking garage;
- 6. bicycle rooms contained within a parking garage;
- 7. accessory uses to parking areas within a parking garage including:
- 7.1. airlock rooms adjacent to elevators or exits;
- 7.2. exit stairs that lead directly from a parking garage to the exterior of the building without serving any other areas;
- 7.3. curbs adjacent to the parking areas;
- 7.4. supporting columns, walls or other like structures in a parking garage;
- 7.5. pedestrian walkways within a parking garage;
- 7.6. motor vehicle loading spaces;
- 7.7. access thereto, and adjacent bin staging areas;
- dead areas adjacent to parking spaces between columns, in corners and around curves or provided to facilitate vehicular turnaround;
- 7.9. other spaces in a parking garage not accessible and/or useable due to structural design; and

The calculation of GROSS FLOOR AREA shall include:

- 1. general storage spaces of any kind, including lockers and rooms;
- 2. bicycle rooms not contained within a parking garage;
- 3. vestibules other than airlock rooms;
- 4. garbage and recycling rooms;
- 5. stairs, landings and hallways other than those that lead directly from a parking garage to the exterior of a building without serving any other areas;
- 6. amenity spaces;
- elevator lobbies;
- 8. the floor areas of elevator cabs

MECHANICAL FLOOR AREA

For the purpose of this exception, MECHANICAL FLOOR AREA shall mean the floor area within a building or structure used exclusively for the accommodation of mechanical equipment necessary to physically operate the building, including but not limited to:

- 1. heating
- ventilation 3. air conditioning
- electrical
- plumbing
- 6. fire protection
- telephone telecommunications
- cable and elevator equipment
- 10. garbage chutes and compactors
- 11. storm water management and irrigation facilities

DEFINITIONS NORTH YORK BY-LAW 7625

- ** **HEIGHT** SHALL MEAN THE VERTICAL DISTANCE BETWEEN THE ESTABLISHED GRADE, AND IN THE CASE OF A FLAT ROOF, THE HIGHEST POINT OF THE ROOF SURFACE. MECHANICAL PENTHOUSE HEIGHT NOT INCLUDED.
- *** ESTABLISHED GRADE SHALL MEAN THE ELEVATION AS FIXED BY THE MUNICIPALITY OF THE CENTER LINE OF THE STREET AT THE MID-POINT OF THE FRONT LOT LINE. ESTABLISHED GRADE FOR 35-39 HOLMES AVENUE IS: 192.30
- **** COVERAGE MEANS THE PERCENTAGE OF THE LOT AREA COVERED BY ALL BUILDINGS ABOVE GROUND LEVEL, INCLUDING ACCESSORY BUILDINGS AND STRUCTURES, BUT EXCLUDES:
 - A) PERMITTED ENCROACHMENTS INTO THE MINIMUM YARD SETBACKS; AND B) THAT PORTION OF THE LOT, WHICH IS OCCUPIED BY A BUILDING OR PORTION, WHICH IS COMPLETELY BELOW GROUND LEVEL.

Statistics Template - Toronto Green Standard Version 3.0 Mid to High Rise Residential and all **New Non-Residential Development**

The Toronto Green Standard Version 3.0 Statistics Template is submitted with Site Plan Control Applications and stand alone Zoning Bylaw Amendment applications. Complete the table and copy it directly onto the Site Plan submitted as part of the application.

For Zoning Bylaw Amendment applications: complete General Project Description and Section 1. For Site Plan Control applications: complete General Project Description, Section 1 and Section 2. For further information, please visit www.toronto.ca/greendevelopment

General Project Description	Proposed
Total Gross Floor Area	10,717.30
Breakdown of project components (m²)	
Residential	
Retail	
Commercial	
Industrial	
Institutional/Other	
Total number of residential units	154

Section 1: For Stand Alone Zoning Bylaw Amendment Applications and

Site Plan Control Applications

Automobile Infrastructure	Required	Proposed	Proposed %
Number of Parking Spaces	154	96	62.33%
Number of parking spaces dedicated for priority LEV parking	N/A	N/A	N/A
Number of parking spaces with EVSE	18	18	100%
Cycling Infrastructure	Required	Proposed	Proposed %
Number of long-term bicycle parking spaces (residential)	105	105	100%

Cycling infrastructure		Required	Proposed	Proposed %
Number of long-term bicycle parking spaces (resid	ential)	105	105	100%
Number of long-term bicycle parking spaces (all of	ther uses)	N/A	N/A	N/A
Number of long-term bicycle parking (all uses) loc	ated on:			
a) first storey of building		N/A	53	50.48%
b) second storey of building		N/A	32	30.48%
c) first level below-ground		N/A	20	19.04%
d) second level below-ground		N/A	0	0%
e) other levels below-ground		N/A	0	0%









Page 1 of 3

11-0063 2018-05

Statistics Template - Toronto Green Standard Version 3.0 Mid to High Rise Residential and all **New Non-Residential Development**

Cycling Infrastructure	Required	Proposed	Proposed %
Number of short-term bicycle parking spaces (residential)	11	11	100%
Number of short-term bicycle parking spaces (all other uses)	N/A	N/A	N/A
Number of male shower and change facilities (non-residential)	N/A	N/A	N/A
Number of female shower and change facilities (non-residential)	N/A	N/A	N/A

Tree Planting & Soil Volume	Required	Proposed	Proposed %
Total Soil Volume (40% of the site area \div 66 m ² x 30 m ³).	432 cu.m.	468.4 cu.m	108.4


TGS STATISTICS TEMPLATE


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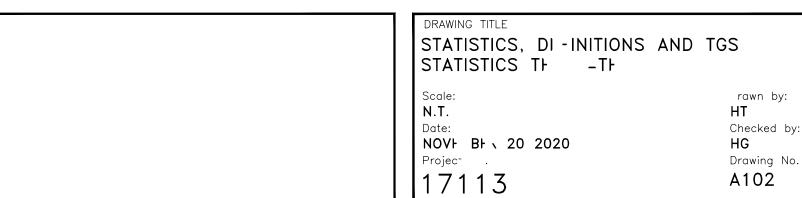
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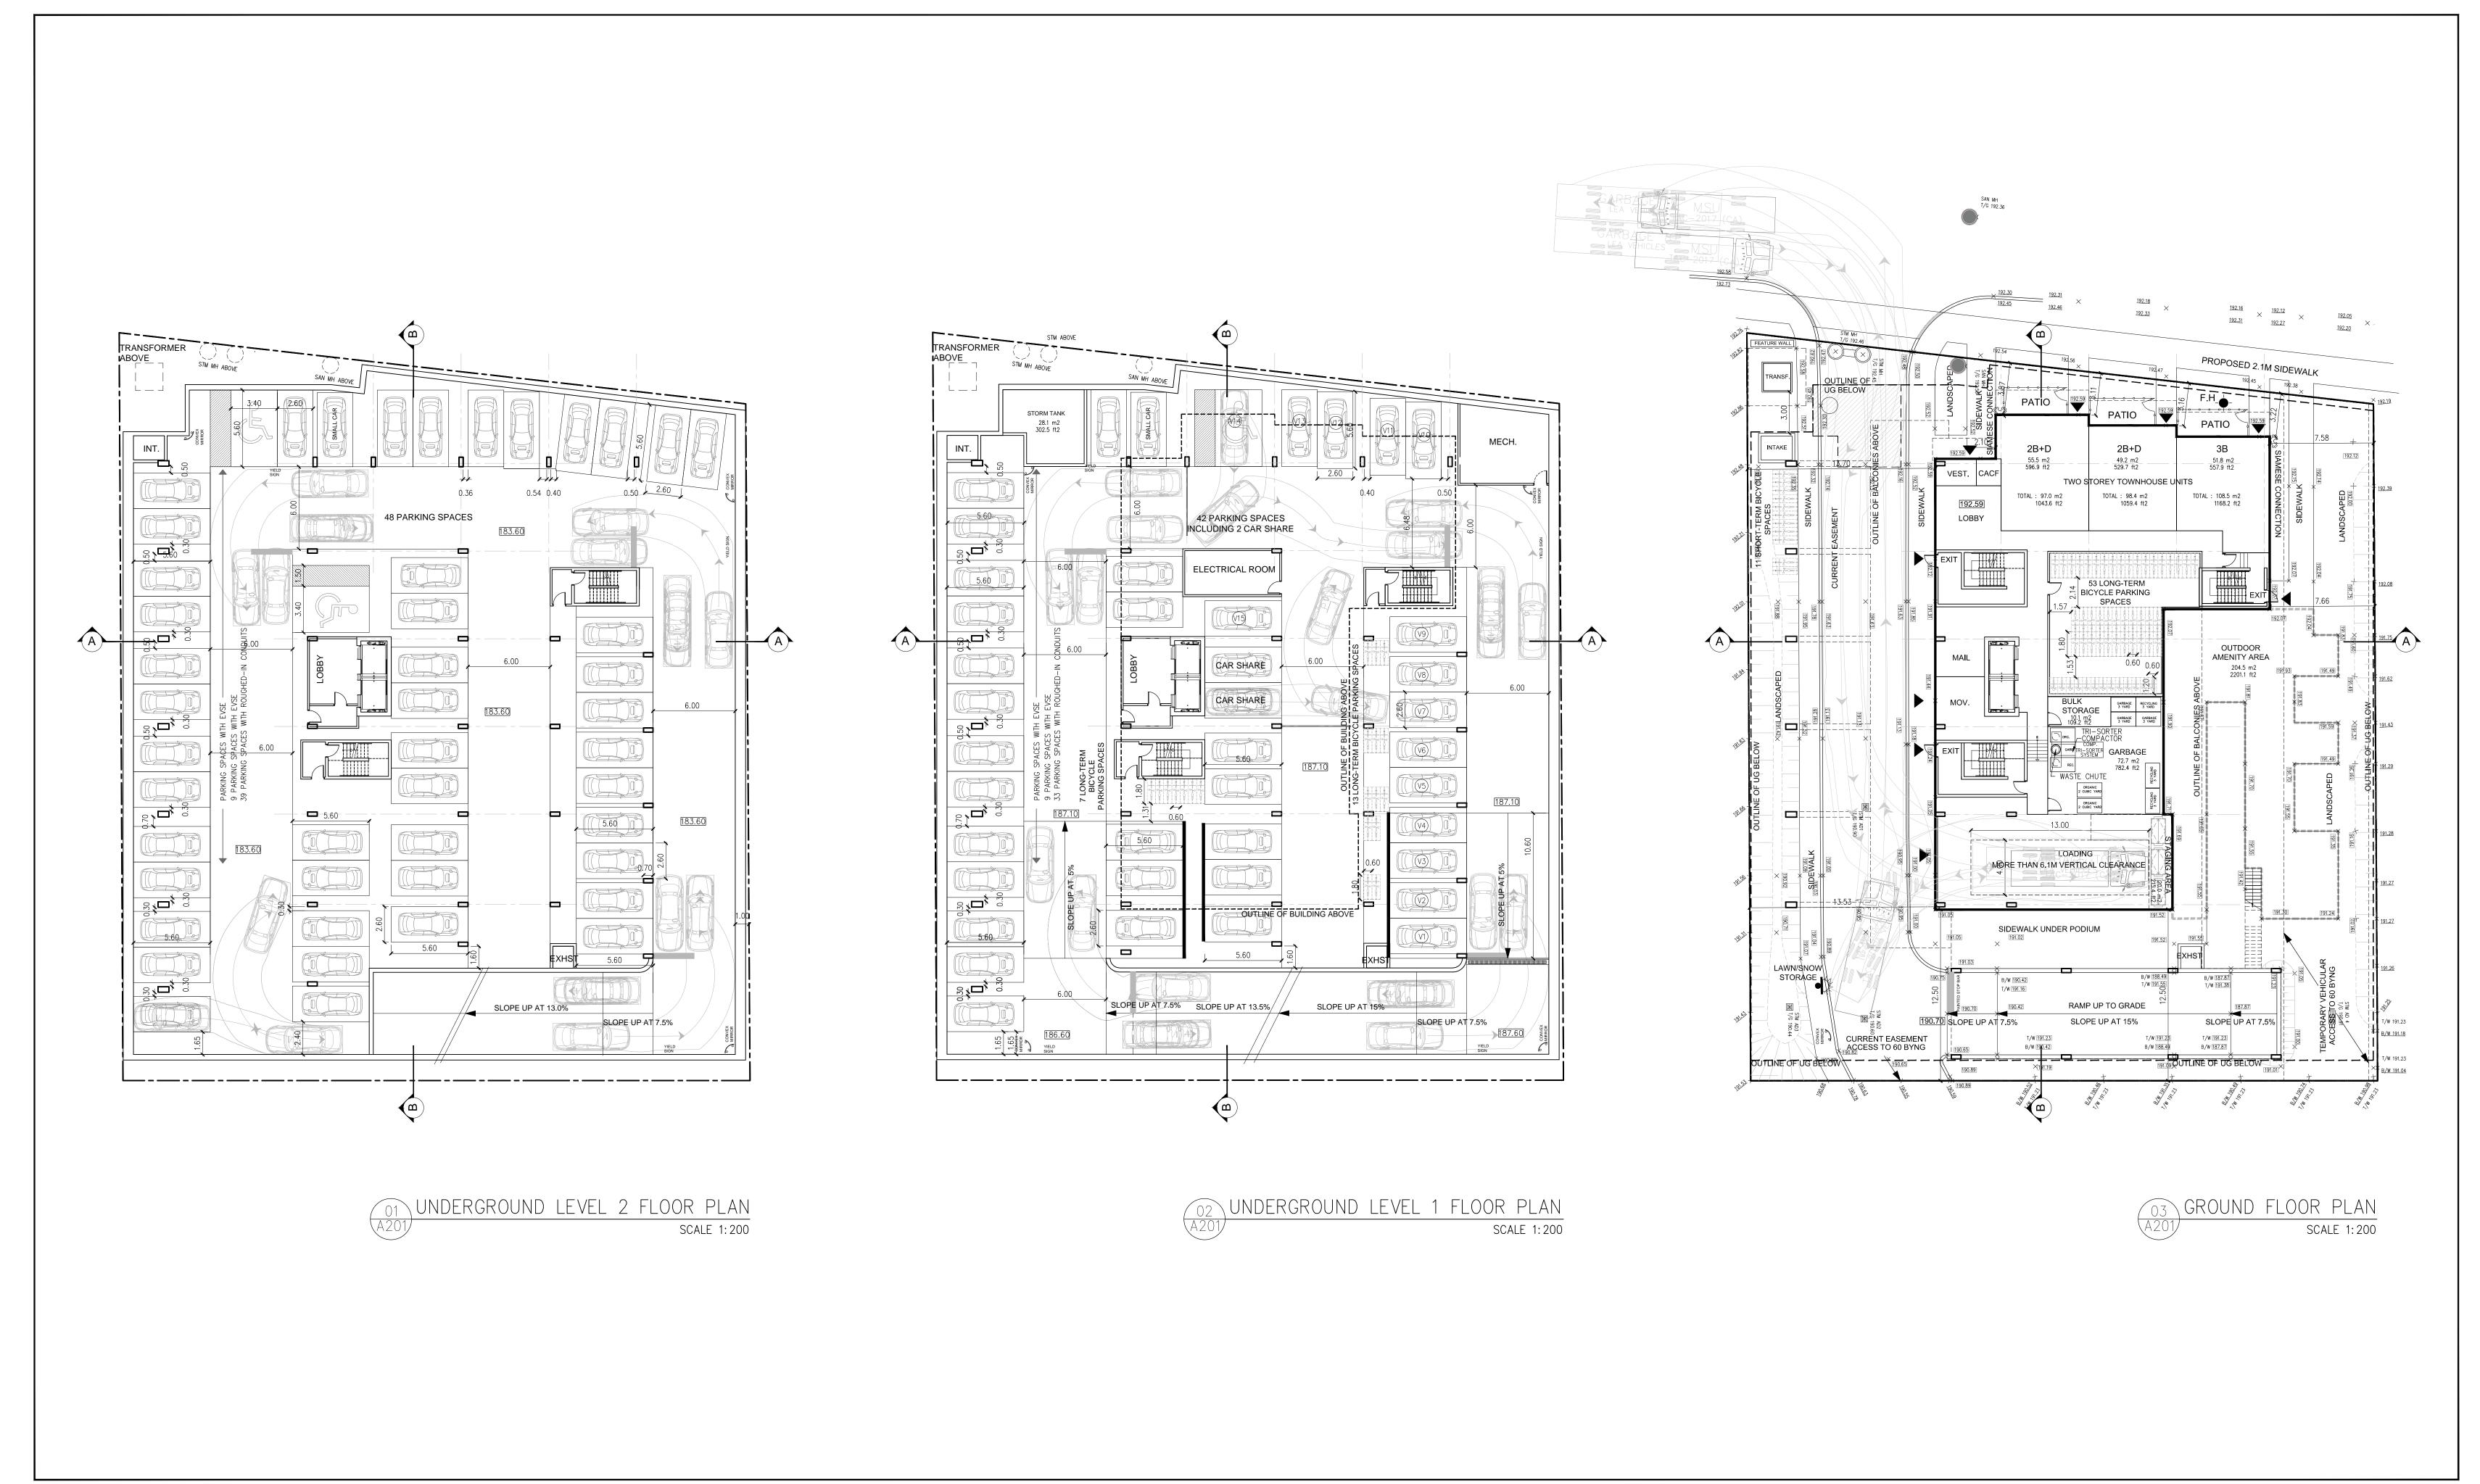




35-39 HOLMES AVENUE TORONTO, ONTARIO




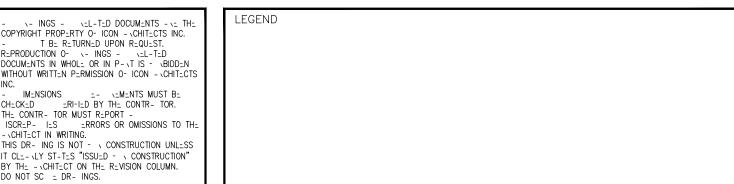


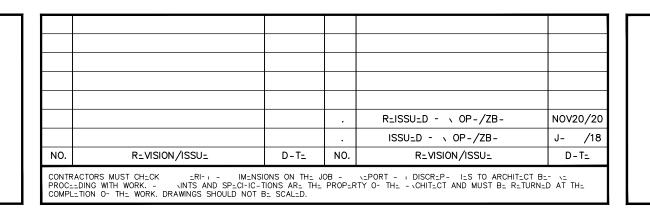

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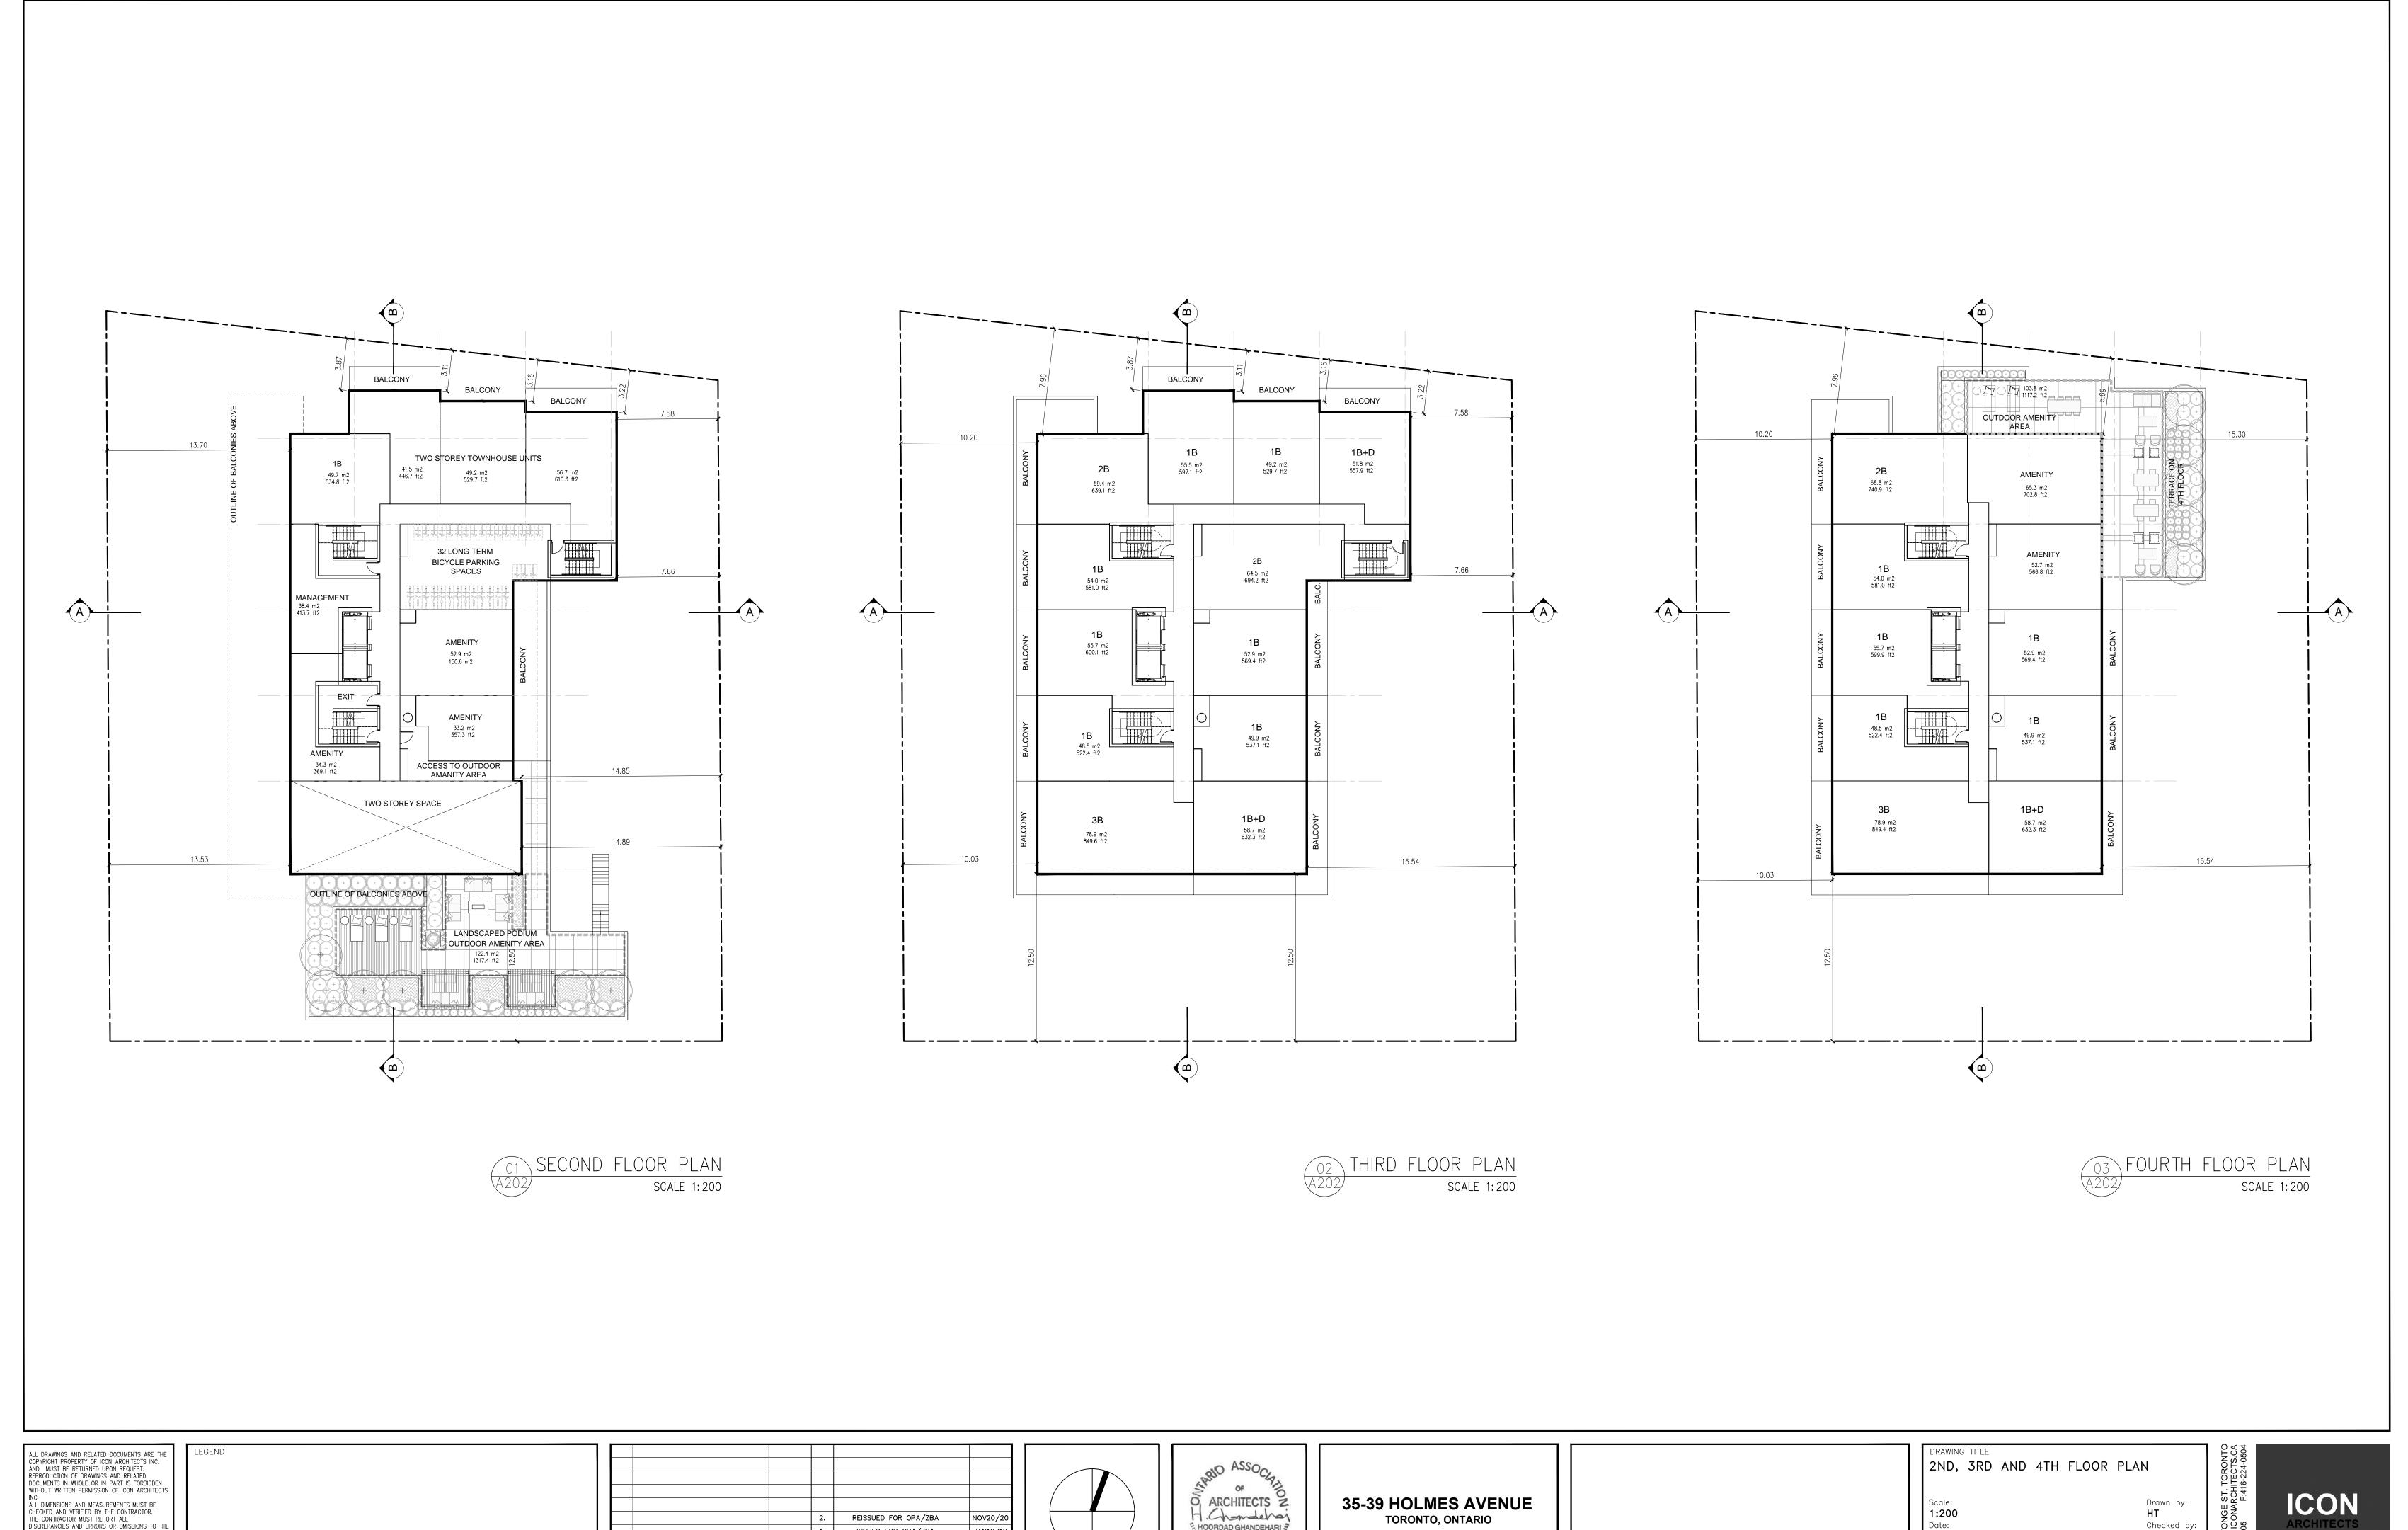
35-39 HOLMES AVENUE TORONTO, ONTARIO

UG LEVEL 2 AND 1 AND GROUND FLOOR PLANS

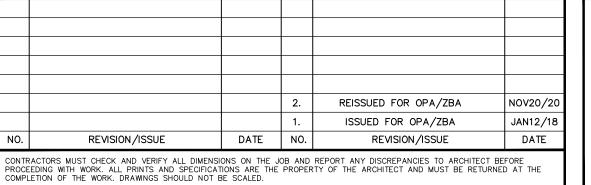Scale: Drawn by: HT Checked by: NOVEMBER 20 2020 HG Project No. Drawing No. A201

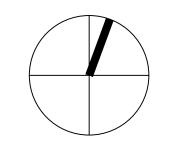
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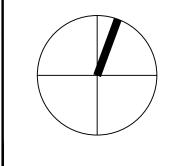
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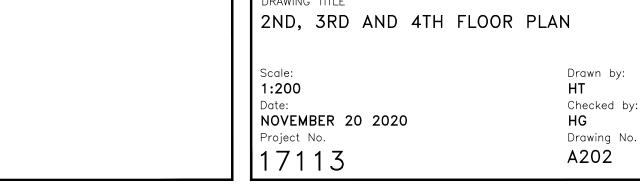
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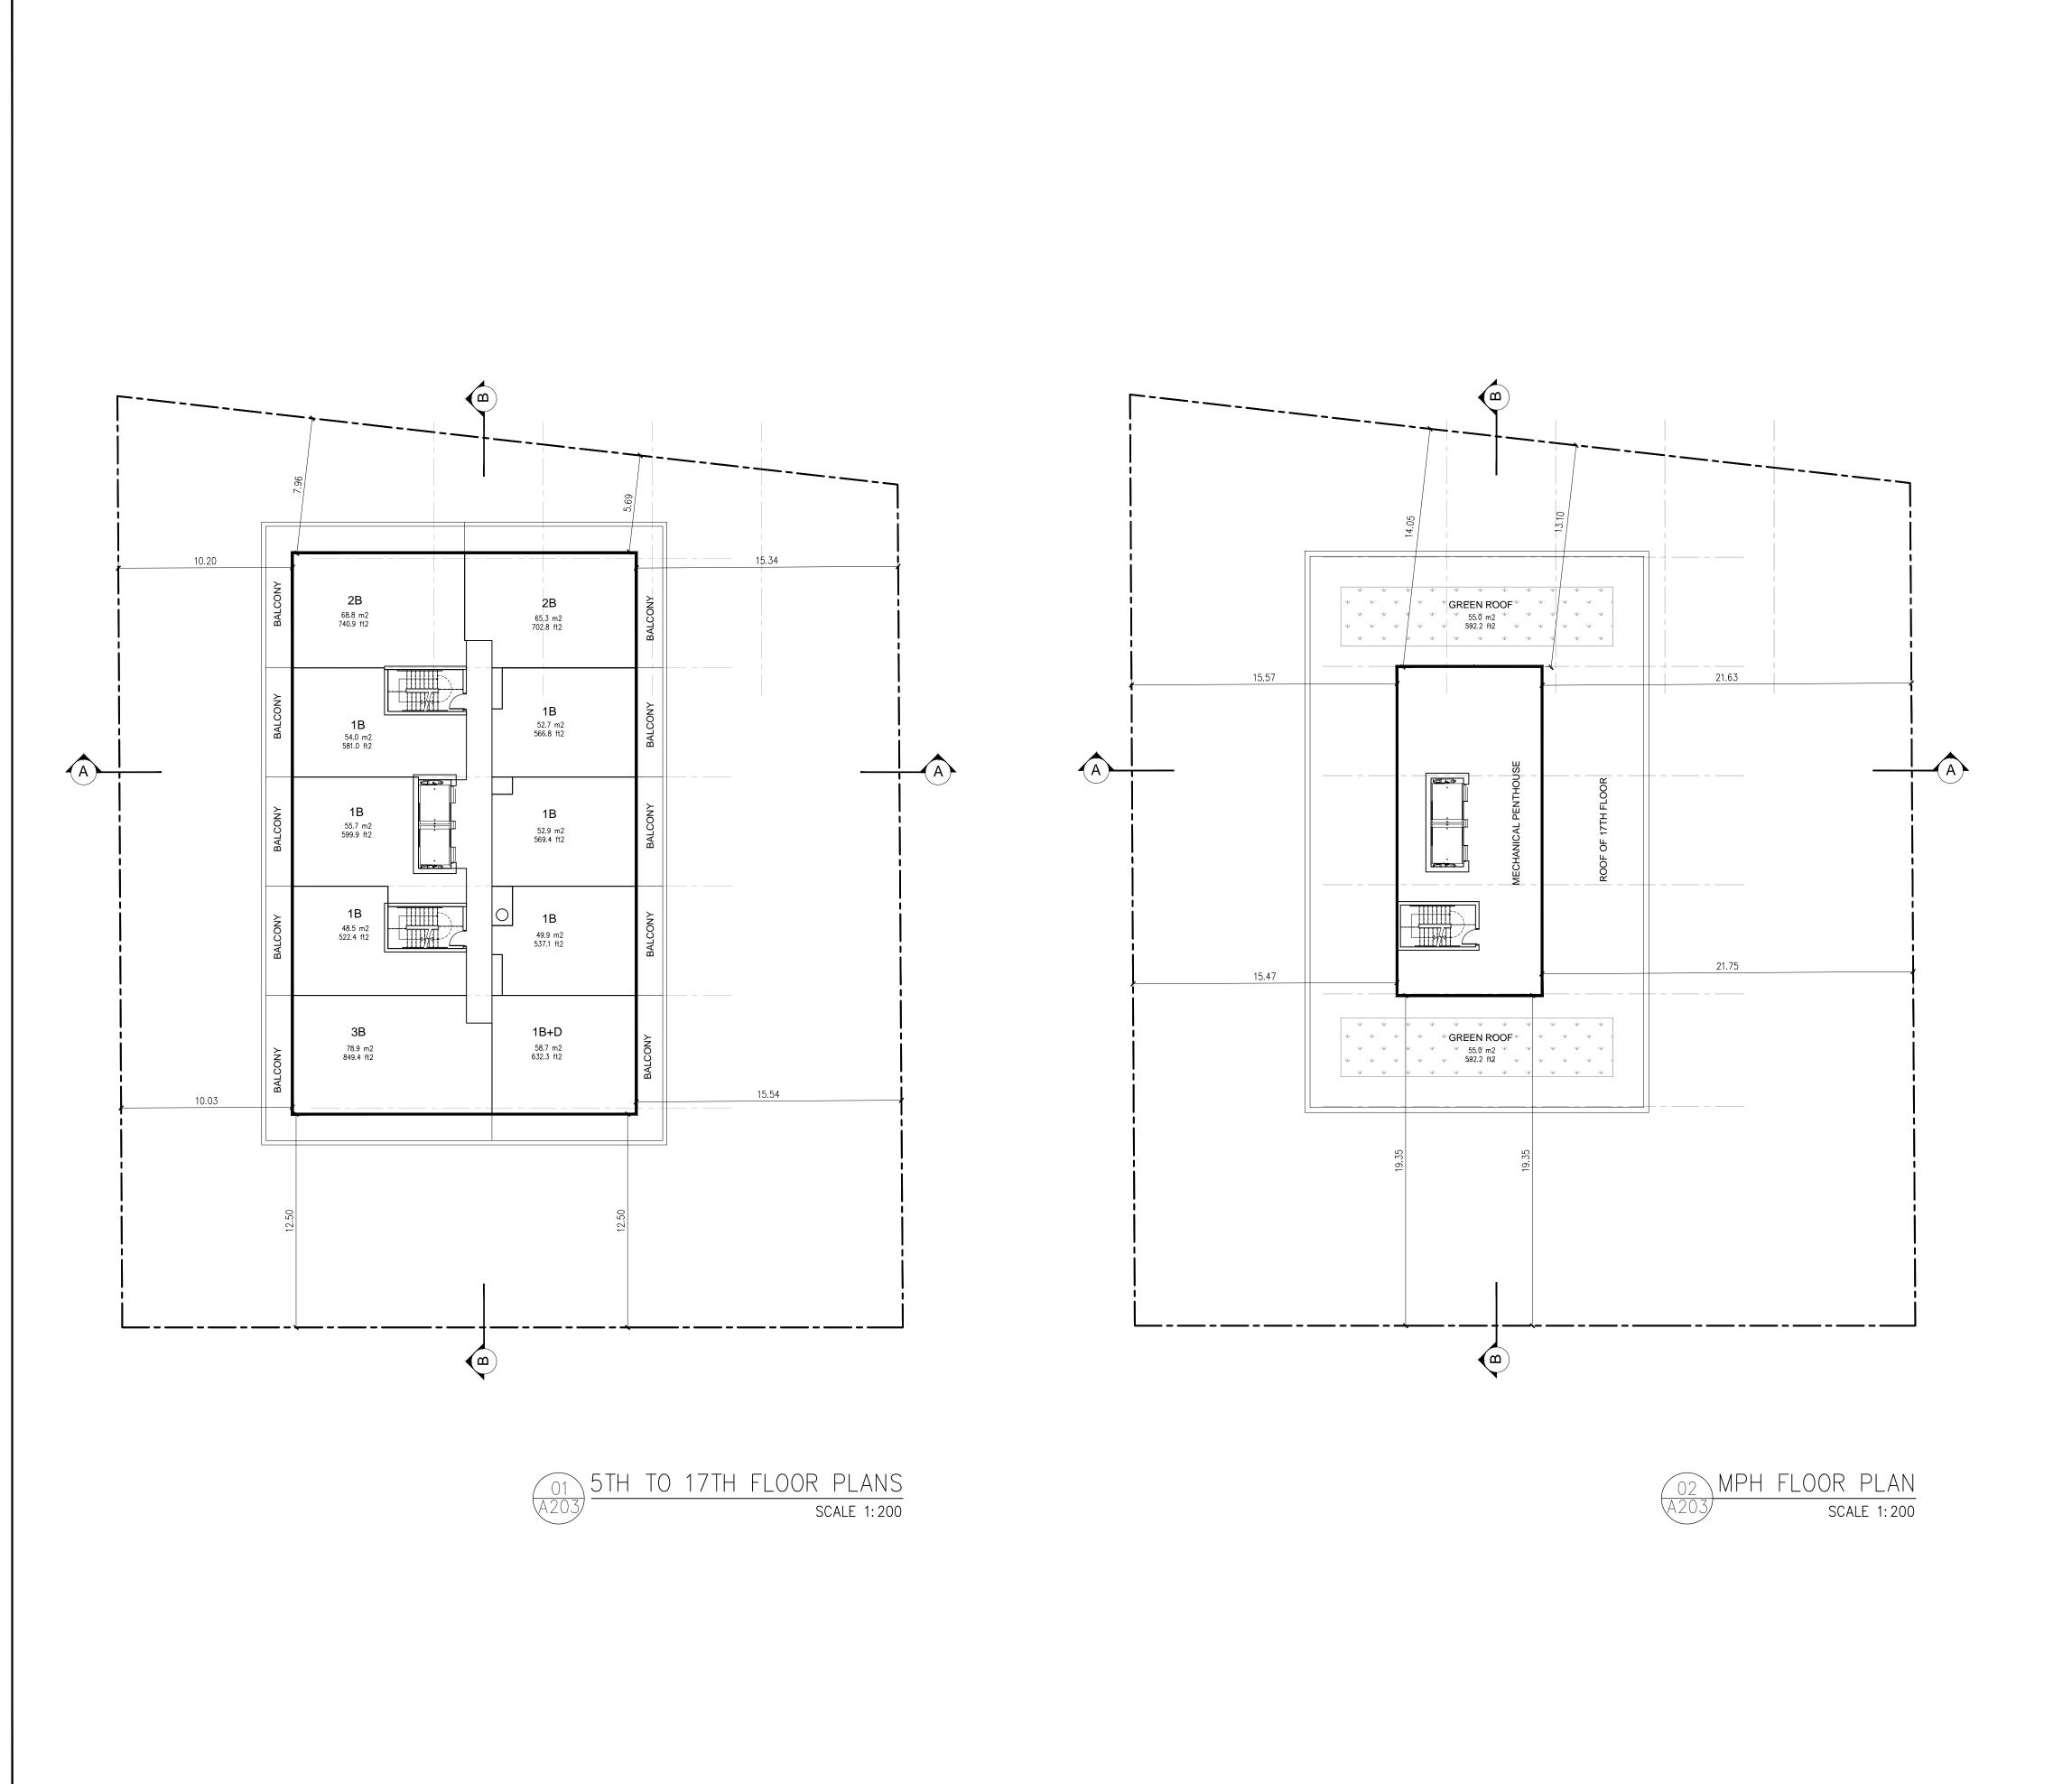












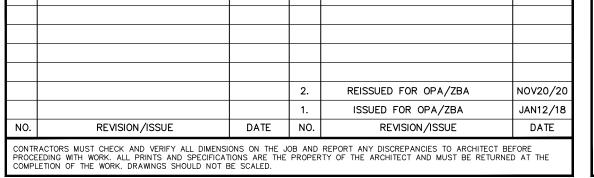

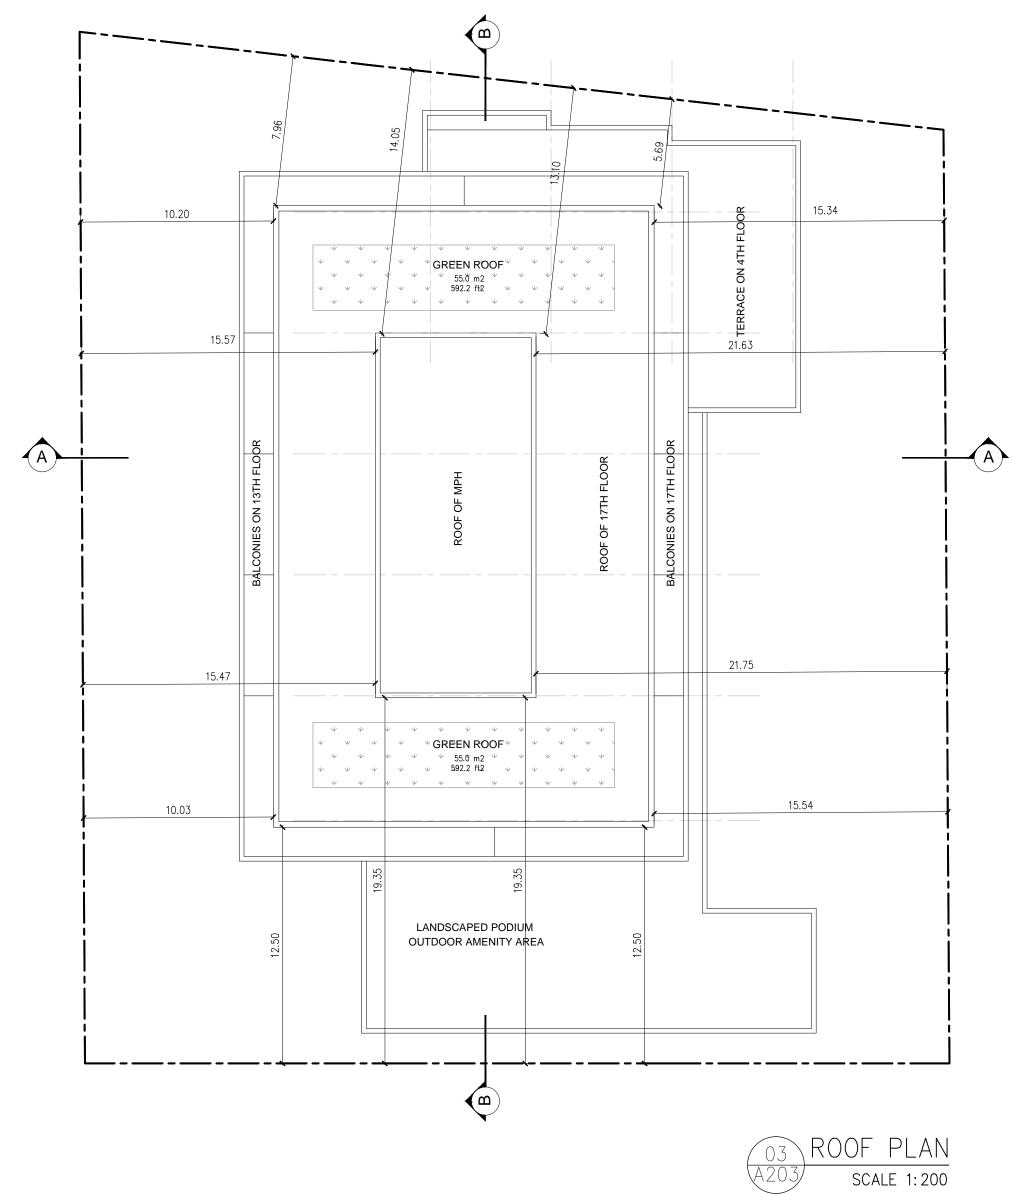



		Proposed
Gross Floor Area, as defined in Green Roof Bylaw (m²)		11,846.6
Total Roof Area (m²)		832.5
Area of Residential Private Terraces (m²)		0
Rooftop Outdoor Amenity Space, if in a Residential Building (m²)		0
Area of Renewable Energy Devices (m ²)		0
Tower (s)Roof Area with floor plate less than 750 m ²		469.1
Total Available Roof Space (m²)		363.4
Green Roof Coverage	Required	Proposed
Coverage of Available Roof Space (m²)	30%	30%
Coverage of Available Roof Space (%)	109.02	110

04 GREEN ROOF STATISTICS
SCALE N.T.S.

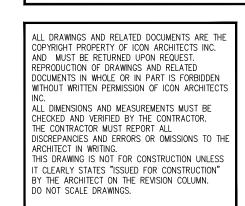




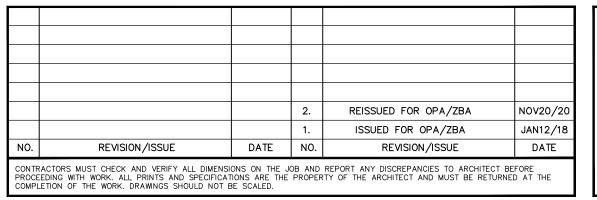

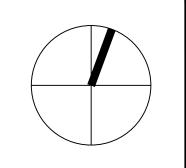



35-39 HOLMES AVENUE TORONTO, ONTARIO

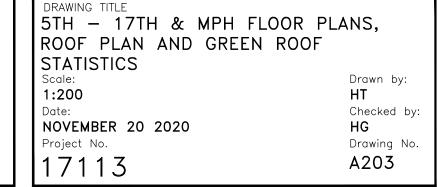

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35-39 HOLMES AVENUE TORONTO, ONTARIO

NORTH AND EAST ELEVATIONS 1:200 Date:
NOVEMBER 20 2020
Project No. 17113

Drawn by: **HT** Checked by: Drawing No. A301

HG


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PLOT DATE November 20, 2020

01 NORTH ELEVATION SCALE 1:200









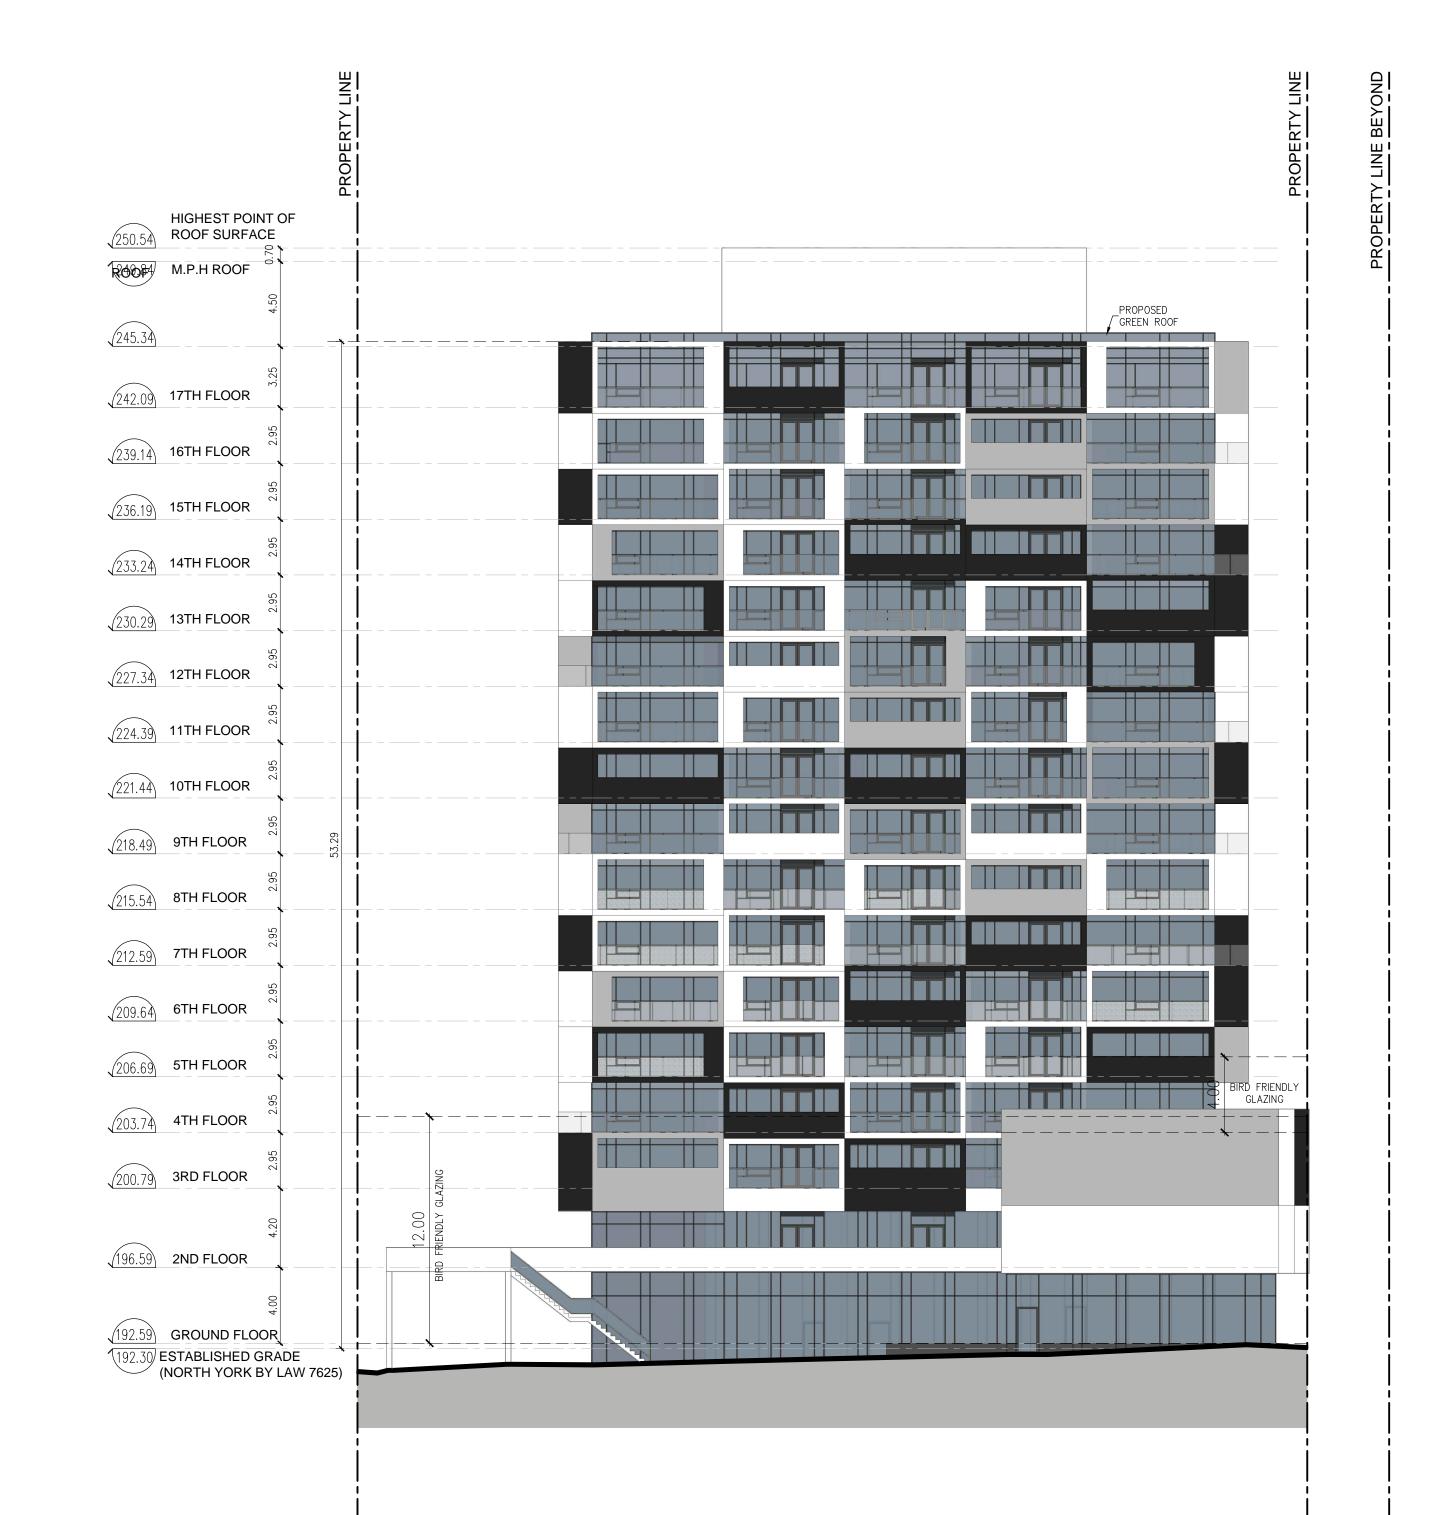

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ARCHITECTS Z H.Chandelogi HOORDAD GHANDEHARI **35-39 HOLMES AVENUE** LICENCE 6313

TORONTO, ONTARIO

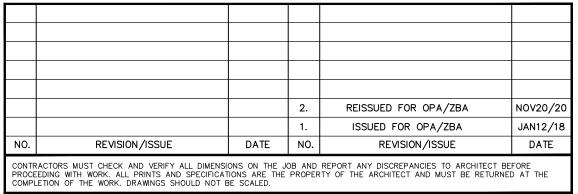

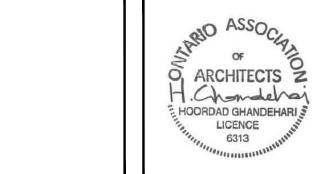SOUTH AND WEST ELEVATIONS Drawn by: **HT** Checked by: NOVEMBER 20 2020
Project No. HG Drawing No. 17113 A302

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