

PUBLIC ATTACHMENT 2

22 BALLIOL STREET

APPLICATION FOR ZONING BY-LAW AMENDMENT

PROJECT TEAM

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ARCHITECTURAL SHEET LIST

Drawing Number	Drawing Name	Current Revision	Revision Date
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22 BALLIOL STREET

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SCALE 1:150 PROJECT NO. 201301 ISSUE DATE JULY 6, 2021

COVER SHEET

1.0 SUMMARY

SITE AREA - 1,892 m² TOTAL GFA - 28,305 m² FSI - 15.0 NEW RESIDENTIAL UNITS - 399

2.0 BUILDING HEIGHTS

Tower: 120 m Mechanical Penthouse: 6 m **TOTAL:** 126 m

3.0 FLOOR AREA

*GFA calculated per Area Plans, A1001 - A1004

				3.1 FL00	OR AREA				
Level	# of Levels	GCA/Level (m²)	Total GCA (m²)	GFA Deductions (m²)	Outdoor Amenity (m²)	Indoor Amenity (m²)	Residential GFA (m²)	Retail GFA (m²)	Total GFA (m²
BELOW-GRADE									
P3	1	1,789	1,789	1,752	0	0	37	0	37
P2	1	1,771	1,771	1,733	0	0	37	0	37
P1	1	1,770	1,770	1,681	0	0	39	50	89
	1	5,330	5,330	5,166	0	0	114	50	164
Level 1 Mezz. Level 2	1 1	409 1,393	409 1,393 1,366	164 237 237	0 0	0 69 69	82 1,155 1,120	164 0	246 1,155 1 129
						-			
Level 3	1	1,366	1,366	237	0		1,129	0	1,129
Level 4	1	1,382	1,382	612	165	479	770	0	770
Level 5	1	766	766	129	571	75	636	0	636
Level 6-32	27	750	20,258	1,477	0	0	18,781	0	18,781
Level 33-37	5	750	3,752	274	0	0	3,478	0	3,478
Level 38	1	634	634	203	127	148	431	0	431
MECH. P.H.	1	456	456	456	0	0	0	0	0
		9,584	32,093	3,952	863	840	27,236	904	28,141

		3.2 RESI	DENTIAL UN	NITS		
Level	Studio	1B	1B+D	2B	3B	Total Units
BELOW-GRADE						
P3	0	0	0	0	0	0
P2	0	0	0	0	0	0
P1	0	0	0	0	0	0
	0	0	0	0	0	0
ABOVE-GRADE						
Level 1	0	0	0	0	0	0
Level 1 Mezz.	0	0	0	0	0	0
Level 2	2	2	1	7	2	14
Level 3	2	2	1	6	3	14
Level 4	0	2	1	3	2	8
Level 5	1	5	1	2	1	10
Level 6-32	27	162	0	81	27	297
Level 33-37	0	20	5	20	5	50
Level 38	0	3	0	3	0	6
MECH. P.H.	0	0	0	0	0	0
	32	196	9	122	40	399
Unit Type	'STUDIO	1B	1B+D	2B	3B	TOTAL
No. Units	32	196	9	122	40	399
Unit Mix	8%	49%	2%	31%	10%	100%

4.1 AMENITY					
Total Units		Am	nenity		
TOTAL OTHER	Outdoor	Outdoor / Unit	Indoor	Indoor / Unit	
399	863 m ²	2.16 m ²	840 m ²	2.11 m ²	

5.0 PARKING

				5.1	I CAR PAR	KING					
	Reside	ntial Car P	arking	Visit	tor Car Par	king	Re	tail Car Pa	rking	Car Share	Total Car
Level	Regular	BF	Total	Regular	BF	Total	Regular	BF	Total	Parking	Parking
			•			1	-		'		
P1	0	0	0	12	1	13	9	1	10	0	23
	0 28	0 2	0 30	12 10	1 0	13 10	9	0	10	0 1	23 41
P1 P2 P3	0 28 43	0 2 2	0 30 45		1 0 0		-	0 0	0	0 1 0	

Car Parking Rates

- Short-Term Use) 1 Retail Parking Space per 100 m² Retail GFA

oui i t	ining riacos
•	0.19 Residential Parking Spaces per Unit
•	0.06 Residential Visitor Parking Spaces per Unit (3 Spaces Designated for Sh

5.2 BICYCLE PARKING						
	Bicycle	Bicycle Parking Total B				
Level	Long-Term	Short-Term	Parking			
	24	26	50			
	0	28	28			
d	148	0	148			
	148	0	148			
	114	0	114			
ΓAL	434	54	488			

- 1.08 Long-Term Parking Spaces per Unit
 0.12 Short-term Parking spaces per Unit
 2 Long-Term Parking Spaces Designated for Retail
 6 Short-Term Parking Spaces Designated for Retail

6.0 STORAGE

6.1 LOCKERS	
STORAGE LOCKER	23

7.0 LOADING

7.1 LOADING					
Level	Count	Туре			
Level 1	1	TYPE G LOADING			
Level 1	1	TYPE B LOADING			

8.0 WASTE

8.1 WASTE STORAGE AREA			
_evel	Area Type	Area	
P1	BULKY STORAGE	10 m ²	
71	REFUSE	115 m ²	
		125 m²	

Toronto Green Standard Version 3.0

General Project Description	
SITE AREA	1,892 m ²
TOTAL GROSS FLOOR AREA	28,305 m ²
RESIDENTIAL	27,350 m ²
RETAIL	955 m ²
OTHER	0 m ²
TOTAL NUMBER OF RESIDENTIAL UNITS	399

Section 1: For Stand Alone Zoning Bylaw Amendment Applications and Site Plan Control Applications

Automobile Infrastructure	Required	Proposed	Percentage
NUMBER OF PARKING SPACES	471	109	23.1 %
NUMBER OF PARKING SPACES DEDICATED FOR PRIORITY CARPOOLING/ RIDESHARING PARKING	0	1	
NUMBER OF PARKING SPACES WITH EVSE	23	28	25.7 %
Cycle Infrastructure	Required	Proposed	Percentage
NUMBER OF LONG-TERM BICYCLE PARKING SPACES (RESIDENTIAL)	360	432	120.0 %
NUMBER OF LONG-TERM BICYCLE PARKING SPACES (ALL OTHER USES)	2	2	100.0 %
NUMBER OF LONG-TERM BICYCLE PARKING (RESIDENTIAL AND ALL OTHER USES) LOCATED ON:			
A) FIRST STOREY OF BUILDING		0	
B) SECOND STOREY OF BUILDING		148	
C) FIRST LEVEL BELOW-GROUND		24	
D) SECOND LEVEL BELOW-GROUND (ALSO INDICATE % OF NET AREA OF LEVEL OCCUPIED BY BICYCLE PARKING)		0	
E) OTHER LEVELS BELOW-GROUND (ALSO INDICATE % OF NET AREA OF LEVEL OCCUPIED BY BICYCLE PARKING)		0	
NUMBER OF SHORT-TERM BICYCLE PARKING SPACES (RESIDENTIAL)	40	48	120.0 %
NUMBER OF SHORT-TERM BICYCLE PARKING SPACES (ALL OTHER USES)	6	6	100.0 %
NUMBER OF MALE SHOWER AND CHANGE FACILITIES (NON-RESIDENTIAL)	N/A	N/A	
NUMBER OF FEMALE SHOWER AND CHANGE FACILITIES (NON-RESIDENTIAL)	N/A	N/A	
Tree Planting & Soil Volume	Required	Proposed	Percentage
TOTAL SOIL VOLUME (40% OF THE SITE AREA / 66m2 X 30m3)	344 m ³	5 m ³	1.5 %

Section 2: For Site Plan Control Applications

Cycle Infrastructure	Required	Proposed	Percentage
NUMBER OF SHORT-TERM BICYCLE PARKING SPACES (ALL USES) AT GRADE OR ON FIRST LEVEL BELOW GRADE	46	54	117.4 %
Urban Heat Island and Non-Roof Hardscape	Required	Proposed	Percentage
TOTAL NON-ROOF HARDSCAPE AREA (M2)		224 m ²	
TOTAL NON-ROOF HARDSCAPE AREA TREATED FOR URBAN HEAT ISLAND (MINIMUM 50%) (M2)	112 m ²	206 m ²	92.0 %
AREA OF NON-ROOF HARDSCAPE TREATED WITH: (INDICATE M2)			
A) HIGH-ALBEDO SURFACE MATERIAL		206 m ²	92.0 %
B) OPEN-GRID PAVEMENT		0 m ²	0 %
C) SHADE FROM TREE CANOPY		0 m ²	0 %
D) SHADE FROM HIGH-ALBEDO STRUCTURES		0 m ²	0 %
E) SHADE FROM ENERGY GENERATION STRUCTURES		0 m ²	0 %
PERCENTAGE OF REQUIRED CAR PARKING SPACES UNDER COVER (MINIMUM 75%) (NON-RESIDENTIAL ONLY)	N/A	N/A	N/A
Green and Cool Roofs	Required	Proposed	Percentage
AVAILABLE ROOF SPACE (M2)	· //////	26 m ²	
AVAILABLE ROOF SPACE PROVIDED AS GREEN ROOF (M2)	16 m ²	336 m ²	1300 %
AVAILABLE ROOF SPACE PROVIDED AS COOL ROOF (M2)		0 m ²	N/A
AVAILABLE ROOF SPACE PROVIDED AS SOLAR PANELS (M2)		0 m ²	N/A
Water Efficiency	Required	Proposed	Percentage
TOTAL LANDSCAPED SITE AREA (M2)	<u>.</u>	3 m ²	
LANDSCAPED SITE AREA PLANTED WITH DROUGHT-TOLERANT PLANTS (MINIMUM 50%) (M2 AND %) (IF APPLICABLE)	1.5 m ²	3 m ²	100.0 %
Tree Planting and Soil Volume	Required	Proposed	Percentage
TOTAL SITE AREA (M2)		1,892 m ²	
TOTAL SOIL VOLUME (40% OF THE SITE AREA / 66 m2 X 30 m3)	344 m ³	5 m ³	1.5 %
TOTAL NUMBER OF PLANTED AREAS (MINIMUM 30 m3 SOIL)		0	
TOTAL NUMBER OF TREES PLANTED		0	
NUMBER OF SURFACE PARKING SPACES (IF APPLICABLE)	N/A	N/A	N/A
NUMBER OF SHADE TREES LOCATED IN SURFACE PARKING AREA INTERIOR (MINIMUM 1 TREE FOR 5 PARKING SPACES)	N/A	N/A	N/A
Native and Pollinator Supportive Species	Required	Proposed	Percentage
TOTAL NUMBER OF PLANTS	·	0	
TOTAL NUMBER OF NATIVE PLANTS AND % OF TOTAL PLANTS (MINIMUM 50%)	0	0	
Bird Friendly Glazing	Required	Proposed	Percentage
TOTAL AREA OF GLAZING OF ALL ELEVATIONS WITHIN 16M ABOVE GRADE (INCLUDING GLASS BALCONY RAILINGS) - EAST BUILDING		2.219.211	
TOTAL AREA OF TREATED GLAZING (MINIMUM 85% OF TOTAL AREA OF GLAZING WITHIN 16M ABOVE GRADE) (M2%) - EAST BUILDING			(//////
PERCENTAGE OF GLAZING WITHIN 16M ABOVE GRADE TREATED WITH:			
A) LOW REFLECTANCE OPAQUE MATERIALS			//////
,			75.8%
R) VISUAL MARKERS	1 / / / / / /	1 0 0 0 0 0 0 0 0 0 0 0 0 0 0 0 0 0 0 0	1 22 22 72
B) VISUAL MARKERS C) SHADING		ASO 0 m2	

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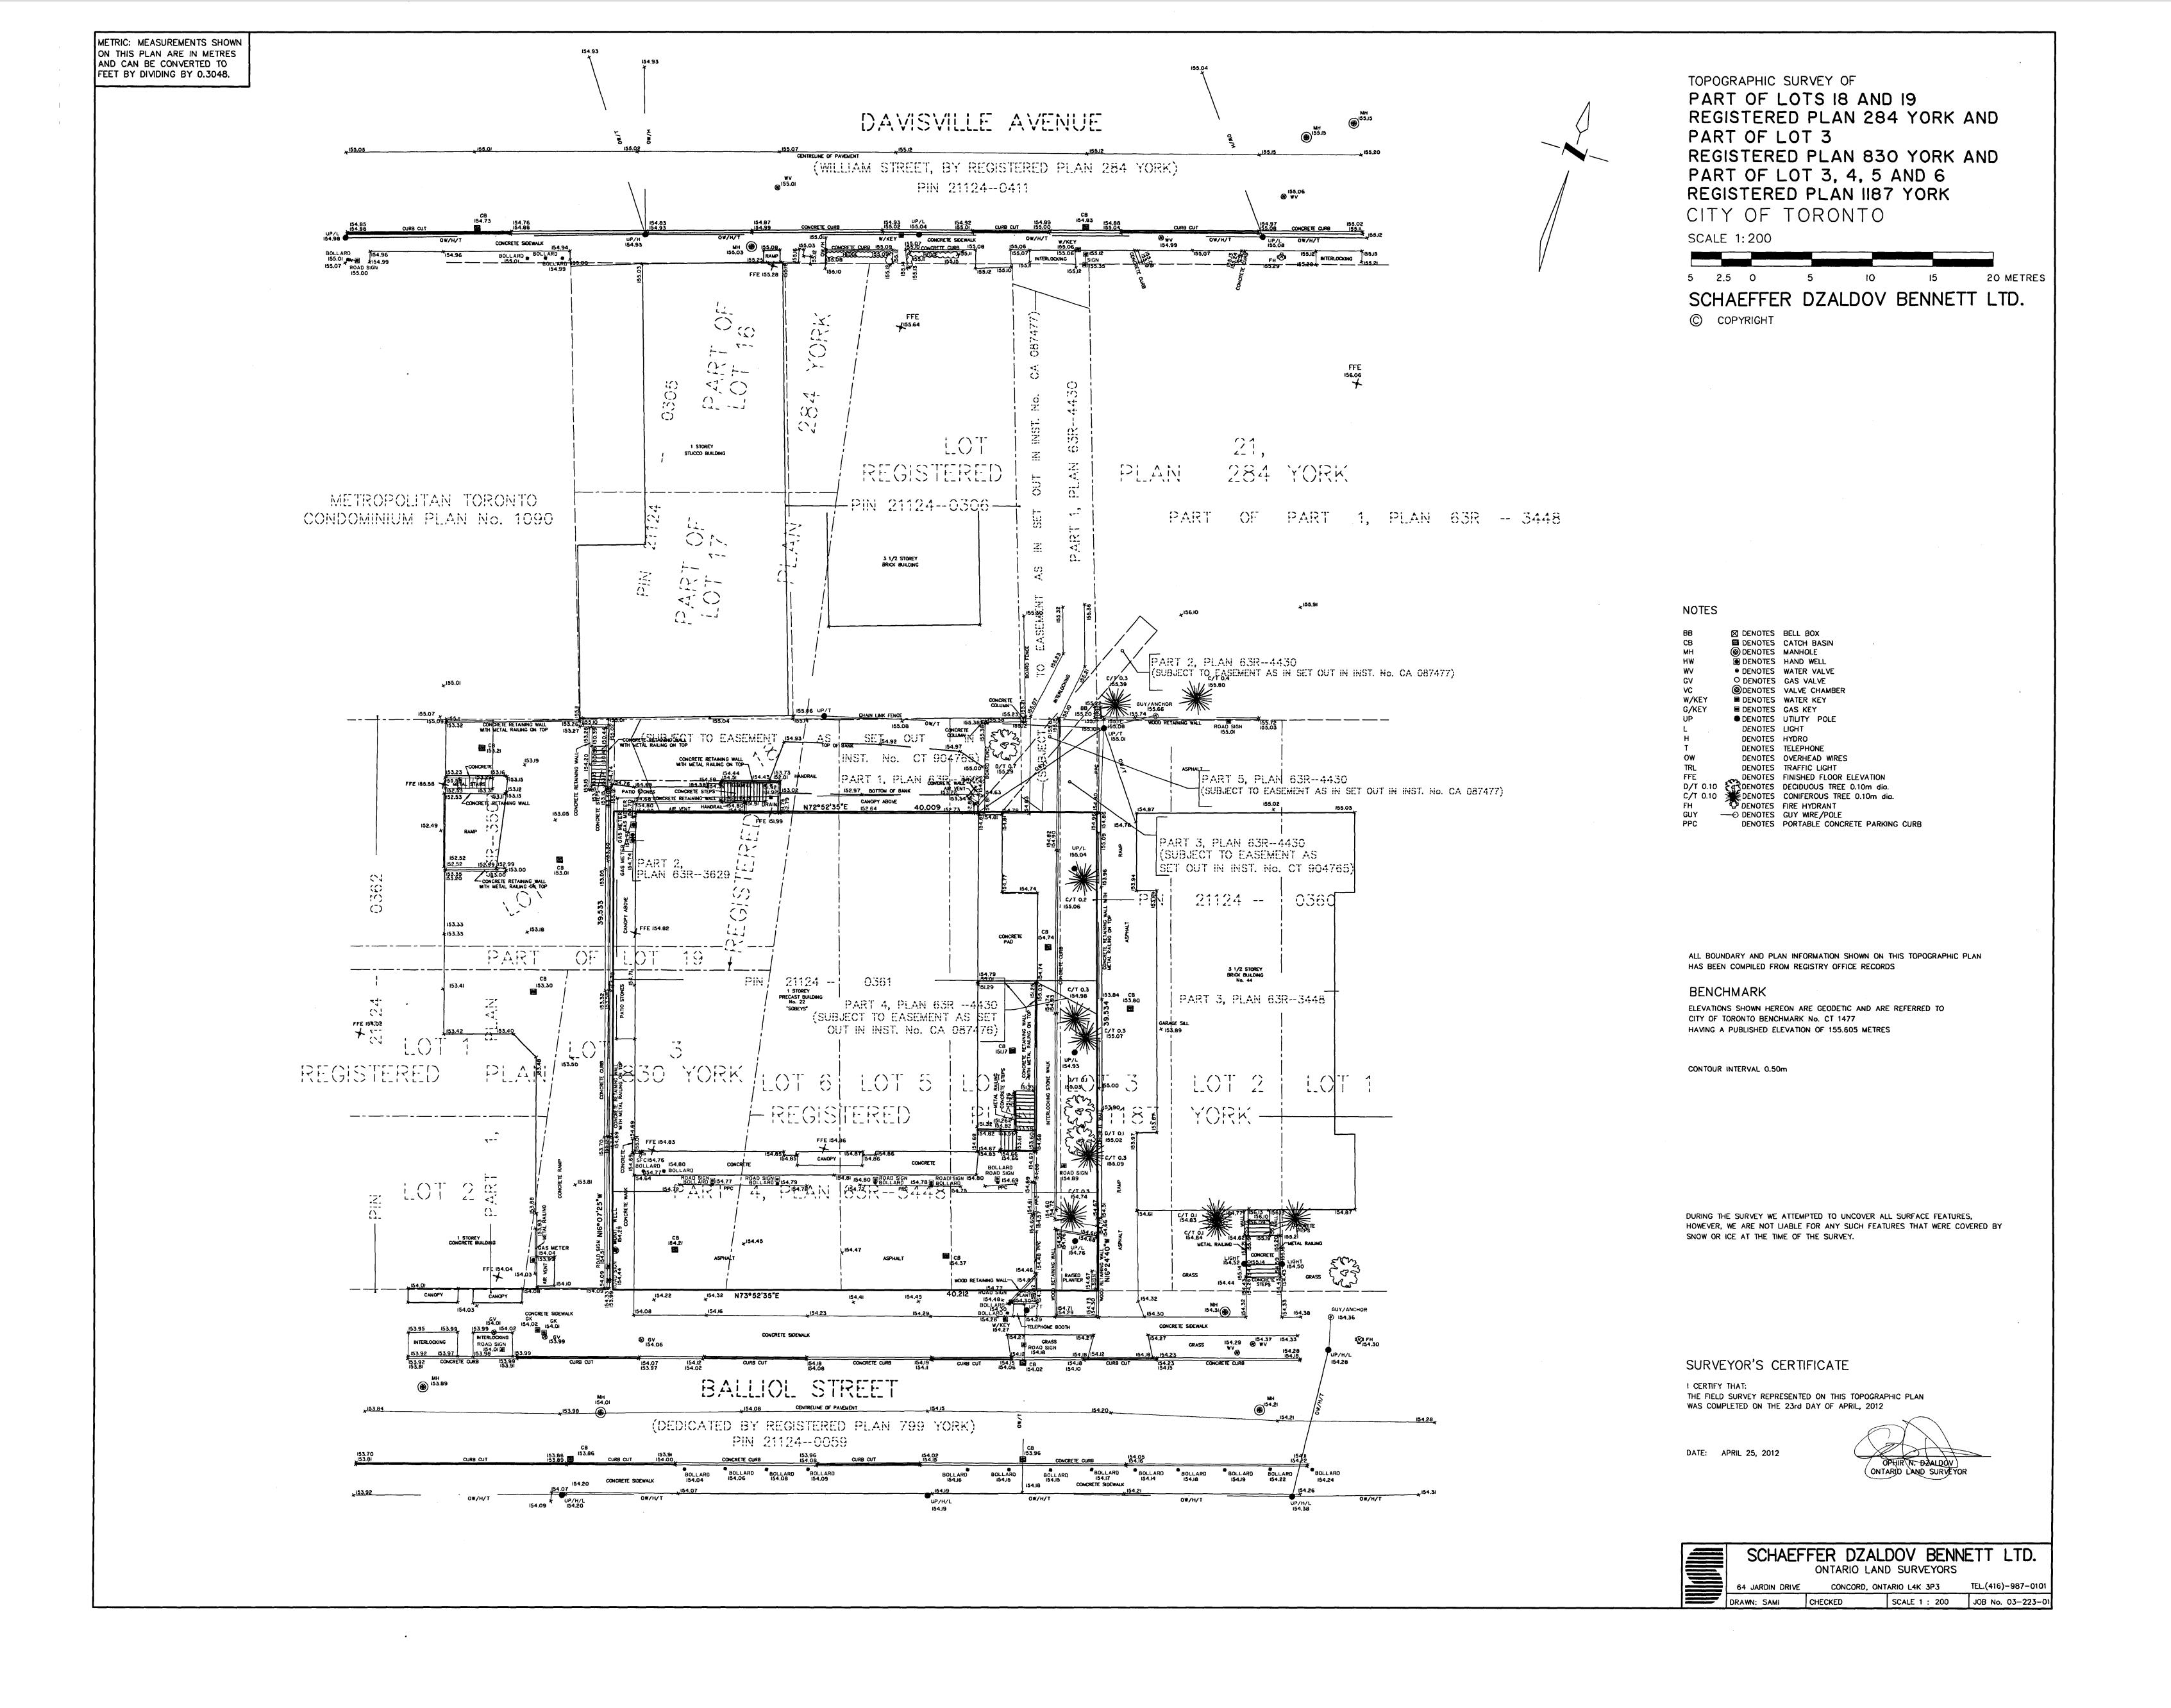
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SHIPLAKE / COLLECDEV 22 BALLIOL STREET

Project North True North

SCALE 1:1 PROJECT NO. 201301 ISSUE DATE JULY 6, 2021

STATISTICS



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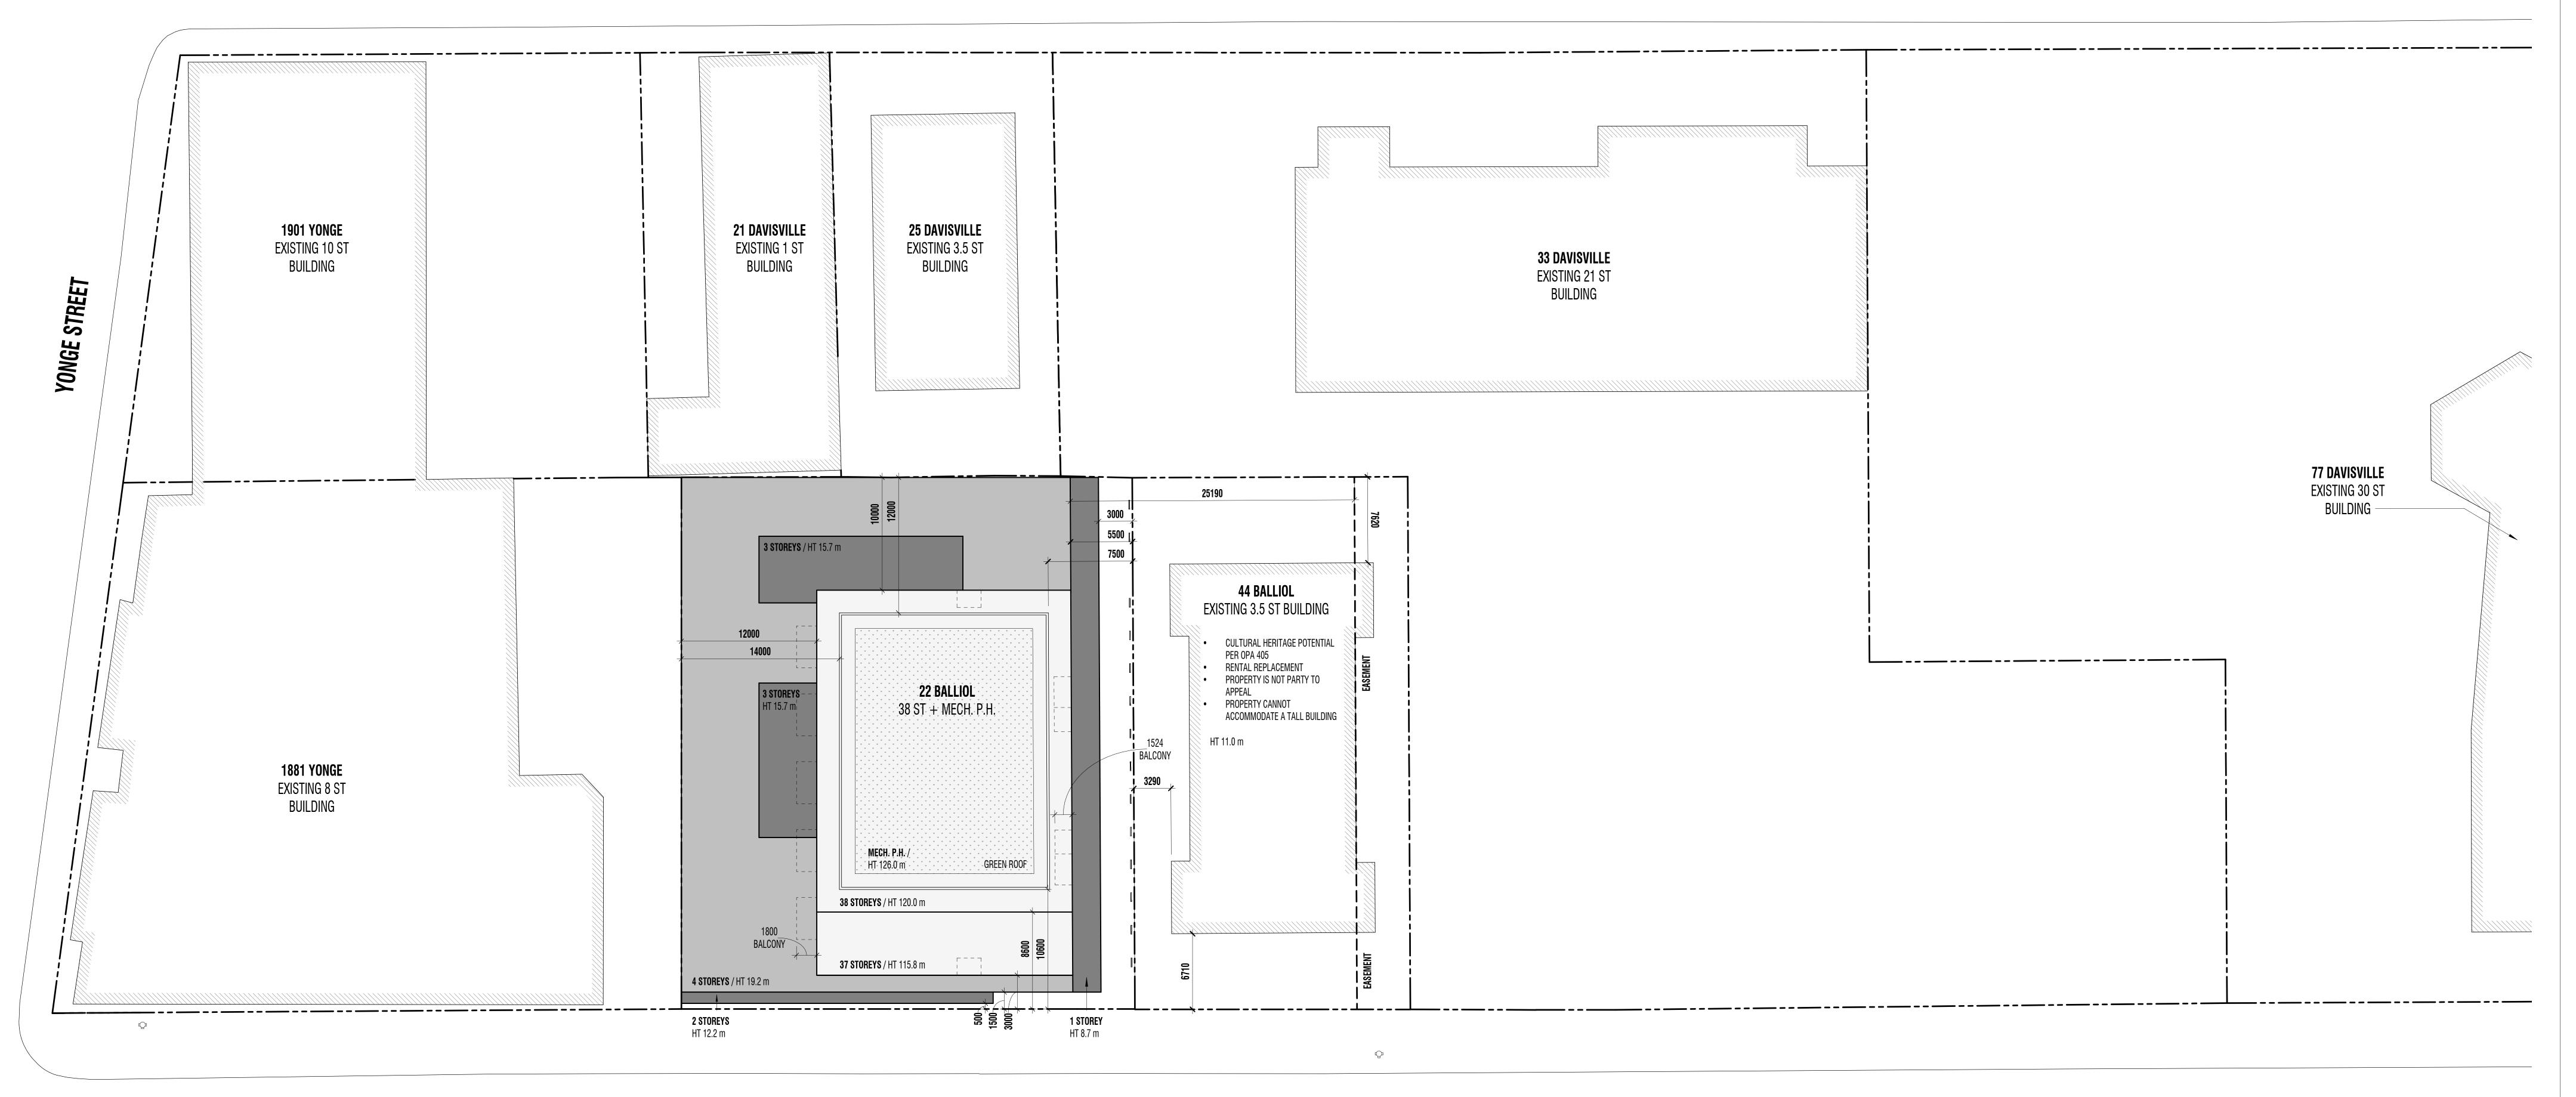
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PROJECT NO. 201301 ISSUE DATE JULY 6, 2021

SITE SURVEY

DAVISVILLE AVENUE



BALLIOL STREET

C/L OF ROAD

1 ROOF SITE PLAN - 1 : 200

GREEN ROOF STATISTICS

		PROPOS
GROSS FLOOR AREA, AS DEFINED IN GREEN ROOF BYLAW (m²)		28,258
TOTAL ROOF AREA (m ²)		1,518 ı
AREA OF RESIDENTIAL PRIVATE TERRACES (m²)		194 m
ROOFTOP OUTDOOR AMENITY SPACE, IF IN A RESIDENTIAL BUILDING (m²)		554 m
AREA OF RENEWABLE ENERGY DEVICES (m ²)		0 m ²
TOWER(S) ROOF AREA WITH FLOOR PLATE LESS THAN 750 m ² (m ²)		743 m
TOTAL AVAILABLE ROOF SPACE (m²)		26 m
GREEN ROOF COVERAGE	REQUIRED	PROPOS
COVERAGE OF AVAILABLE ROOF SPACE (m²)	16 m ²	343 m
COVERAGE OF AVAILABLE ROOF SPACE (%)	60%	13009

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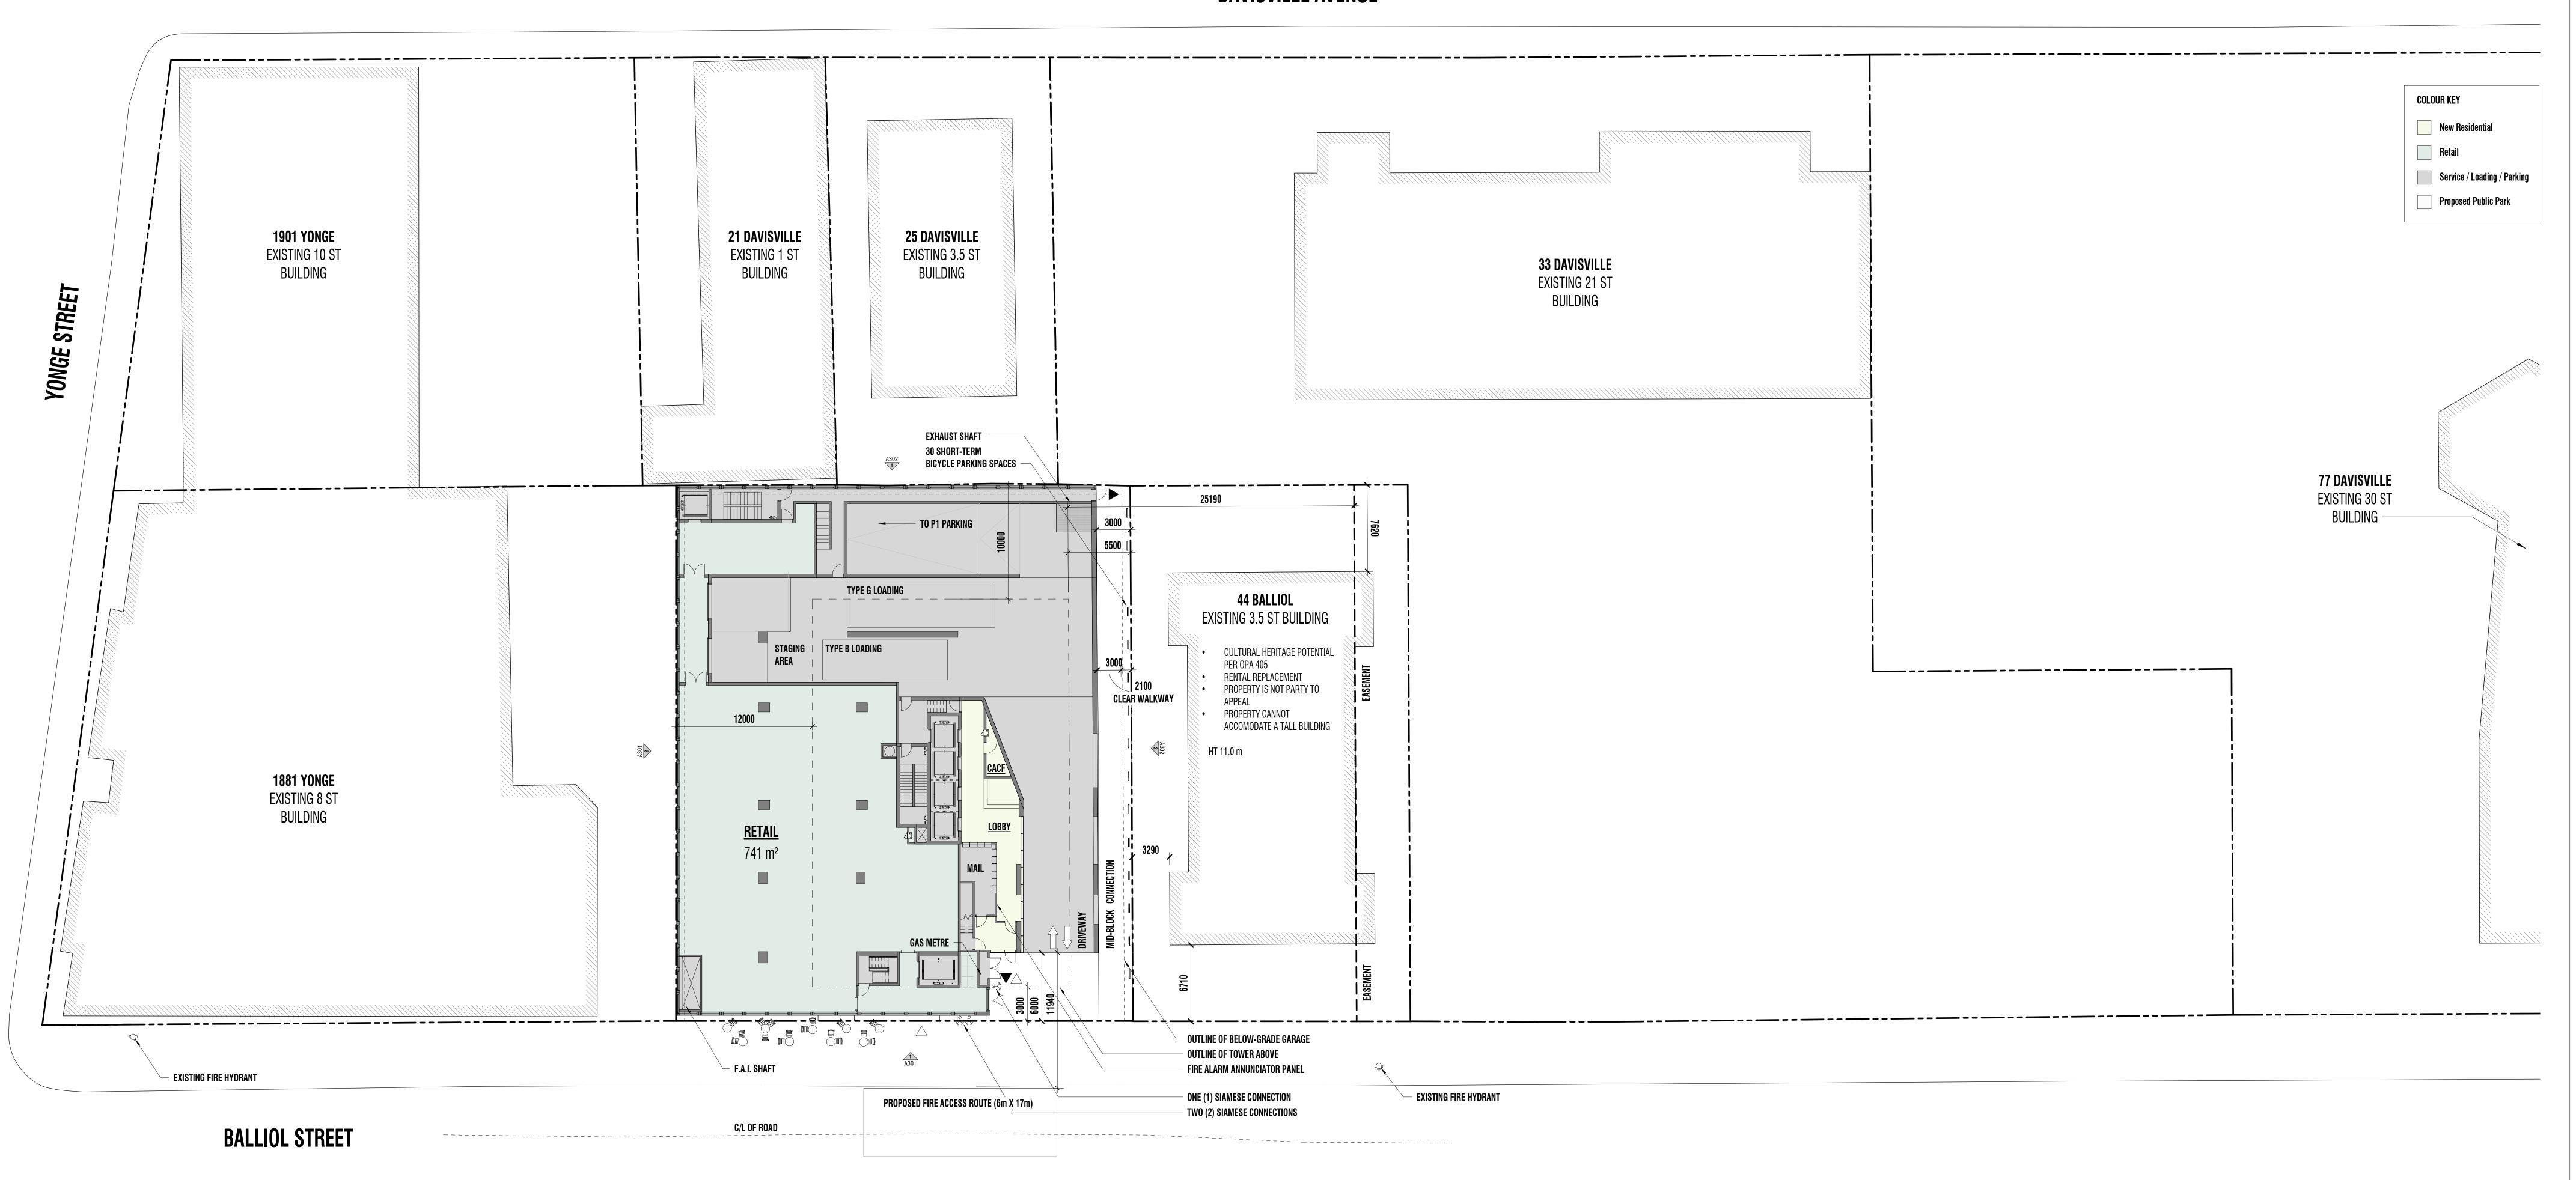
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ROOF SITE PLAN

DAVISVILLE AVENUE



1 GROUND FLOOR SITE PLAN
A01 A104 1:200

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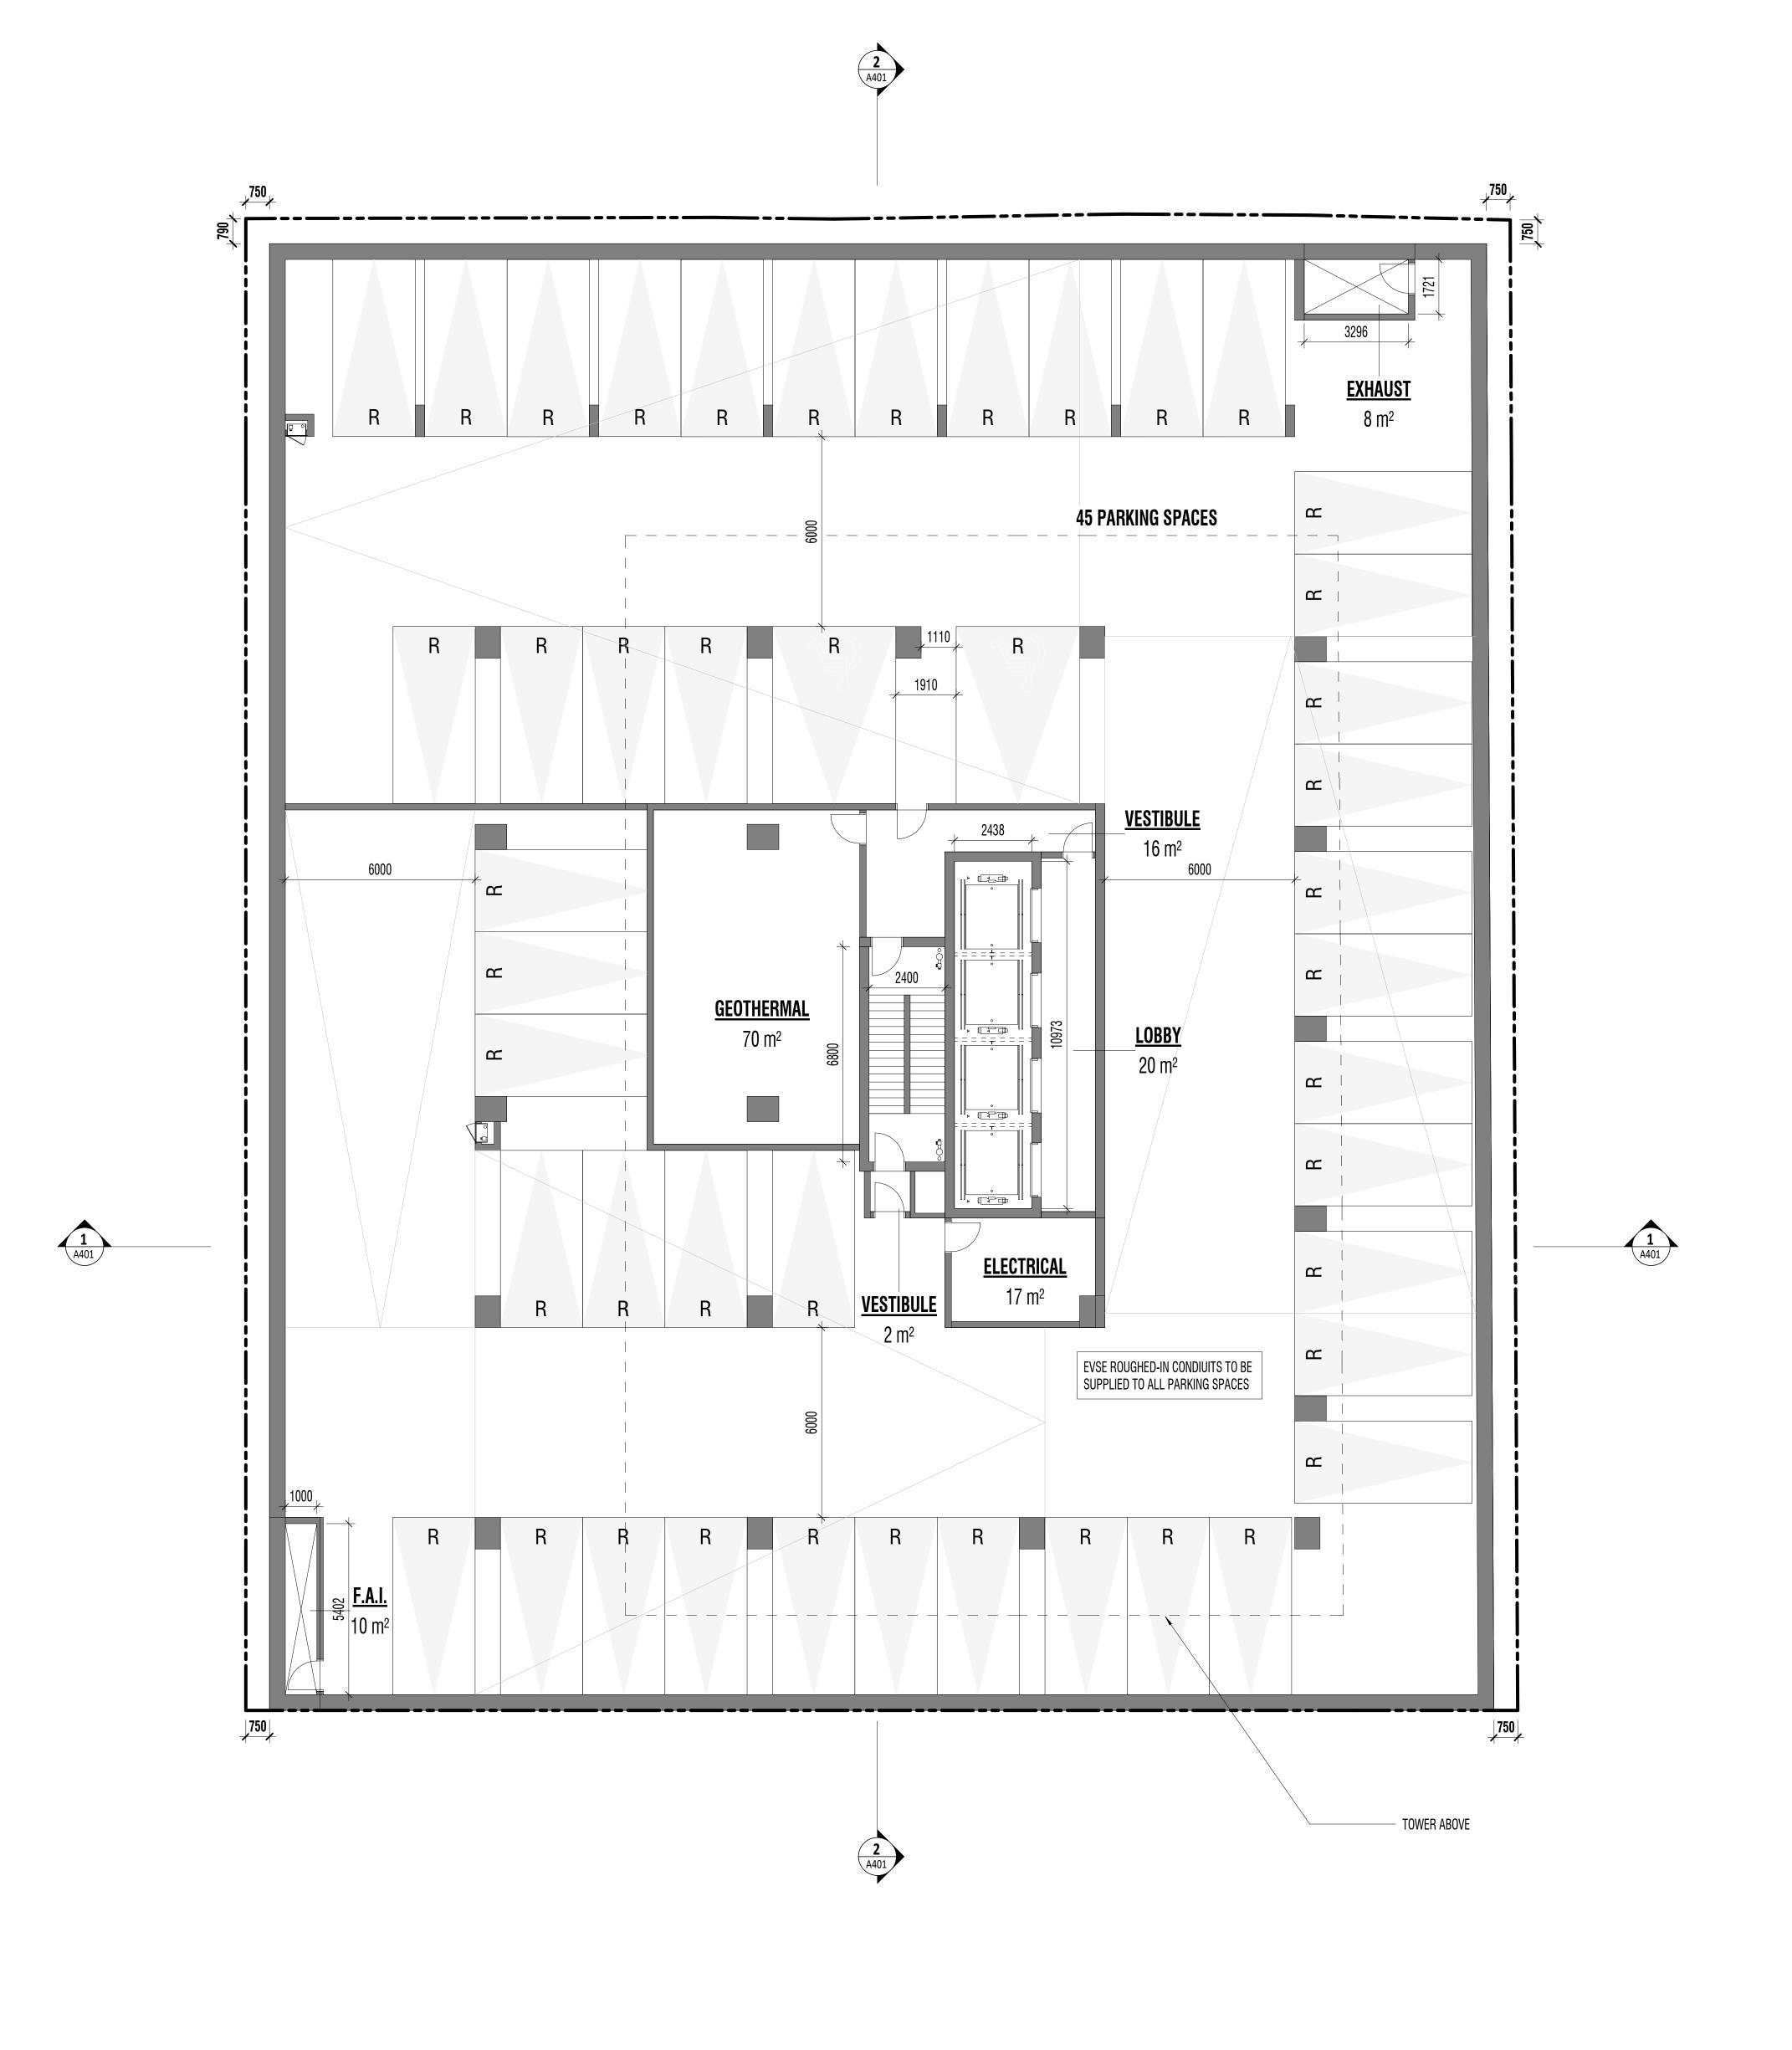
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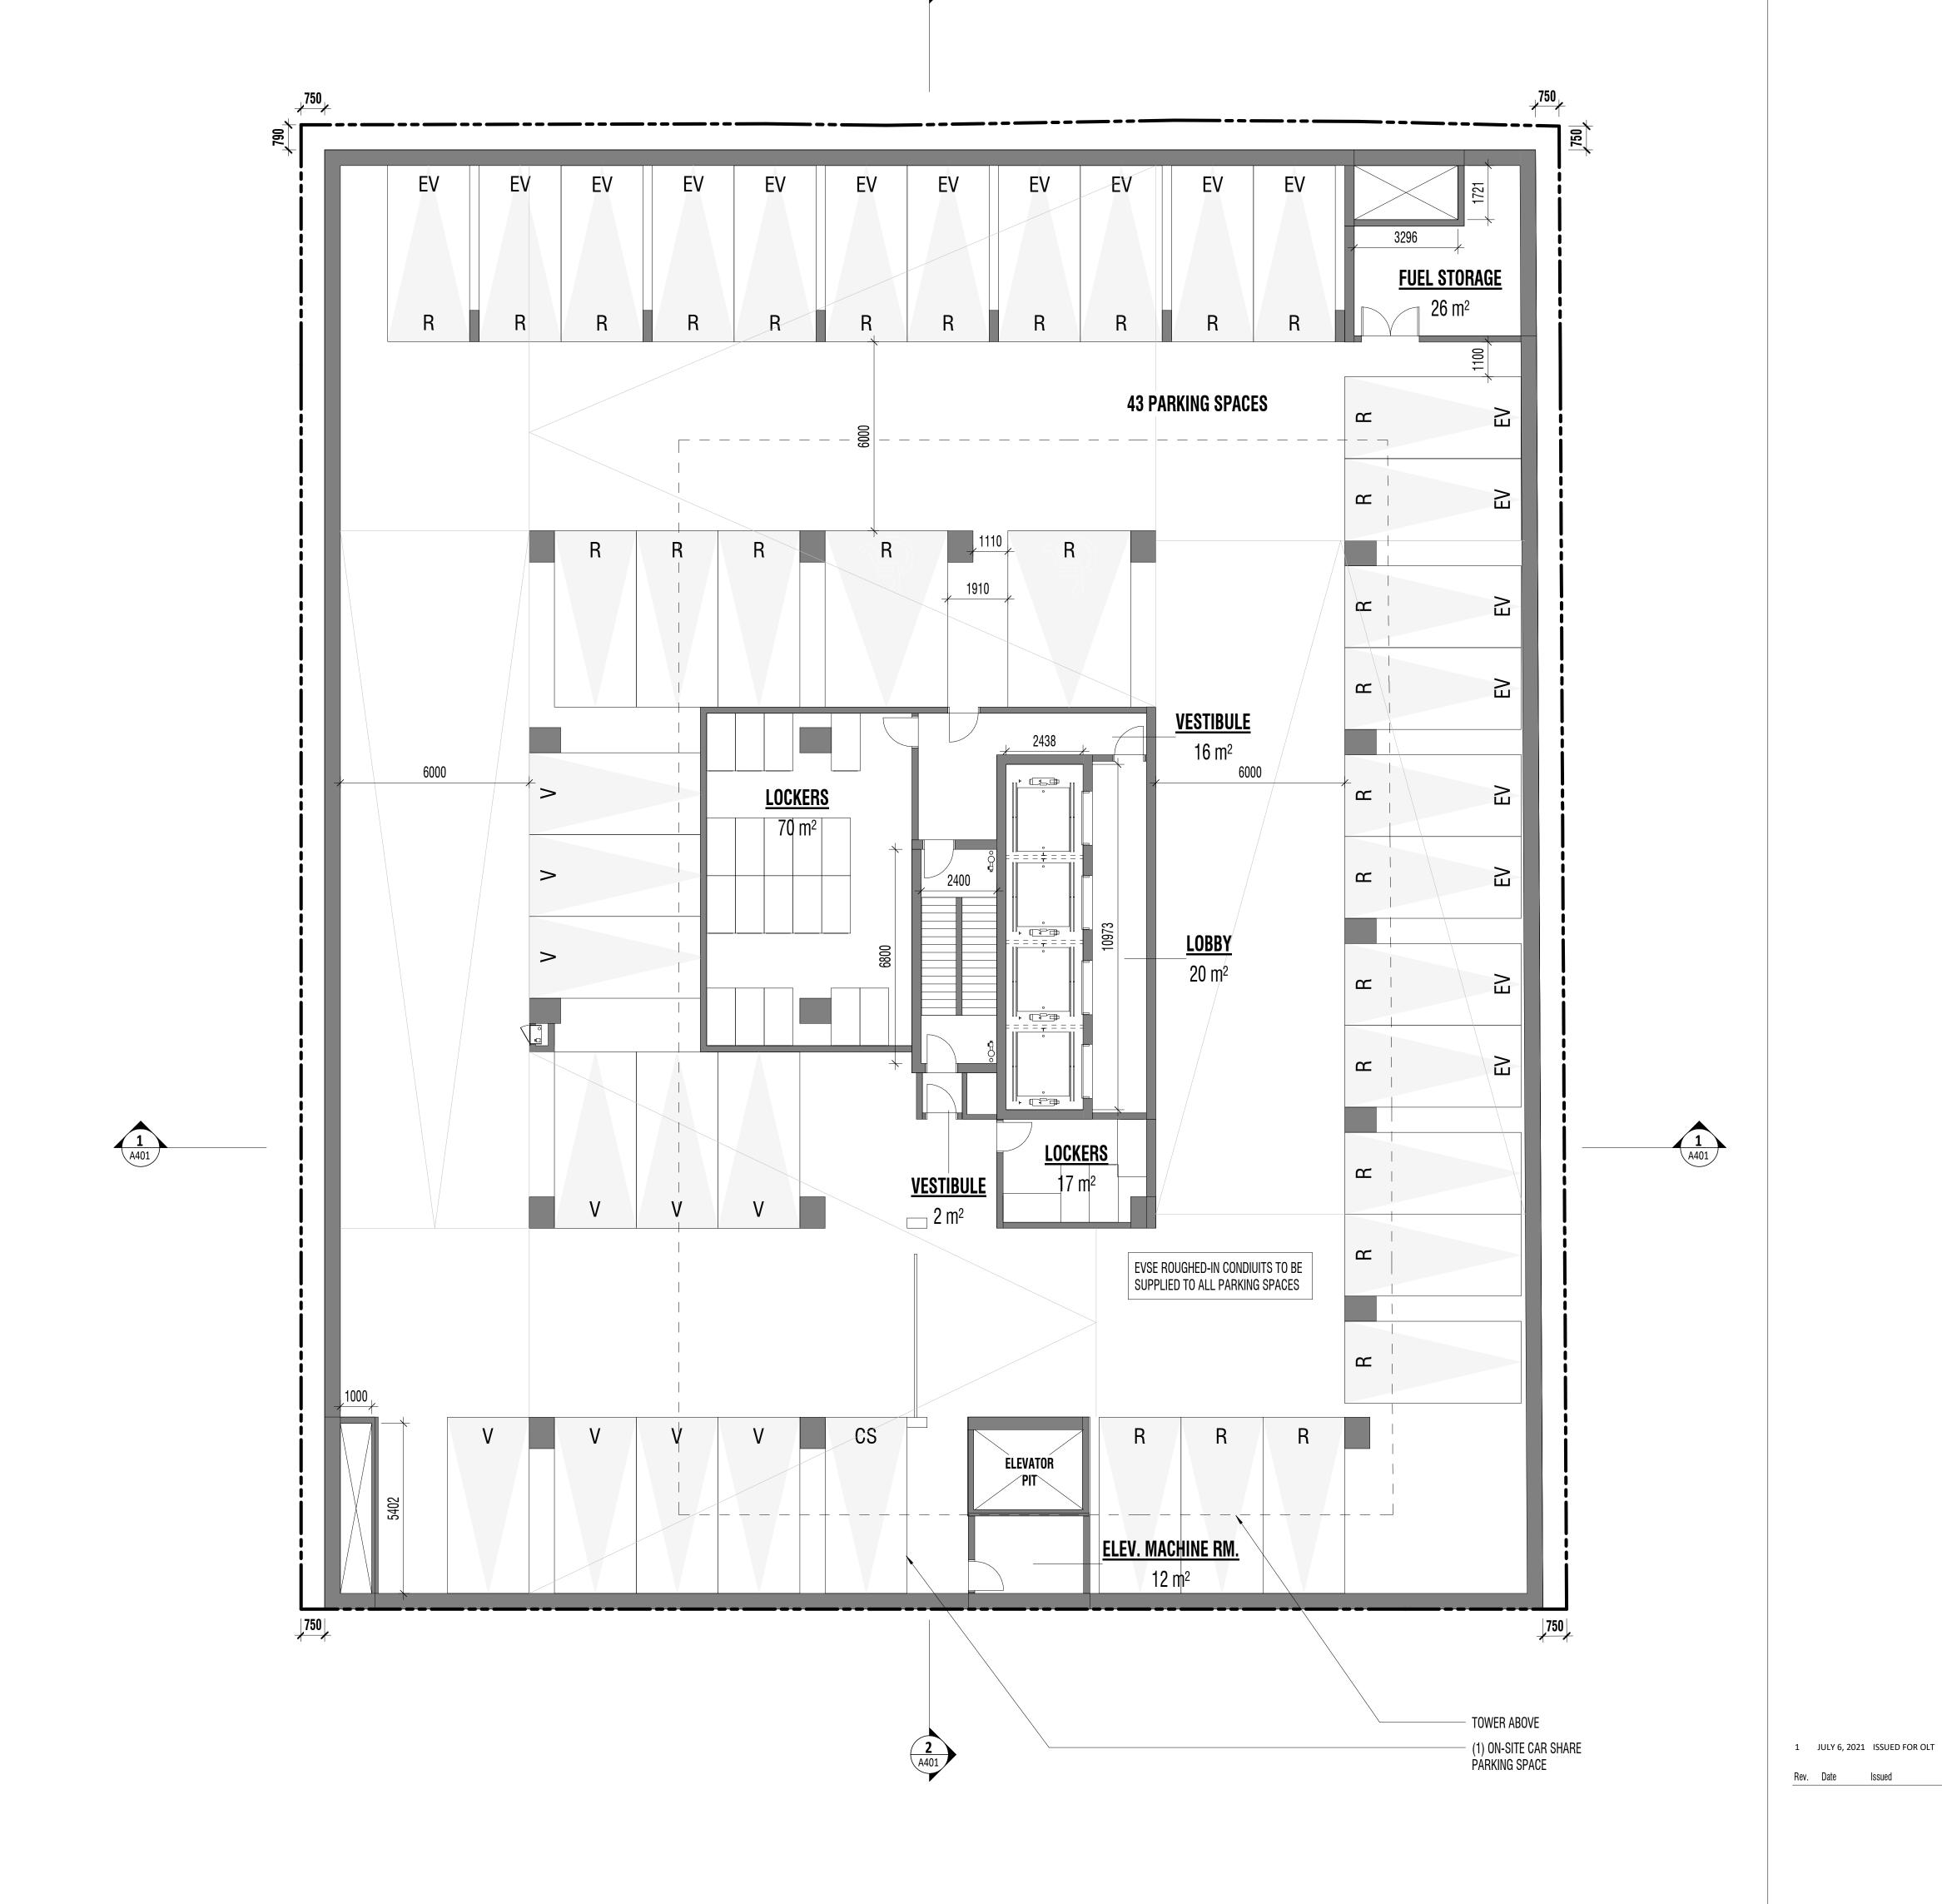
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PROJECT NO. 201301
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GROUND FLOOR SITE PLAN







2 LEVEL P3 FLOOR PLAN
A01 A105 1:100

1	LEVEL	P2 FLOOR PLAN
A01 A1	05 1:100	

				5.	1 CAR PAR	KING					
	Resid	ential Car P	arking	Visitor Car Parking			Retail Car Parking			Car Share	Total Car
Level	Regular	BF	Total	Regular	BF	Total	Regular	BF	Total	Parking	Parking
P1	0	0	0	12	1	13	9	1	10	0	23
P2	28	2	30	10	0	10	0	0	0	1	41
P3	43	2	45	0	0	0	0	0	0	0	45
ΤΩΤΛΙ	71	1	75	22	1	23	0	1	10	1	100

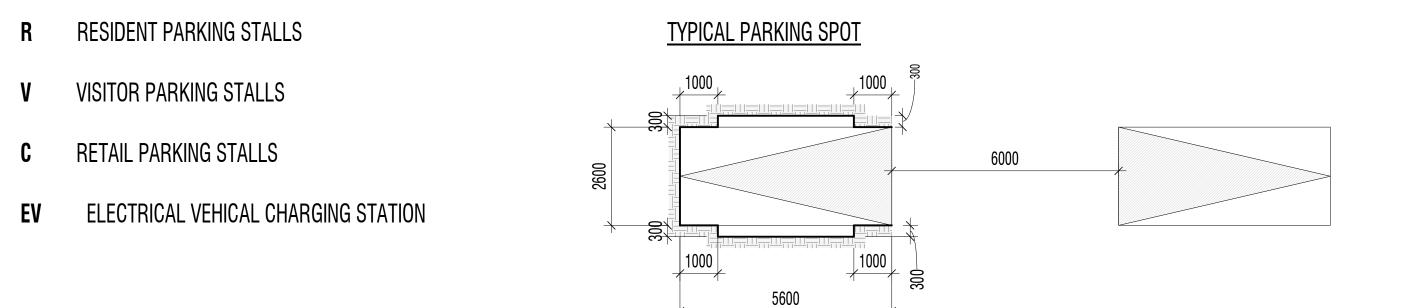

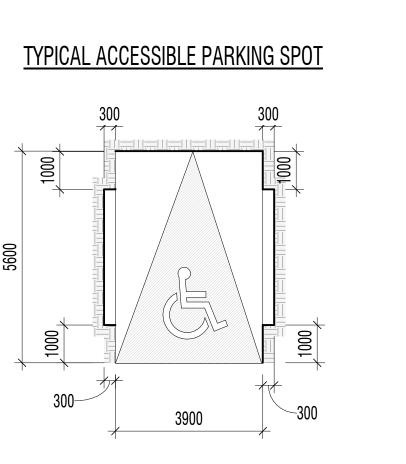

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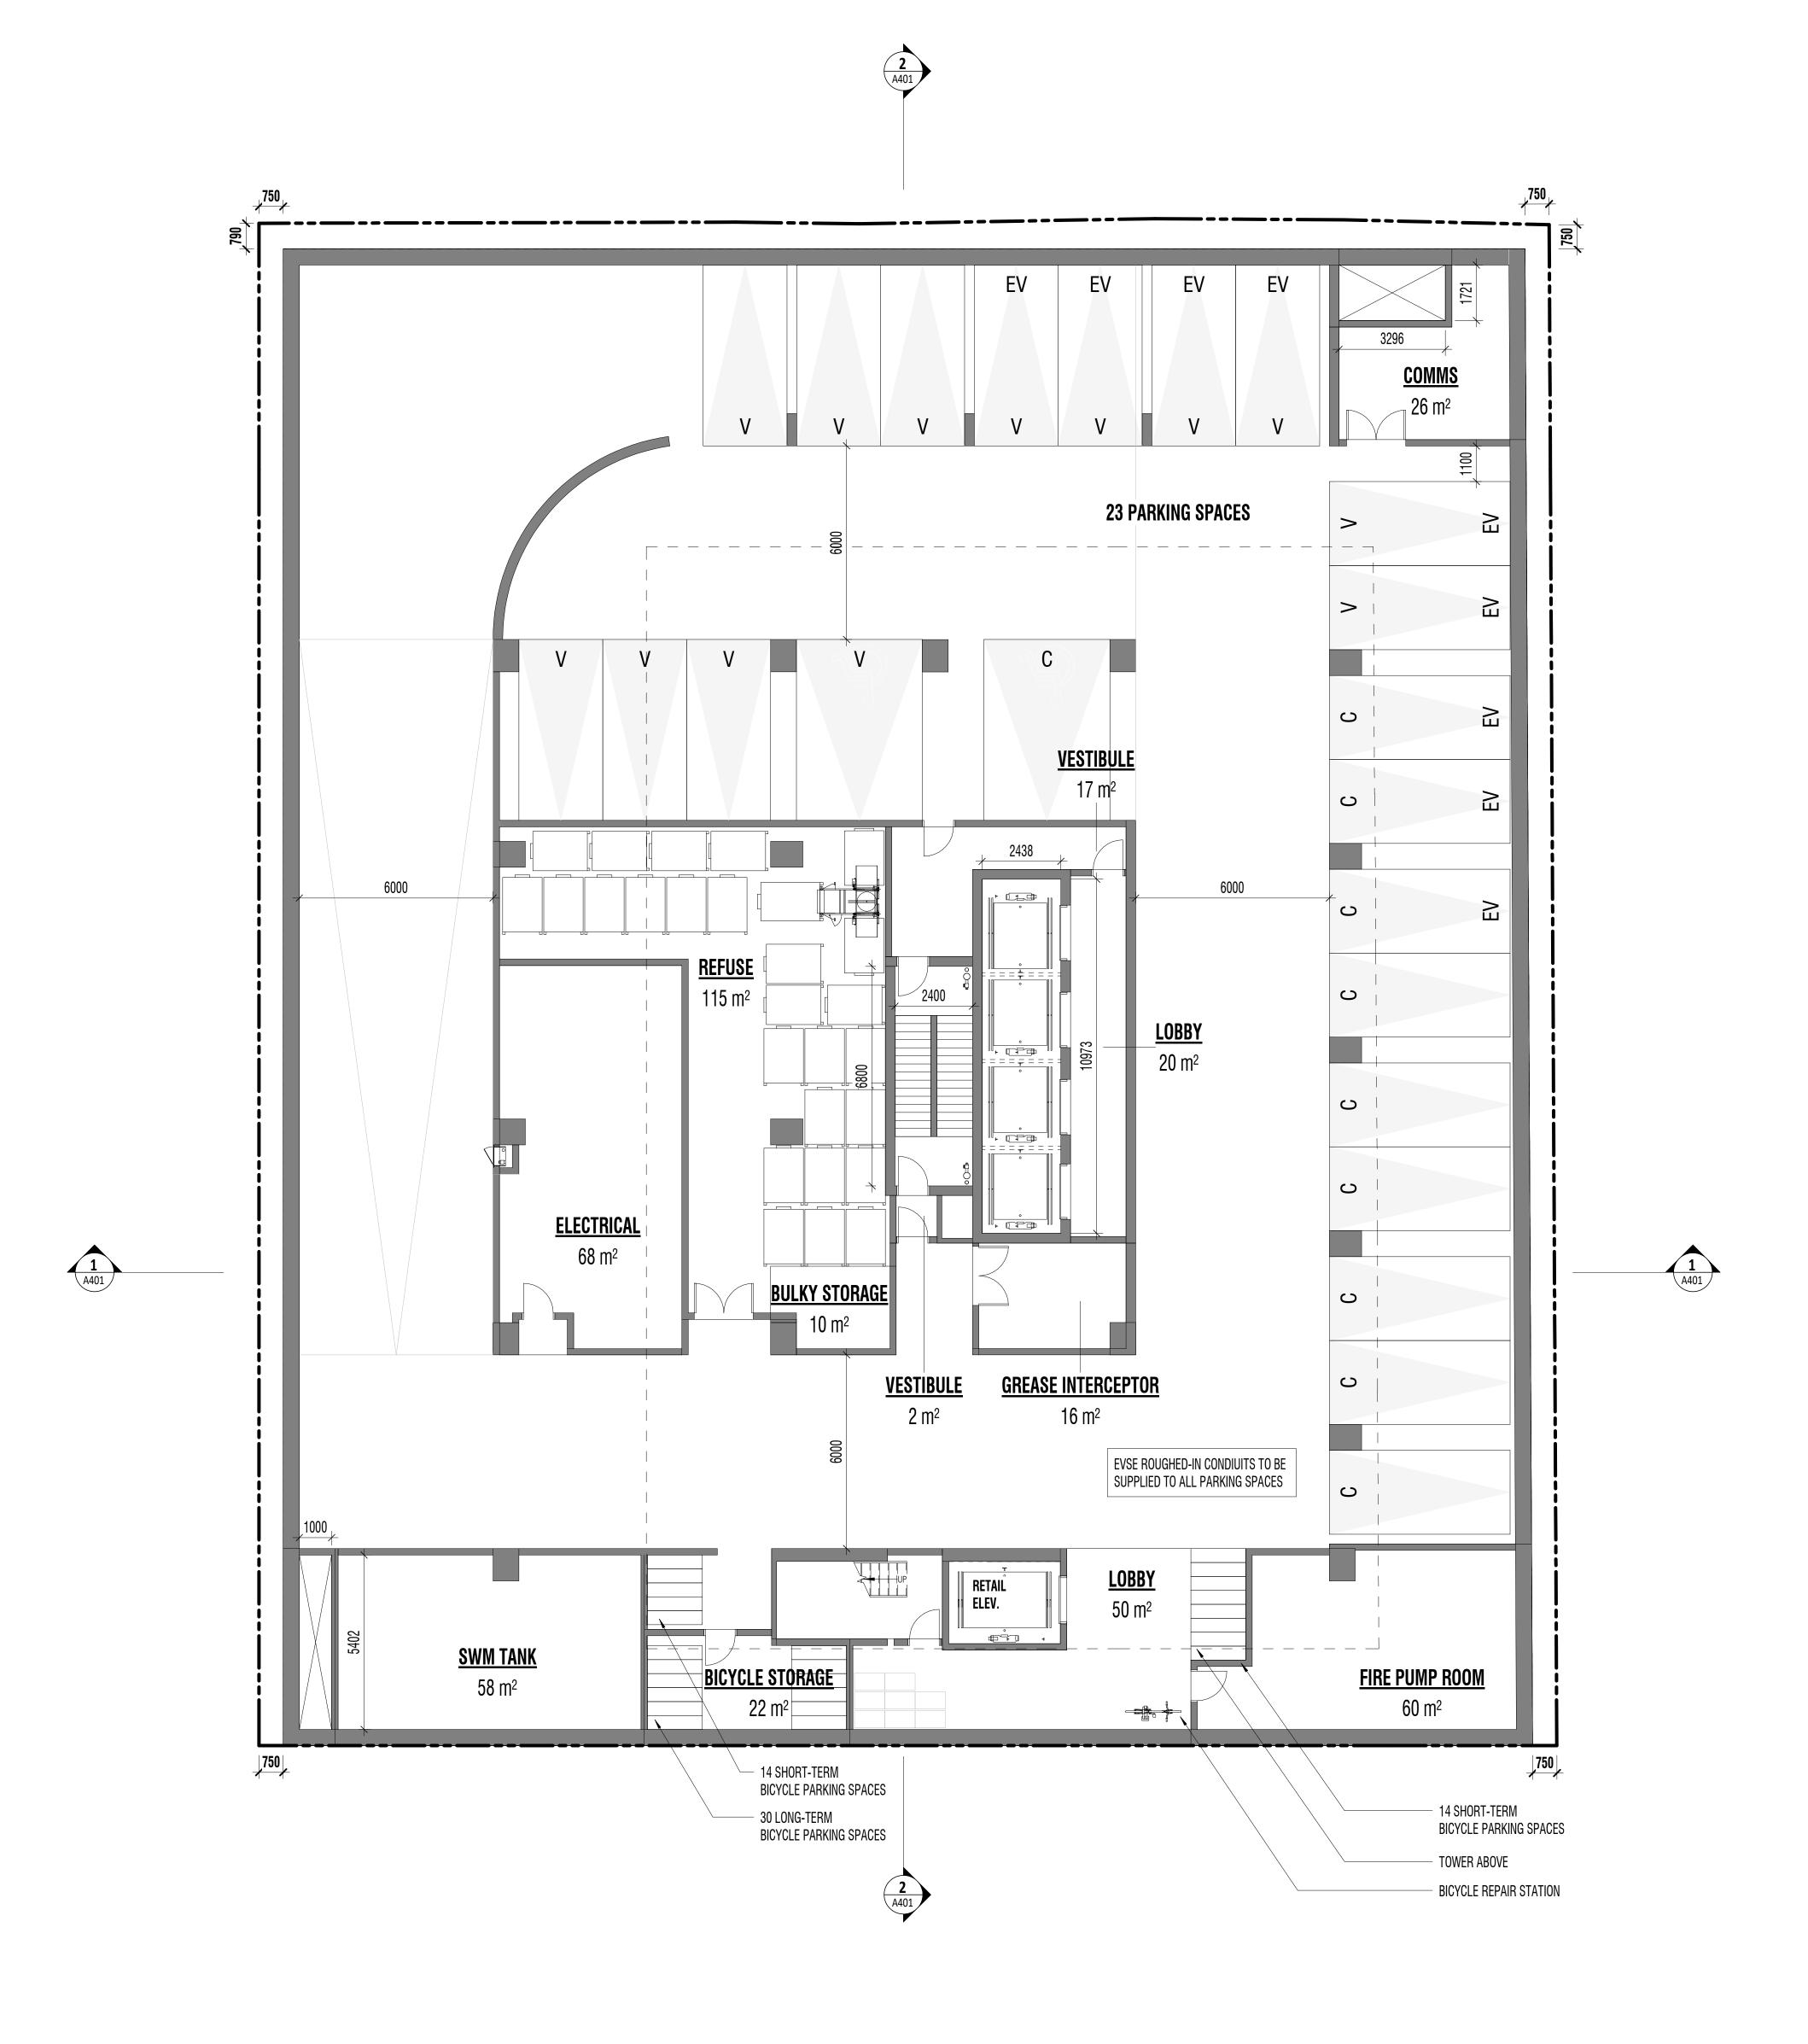
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FLOOR PLAN

LEVEL P3, P2



LEVEL P1 FLOOR PLAN


				5.	1 CAR PAR	KING					
	Resid	ential Car P	arking	Visitor Car Parking			Retail Car Parking			Car Share	Total Car
Level	Regular	BF	Total	Regular	BF	Total	Regular	BF	Total	Parking	Parking
P1	0	0	0	12	1	13	9	1	10	0	23
P2	28	2	30	10	0	10	0	0	0	1	41
P3	43	2	45	0	0	0	0	0	0	0	45
TOTAL	71	1	75	22	1	23	0	1	10	1	100


R RESIDENT PARKING STALLS

V VISITOR PARKING STALLS

C RETAIL PARKING STALLS

EV ELECTRICAL VEHICAL CHARGING STATION

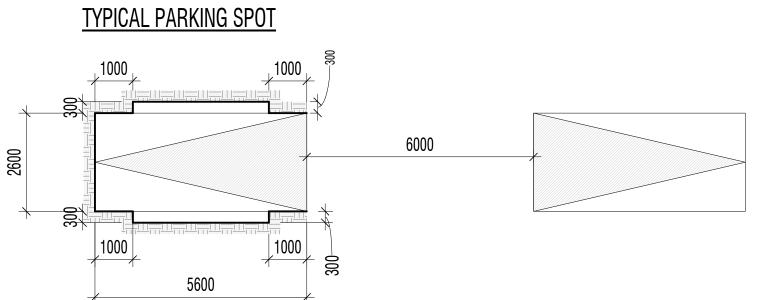

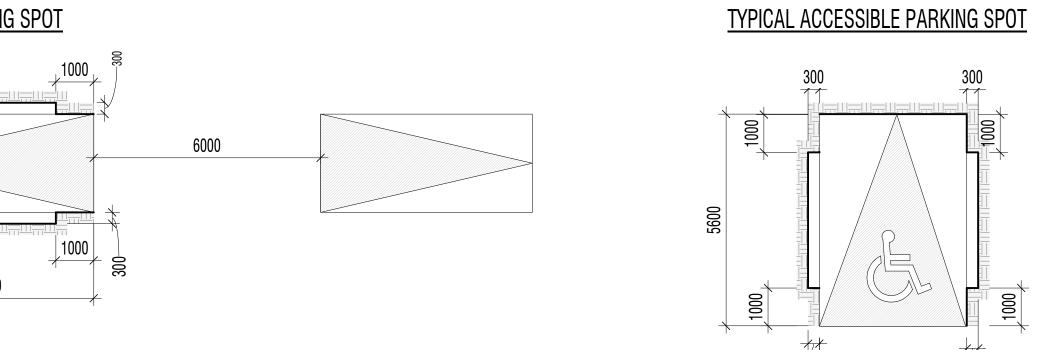


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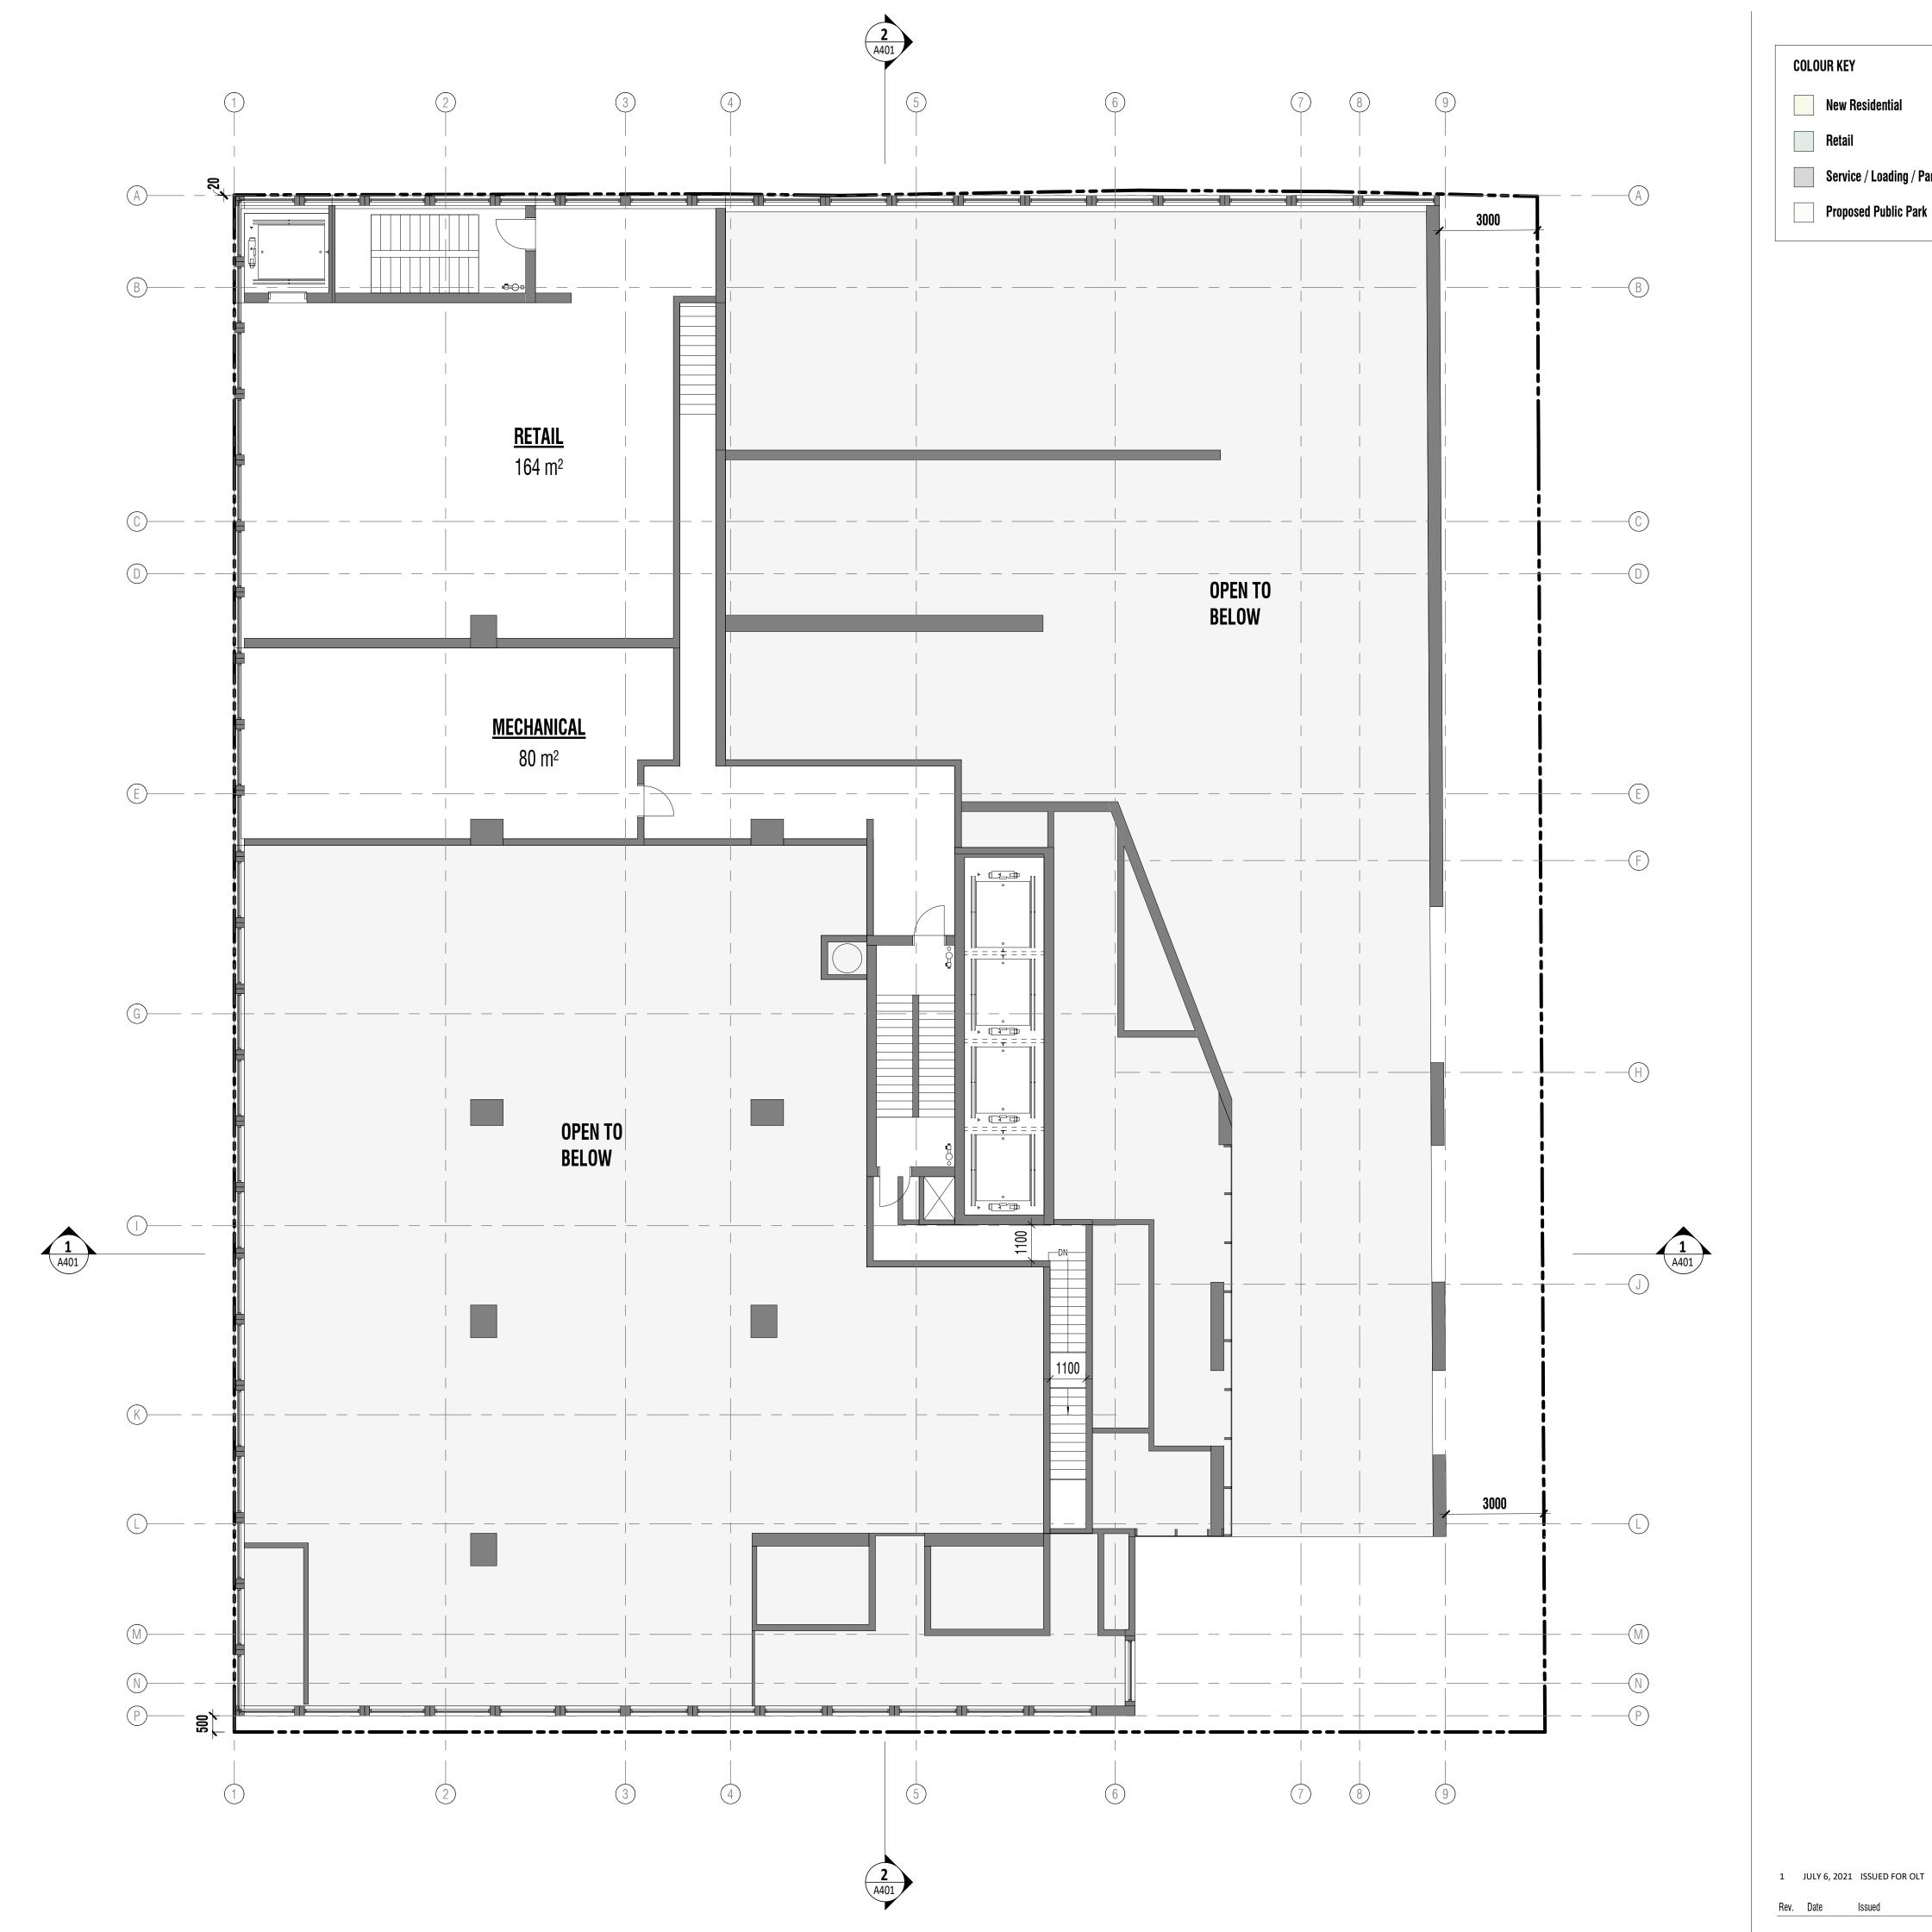
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LEVEL P1 **FLOOR PLAN**







2 LEVEL 1 MEZZANINE FLOOR PLAN
A01 A201 1:100

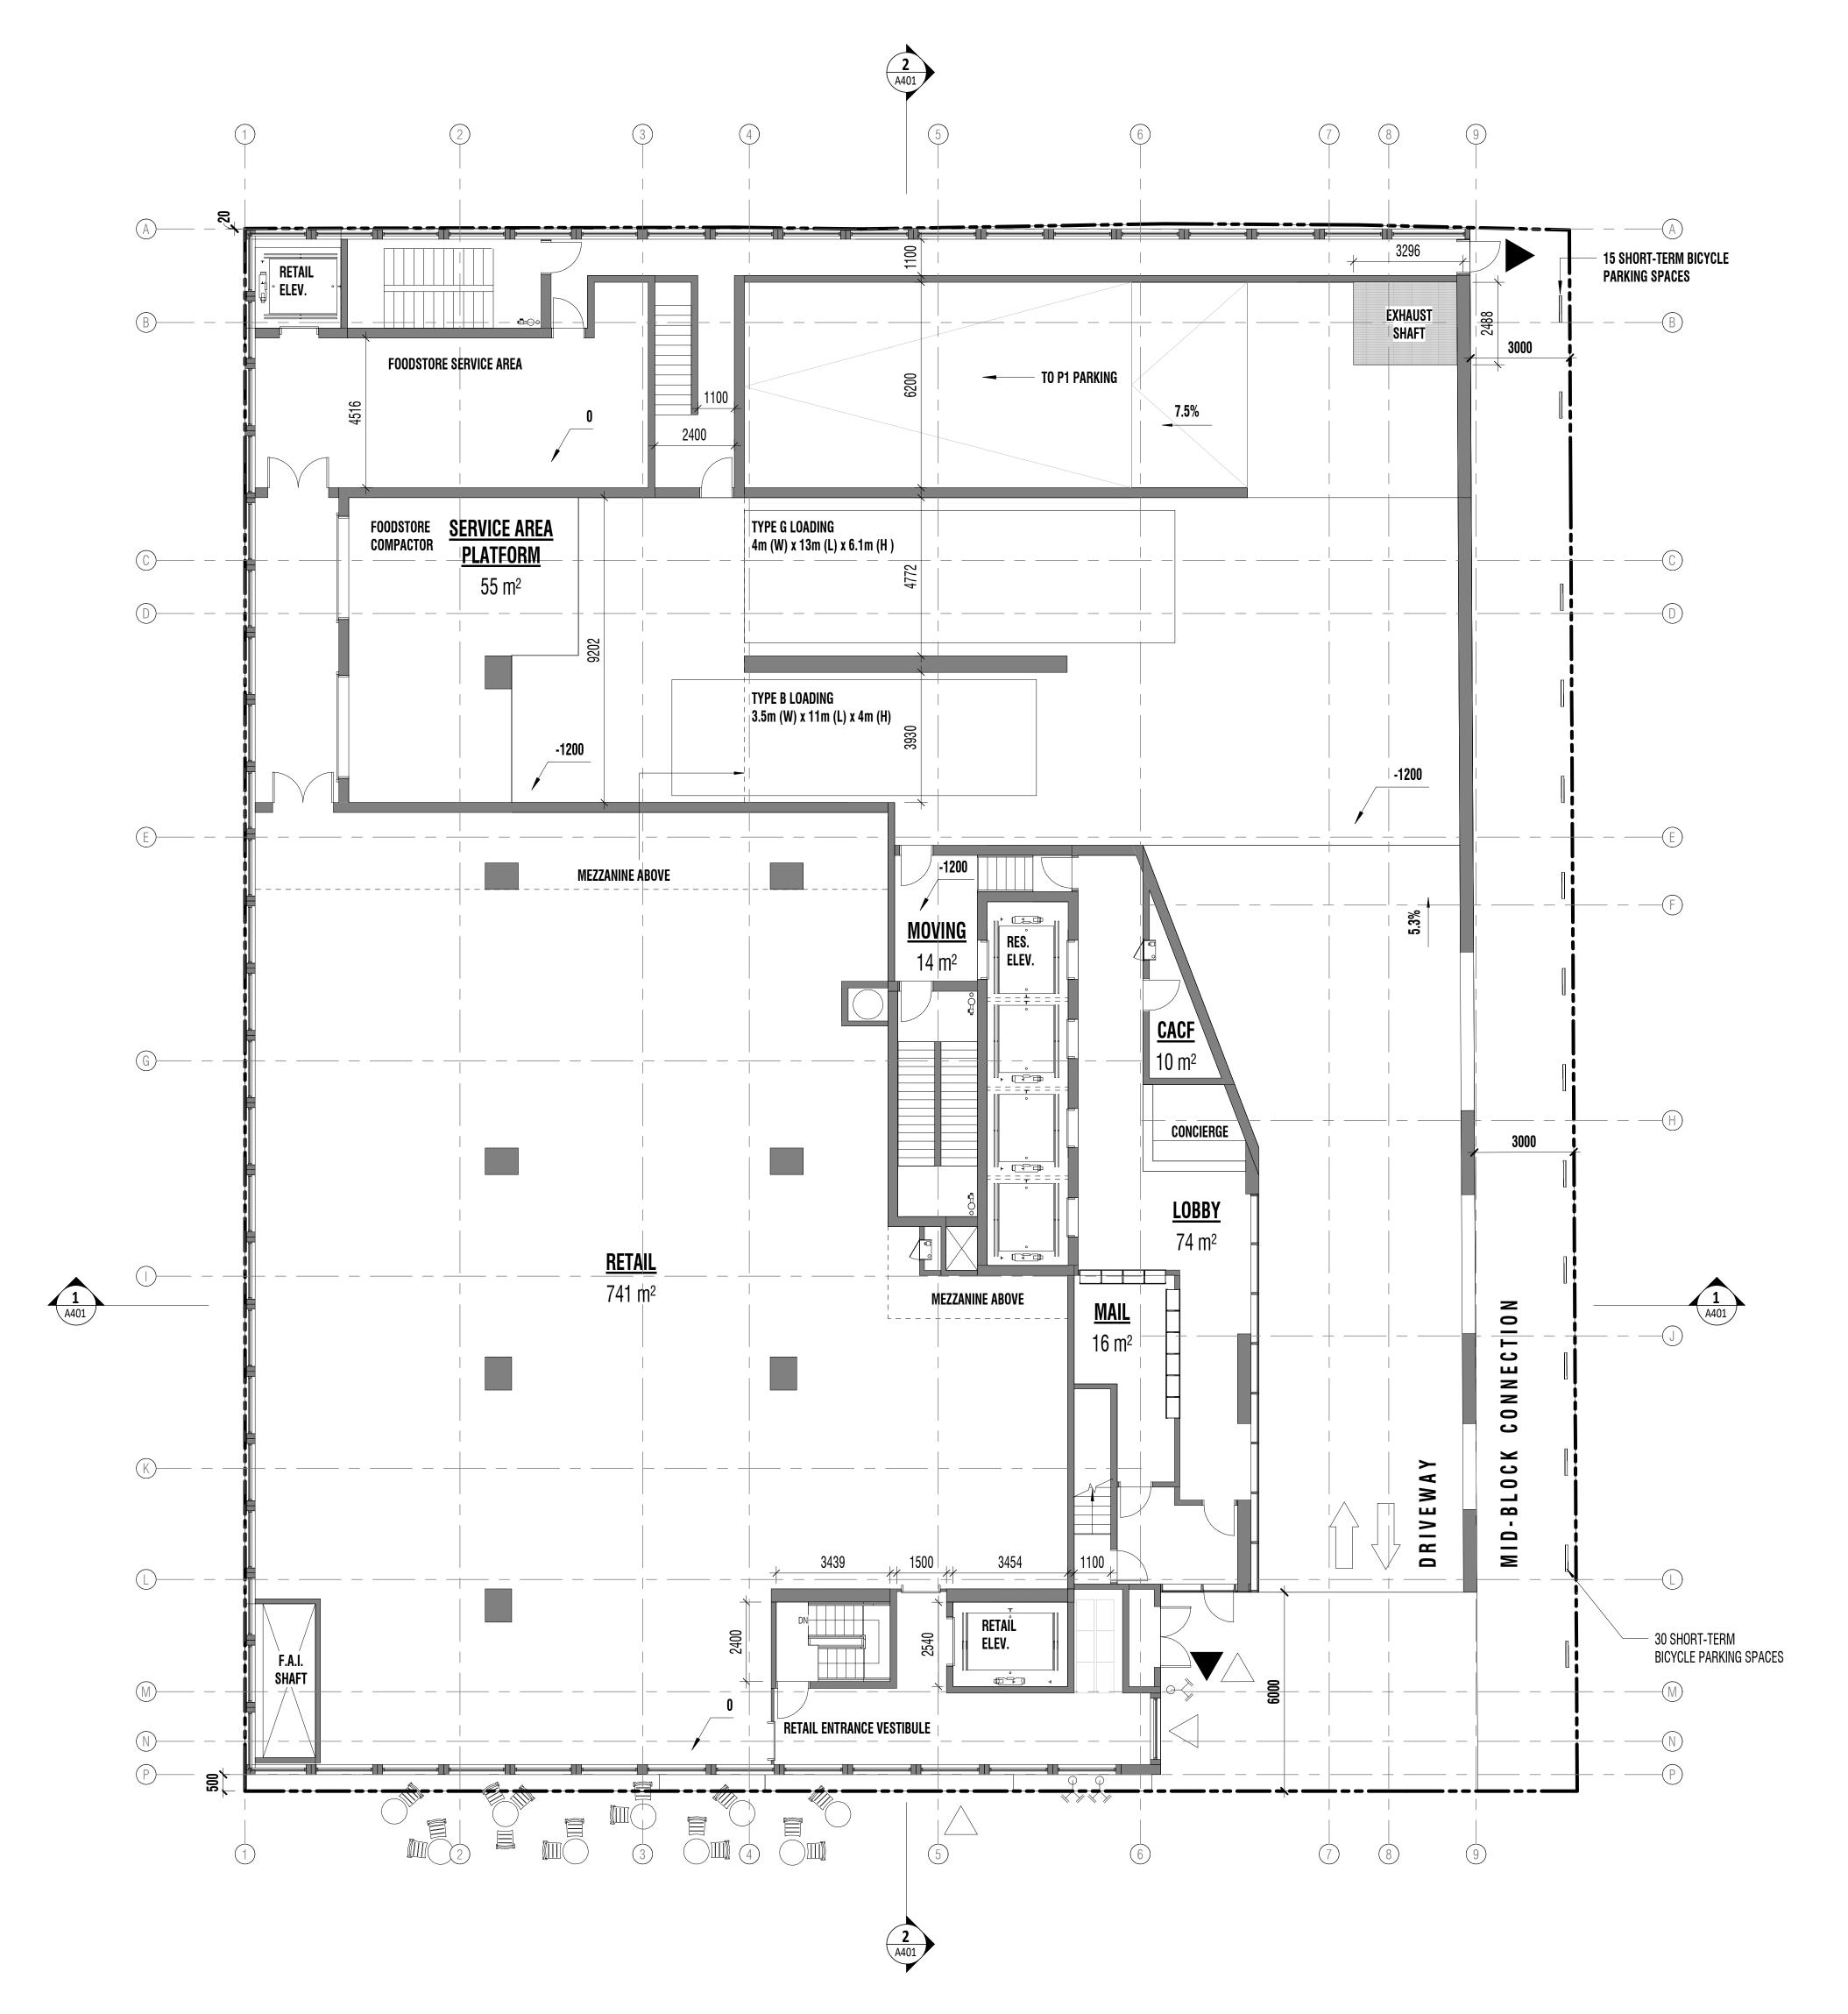
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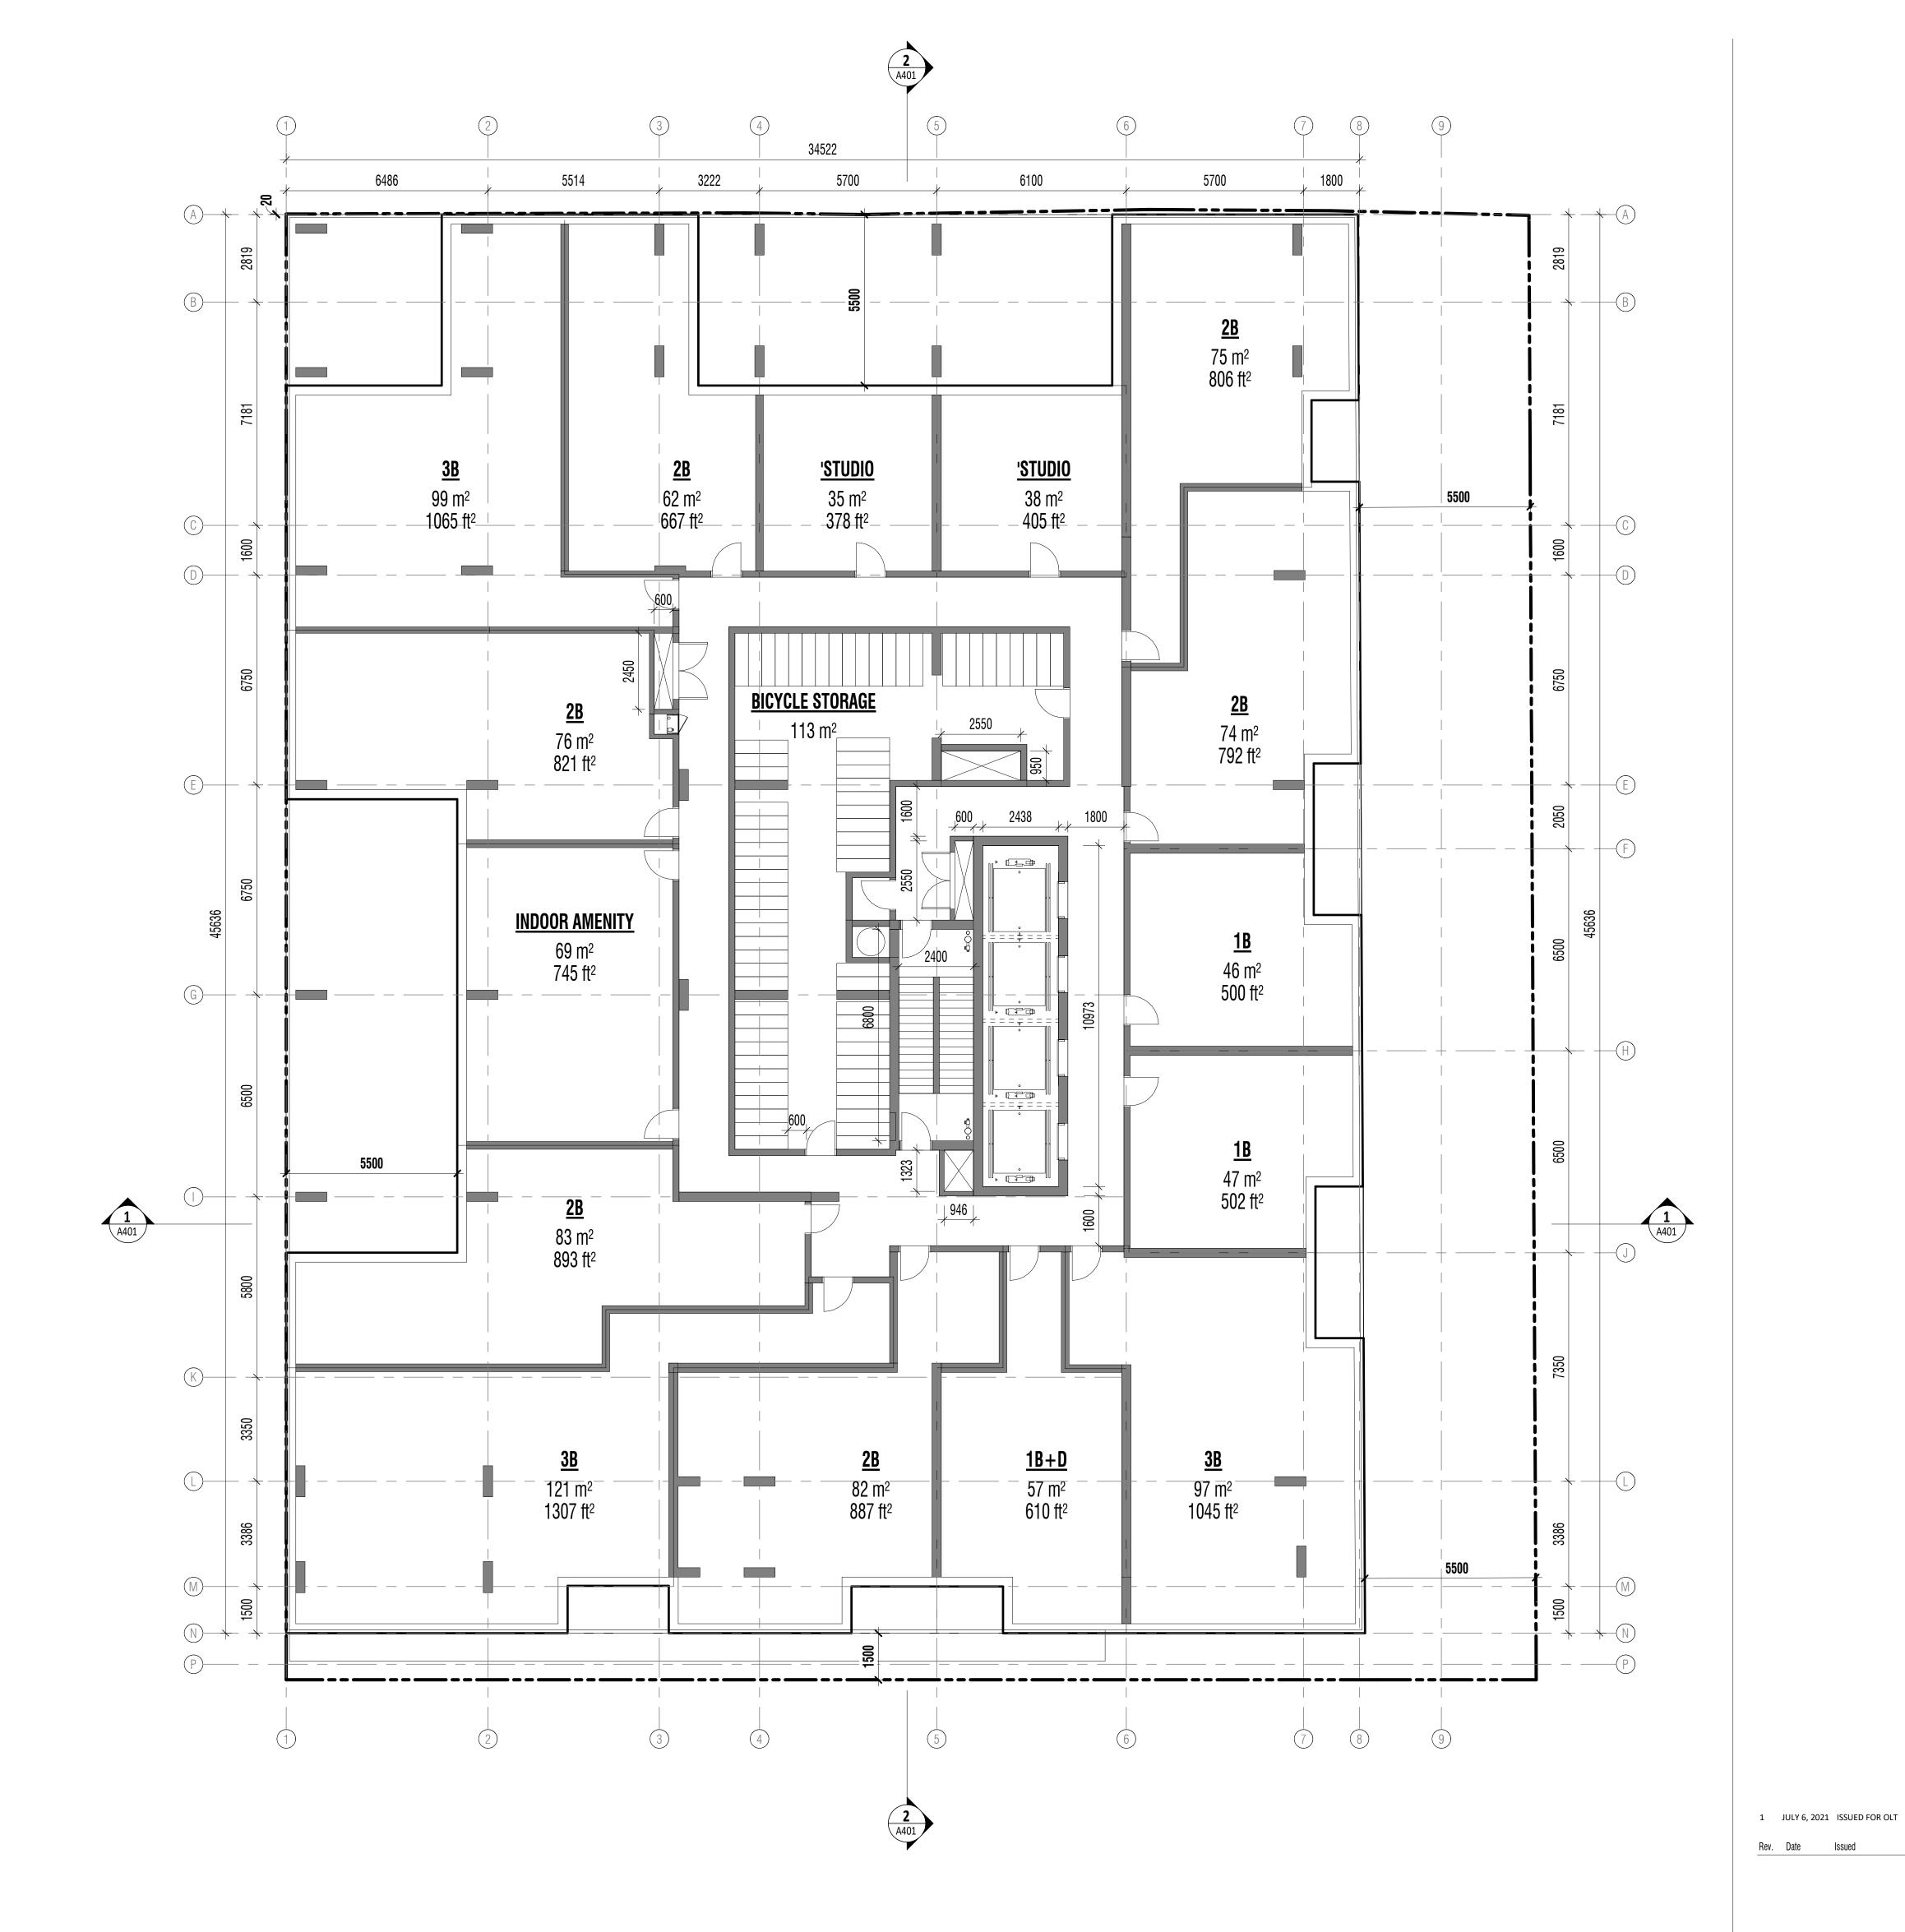
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LEVEL 1, **1-MEZZANINE FLOOR PLANS** A201








2 LEVEL 3 FLOOR PLAN
A01 A202 1:100
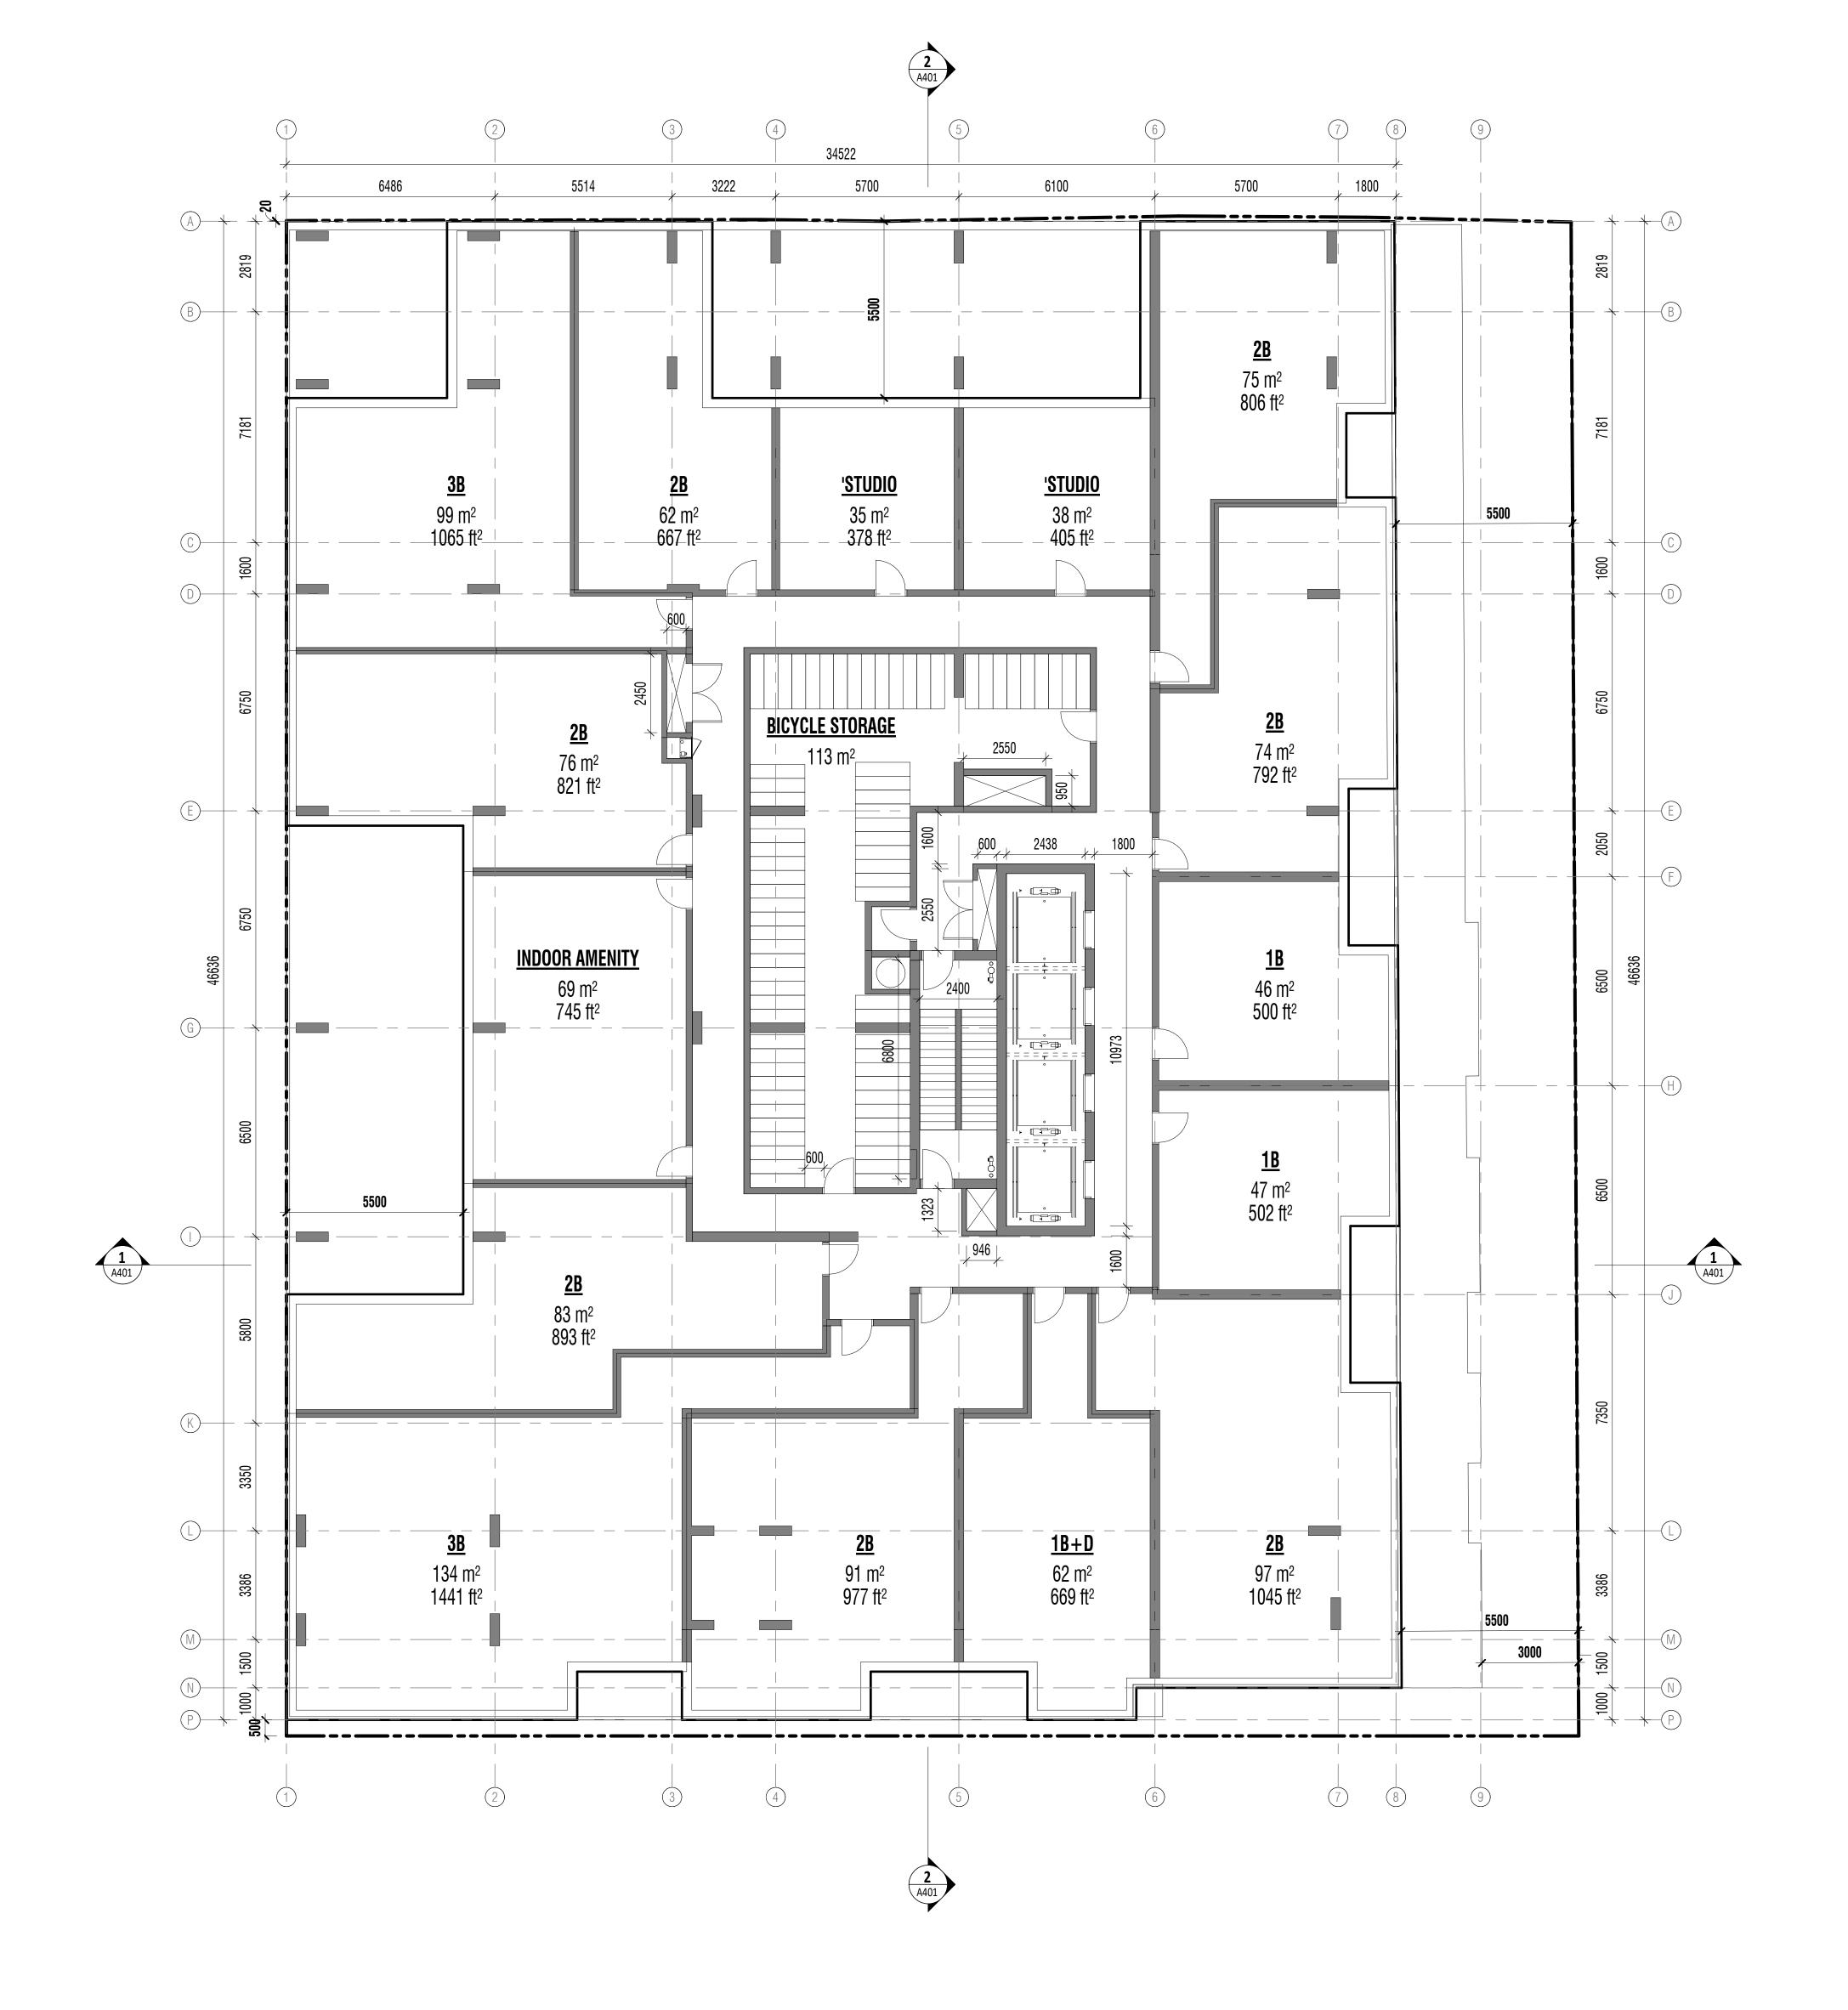
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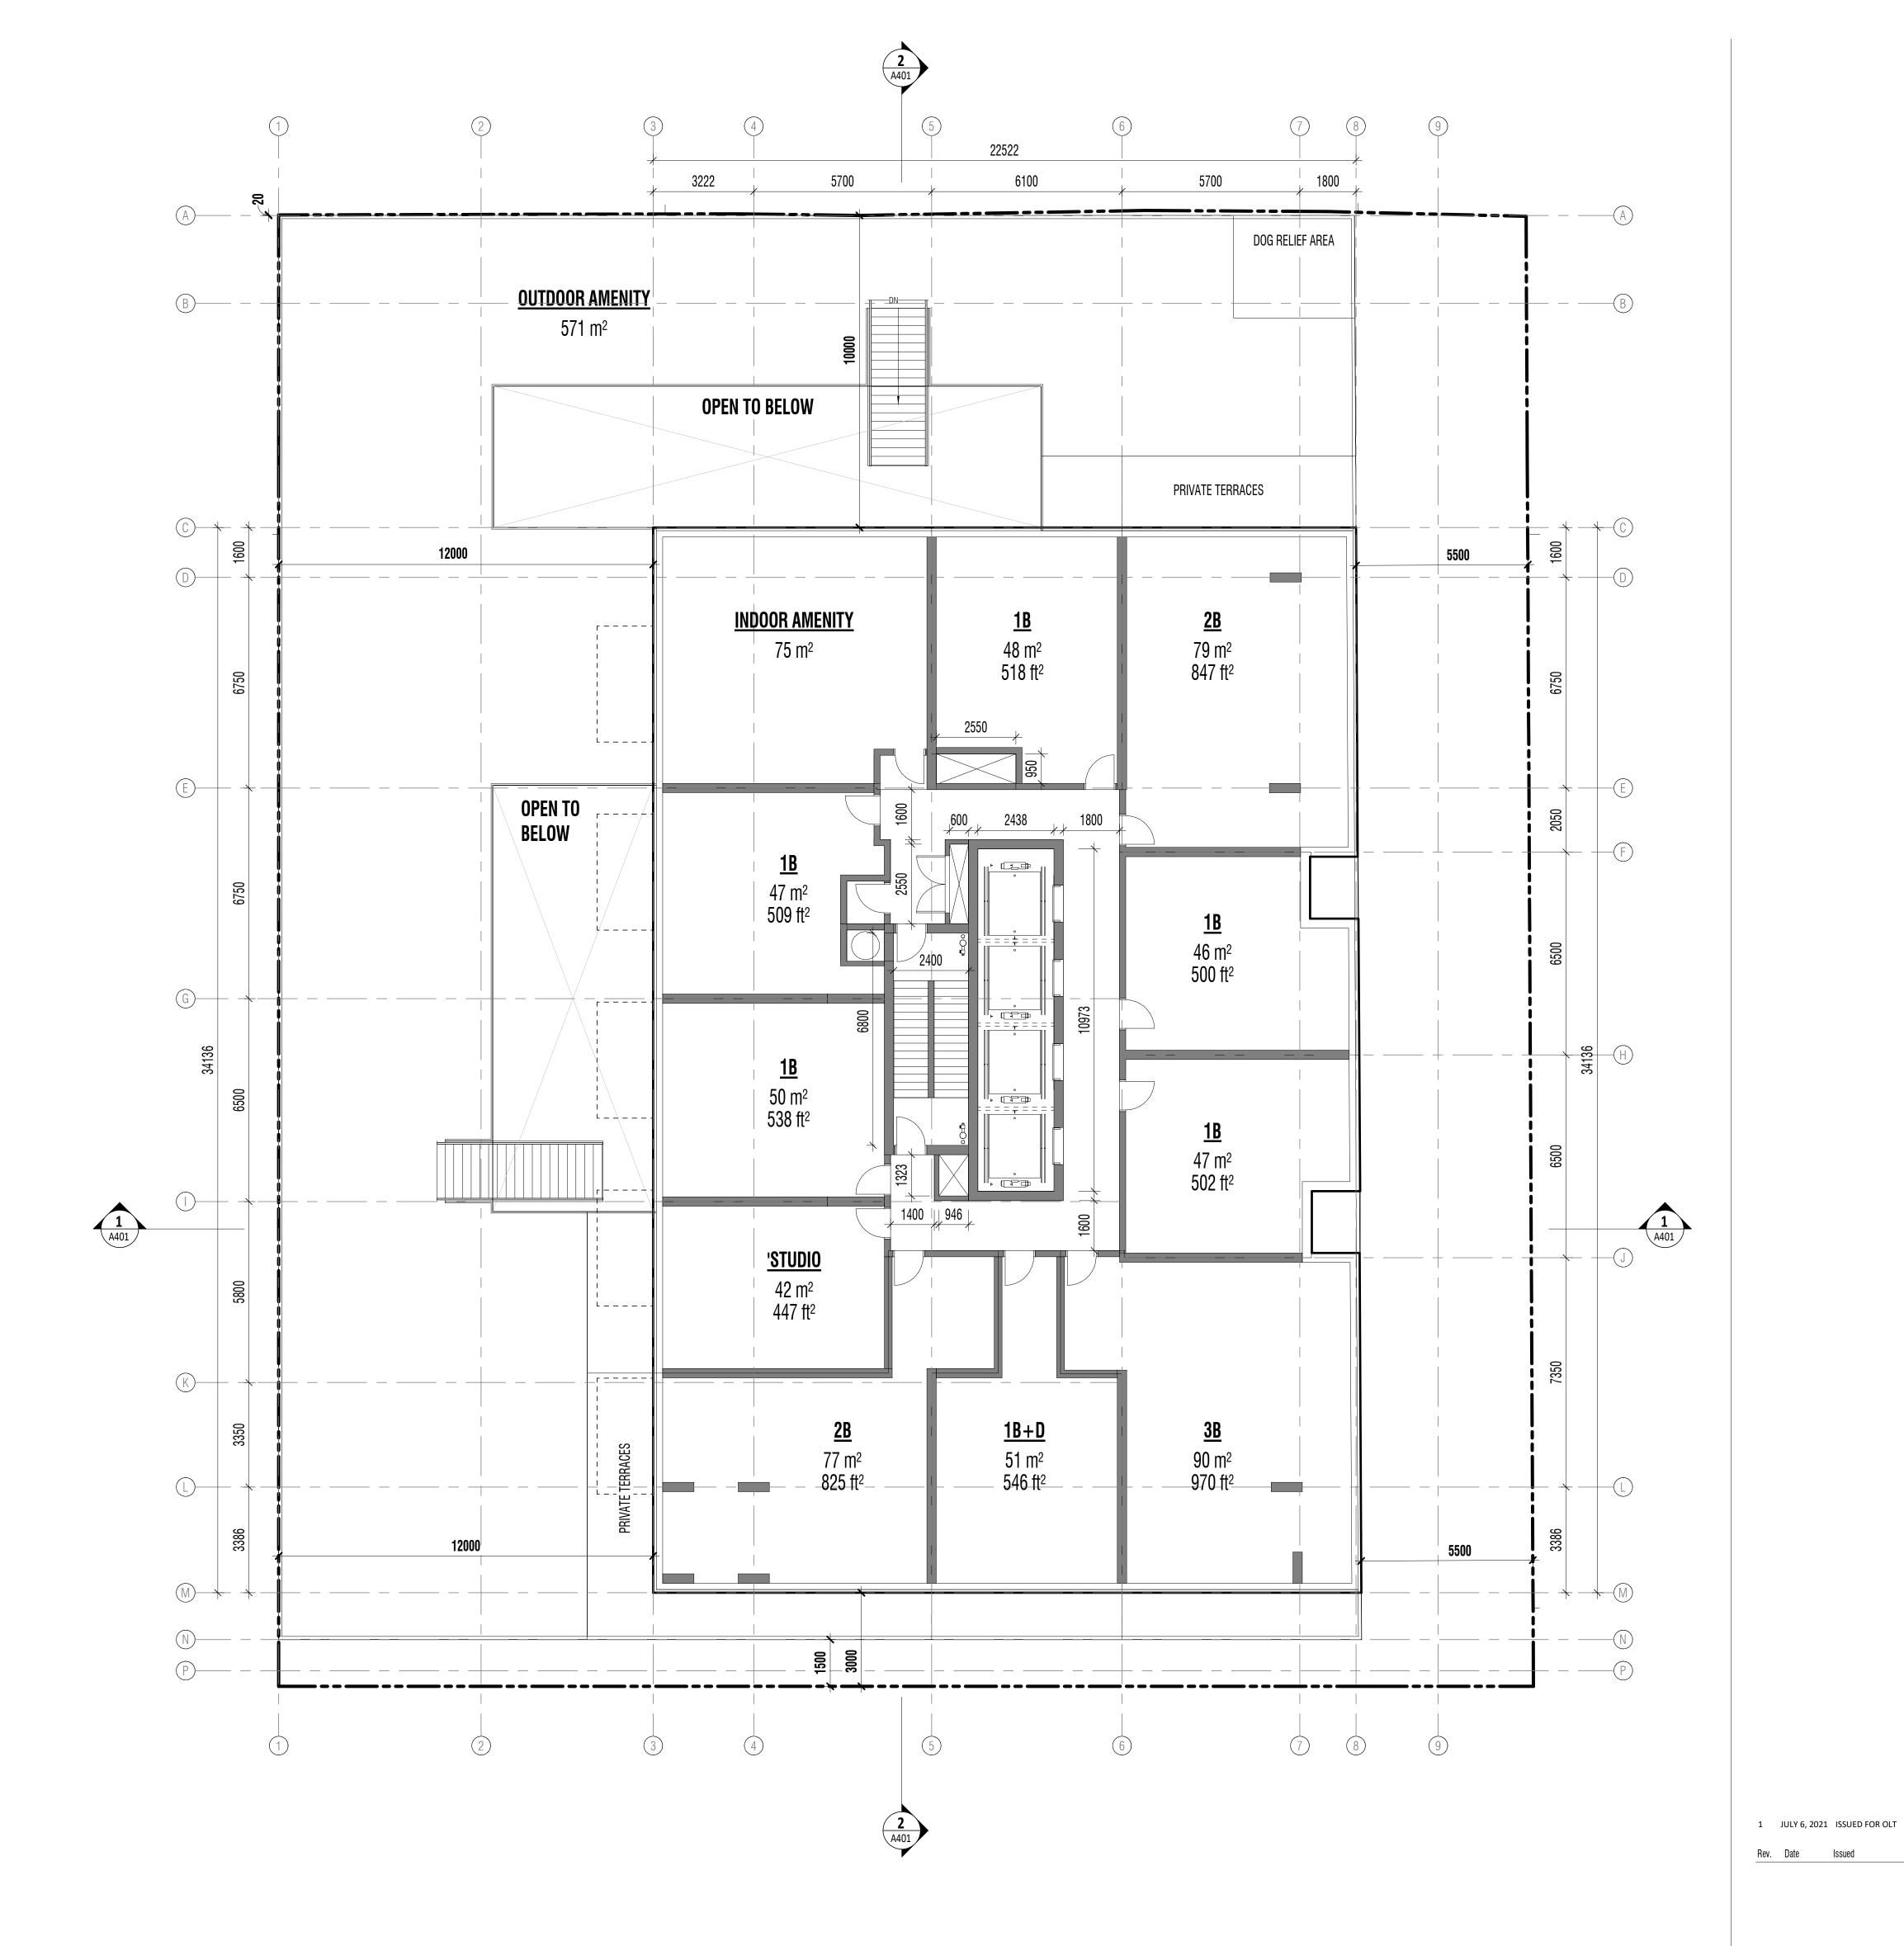
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LEVEL 2,3 FLOOR PLANS





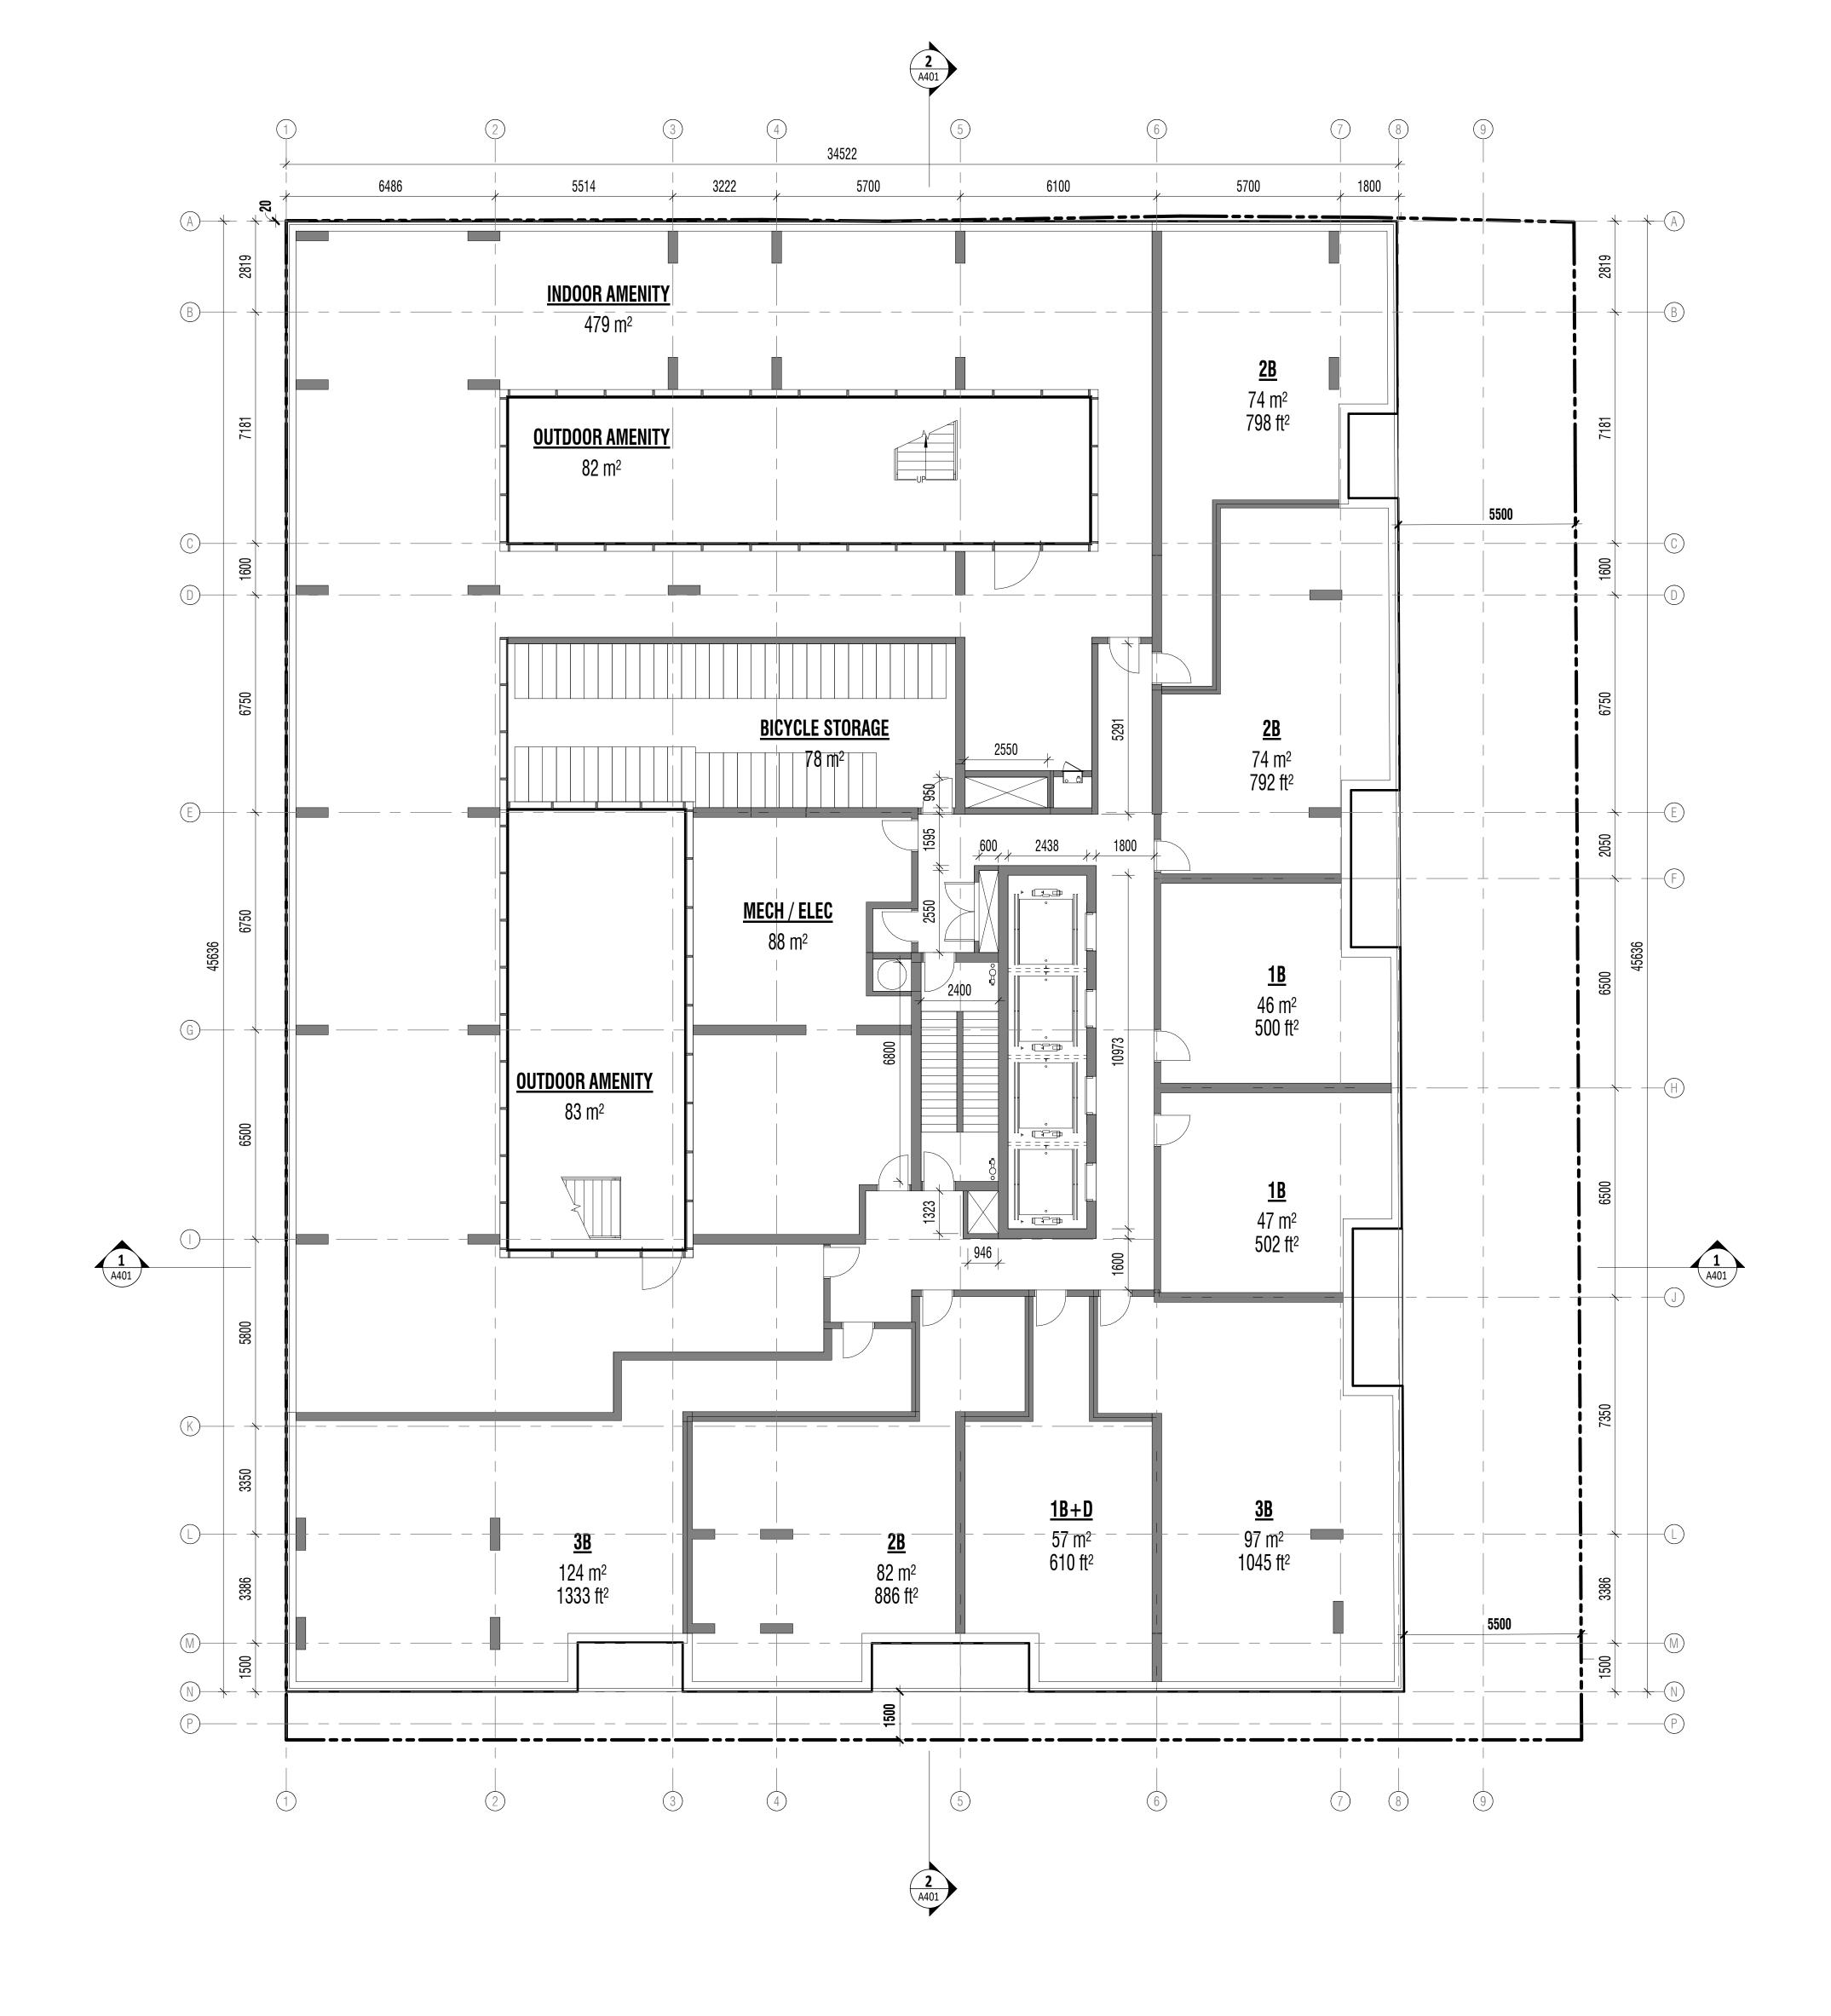

1 LEVEL 5 FLOOR PLAN
A01 A203 1:100

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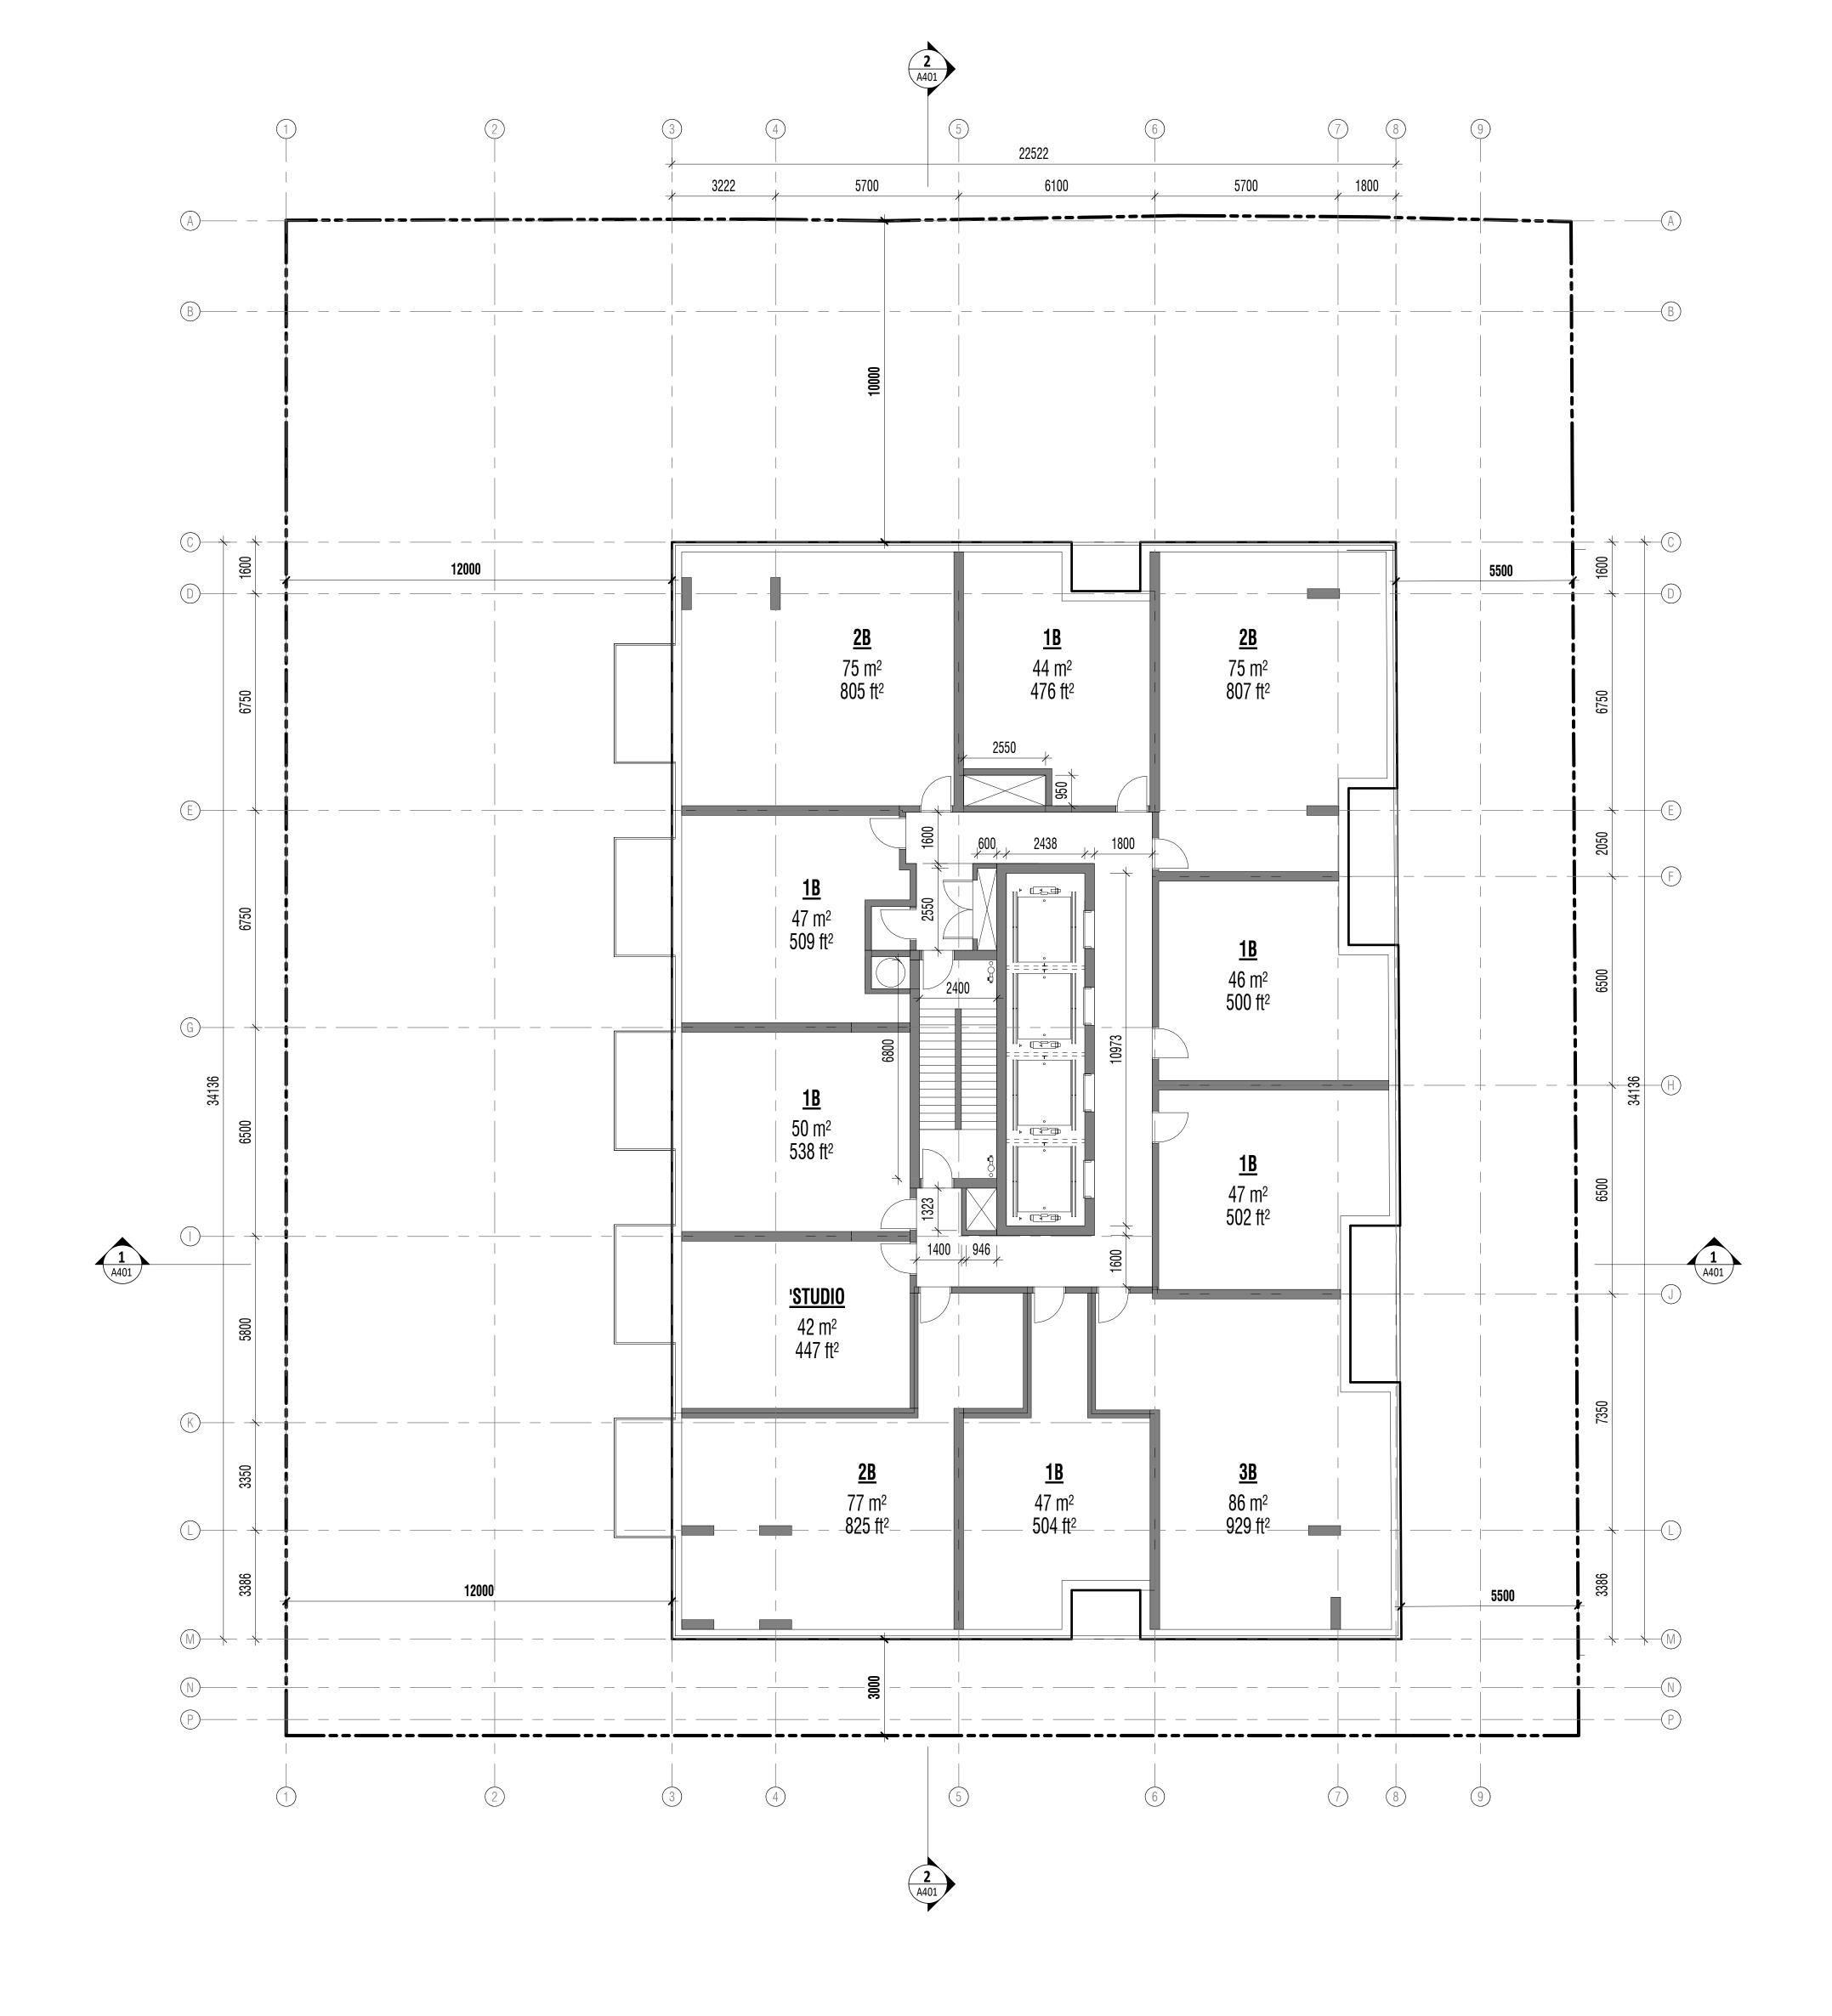
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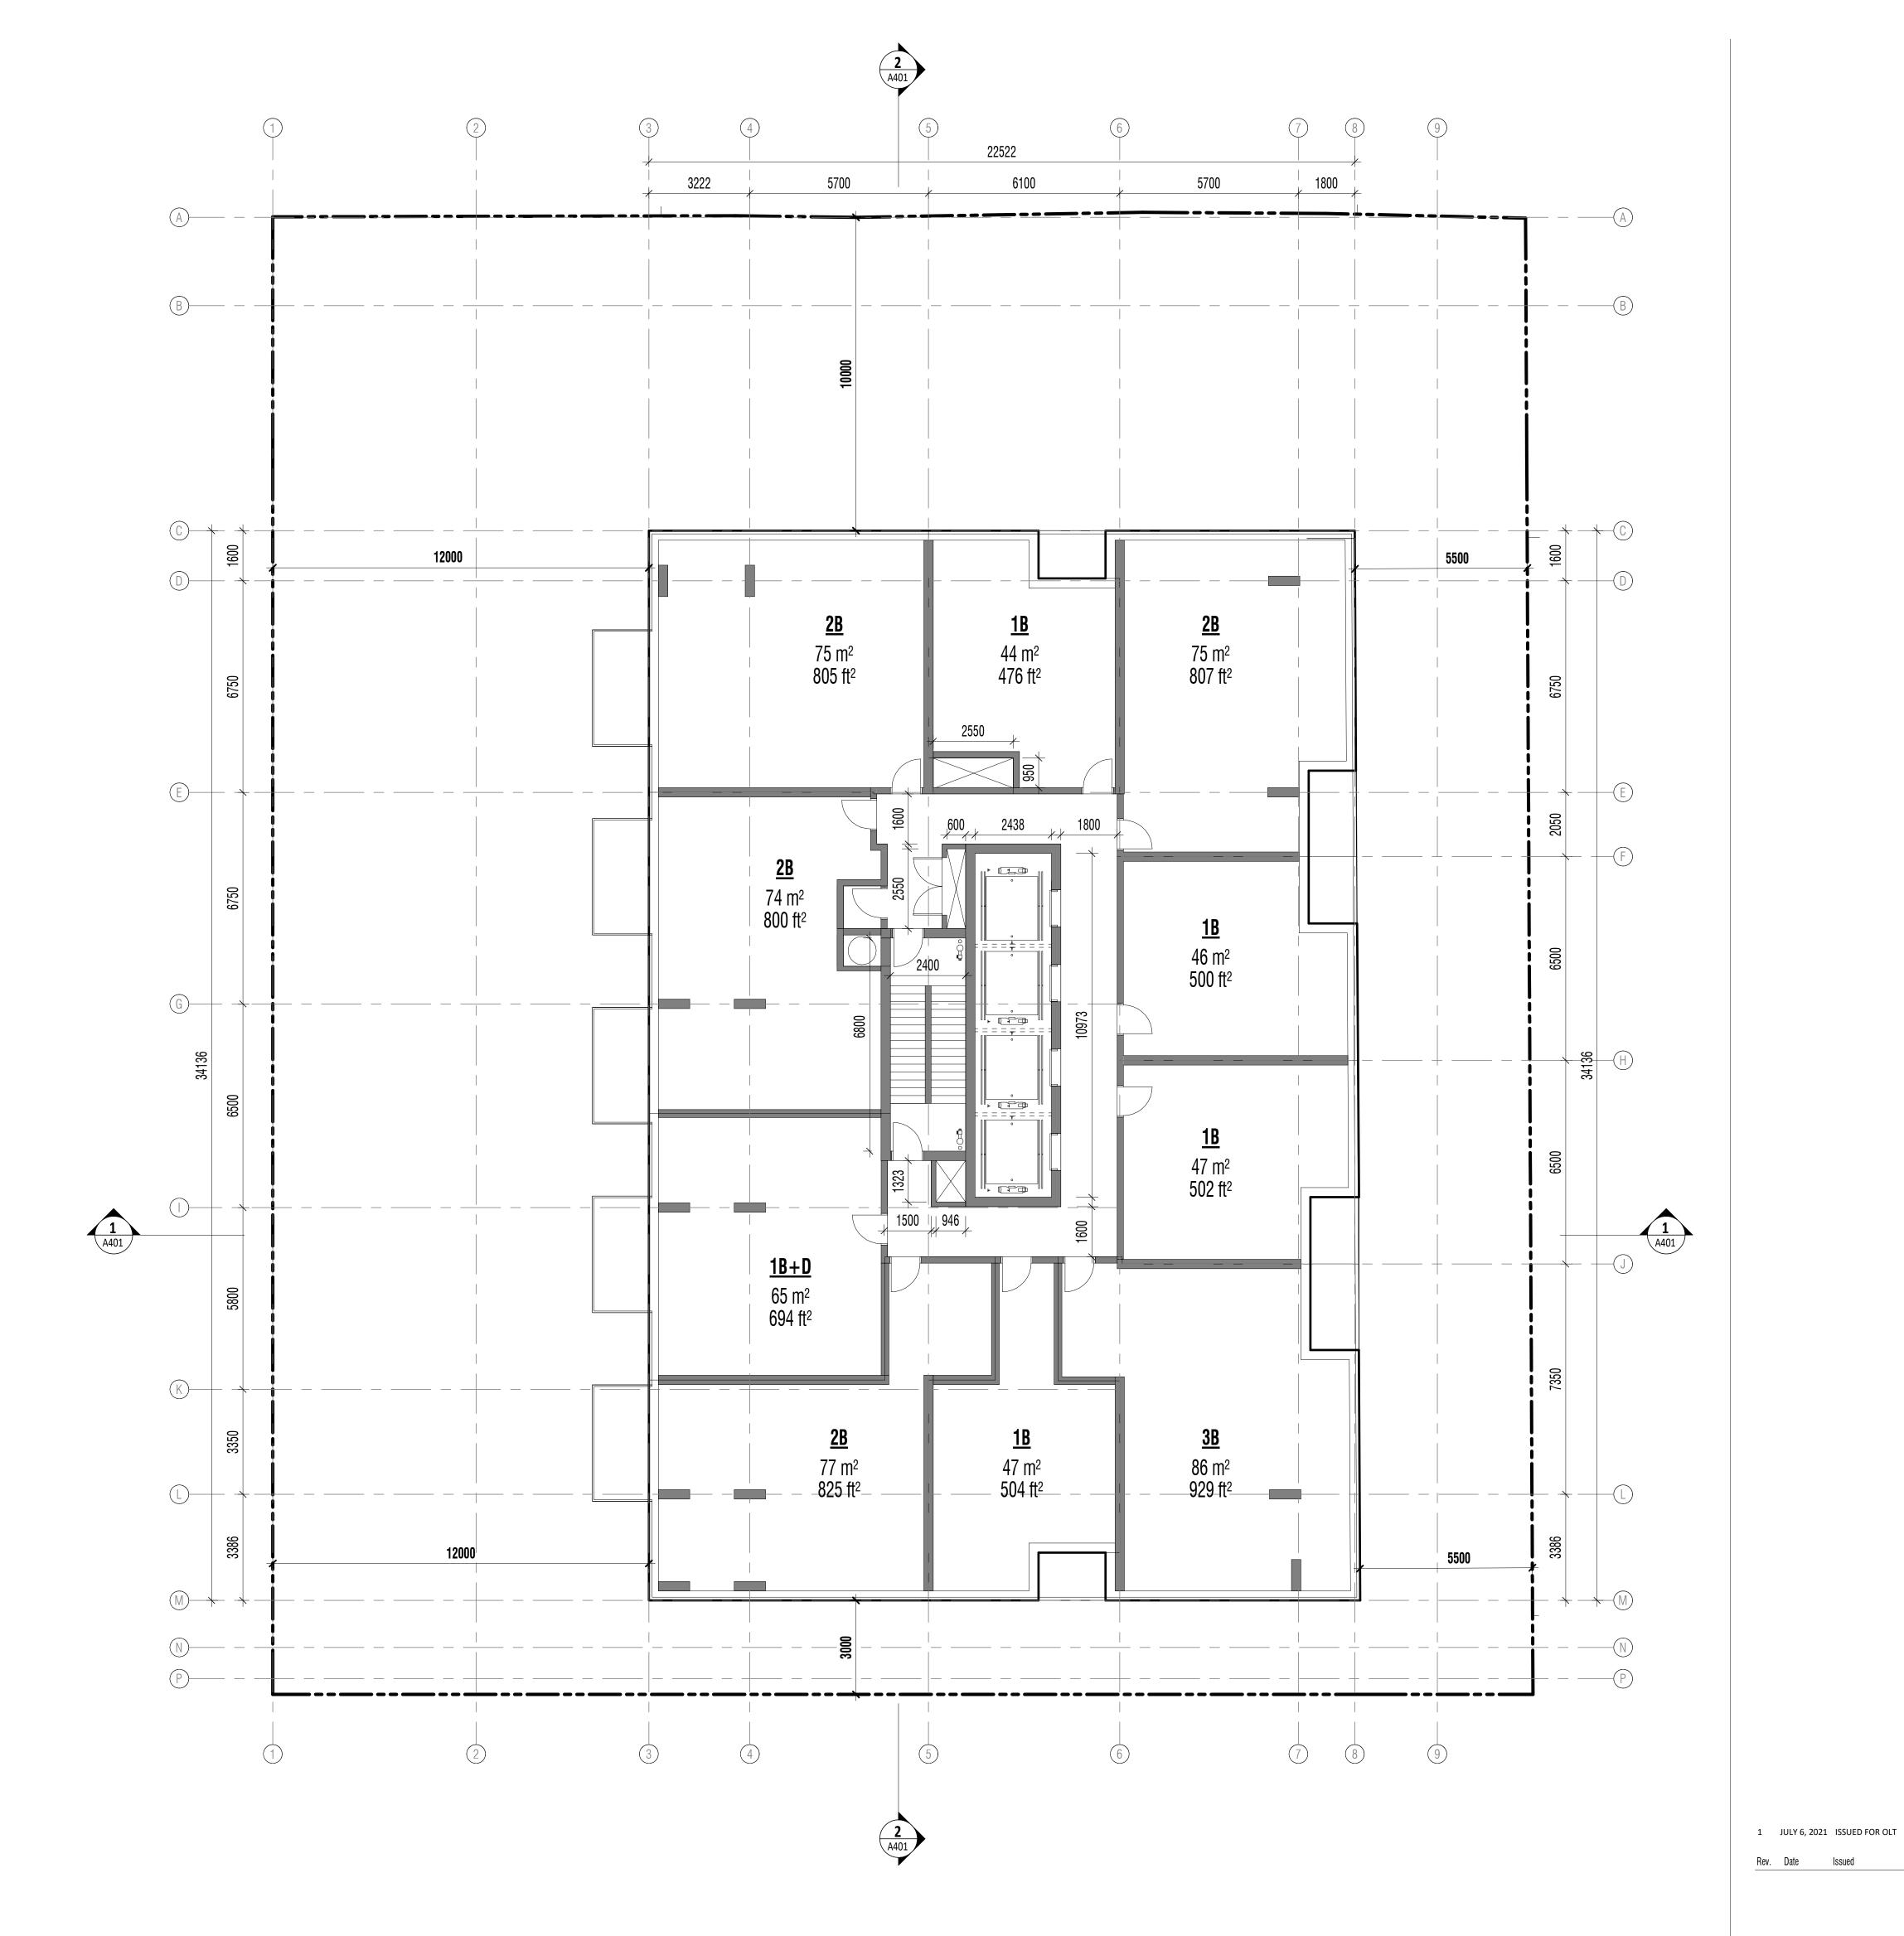
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LEVEL 4,5 FLOOR PLANS








1 LEVEL 33-37 FLOOR PLAN

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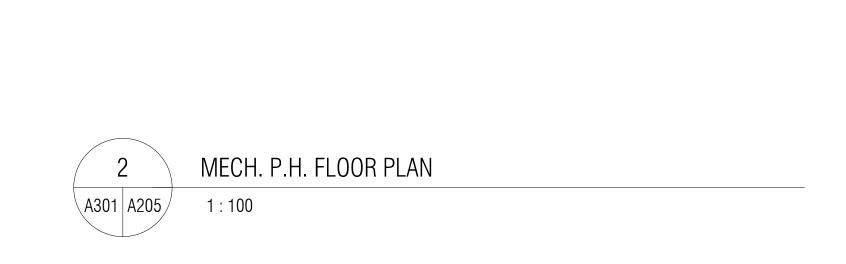
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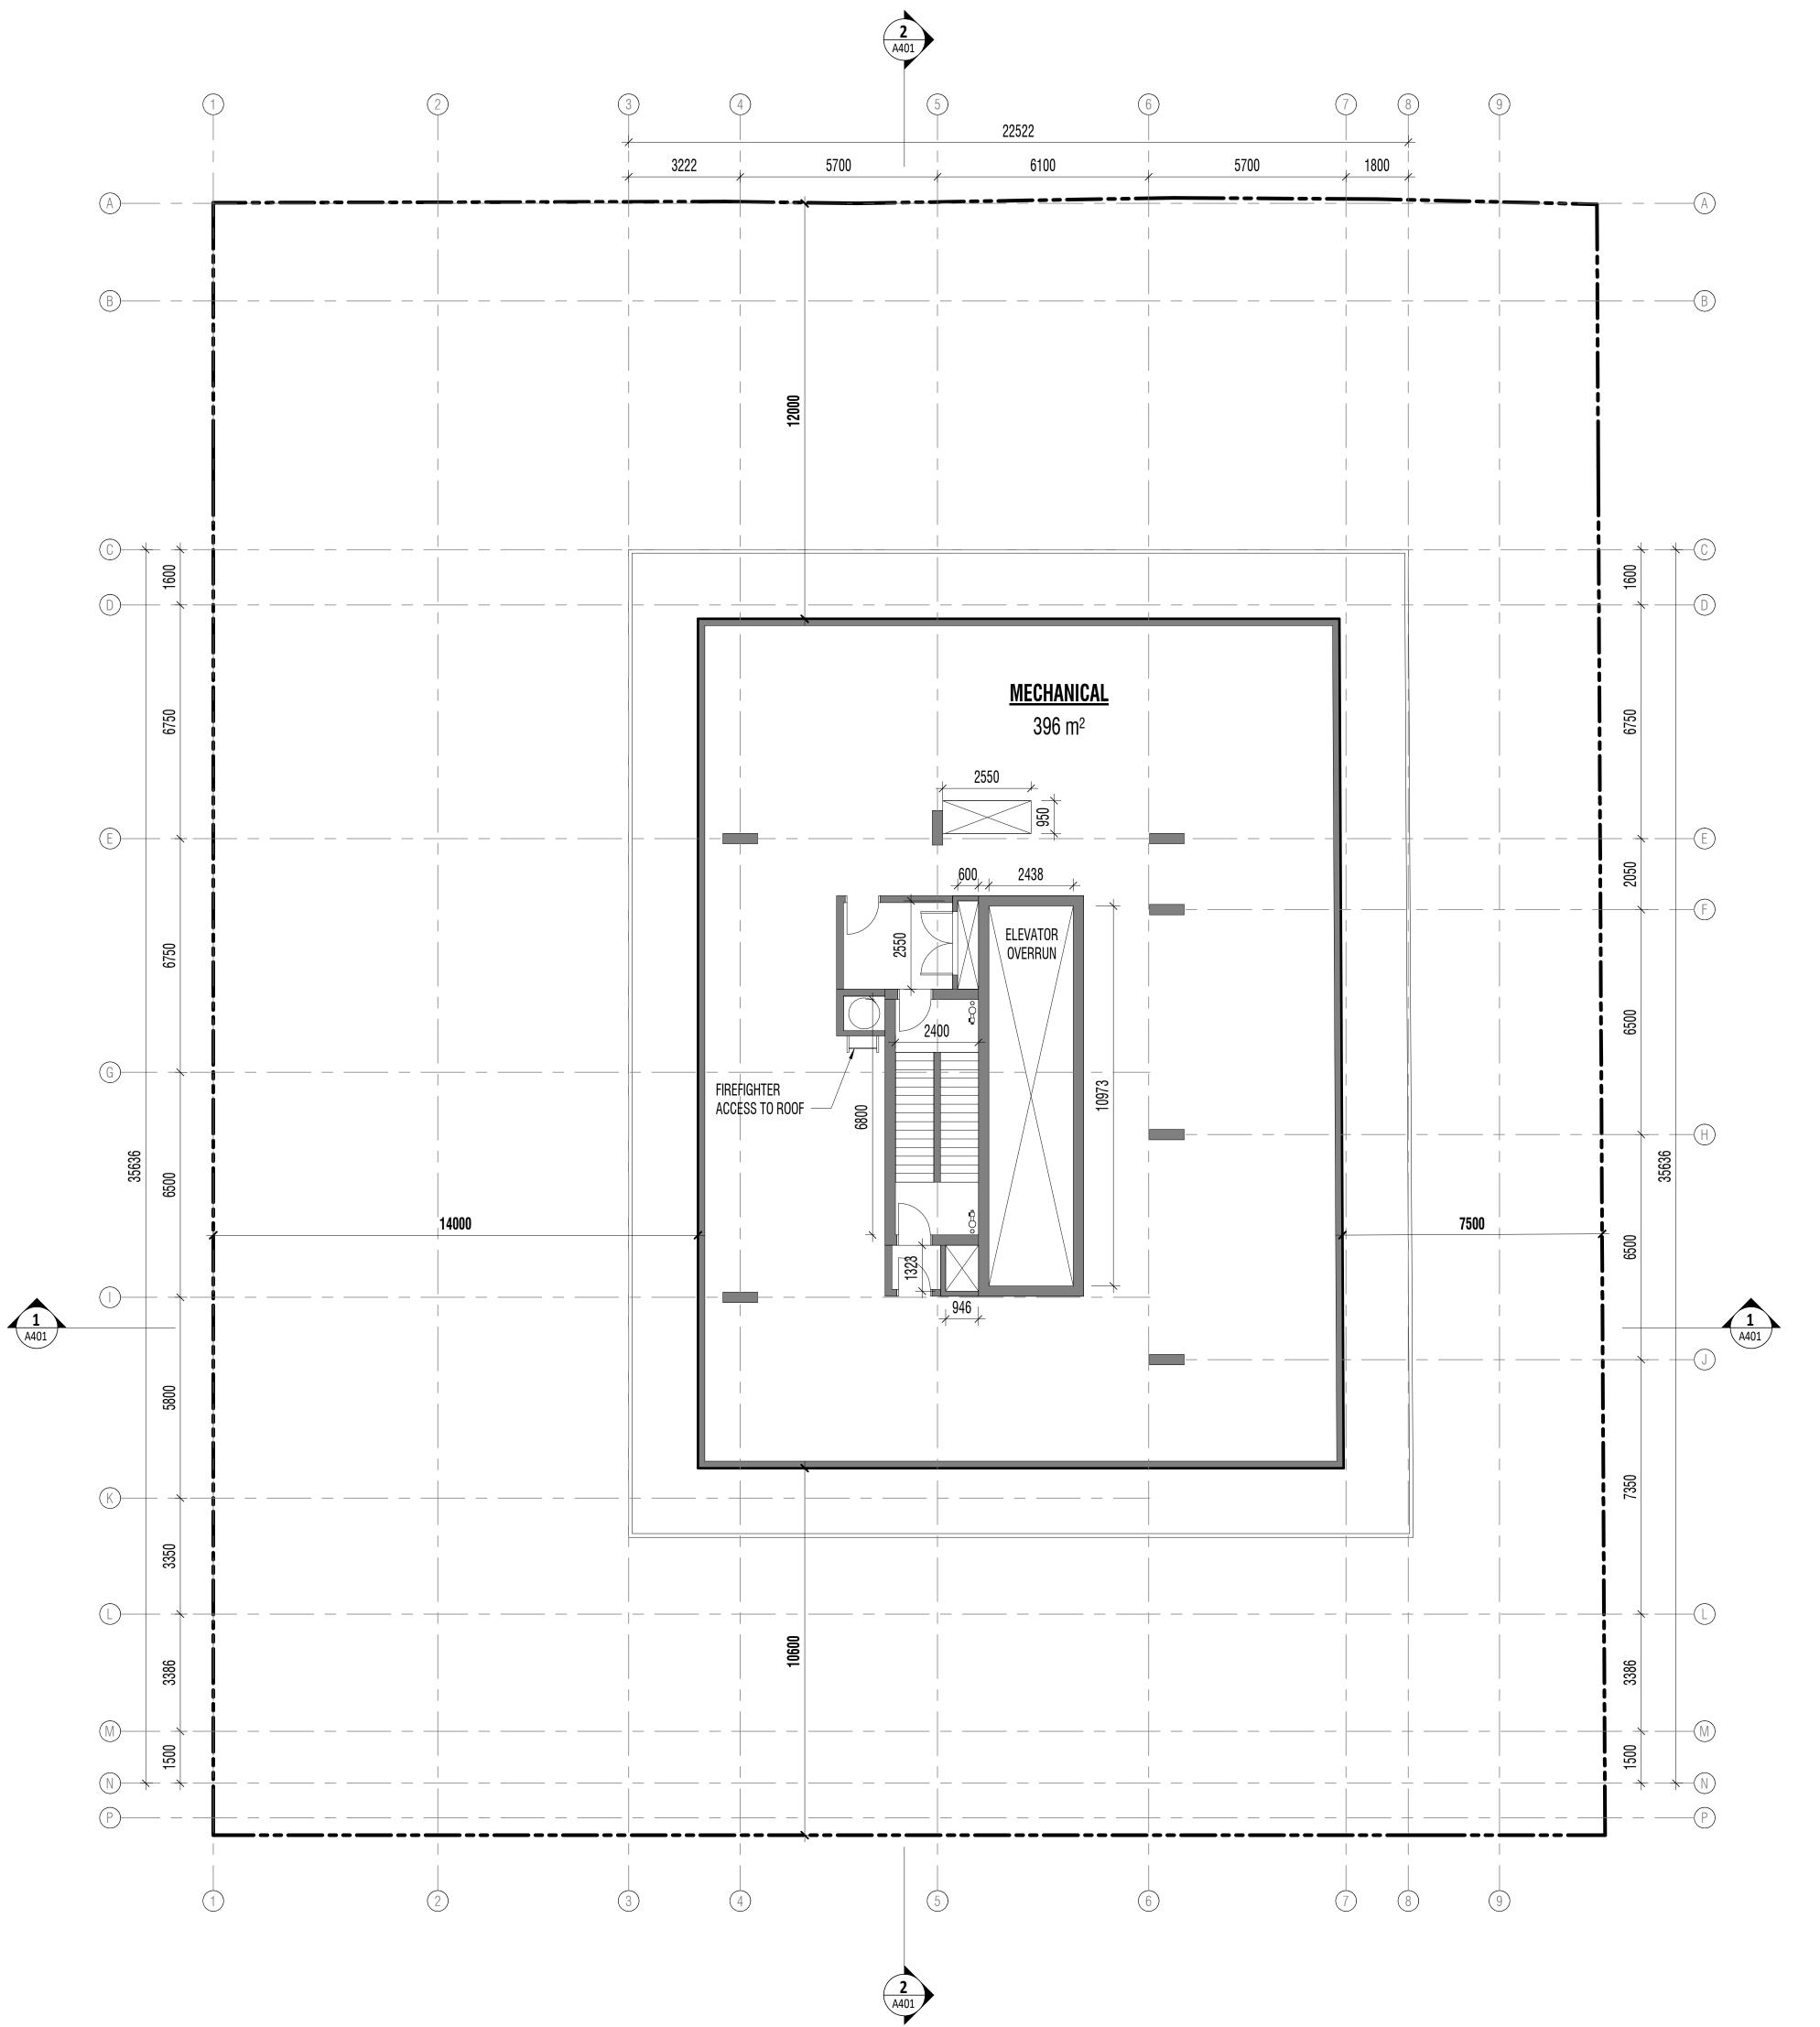
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LEVEL 6-32, 33-37 FLOOR **PLANS** A204







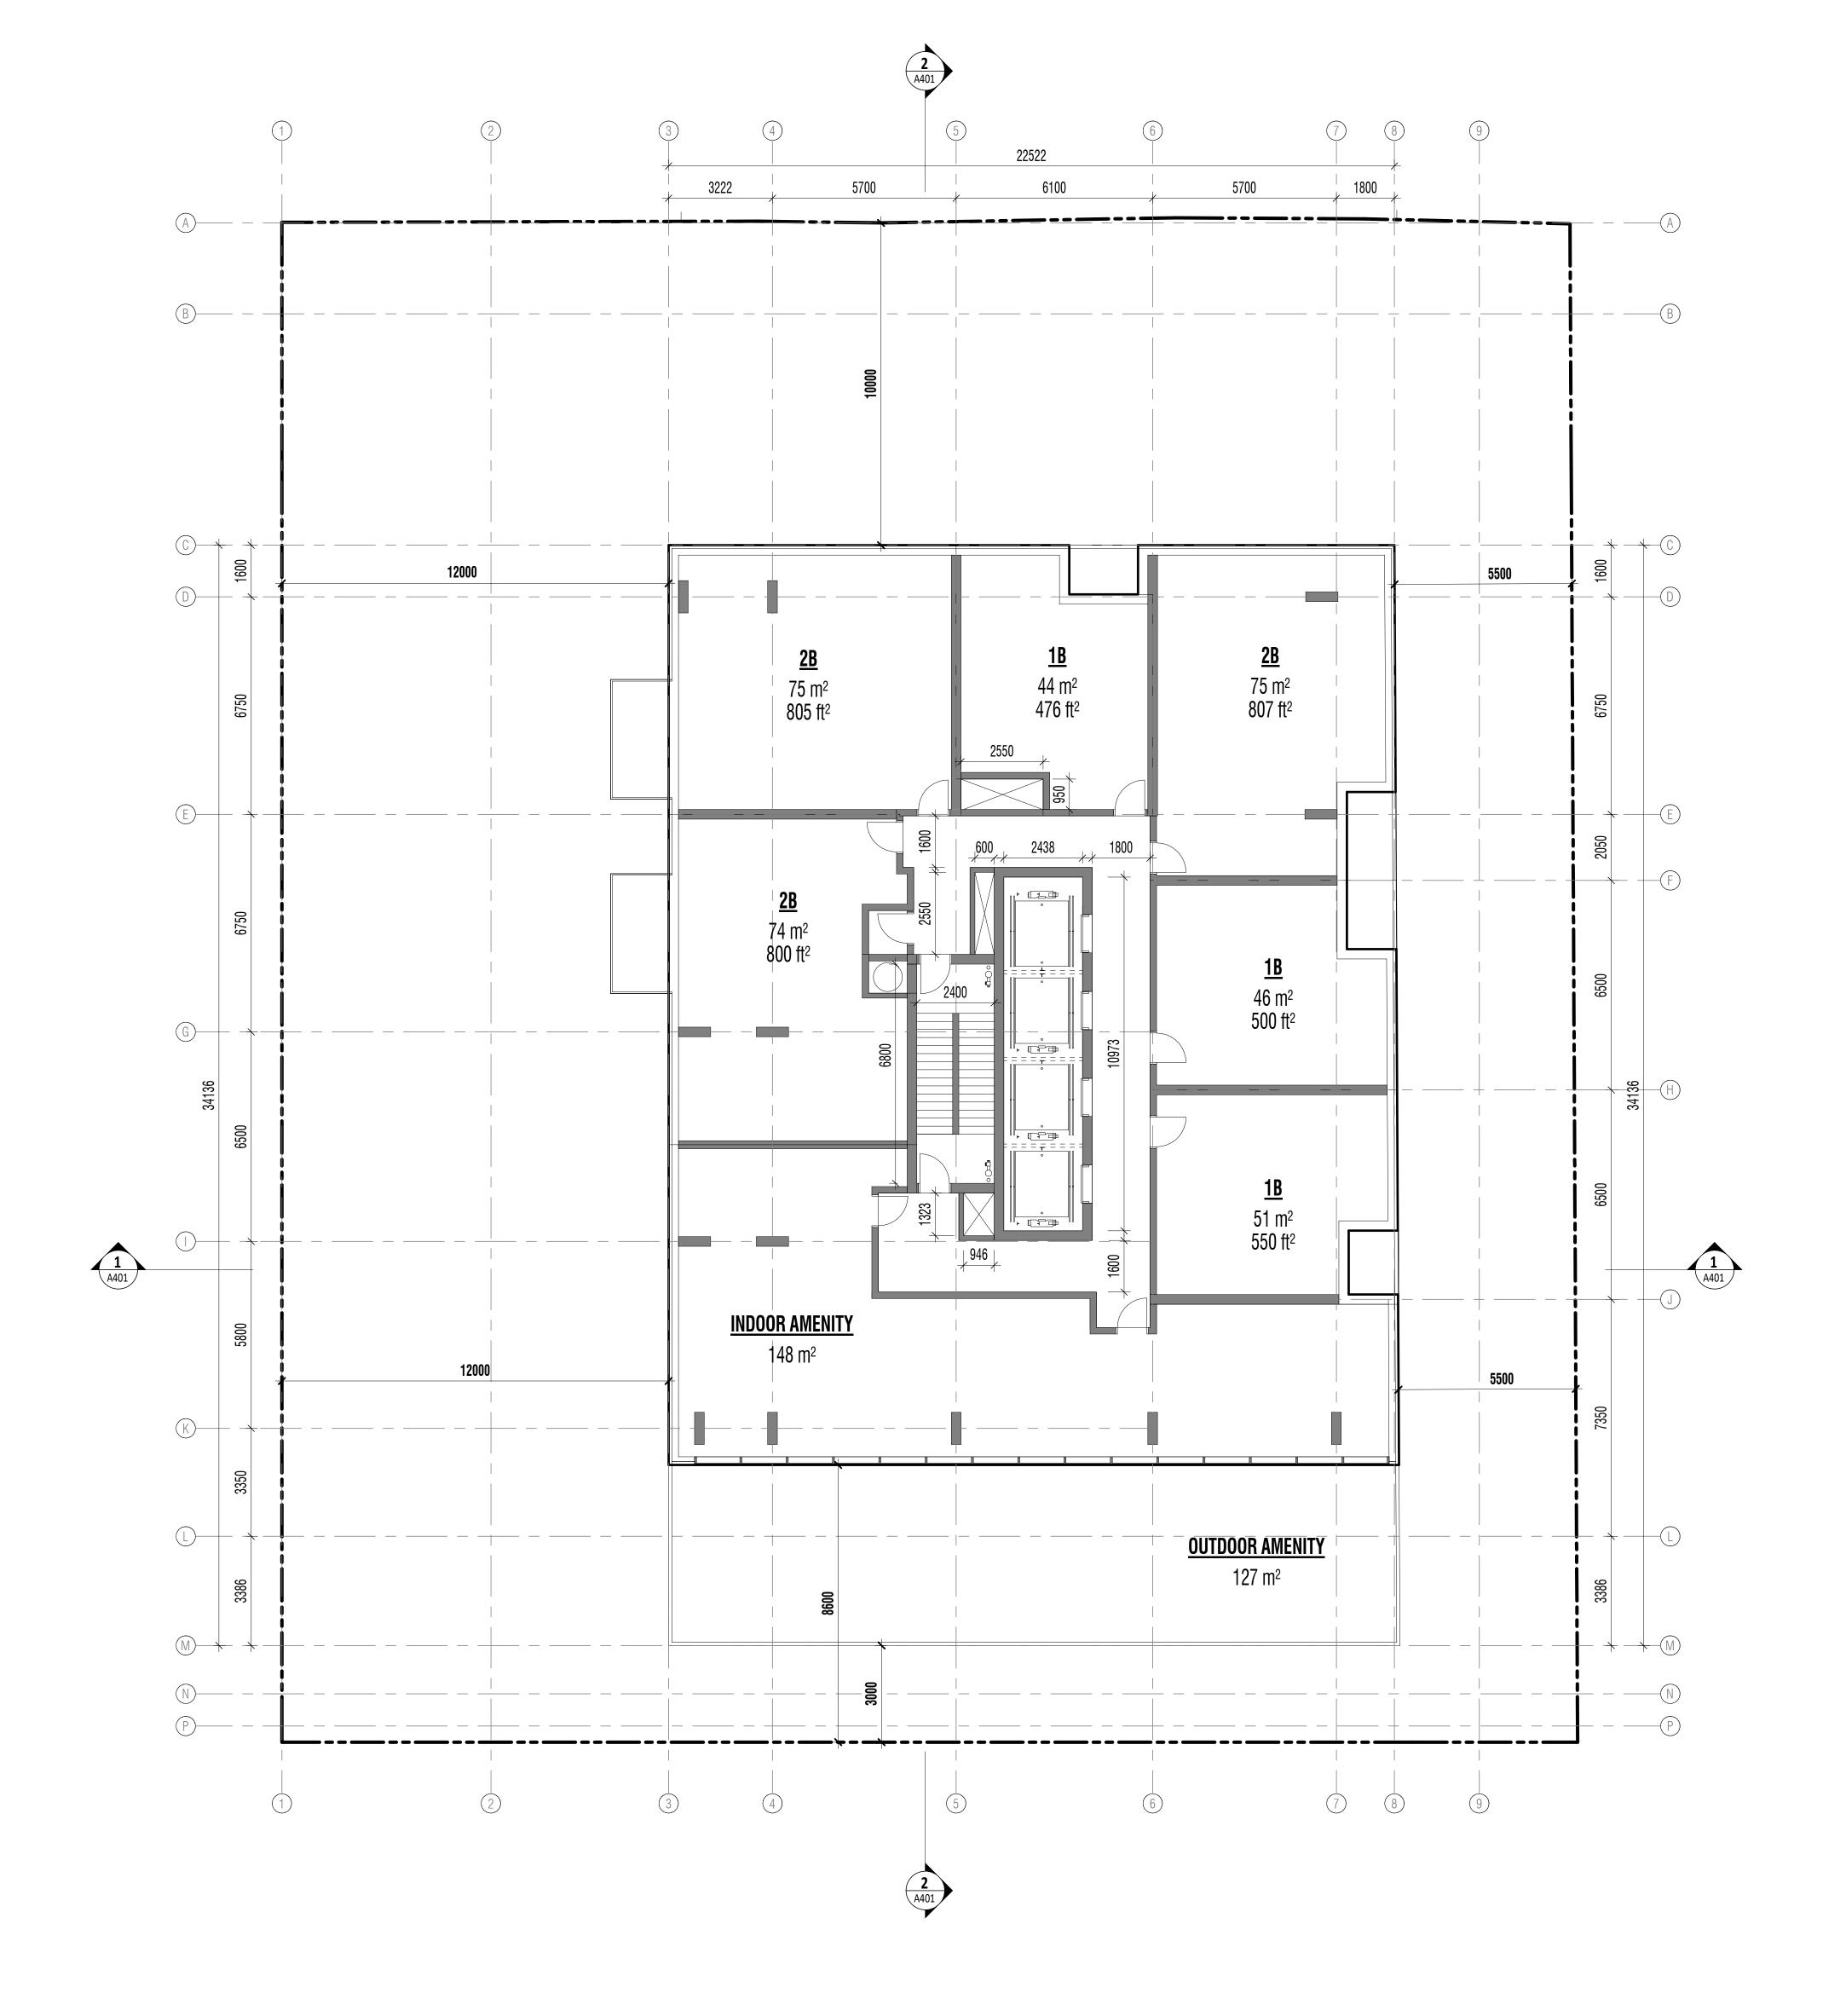

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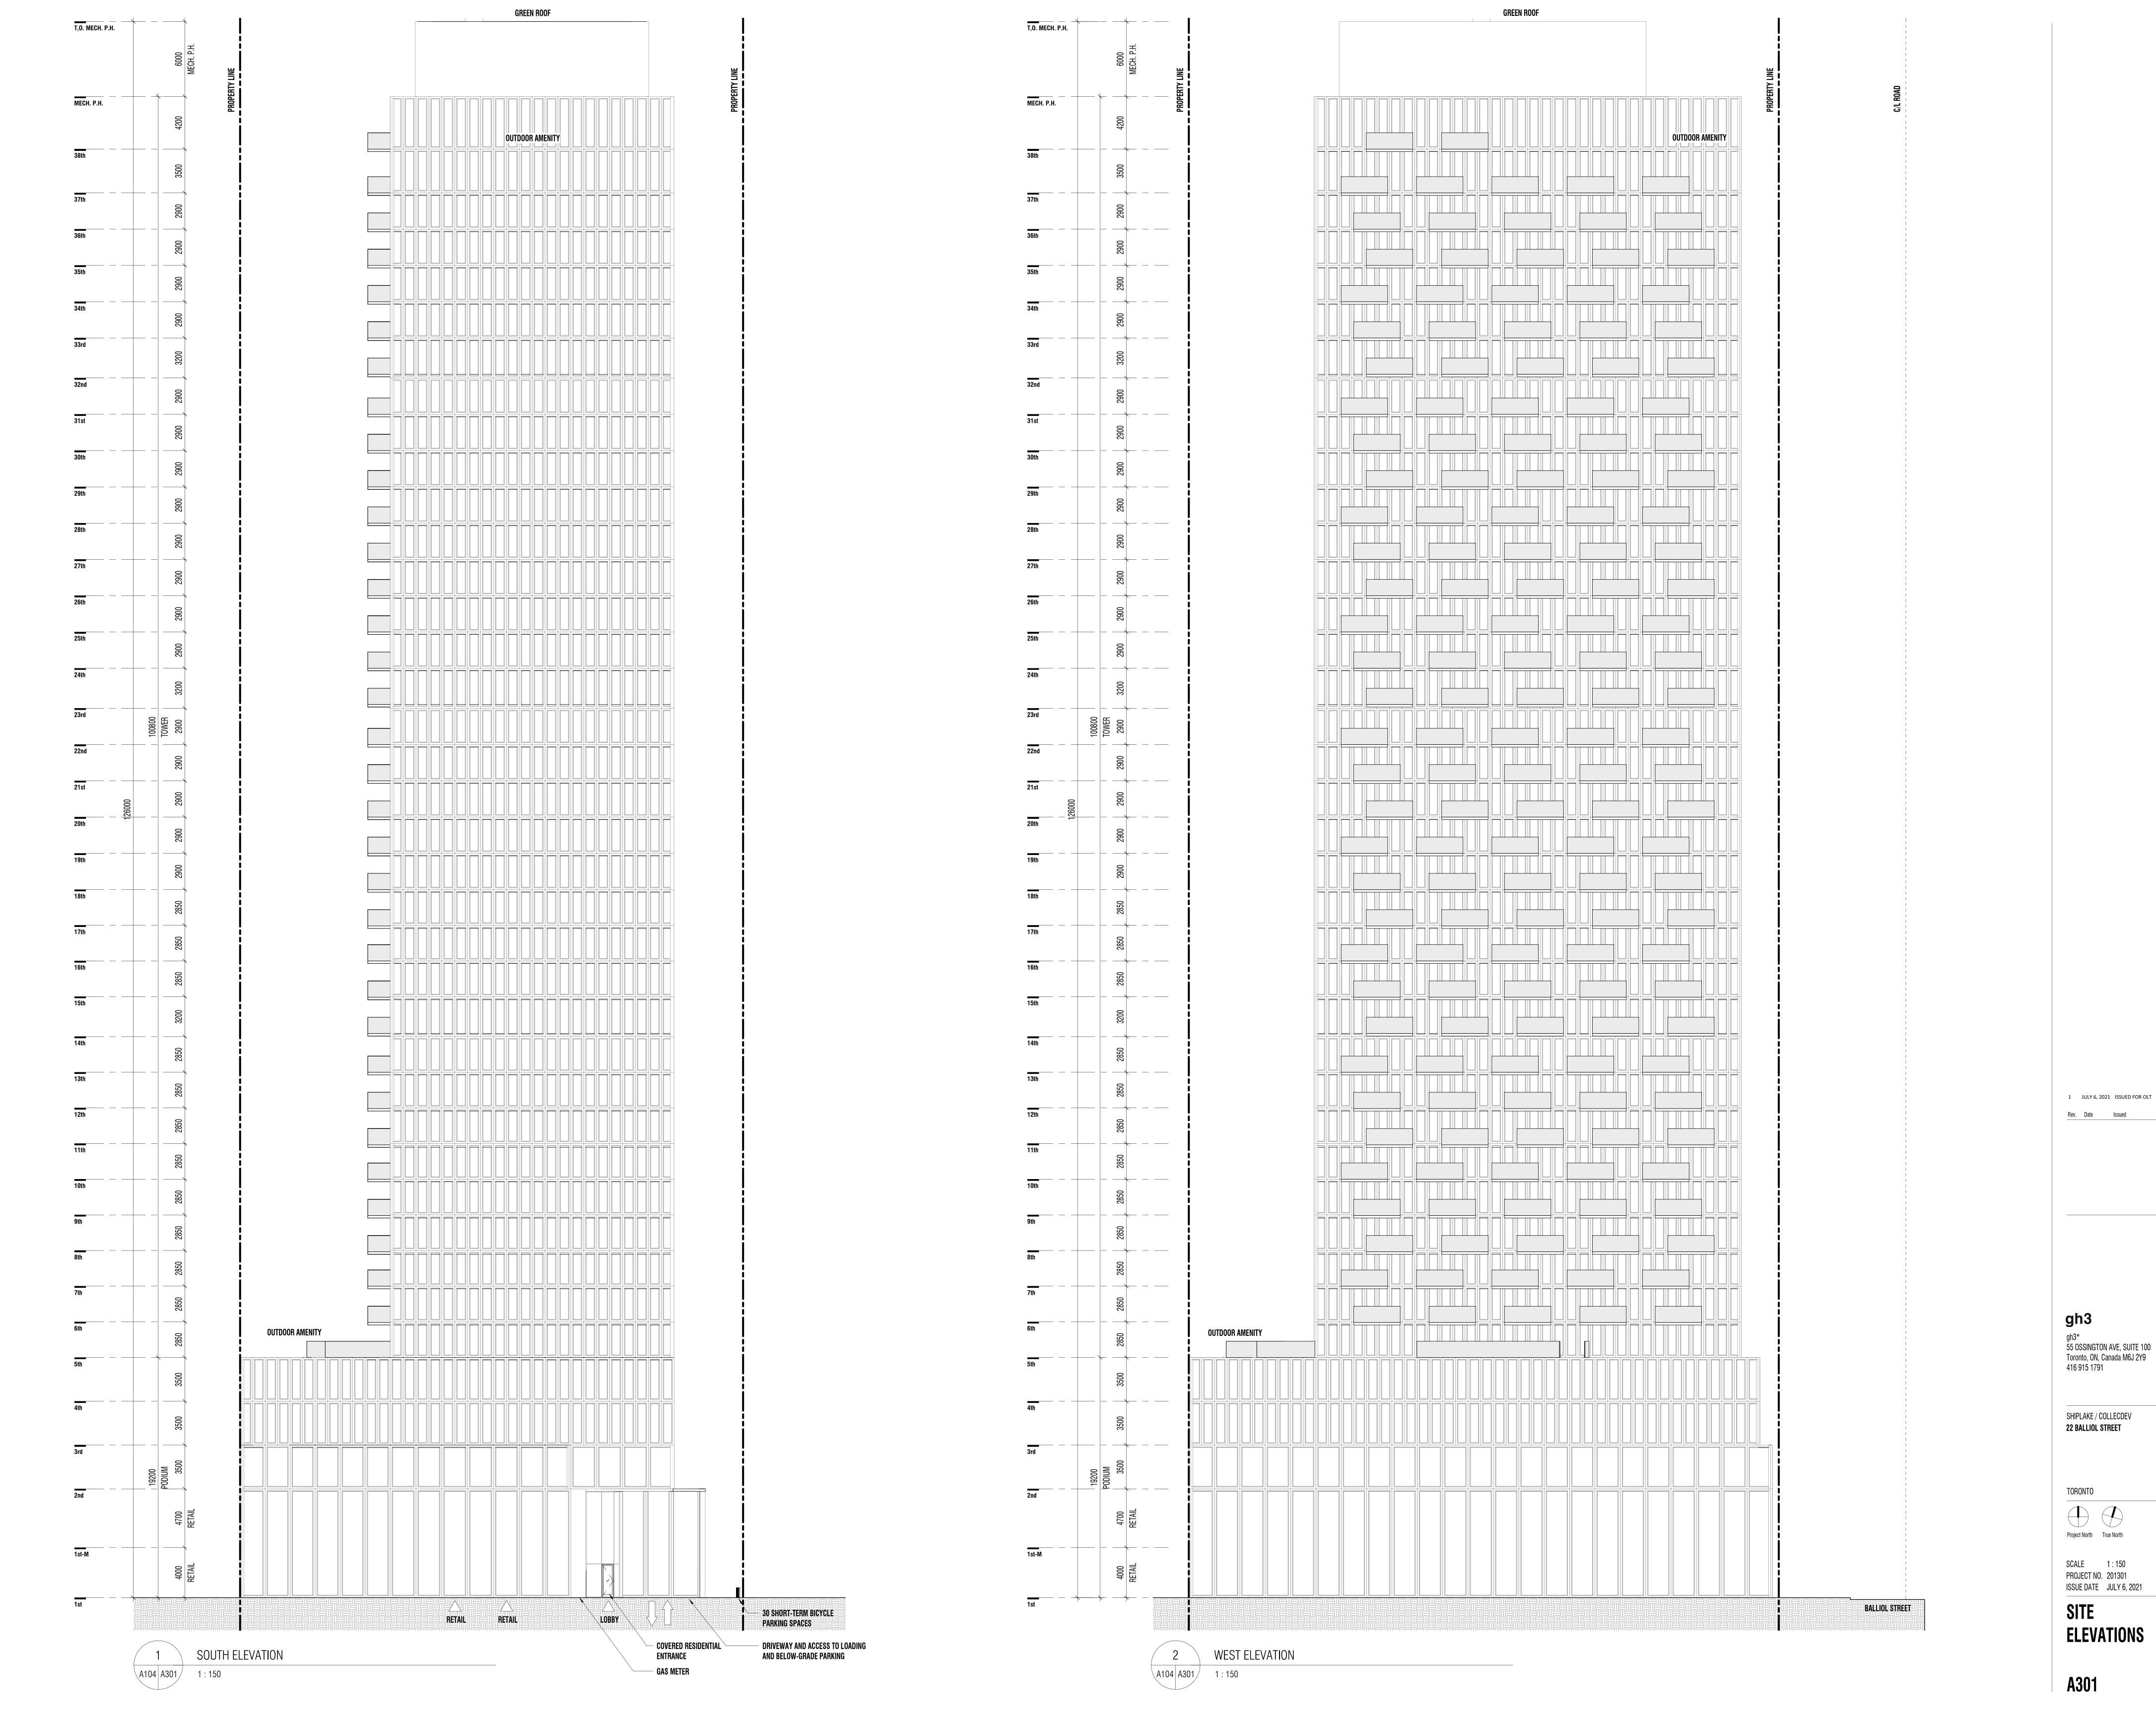
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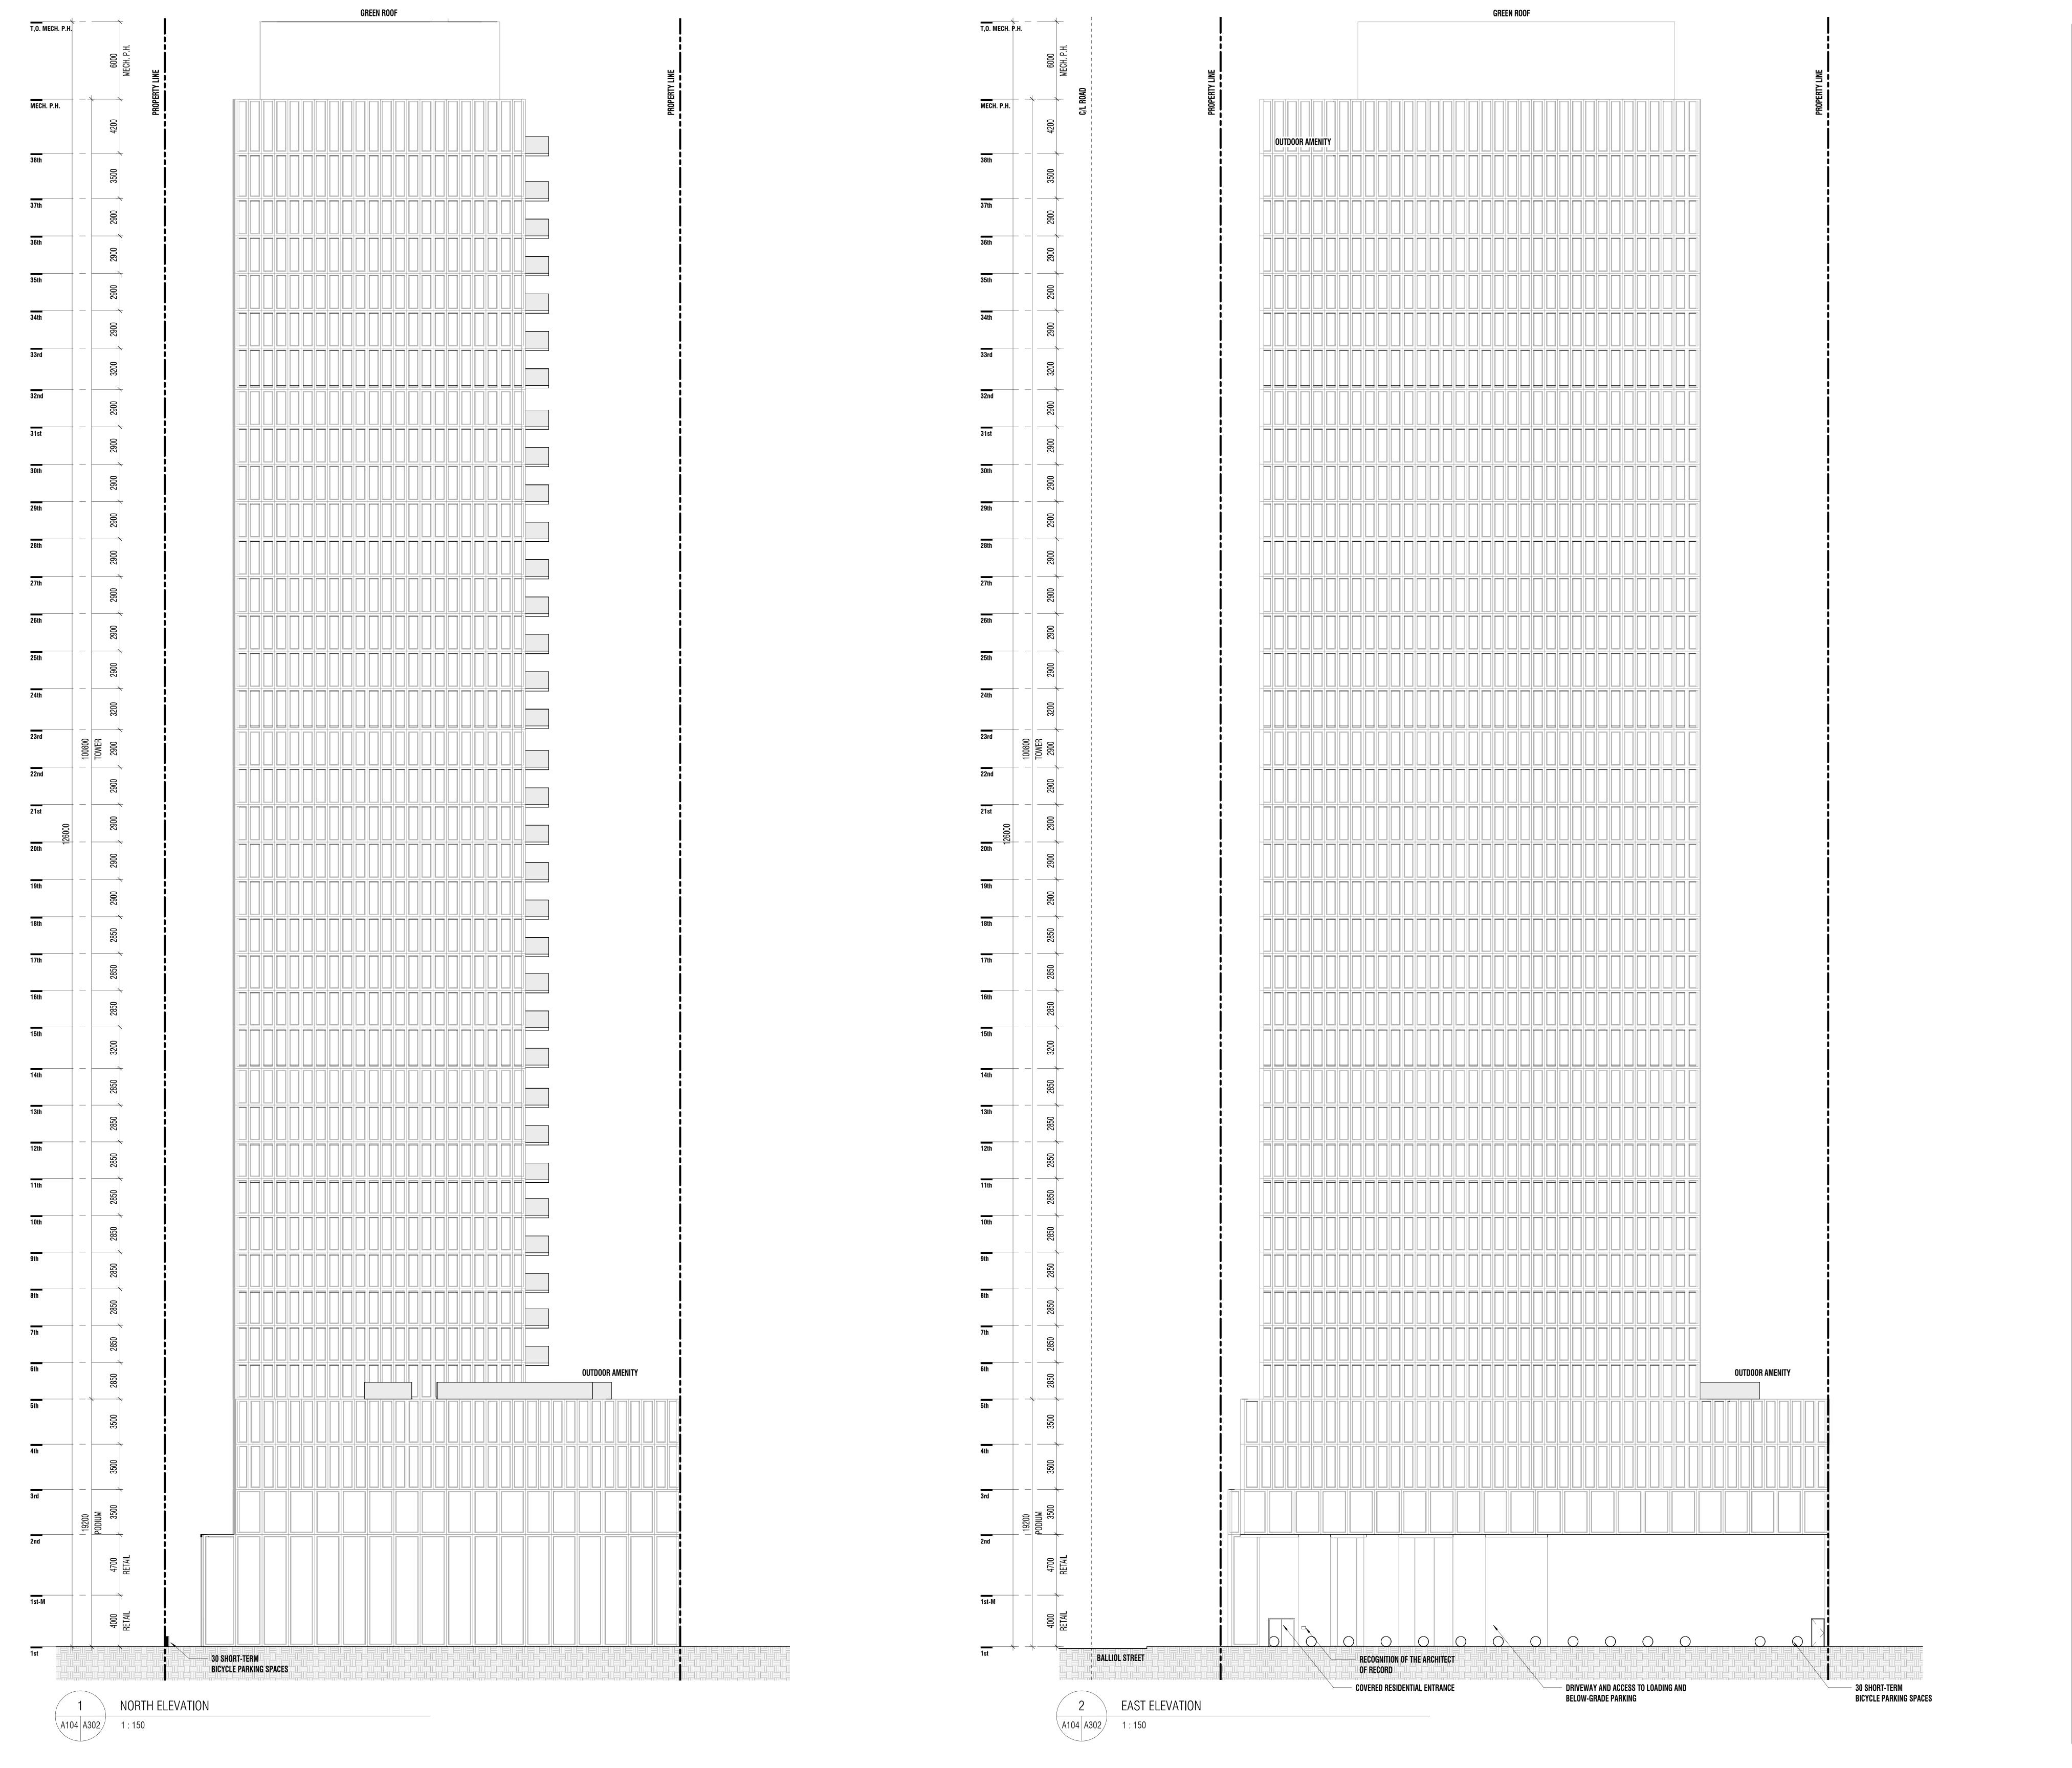
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LEVEL 38,
MECH. P.H.
FLOOR PLANS
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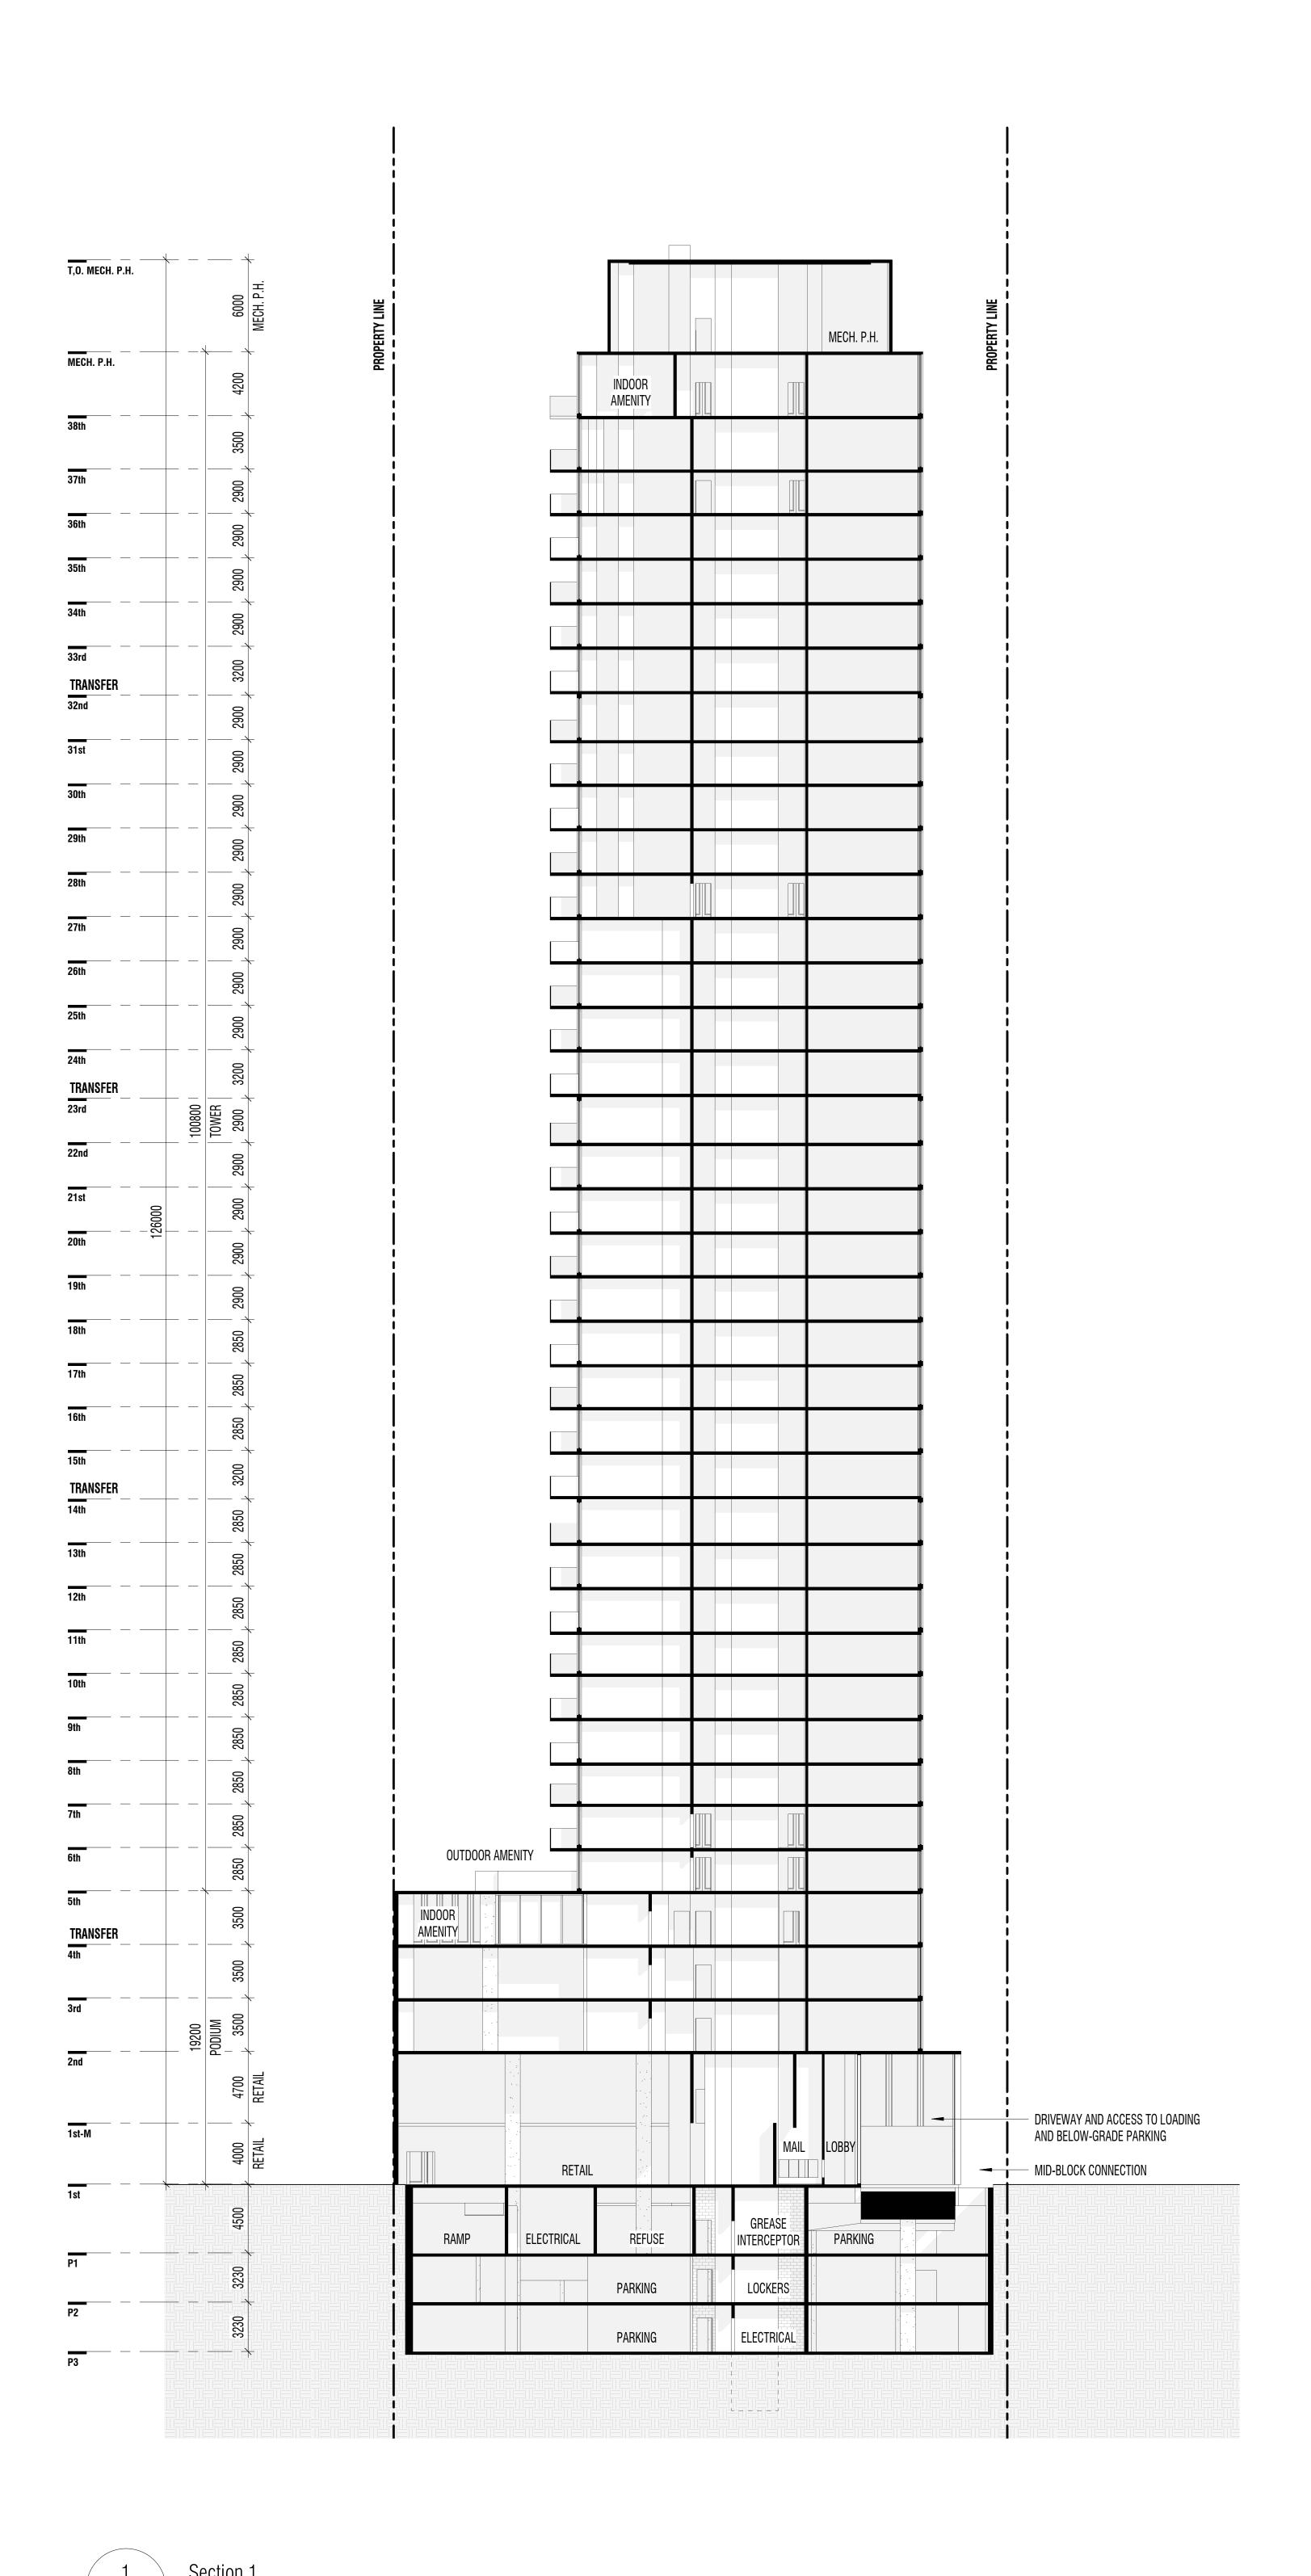
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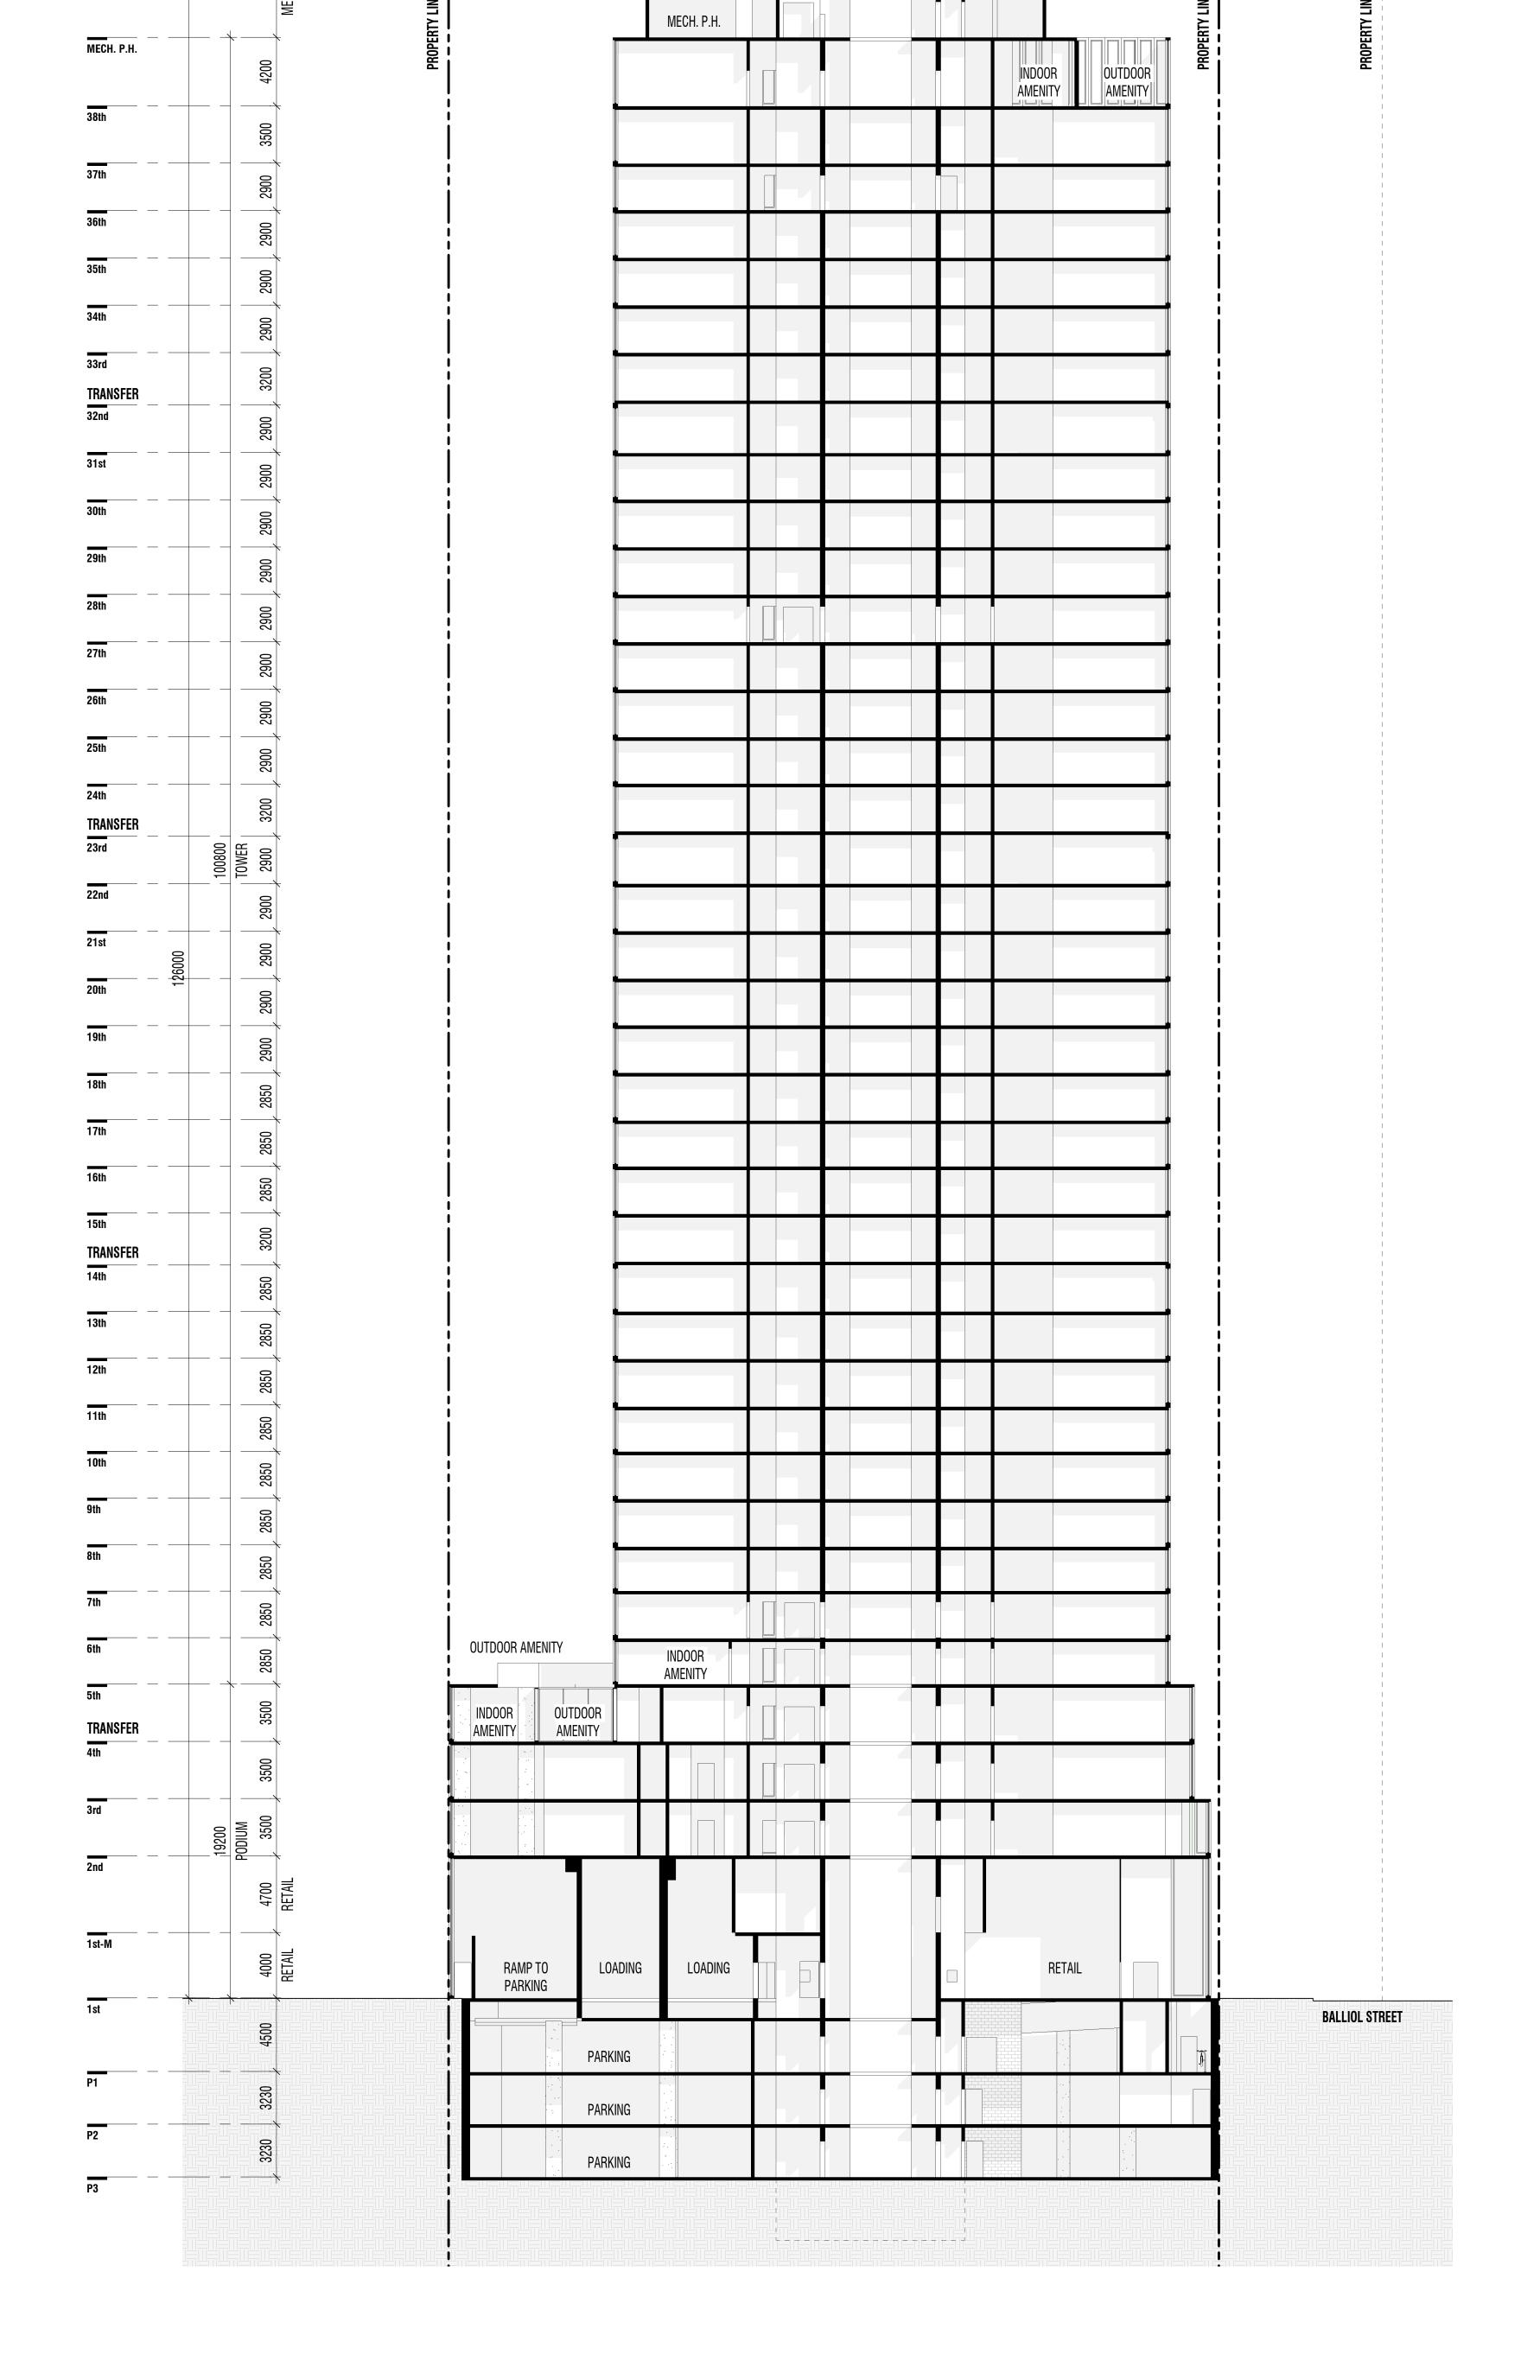
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SCALE 1:150 PROJECT NO. 201301 ISSUE DATE JULY 6, 2021

SITE ELEVATIONS





2 Section 2 A105 A401 1 : 200

T,O. MECH. P.H.

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Rev. Date Issued

gh3

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SHIPLAKE / COLLECDEV
22 BALLIOL STREET

TORONTO

SCALE 1:200
PROJECT NO. 201301
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SITE SECTIONS