**APPENDIX IV** 

Landscape Plan





#### TREE PLANTING NOTE:

HIGH QUALITY PLANTING SOIL TO THE FOLLOWING SPECIFICATION:

SANDY LOAM SOIL MIXTURE WITH A PH OF 7.5 OR LESS TO BE COMPRISED OF:

50 - 60% SAND 20 - 40% SILT

6 - 10% CLAY 2 - 5% ORGANIC MATTER

#### GRADING NOTE:

SEE ENGINEERING DRAWINGS FOR ALL GRADING INFORMATION AND ARCHITECT DRAWINGS FOR ALL WALL ELEVATIONS.

#### WATERING PROGRAM:

SEE MAINTENANCE SECTION IN SPECIFICATIONS ON SHEET D-I, WHICH CALLS FOR CONTRACTOR TO WATER FOR 4 GROWING MONTHS. THEN OWNER ASSUMES WATERING RESPONSIBILITY FOR THE REMAINING 20 MONTHS OF THE 2 YEAR TREE / SHRUB ESTABLISHMENT PERIOD BY PROVIDING WATERING AS REQUIRED, USING HOSE BIBS AT THE FRONT OF EACH UNIT.

#### MIGRATORY BIRD NOTE

PRIOR TO SITE DISTURBANCE THE OWNER MUST CONFIRM THAT NO MIGRATORY BIRDS ARE MAKING USE OF THE SITE FOR NESTING. THE OWNER MUST ENSURE THAT THE WORKS ARE IN CONFORMANCE WITH THE MIGRATORY BIRD CONVENTION ACT AND THAT NO MIGRATORY BIRD NEXSTS WILL BE IMPACTED BY THE PROPOSED WORK.

IRRIGATION DESIGN, SPECIFICATIONS
AND IRRIGATION WATER RE-USE
CALCULATIONS, IN PROGRESS

LANDSCAPE LIGHTING FIXTURE LAYOUT AND PHOTOMETRICS PLAN IN PROGRESS. MANUFACTURE: UNILOCK
STYLE: SERIES
SIZE: T.B.D.
PATTERN: SQUARE CUT
MINERAL ICE GREY

MANUFACTURE: UNILOCK
STYLE: UNILOCK
STYL

CONCRETE PAVING - TYPE I

FINISH: BROOM SWEPT
COLOUR: NATURAL CONCRETE
INSTRUCTION: NO TROWELLED BOARDER,

SRI VALUE: 29 MIN.

# CARLTON ST. MOLEAR PL. ALLEN GARDEN PARK SITE

KEY PLAN

LEGEND

PROPERTY LINE

TREE PROTECTION HOARDING LIMITS PER ARBORIST REPORT

EXISTING DECIDUOUS TREE TO REMAIN

EXISTING TREE TO BE REMOVED (DECIDUOUS / CONIFEROUS)



PROPOSED SHRUBS, PERENNIALS & ORNAMENTAL GRASS

CONCRETE UNITE PAVER TYPE 1

CONCRETE UNITE PAVER TYPE 2


CONCRETE PAVING

─── WOODEN FENCE

BASE INFORMATION OBTAINED ELECTRONICALLY FROM DIAMOND SCHMITT ARCHITECTS (PROJECT NO. 1613 - TEL.416.862.8800)

3	AUG 22 2019	REISSUED FOR S.P.A NO.1	RS
2	JUN 14 2019	ISSUED FOR S.P.A NO.1	RS
1	JUN 7 2019	ISSUED FOR DRAFT SUBMISSION #1	RS
no.	date	version	by

All information hereon to be checked and verified at the site and any discrepancies must be reported to and clarified by the landscape architect before commencing work. All drawings, specifications, details, digital information, etc., prepared by the landscape architect are instruments of service and as such are his property and must be returned at his request.

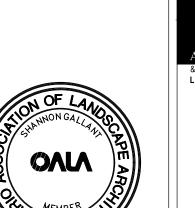

ALEXANDER BUDREVICS

& ASSOCIATES LIMITED
LANDSCAPE ARCHITECTS

895 Don Mills Road, Second Tower, Suite 212

Toronto, Ontario, Canada, M3C 1W3

416.444.5201★ 416.444.5208

www.budrevics.com


project

308-314 JARVIS STREET & 225 MUTUAL STREET TORONTO, ONTARIO

GRAYWOOD DEV.'S / ALTERRA GROUP

OVERALL


GROUND LEVEL PLAN

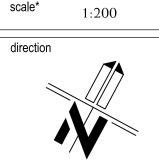

MAY 30, 2019

project no.
3298
sheet no.

file 3298 L1 V3-190822

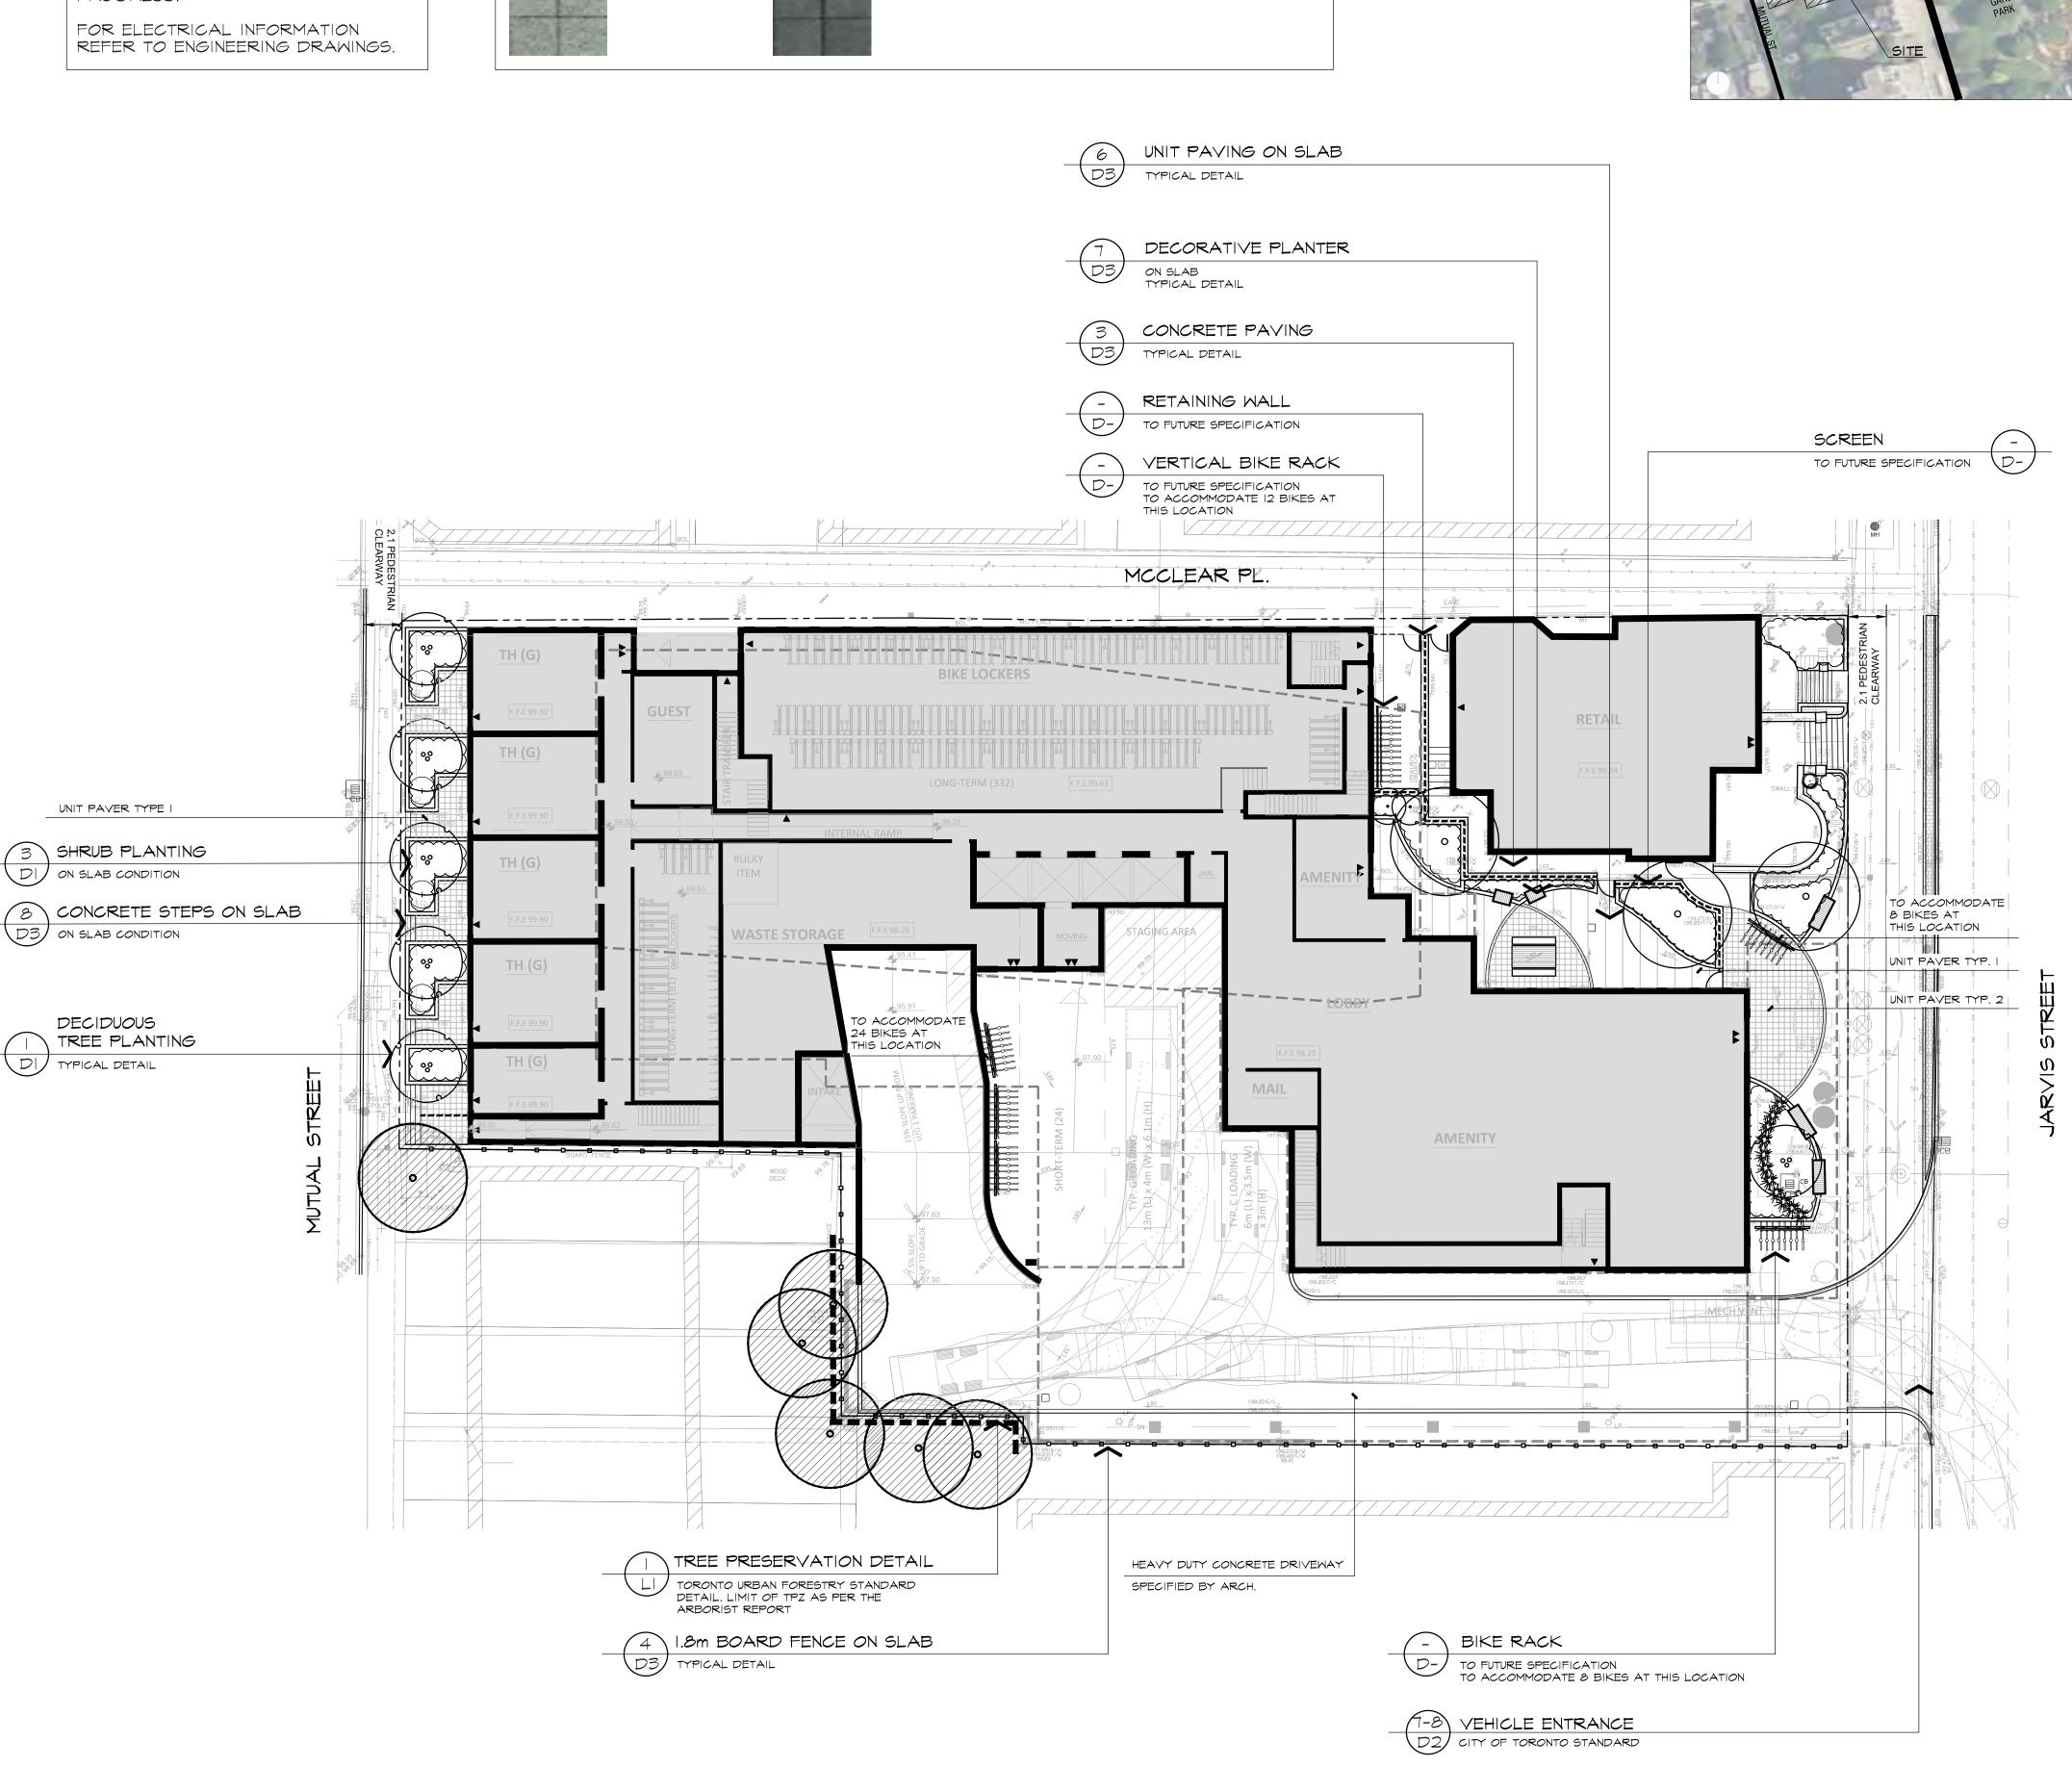

TREE PRESERVATION DETAIL

(1) Tree protection barriers must be a plywood or plastic web hoarding or equivalent

Tree protection barriers for trees situated on the City road allowance where visibility must be maintained can be 1.2m (4ft.) high and consist of orange plastic web snow fencing on

(3) Where some excavate or fill has to be temporarily located near a tree protection barrier,

(4) All supports and bracing should be outside the Tree Protection Zone. All such supports

(6) No construction activity, grade changes, surface treatment or excavations of any kind is permitted within the Tree Protection Zone.

6 Sediment control fencing shall be installed in locations indicated in an Urban Forestry approved Tree Protection Plan. The sediment control fencing must be installed to Ontario Provicial Standards (OPSO-219.110) and to the satisfaction of Urban Forestry.

Parks, Forestry and Recreation

Sept 2008 Detail TP-1

plywood must be used to ensure no material enters the Tree Protection Zone.


should minimize damaging roots outside the Tree Protection Barrier.


CITY OF TORONTO - URBAN FORESTRY

**bal Toronto** 

Urban Forestry

a wood frame made of 2"x 4"s .

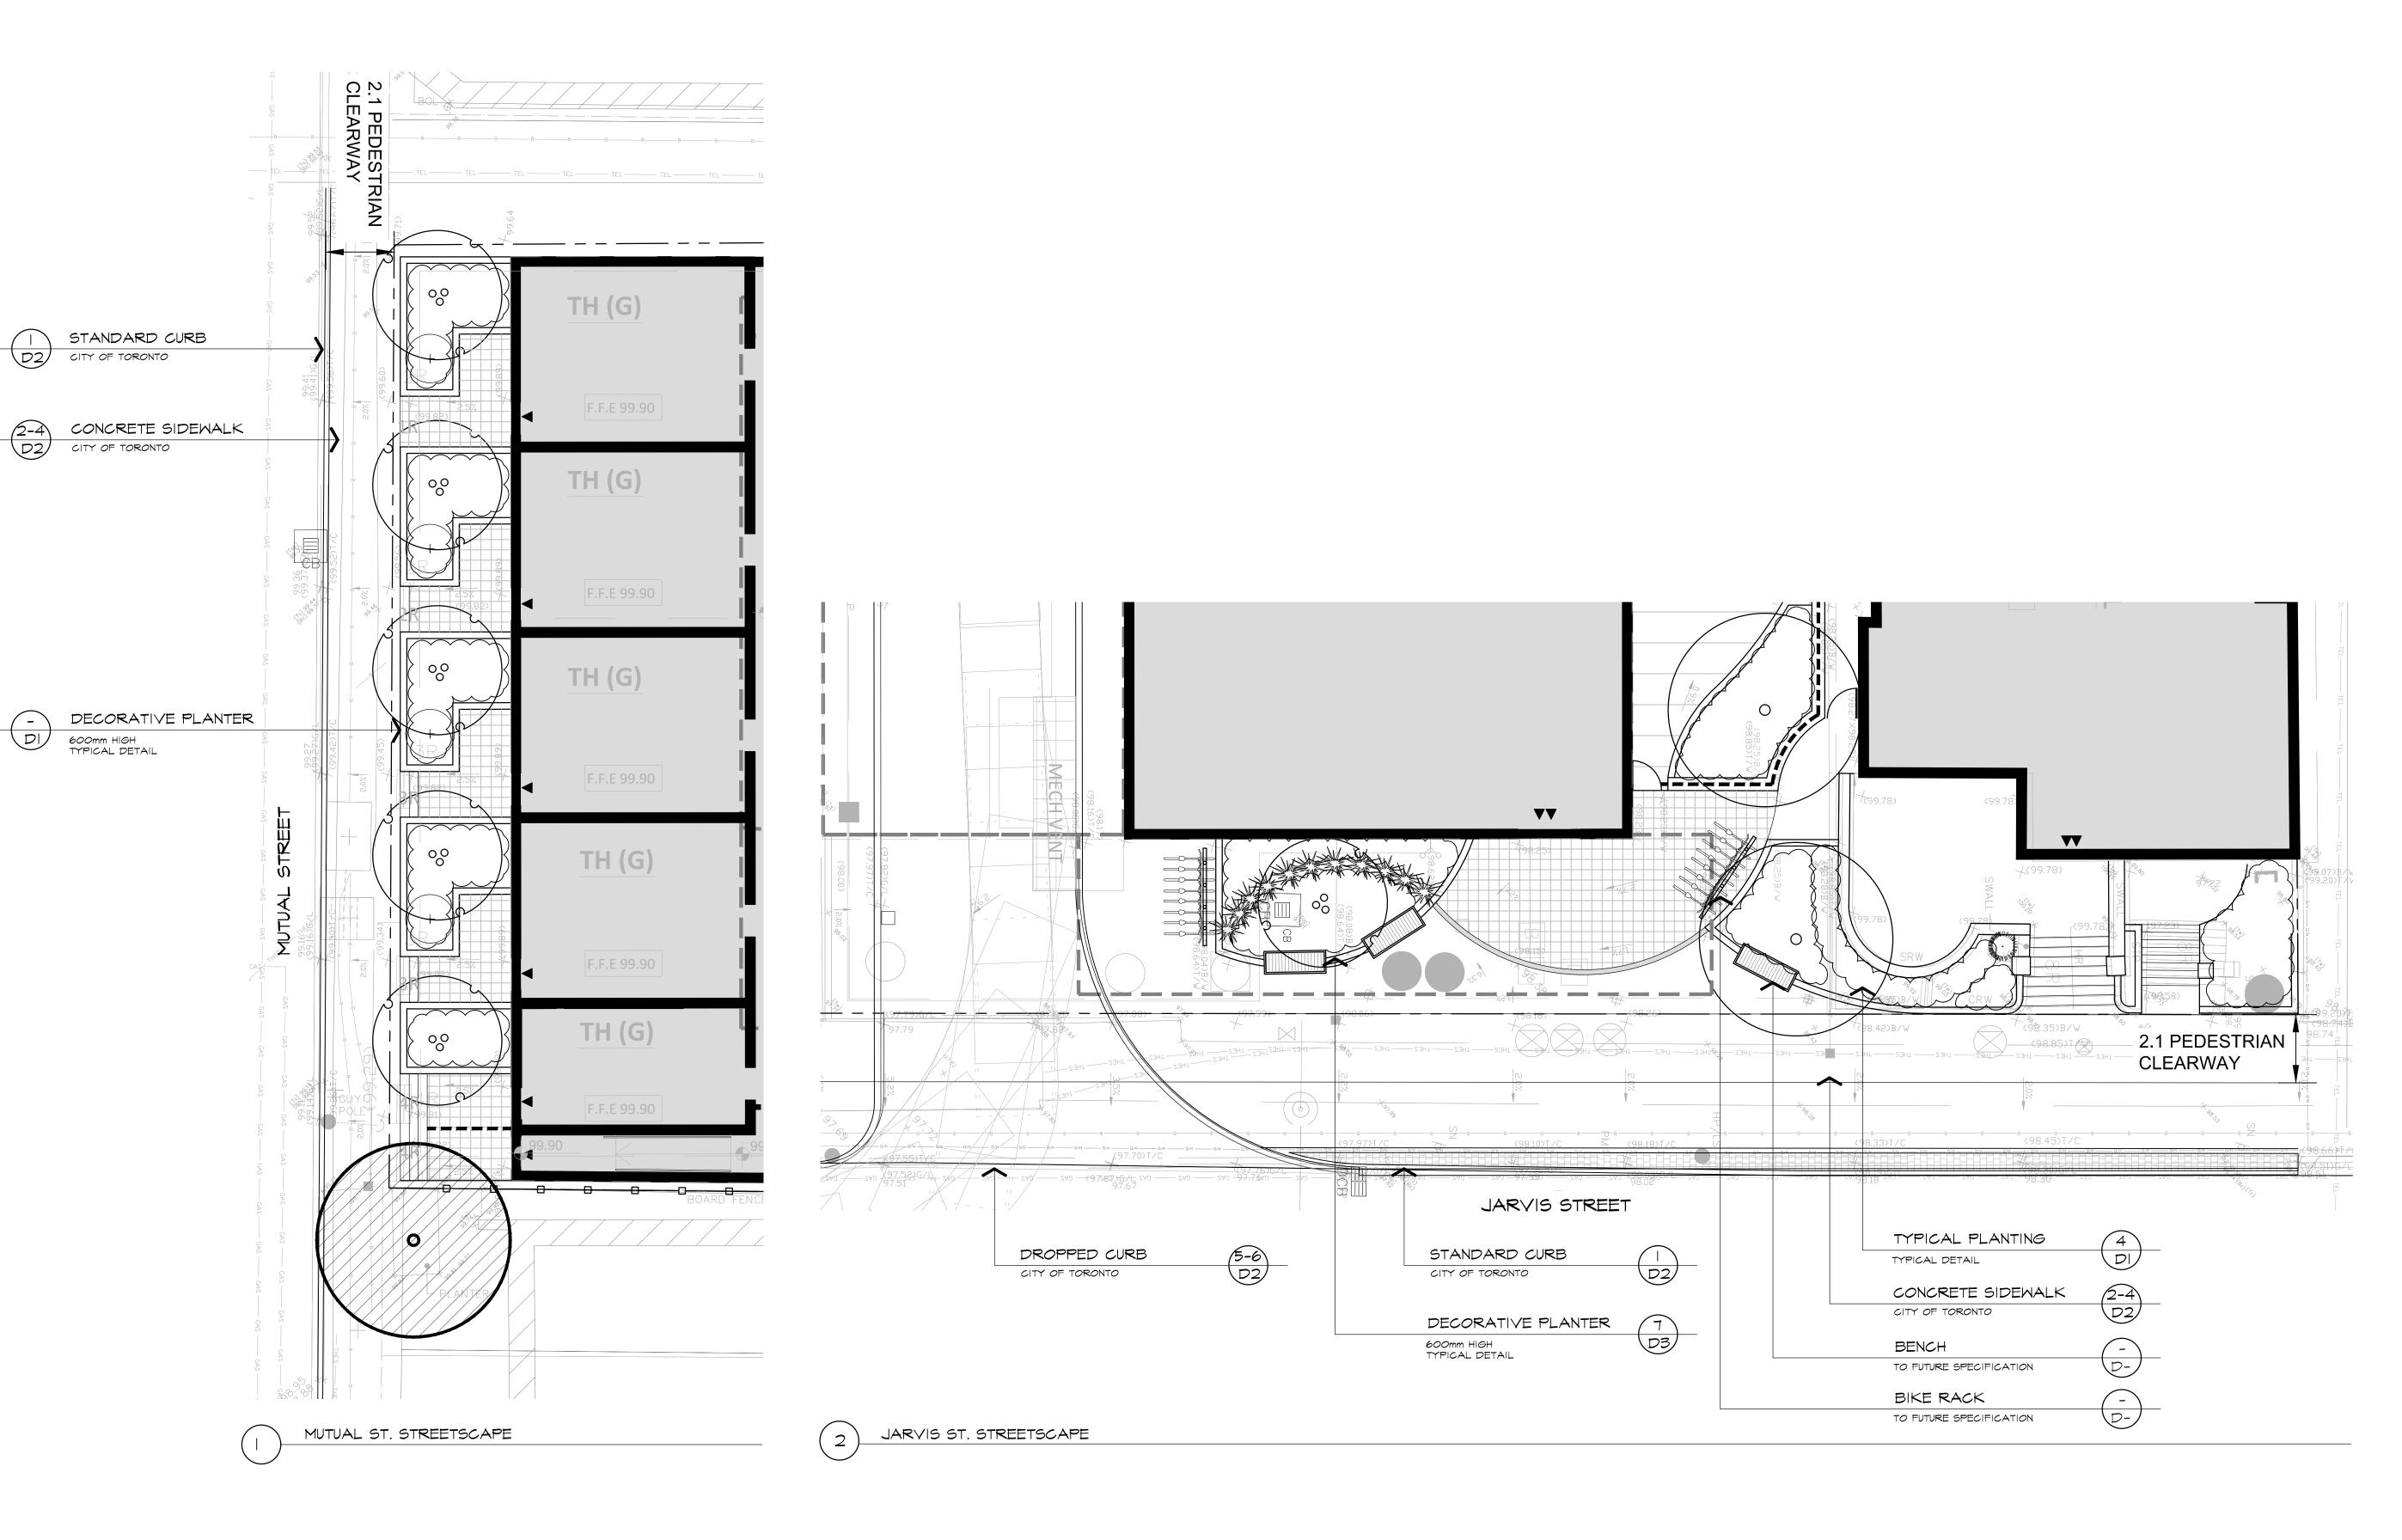

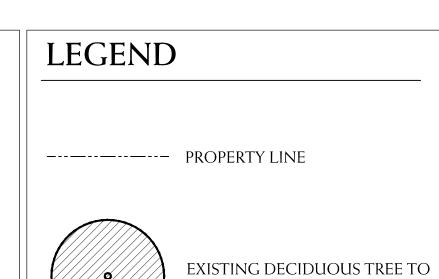

+ PROPOSED DECIDUOUS STREET TREE

REMAIN

PROPOSED SHRUBS, PERENNIALS & ORNAMENTAL GRASS

CONCRETE UNITE PAVER TYPE 2

CONCRETE UNITE PAVER TYPE 1

CONCRETE PAVING

WOODEN FENCE

BASE INFORMATION OBTAINED ELECTRONICALLY FROM DIAMOND SCHMITT ARCHITECTS (PROJECT NO. 1613 - TEL.416.862.8800)

3	AUG 22 2019	REISSUED FOR S.P.A NO.1	RS
2	JUN 14 2019	ISSUED FOR S.P.A NO.1	RS
1	JUN 7 2019	ISSUED FOR DRAFT SUBMISSION #1	RS
no.	date	version	by

All information hereon to be checked and verified at the site and any discrepancies must be reported to and clarified by the landscape architect before commencing work. All drawings, specifications, details, digital information, etc., prepared by the landscape architect are instruments of service and as such are his property and must be returned at his request.





ANDSCAPE ARCHITECTS

895 Don Mills Road, Second Tower, Suite 212
Toronto, Ontario, Canada, M3C 1W3

416.444.5201

416.444.5208

www.budrevics.com


project

308-314 JARVIS STREET & 225 MUTUAL STREET TORONTO, ONTARIO

GRAYWOOD DEV.'S / ALTERRA GROUP

dra

STREETSCAPE
ENLARGEMENT PLANS

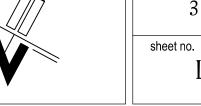


PAVING SPECIFICATIONS: UNIT PAVING - TYPE I UNIT PAVING - TYPE 2 MANUFACTURE: UNILOCK STYLE: UMBRIANO SIZE: T.B.D. PATTEN: LINEAR MANUFACTURE: UNILOCK STYLE: SERIES PATTERN: SQUARE CUT COLOUR: BLACK MINERAL ICE GREY SRI VALUE: 33 SRI VALUE: 15

IRRIGATION DESIGN, SPECIFICATIONS AND IRRIGATION WATER RE-USE CALCULATIONS, IN PROGRESS


LANDSCAPE LIGHTING FIXTURE LAYOUT AND PHOTOMETRICS PLAN IN PROGRESS.

FOR ELECTRICAL INFORMATION REFER TO ENGINEERING DRAWINGS.


TERRACES FURNISHINGS AND ACCESSORIES TO BE SPECIFIED AS PART OF TENDER PACKAGE

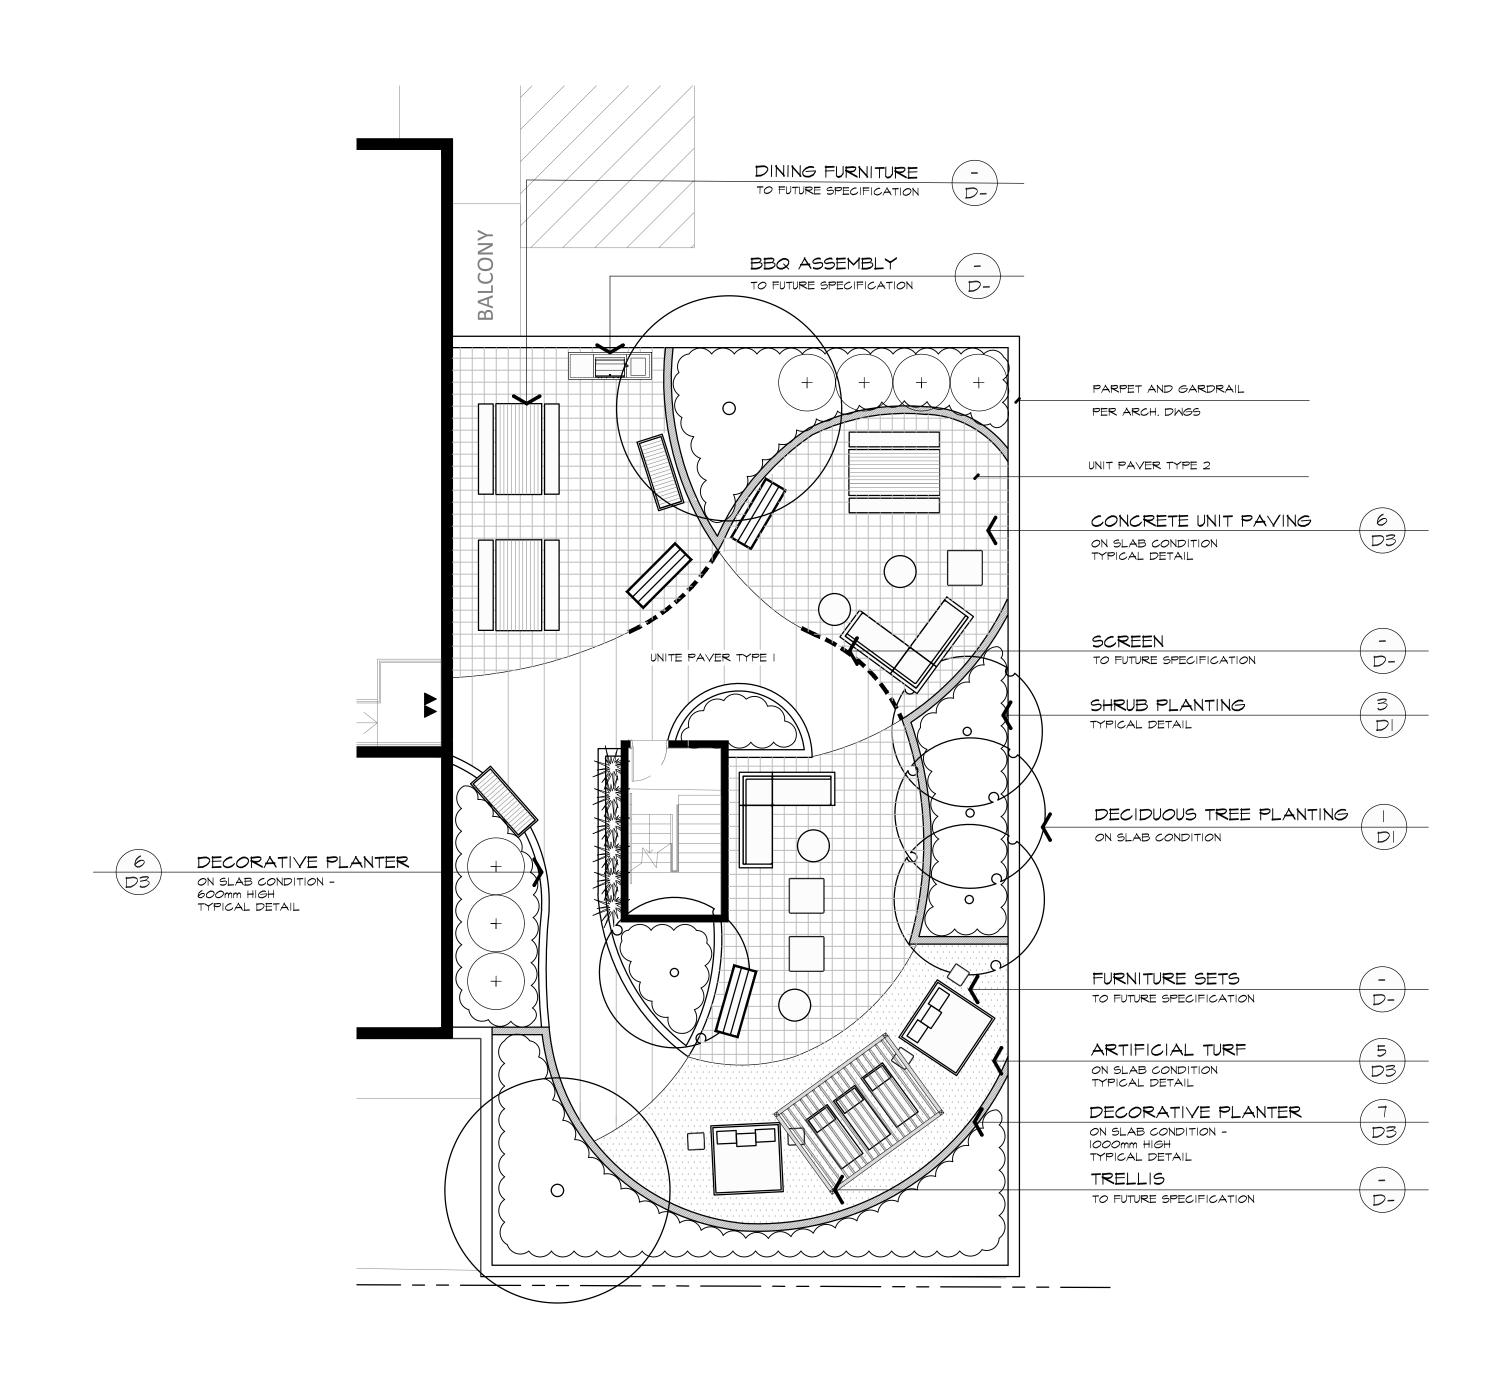

7th FLOOR AMENITY TERRACE

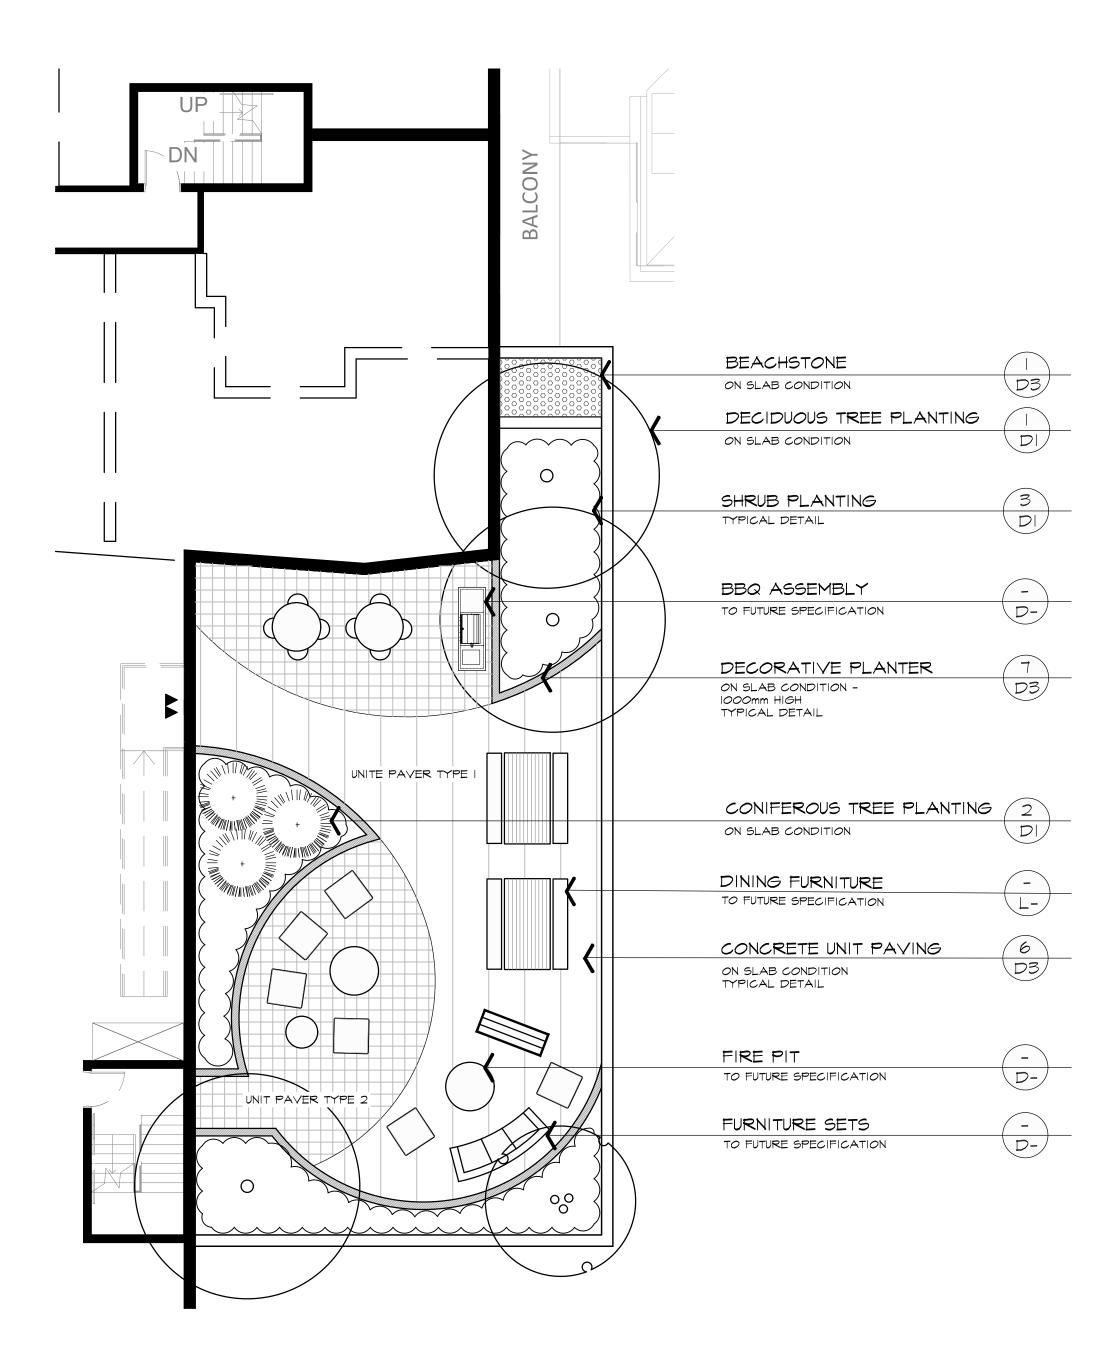

10th FLOOR AMENITY TERRACE

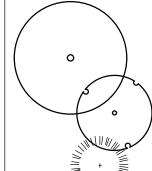

LEGEND

PROPOSED DECIDUOUS TREE

PROPOSED CONIFEROUS TREES

PROPOSED SHRUBS,

------

PERENNIALS & ORNAMENTAL GRASS

PROPOSED SCREEN

ARTIFICIAL TURF

CONCRETE UNITE PAVER TYPE 1

CONCRETE UNITE PAVER TYPE 2

DECORATIVE PLANTER


1000mm HIGH

DECORATIVE PLANTER 600mm HIGH

BASE INFORMATION OBTAINED ELECTRONICALLY FROM DIAMOND SCHMITT ARCHITECTS (PROJECT NO. 1613 - TEL.416.862.8800)

3	AUG 22 2019	REISSUED FOR S.P.A NO.1	RS
2	JUN 14 2019	ISSUED FOR S.P.A NO.1	RS
1	JUN 7 2019	ISSUED FOR DRAFT SUBMISSION #1	RS
no.	date	version	by

All information hereon to be checked and verified at the site and any discrepancies must be reported to and clarified by the landscape architect before commencing work. All drawings, specifications, details, digital information, etc., prepared by the landscape architect are instruments of service and as such are his property and must be returned at his request.

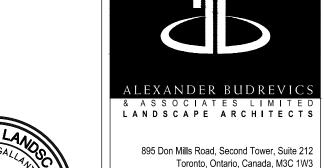



project

895 Don Mills Road, Second Tower, Suite 212 Toronto, Ontario, Canada, M3C 1W3 **୬** 416 444 5201 **4** 416.444.5208


www.budrevics.com

308-314 JARVIS STREET & 225 MUTUAL STREET TORONTO, ONTARIO

GRAYWOOD DEV.'S / ALTERRA GROUP

LANDSCAPE PLAN 7th & 10th FLOOR AMENITY TERRACES


date MAY 30 , 2019 file 3298 L3 V3-190822 AS SHOWN

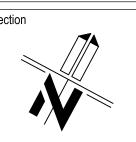


project no. 3298 sheet no.



BIO-ROOF ECO-SYSTEM 4 ASSEMBLY (PRE-VEGETATED) image provided by BIOROOF

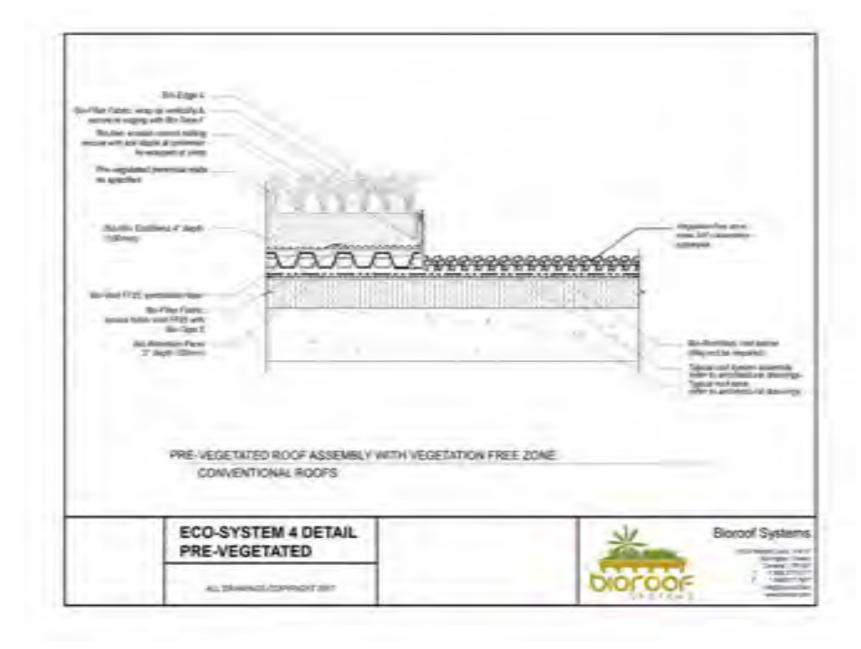

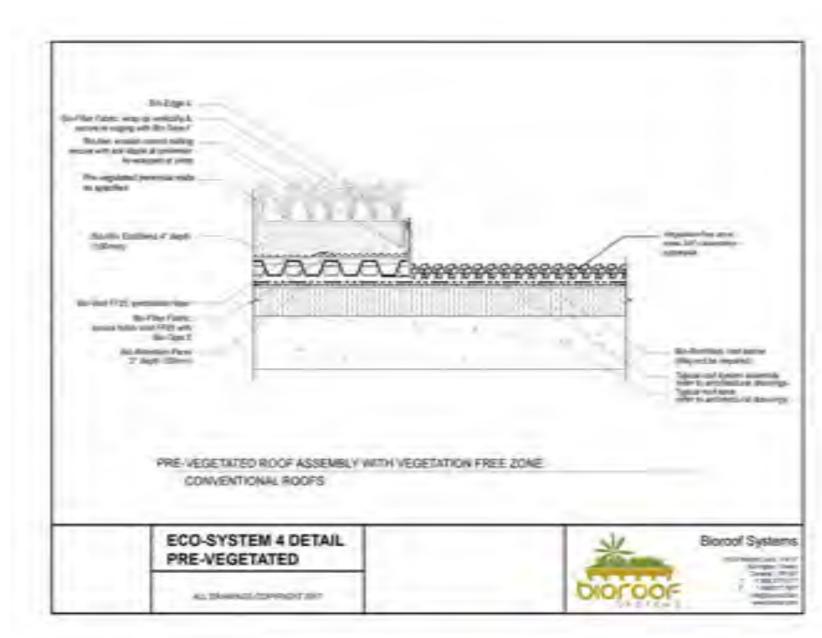




GREEN ROOF SYSTEM MANUFACTURED AND SUPPLIED BY: BIOROOF SYSTEMS, (OR APPROVED EQUAL)

CONTACT: KEN MCGOWAN PHONE: 905,975,1721 EMAIL: KEN@BIOROOF.COM

#### PRE-VEGETATED PERENNIAL MAT GENERAL NOTES: SPECIFICATIONS: GREEN ROOF INSTALLER TO ENSURE ANCHORAGE OF SYSTEM TOTAL GREEN ROOF AREA: 239.6m2 NO ACCESS TO TENANTS REFER TO ENGINEERING PLAN FOR ROOF DRAIN DETAILS AND SPECIFICATIONS BIOROOF, URBAN MEADOW MIX GREENROOF SUPPLIER TO PRE-VEGETATED PERENNIAL MAT PROVIDE WIND UPLIFT REPORT Aruba Creeping Red Fescue J-5 Chewings Fescue Ecostar Hard Fescue AND MAINTENANCE PLAN. GREEN ROOF TO COMPLY WITH Beebalm - Wild Bergamot THE REQUIREMENTS OF THE GREEN Mixed Columbine ROOF DESIGNER CHECKLIST AND Black Eyed Susan CITY OF TORONTO BY-LAW NO. Viola (mixed colours) 503-2009 Purple ConeflowerPale Purple Coneflower FALL ARREST ANCHOR SYSTEM TO BE INSTALLED FOR OSHA AND OBC STANDARDS.

Shasta Daisy

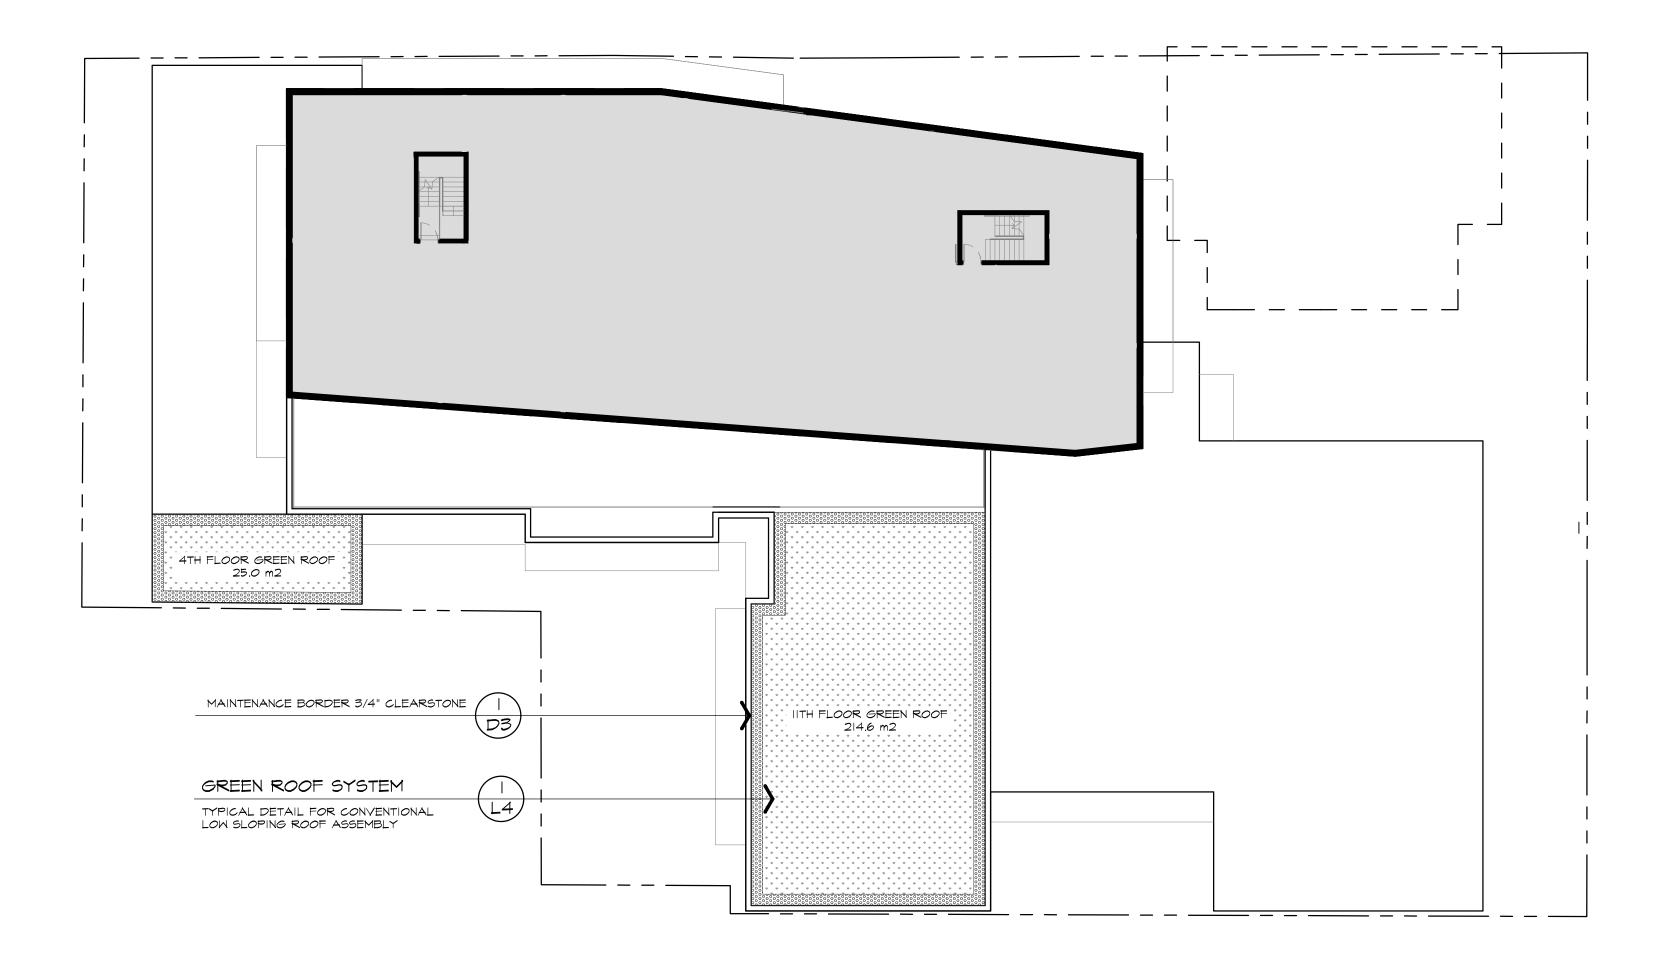



# **Green Roof Statistics**

The Grean Road State to Tempare is required in the assembled for Sier Plan Control Applicators where it grean not is required under the Topolitz Municipal Cook Chapter 650, Green Royds. Complete the table below and copy if directly sette the Roof Plan. submitted as part of any Site Plan Control Application requiring a green real in accordance with the Sylvan Pieter to Section § 462— To the Municipal Code for a complete list of disfinish terms, and gream contry and certainly regarding the intent and application of the terms included in the template. The Toronto Municipal Code Chapter 492, Green Roots can be found online at http://www.lgovite.co/egipton/historide/154-552.cd

#### Green Roof Statistics

		Processo
Gross Floor Area, as defined in Green Roof Bylaw (m)	9	0.4m E
Total Roof Area (m*)		2407
Area of Residential Private Terraces (m²)		-915
Rooftop Outdoor Amenity Space, If in a Resident	nat Building (m²)	90.
Area of Renovable Energy Devices (m <sup>2</sup> )		
Tower (s.Ripof Area, with floor plate less than 750	at .	feet.
Total Available Roof Space (m*)		1000
Green Rolel Coverage	Seam	Foxesed
Coverage of Available Roof Space (m²)	1919	2214
Coverage of Available Roof Space (%)		-

# LEGEND

GREEN ROOF -VEGETATED AREA

3/4" CLEAR STONE MAINTENANCE AREA

BASE INFORMATION OBTAINED ELECTRONICALLY FROM DIAMOND SCHMITT ARCHITECTS (PROJECT NO. 1613 - TEL.416.862.8800)

3	AUG 22	REISSUED FOR S.P.A NO.1	RS
	2019 JUN 14	LIGHTED FOR CRANCE	D.C.
2	2019	ISSUED FOR S.P.A NO.1	RS
1	JUN 7 2019	ISSUED FOR DRAFT SUBMISSION #1	RS
no.	date	version	by

All information hereon to be checked and verified at the site and any discrepancies must be reported to and clarified by the landscape architect before commencing work. All drawings, specifications, details, digital information, etc., prepared by the landscape architect are instruments of service and as such are his property and must be returned at his request.





**4** 416.444.5208


www.budrevics.com

308-314 JARVIS STREET & 225 MUTUAL STREET TORONTO, ONTARIO


GRAYWOOD DEV.'S / ALTERRA GROUP


ROOF PLAN GREEN ROOF & DETAIL

\_\_\_\_\_date MAY 30 , 2019 file 3298 L4 V3-190822 scale\* 1:200 project no. 3298

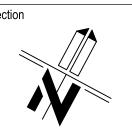

sheet no.

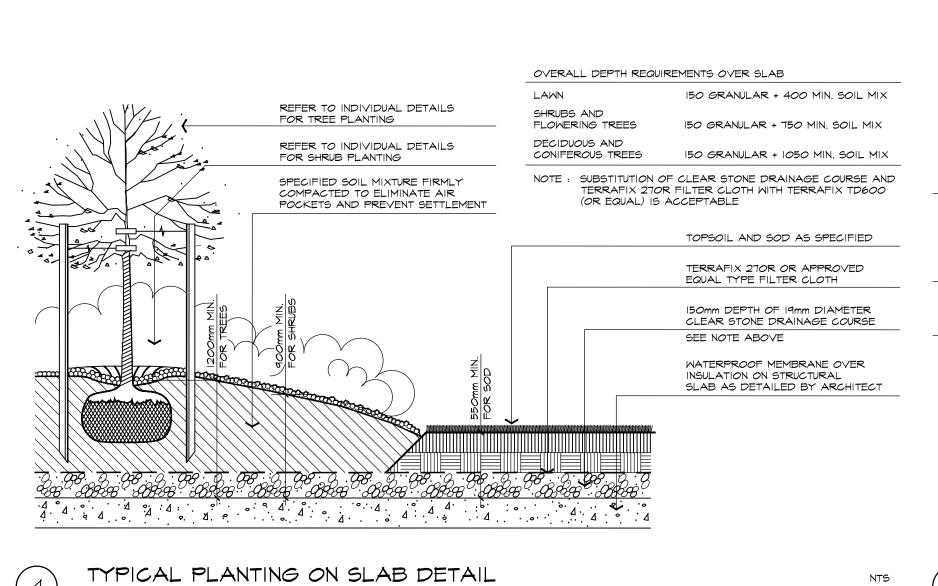

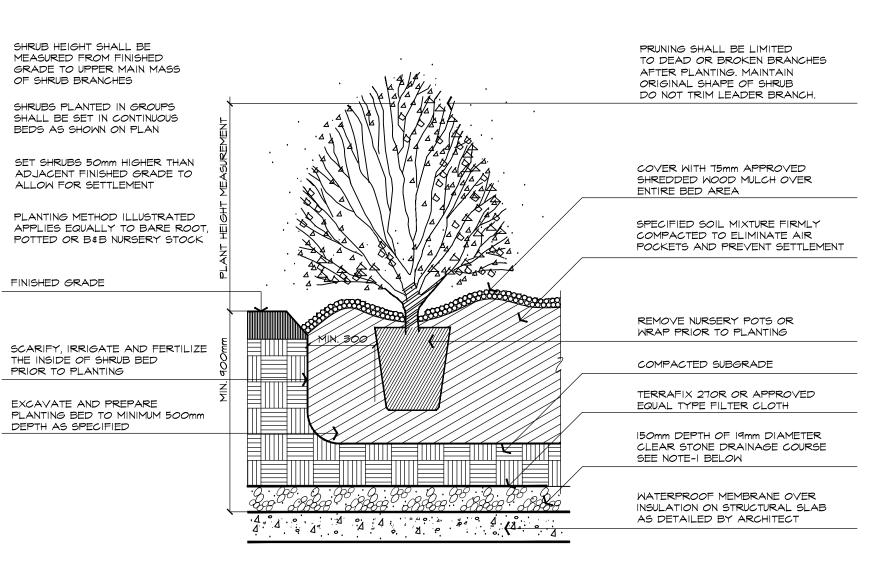

NOTE-I : ALL STAKES, TREE WRAP, HOSES, AND WIRES TO BE REMOVED BY CONTRACTOR 12mm DIAMETER BLACK RUBBER HOSE LOOPED ABOVE FIRST STRONG BRANCH PRIOR TO FINAL ACCEPTANCE. WILTPROOF IN NURSERY 12 GAUGE GALVANIZED WIRE PRIOR TO DELIVERY ENGLOSED IN 12mm DIAMETER RUBBER HOSE SECURED AROUND TREE TRUNK. PROVIDE WIRE PRUNING SHALL BE LIMITED TURNBUCKLE FOR TENSION TO DEAD OR BROKEN BRANCHES AFTER PLANTING. MAINTAIN ORIGINAL SHAPE OF TREE DO NOT TRIM LEADER BRANCH. WRAP TREE TRUNK WITH APPROVED TREE WRAP AFTER VISUAL INSPECTION BY LANDSCAPE ARCHITECT. WRAP TO SET TREE 50mm HIGHER THAN EXTEND FROM TOP OF ROOTBALL TO ADJACENT FINISHED GRADE TO ABOVE GUYWIRE HOSE LOCATION. ALLOW FOR SETTLEMENT PROVIDE MIN. IOMM OVERLAP. TWO 2400mm LONG 50mm SQUARE SET TREE STAKES JUST PRESSURE TREATED WOOD STAKES INSIDE TREE PIT AS SHOWN SECURED INTO GROUND AS SHOWN PROVIDE APPROVED RODENT GUARD WHERE REQUIRED FINISHED GRADE CONSTRUCT 100mm SOIL SAUCER AROUND TREE BASE AND COVER WITH 75mm APPROVED SHREDDED CUT AND REMOVE TOP 1/3 OF BURLAP FROM ROOTBALL INCLUDING ALL TIE ROPE AND WIRE WOOD MULCH SPECIFIED SOIL MIXTURE FIRMLY COMPACTED TO ELIMINATE AIR SCARIFY, IRRIGATE AND FERTILIZE POCKETS AND PREVENT SETTLEMENT THE INSIDE OF THE TREE PIT PRIOR TO PLANTING TERRAFIX 270R OR APPROVED EQUAL TYPE FILTER CLOTH PROVIDE 75mm SOIL MOUND AT BASE OF PIT AS SHOWN 150mm DEPTH OF 19mm DIAMETER CLEAR STONE DRAINAGE COURSE COMPACTED SUBGRADE SEE NOTE-2 BELOW WATERPROOF MEMBRANE OVER INSULATION ON STRUCTURAL SLAB AS DETAILED BY ARCHITECT MINIMUM DEPTHS OVER SLAB NOTE-2: SUBSTITUTION OF CLEAR STONE DRAINAGE COURSE AND TERRAFIX 270R FILTER CLOTH WITH TERRAFIX TD600 OR MIRADRAIN (OR EQUAL) IS ACCEPTABLE DECIDUOUS AND CONIFEROUS TREES 150 GRANULAR + 1050 MIN. SOIL MIX

TYPICAL INSTALLATION FOR 75mm CALIPER TREES OR LESS

DECIDUOUS TREE PLANTING ON SLAB DETAIL

NTS

ABAL OSIII-OTIIOI

REISSUED FOR S.P.A NO.1 2019 JUN 14 ISSUED FOR S.P.A NO.1 2019 JUN 7 ISSUED FOR DRAFT SUBMISSION #1

All information hereon to be checked and verified at the site and any discrepancies must be reported to and clarified by the landscape architect before commencing work. All drawings, specifications, details, digital information, etc., prepared by the landscape architect are instruments of service and as such are his property and must be returned at his request.

version

# MASTER PLANT LIST

IN THE EVENT OF A DISCREPANCY BETWEEN THE PLANTING PLAN AND THE PLANT LIST QUANTITIES, THE PLANTING PLAN SHALL GOVERN.

NOTE-I: SUBSTITUTION OF CLEAR STONE DRAINAGE COURSE AND

OR MIRADRAIN (OR EQUAL) IS ACCEPTABLE

TERRAFIX 270R FILTER CLOTH WITH TERRAFIX TD600

NTS

ABAL 05113-071101

KEY	QUANTITY	BOTANICAL NAME	COMMON NAME	NATIVE	DROUGHT TOLERANT	CALIPER	HEIGHT	SPREAD	ROOT	REMARKS	O.C. SPACING
r	DECIDUOUS SHA	ADE TREES									
Α	-	CERSIS CANADENSIS	EASTERN REDBUD	<b>✓</b>	<b>✓</b>	70mm	2500mm	1200mm	B¢B	SPECIMEN	N/A
В	-	AMELANCHIER CANADENSIS	SERVICEBRRY	<b>/</b>		70mm	2500mm	1200mm	B <b></b> ₿	SPECIMEN	N/A
C	-	CORNUS ALTERNIFOLIA	PAGODA DOGWOOD	<b>✓</b>	<b> </b>	70mm	2500mm	1200mm	B≰B	SPECIMEN	N/A
D	-	ULMUS AMERICANA	AMERICAN ELM	<b>✓</b>	<b>√</b>	70mm	2500mm	1200mm	B¢B	SPECIMEN	N/A
c	CONIFEROUS (E	VERGREEN) TREES									
E	-	PINUS STROBUS 'FASTIGIATA'	COLUMNAR EATERN WHITE PINE	✓	<b>✓</b>	1500mm	1000mm	S.B.	SPECIMEN		
~	CONIFEROUS \$	BROADLEAF (EVERGREEN) SHRUBS									
F	-	TAXUS X MEDIA DENSSIFORMIS	DENSE YEW				2500mm	1200mm	B≰B	EVEN FORM	1200mm
6	-	BUXUS 'GREEN GEM'	GREEN GEM BOXWOOD		<b>✓</b>			400mm	3 gal. POT	MIN. 2 YRS. GTH.	500mm
Η	-	EUONYMUS FORTUNEI 'SARCOXIE'	SARCOXIE EUONYMUS		✓			500mm	POTTED	MIN. 2 YRS. GTH.	600mm
r	DECIDUOUS SHF	RUBS									
aa	-	ASTER ALPINUS	ALPINE ASTER		<b>✓</b>			100mm	l gal. POT	MIN. 2 YRS. GTH.	
bb	-	HYDRANGEA PANICULATA 'LIMELIGHT'	LIMELIGHT HYDRANGEA				500mm		POTTED	MIN. 10 STEMS	650mm
C	ORNAMENTAL 6	GRASSES									
cc	-	HAKONECHLOA MACRA 'ALBOSTRIATA'	JAPANESE FOREST GRASS						l gal. POT		500mm
F	PERENNIALS A	ND GROUND COVERS									
aaa	-	CORNUS CANADENSIS	BUNCHBERRY	✓					I GAL. POT		200mm
obb	-	DELOSPERMA X 'FIRE SPINNER'	FIRE SPINNER ICE PLANT		<b> </b>				I GAL. POT		PER PLAN
ccc	-	GUACAMOLE HOSTA	GUACAMOLE HOSTA		<b>✓</b>				I GAL. POT		300mm
ddd	-	ATHYRIUM FILIX-FEMINA	LADY FERN	<b>√</b> .					I GAL. POT		PER PLAN
eee	-	PARTHENOCISSUS QUINQUEFOLIA 'ENGEL'	ENGELMANN'S VIRGINIA CREEPER	<b>✓</b>					2 GAL POT		
fff	-	RUDBECKIA HIRTA	GLORIOSA DAISY	<b>√</b>	<b>✓</b>			100mm	I GAL. POT	MIN. 2 YRS. 6TH.	
999	-	ECHINACEA PURPUREA	PURPLE CONE FLOWER	✓	<b>✓</b>			100mm	I GAL. POT	MIN. 2 YRS. GTH.	

MINIMUM DEPTHS OVER SLAB


TYPICAL INSTALLATION

150 GRANULAR + 750 MIN. SOIL MIX

SHRUB PLANTING ON SLAB DETAIL

FLOWERING TREES

ABAL 05101-071109

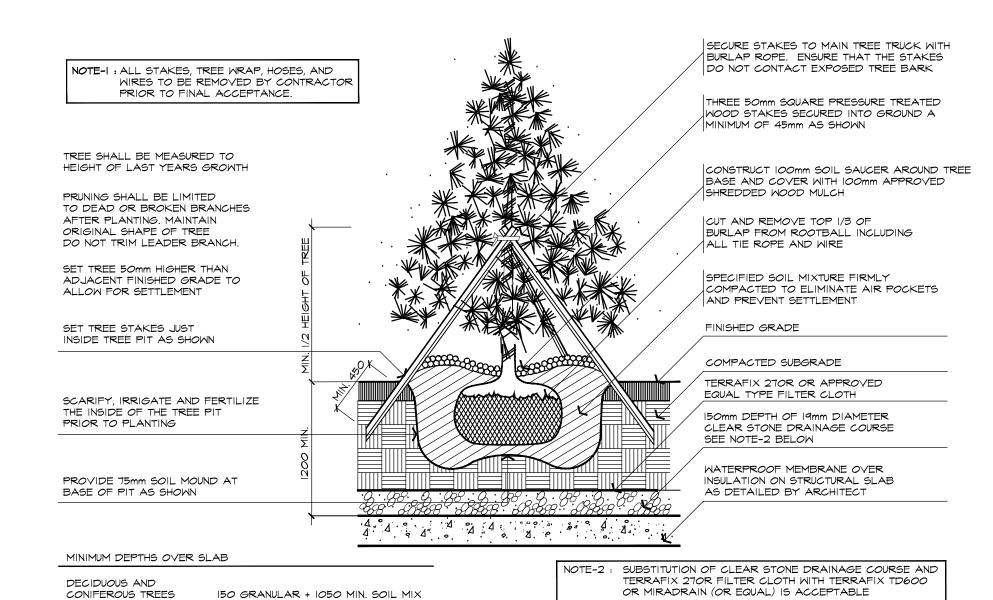

CONIFEROUS TREE PLANTING ON SLAB DETAIL TYPICAL INSTALLATION FOR 2000mm HEIGHT TREES OR LESS

ABAL *O*SII2-*0*7II*0*I

LEXANDER BUDREVIC & ASSOCIATES LIMITED LANDSCAPE ARCHITECTS 895 Don Mills Road, Second Tower, Suite 212 Toronto, Ontario, Canada, M3C 1W3 **4** 416.444.5201 **\$** 416.444.5208 www.budrevics.com

project

no. date


308-314 JARVIS STREET & 225 MUTUAL STREET TORONTO, ONTARIO

GRAYWOOD DEV.'S / ALTERRA GROUP


drawing

PLANTING DETAILS


date MAY 30 , 2019	drawn RS
scale* NTS	file 3298 D1 V3-19082
direction	project no.
	3298
	sheet no.
	$\parallel$ D1

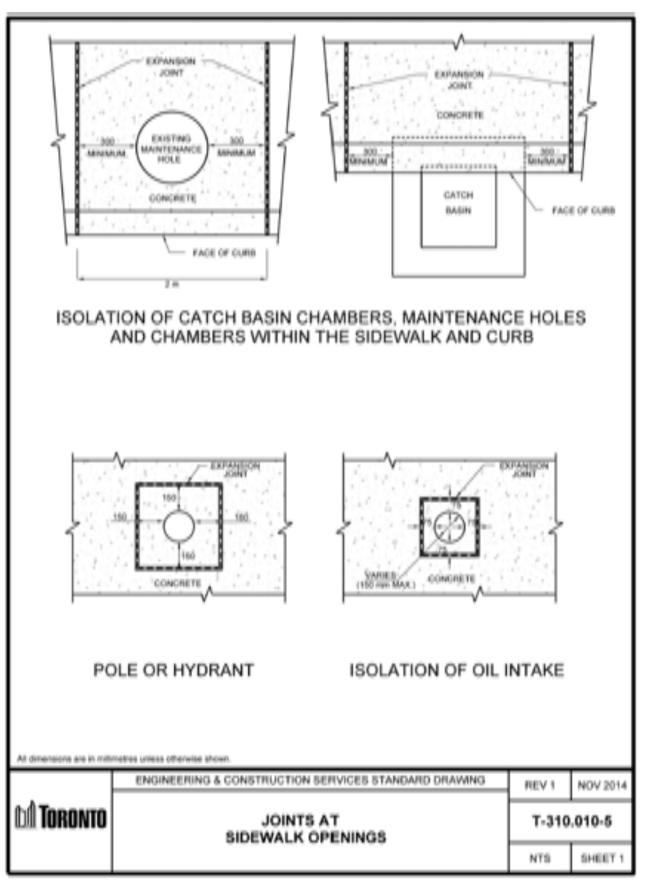



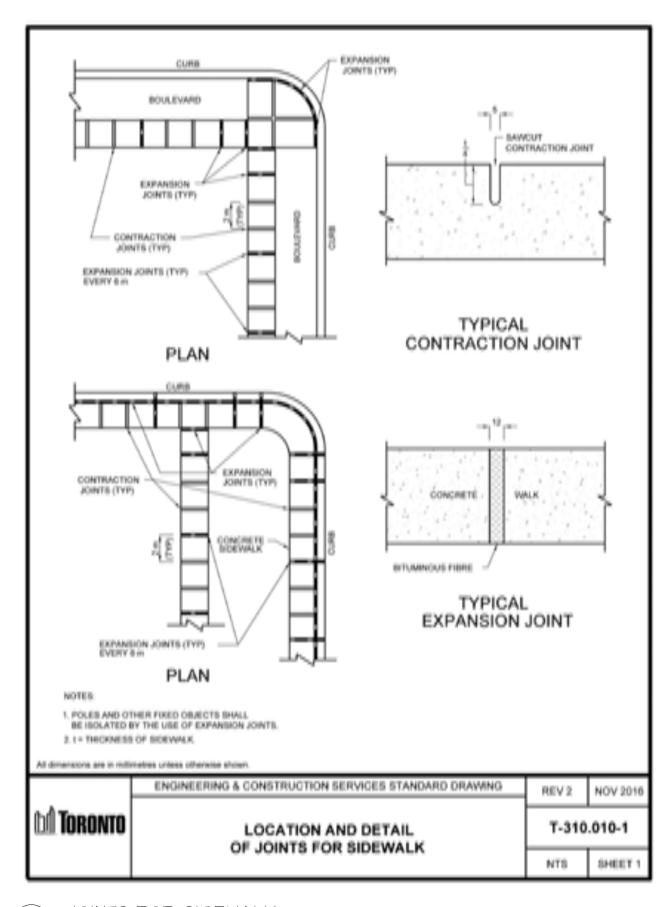




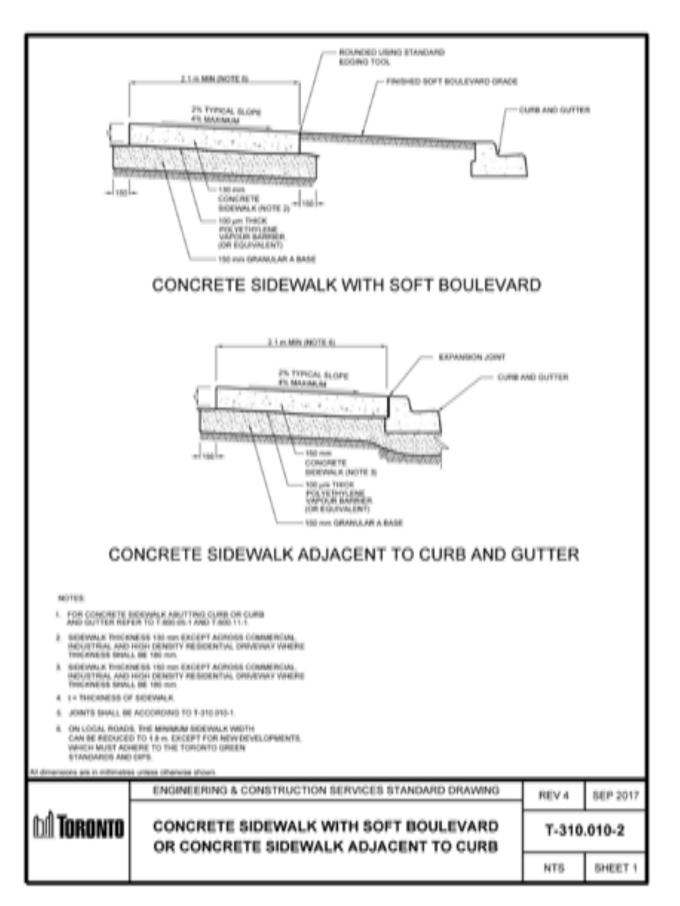


CONCRETE SIDEWALK CONDITIONS

CITY OF TORONTO STANDARD

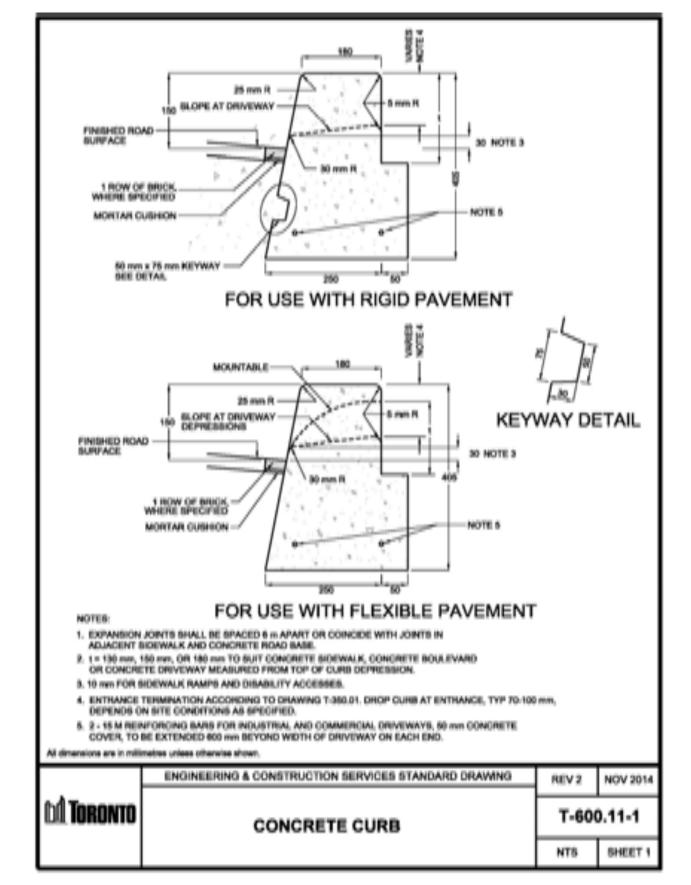


CONCRETE CURB


CITY OF TORONTO STANDARD
REFER TO ENGINEERING DRAWINGS FOR CURB AND GUTTER DETAIL WHERE APPLICABLE

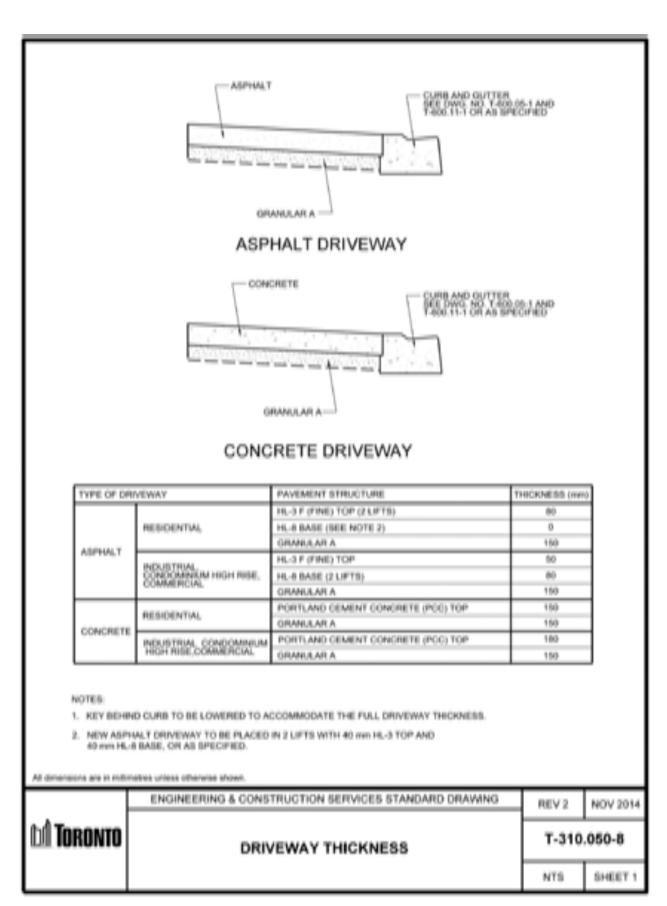




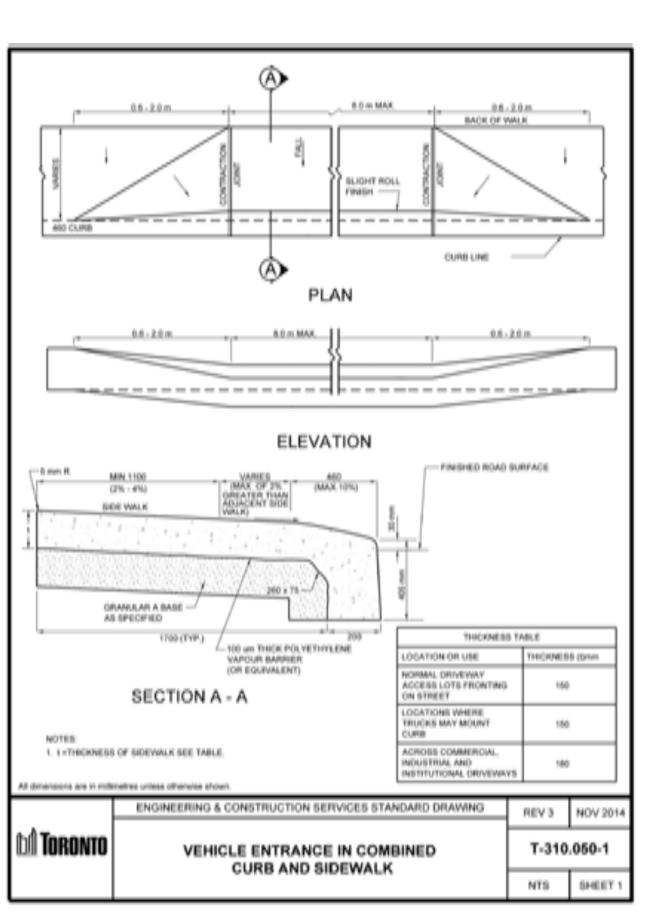



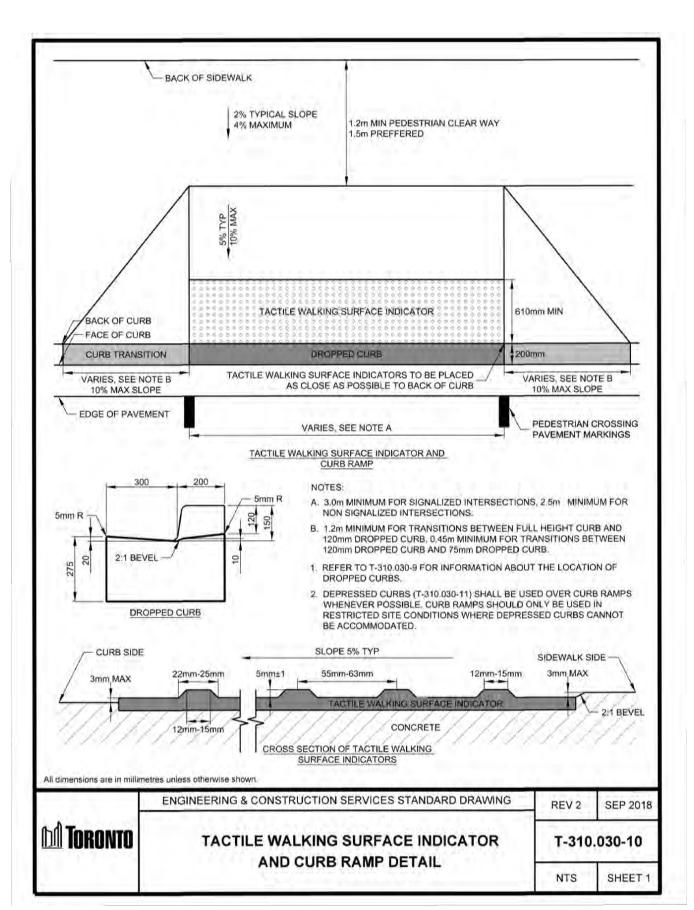


6 TACTILE SURFACE INDICATOR
CITY OF TORONTO STANDARD

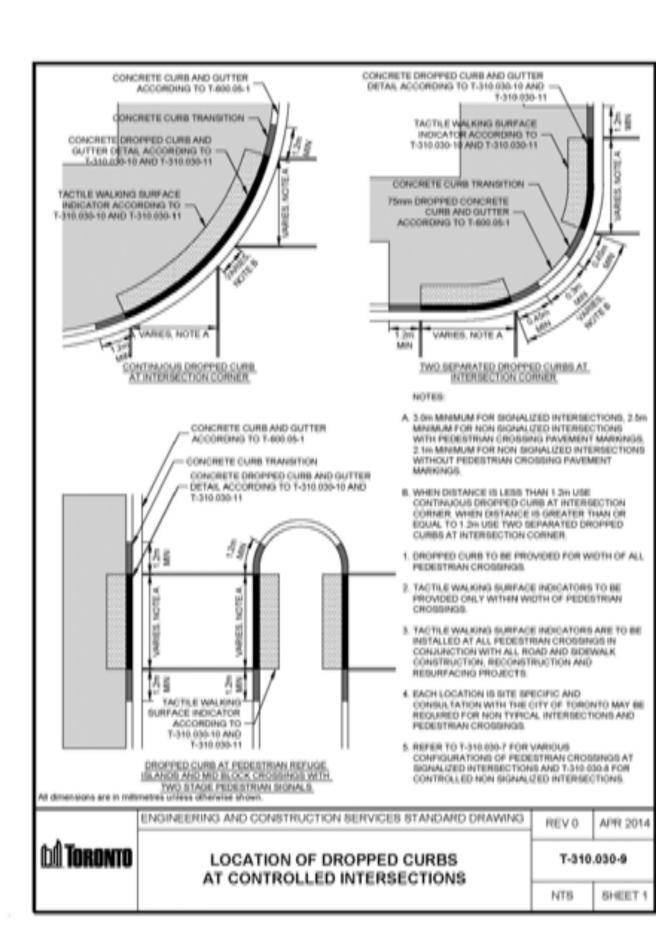

5 DROPPED CURBS

CITY OF TORONTO STANDARD

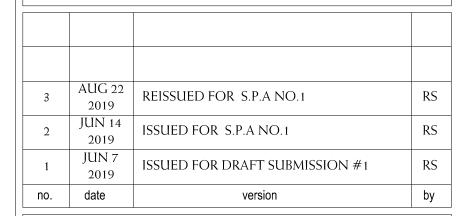

All information hereon to be checked and verified at the site and any discrepancies must be reported to and clarified by the landscape architect before commencing work. All drawings, specifications, details, digital information, etc., prepared by the landscape architect are instruments of service and as such are his property and must be returned at his request.



A L E X A N D E R B U D R E V I C S

& A S S O C I A T E S L I M I T E D

L A N D S C A P E A R C H I T E C T S

895 Don Mills Road, Second Tower, Suite 212
Toronto, Ontario, Canada, M3C 1W3

\$\alpha\$ 416.444.5201

\$\alpha\$ 416.444.5208

www.budrevics.com

project


308-314 JARVIS STREET & 225 MUTUAL STREET TORONTO, ONTARIO

GRAYWOOD DEV.'S / ALTERRA GROUP

drawing

STREETSCAPE DETAILS R.O.W HARDSCAPING

date MAY 30 , 2019	drawn RS
scale* NTS	file 3298 D2 V3-190822
direction	project no.
	3298
	sheet no.
	D2

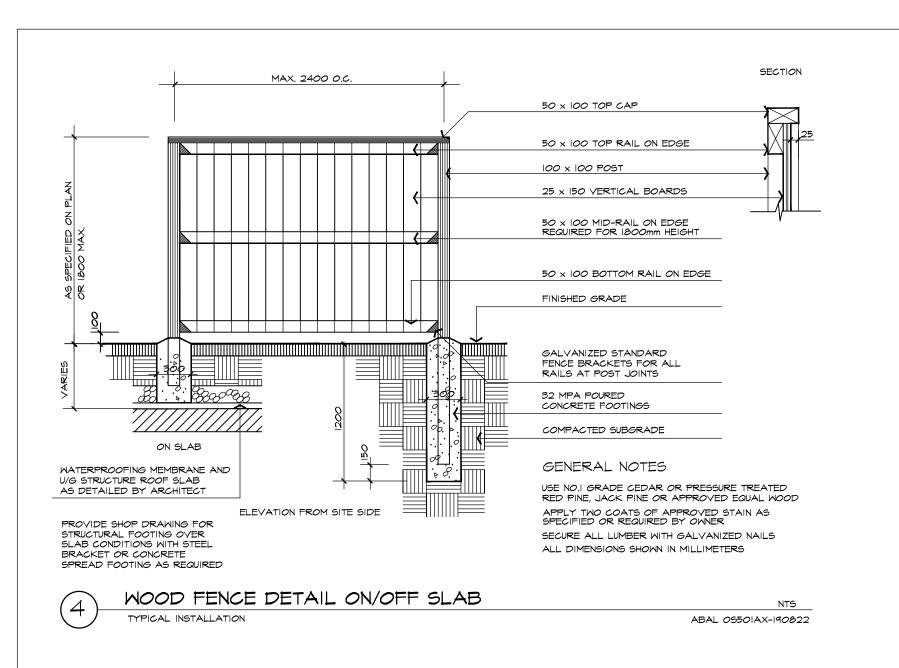

# SPECIFICATIONS

SOFT LANDSCAPING

EXPOSED FACES - COLOUR AND TEXTURE

O MATCH DECORATIVE CONCRETE

TREATMENT OF BUILDING.

AS DETAILED BY ARCHITECT.

#### GENERAL THESE SPECIFICATIONS ARE TO BE READ IN CONJUNCTION WITH THE GENERAL CONDITIONS OF THE CONTRACT AS PREPARED BY AND AVAILABLE AT THE OFFICE OF ALEXANDER BUDREVICS & ASSOCIATES LTD.

PRIOR TO COMMENCING WORK, THE CONTRACTOR SHALL:

 FAMILIARIZE HIMSELF WITH THE PLANS, DETAILS, AND SPECIFICATIONS OF THIS PROJECT,
 VISIT THE SITE TO ASCERTAIN AND TAKE ACCOUNT OF EXISTING ONDITIONS AND ANY DEVIATIONS FROM THE PLANS IN WORK BY OTHERS, 3. FINALIZE ALL DESIGN ALTERNATIVES IN CONSULTATION WITH THE

PRIOR TO EXCAVATING, THE CONTRACTOR SHALL VERIFY THE LOCATION OF ALL UNDERGROUND UTILITIES. IN THE EVENT OF A CONFLICT BETWEEN A PROPOSED TREE LOCATION AND AN UNDERGROUND SERVICE, THE EXACT LOCATION OF THE TREE SHALL BE DETERMINED ON SITE BY THE LANDSCAPE ARCHITECT.

THE CONTRACTOR SHALL, AT HIS OWN EXPENSE, REPAIR ANY DAMAGE TO EXISTING UTILITIES, STRUCTURES, FACILITIES, ETC. DONE IN THE PERFORMANCE OF HIS WORK ALL SITE WORK SHALL CONFORM TO THE <u>CANADIAN NATIONAL MASTER CONSTRUCTION</u>
<u>SPECIFICATIONS</u>, A COPY OF WHICH CAN BE OBTAINED FROM CONSTRUCTION
SPECIFICATIONS CANADA, TEI, (416) TTT-2196, Fax. (416) TTT-219, Email. Info@csc-dcc.ca. IT IS THE RESPONSIBILITY OF THE CONTRACTOR TO BE THOROUGHLY FAMILIAR WITH THESE SPECIFICATIONS AND THEIR IMPLICATIONS FOR THIS PROJECT.

#### PLANT MATERIALS ALL PLANTS SHALL BE INSTALLED TRUE TO SPECIFIED NAMES, SIZES, GRADES, ETC. AND SHALL CONFORM TO THE STANDARDS OF THE CANADIAN NURSERY TRADES

ALL PLANTS SHALL BE NURSERY GROWN. IN THE EVENT OF A DISCREPANCY IN PLANT QUANTITY BETWEEN THE PLANTING PLAN AND THE CONTRACTOR SHALL MAKE PLANTS AVAILABLE FOR INSPECTION BY THE LANDSCAPE ARCHITECT PRIOR TO INSTALLATION. MATERIAL NOT CONFORMING TO THE SPECIFICATIONS SHALL BE REPLACED AT THE EXPENSE OF THE CONTRACTOR. PLANT SUBSTITUTIONS MUST BE APPROVED IN WRITING BY THE OWNER OR THE LANDSCAPE ARCHITECT PRIOR TO DELIVERY OF THE MATERIAL ON SITE. THE LANDSCAPE ARCHITECT MAY, UPON COMPLETION OF THE WORK AND NOTWITHSTANDING PRIOR APPROVAL AT SOURCE, REJECT PLANT MATERIAL NOT

THE CONTRACTOR SHALL USE STANDARD INDUSTRY METHODS FOR PLANTING TREES. TREES SHALL BE TURNED TO GIVE THE BEST APPEARANCE; THEY SHALL ALSO BE GUYED AND STAKED IMMEDIATELY AFTER PLANTING AND AS DETAILED ON THE DRAWINGS.

BED PREPARATION

THE CONTRACTOR SHALL BACKFILL TREE PITS AND PLANTING BEDS TO SPECIFIED DEPTHS WITH EITHER PRE-MIXED TOPSOIL (VIZ., "TRIPLE-MIX") OR A MIXTURE COMPRISED

I PART FINELY PULVERIZED CANADIAN PEAT MOSS
I PART WELL-ROTTED FARM MANURE, WITH "AGRIFORM" 20-10-5 TABLETS (OR APPROVED EQUAL) ADDED ACCORDING TO THE MANUFACTURER'S SPECIFICATIONS.

THE CONTRACTOR SHALL CONSTRUCT TREE PITS AND SHRUB BEDS WITH SOIL SAUCERS, MULCH, AND SUBSURFACE DRAINAGE AS DETAILED. THE CONTRACTOR SHALL CONSTRUCT SHRUB BEDS IN CONTINUOUS FORMS, THE SHAPE OF WHICH SHALL BE APPROVED BY THE LANDSCAPE ARCHITECT AND/OR OWNER, ON SLOPES, SHRUB BEDS SHALL BE FASHIONED TO ALLOW FOR PROPER DRAINAGE.

TOPSOIL & FINE GRADING

THE CONTRACTOR SHALL PLACE ISOMM OF RICH TOPSOIL ON APPROVED SUBGRADES. TOPSOIL SHALL BE IMPORTED WHERE REQUIRED. 10-6-4 FERTILIZER SHALL BE APPLIED ACCORDING TO THE MANUFACTURER'S INSTRUCTIONS AT A RATE OF 7.32  $kg/IOOm^2$  FOR SODDED AREAS, THE MIXTURE AND RATE OF APPLICATION SHALL BE ADJUSTED FOR SEEDED AREAS.

MINOR GRADE DEFICIENCIES AND IRREGULARITIES SHALL BE ELIMINATED PRIOR TO

THE CONTRACTOR SHALL SOD ALL AREAS SO INDICATED ON THE DRAWINGS. SOD SHALL BE FRESHLY CUT NO.1 GRADE NURSERY-GROWN TURF 50-75mm THICK SOD FOR SUNNY, EXPOSED AREAS SHALL BE 50% KENTUCKY BLUEGRASS AND 50% MERION BLUEGRASS. SOD FOR SHADED AREAS SHALL BE 50% NUGGET KENTUCKY BLUEGRASS AND 50% CREEPING RED FESCUE. SOD SHALL BE PLACED ON PREPARED TOPSOIL, WITH JOINTS STAGGERED AND SECTIONS ABUTTED TIGHTLY. IMMEDIATELY AFTER LAYING, IRRIGATION SUFFICIENT TO ENSURE MOISTURE PENETRATION TO A DEPTH OF 100mm SHALL BE APPLIED. SOD SHALL BE MACHINE ROLLED TO ENSURE UNIFORM CONTACT WITH TOPSOIL

SOD ON ALL SLOPES SHALL BE PEGGED WHERE REQUIRED.

#### HARD LANDSCAPING

POURED-IN-PLACE CONCRETE WORK THE CONTRACTOR SHALL OBTAIN WRITTEN APPROVAL OF FORMWORK PRIOR TO POURING CONCRETE. ALL CONCRETE, STEEL REINFORCING, AND FORMWORK SHALL BE AS DETAILED AND SPECIFIED ON THE DRAWINGS.

THE STYLE, COLOUR, AND FINISH OF CONCRETE ELEMENTS SHALL BE APPROVED BY THE OWNER AND/OR LANDSCAPE ARCHITECT PRIOR TO THE COMMENCEMENT OF CONCRETE ALL STRUCTURAL CONCRETE WORK SHALL CONFORM TO LOCAL BUILDING CODES AND

BRICKWORK, STONEWORK & CONCRETE UNIT PAVING WHERE APPLICABLE, THE CONTRACTOR SHALL OBTAIN WRITTEN APPROVAL FROM THE LANDSCAPE ARCHITECT OF ALL STRUCTURAL CONCRETE WORK BEFORE COMMENCING BRICKHORK, STONEWORK OR PAVING WORK. ALL BRICKHORK, STONEWORK, AND CONCRETE UNIT PAVING SHALL BE AS DETAILED AND SPECIFIED ON THE DRAWINGS, UNLESS THE LANDSCAPE ARCHITECT AND/OR THE OWNER APPROVE SUBSTITUTIONS IN WRITING.

PRIOR TO STARTING THIS PORTION OF WORK, THE CONTRACTOR SHALL SUBMIT SAMPLES OF ALL PROPOSED BRICKWORK, STONEWORK, AND CONCRETE UNIT PAVERS FOR APPROVAL BY THE LANDSCAPE ARCHITECT AND/OR THE OWNER WITH RESPECT TO STYLE, COLOUR, AND FINISH. THE CONTRACTOR MAY ALSO BE ASKED TO SUBMIT SAMPLES OF ALTERNATIVES TO THE MATERIALS SPECIFIED ON THE DRAWINGS.

ALL BRICKWORK, STONEWORK, AND CONCRETE UNIT PAVING SHALL CONFORM TO LOCAL BUILDING CODES AND OTHER MUNICIPAL REQUIREMENTS.

**WOODWORK** ALL WOOD SHALL BE NO. I GRADE DRESSED CLEAR CEDAR, PRESSURE-TREATED RED PINE, OR PRESSURE-TREATED JACK PINE, AS SPECIFIED ON THE DRAWINGS. PRESSURE TREATMENT SHALL BE FACTORY-APPLIED COPPER CHROME ARSENATE CLEAR CEDAR OR SPECIALTY WOODS SHALL BE STAINED WITH TWO (2) COATS OF STAIN, PAINT OR PRESERVATIVE.

THE CONTRACTOR SHALL SUBMIT SAMPLES OF ALL PROPOSED FINISHES FOR APPROVAL BY THE LANDSCAPE ARCHITECT AND/OR THE OWNER PRIOR TO ITS APPLICATION. THE CONTRACTOR MAY ALSO BE ASKED TO SUBMIT SAMPLES OF ALTERNATIVES TO THE MATERIALS OR FINISHES SPECIFIED ON THE DRAWINGS.

#### MAINTENANCE

THE CONTRACTOR SHALL MAINTAIN ALL LANDSCAPED AREAS FOR A PERIOD OF FOUR (4) GROWING MONTHS FROM THE DATE OF SUBSTANTIAL COMPLETION. MAINTENANCE SHALL INCLUDE:

NANCE SHALL INCLUDE:
PROPER IRRIGATION TO ENSURE OPTIMUM GROWTH OF TREES, SHRUBS, AND SOD
GRASS MOWING TO MAINTAIN AN APPROXIMATE HEIGHT OF 50mm
THE CULTIVATION AND WEEDING OF TREE PITS AND PLANTING BEDS

AT THE END OF THE SPECIFIED MAINTENANCE PERIOD, PROVIDED ALL PLANT MATERIAL IS ALIVE AND IN A HEALTHY GROWING CONDITION, THE OWNER WILL ASSUME THE RESPONSIBILITY OF MAINTAINING THE LANDSCAPE WORK.

#### PERFORMANCE ACCEPTANCE (SUBSTANTIAL COMPLETION)

WRITTEN NOTICE OF PERFORMANCE ACCEPTANCE BY THE LANDSCAPE ARCHITECT FOR SUBSTANTIAL COMPLETION OF THE PROJECT LANDSCAPE WORKS SHALL MARK THE START OF THE GUARANTEE PERIOD.

SHOULD LOCAL LAW REQUIRE MUNICIPAL ACCEPTANCE, THE LANDSCAPE ARCHITECT WILL SUBMIT THE SUBSTANTIAL COMPLETION CERTIFICATE TO THE MUNICIPALITY SO THAT THEY MAY PROCEED TO INSPECT THE WORK, ISSUE THEIR PERFORMANCE ACCEPTANCE CERTIFICATE, AND REDUCE THE AMOUNT OF SECURITIES. <u>GUARANTEE</u>


ALL PLANT MATERIAL SHALL BE GUARANTEED FOR ONE (I) YEAR FROM THE DATE ON THE PERFORMANCE ACCEPTANCE CERTIFICATE ISSUED BY THE LANDSCAPE ARCHITECT. PLANTS THAT EXPIRE OR OTHERWISE FAIL TO THRIVE DURING THE GUARANTEE PERIOD SHALL BE REPLACED AT THE EXPENSE OF THE CONTRACTOR SIMII ARI Y ALL OTHER LANDSCAPE WORK PERFORMED UNDER THIS CONTRACT SHALL BE


FULLY GUARANTEED FOR ONE (I) YEAR FROM THE DATE OF PERFORMANCE. ACCEPTANCE

#### BY THE LANDSCAPE ARCHITECT. FINAL ACCEPTANCE

OUTSTANDING LANDSCAPE SECURITIES.


ALL WORK SHALL BE INSPECTED AT THE END OF THE GUARANTEE PERIOD BY THE LANDSCAPE ARCHITECT. ANY DEFICIENCIES SHALL BE RECTIFIED BY THE CONTRACTOR TO THE SATISFACTION OF THE LANDSCAPE ARCHITECT AND THE OWNER, THE LANDSCAPE ARCHITECT WILL THEN ISSUE A FINAL ACCEPTANCE CERTIFICATE. SHOULD LOCAL LAW REQUIRE MUNICIPAL ACCEPTANCE, THE LANDSCAPE ARCHITECT WILL SHOULD LOCAL LAW REQUIRE MUNICIPAL ACCEPTIANCE, THE LANDSCAPE ARCHITECT WILL SUBMIT THE FINAL ACCEPTANCE CERTIFICATE TO THE MUNICIPALITY SO THAT THEY MAY PROCEED TO INSPECT THE WORK, GIVE FINAL APPROVAL, AND RELEASE ALL

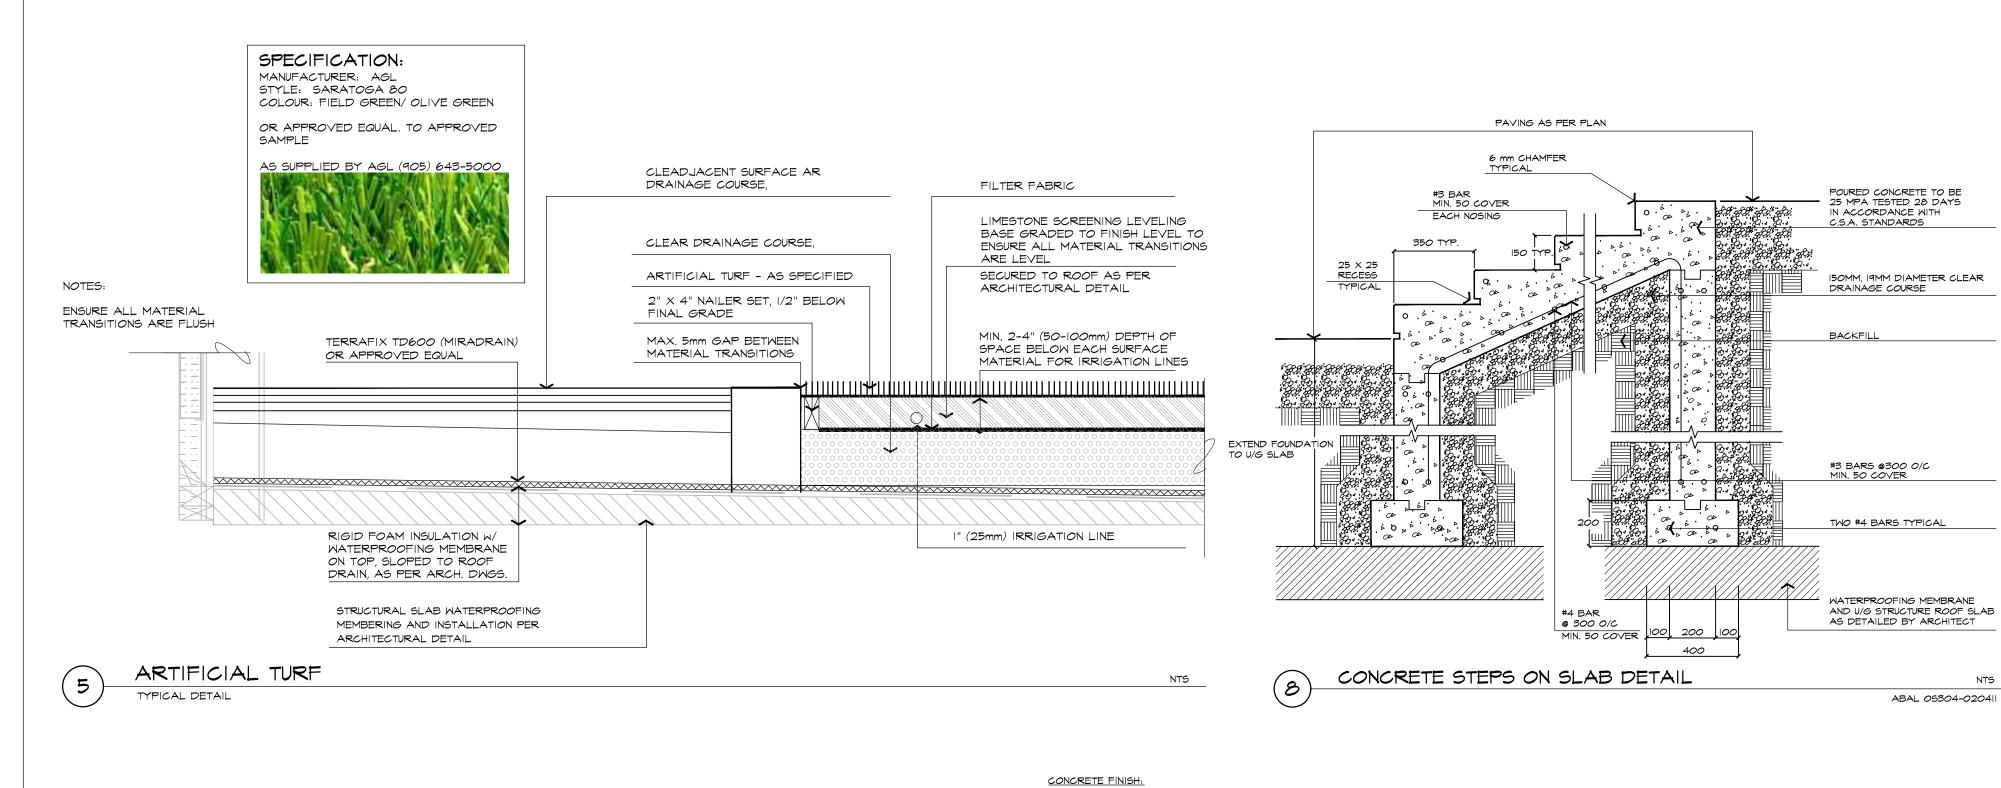

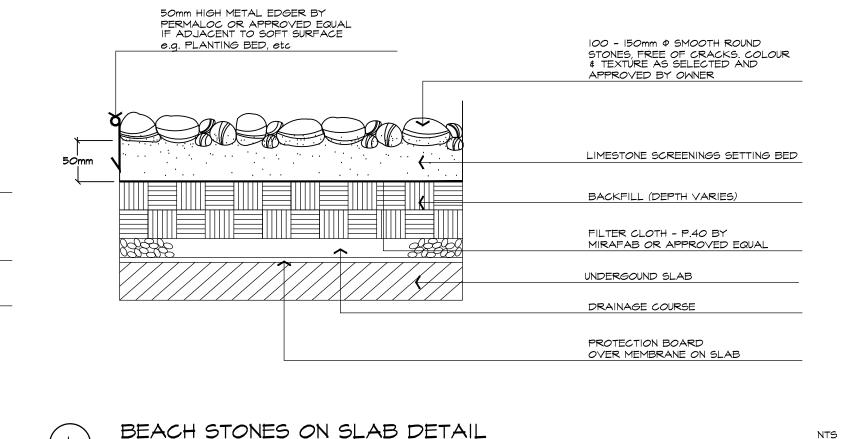





32 MPA POURED CONCRETE - EXPANSION JOINTS EVERY 6000mm CONTROL JOINTS EVERY 1500mm FINISH AS SPECIFIED TROWEL JOINTS UNLESS OTHERWISE SPECIFIED INSTALL I9mm EXPANSION JOINTS ADJACENT TO CONCRETE

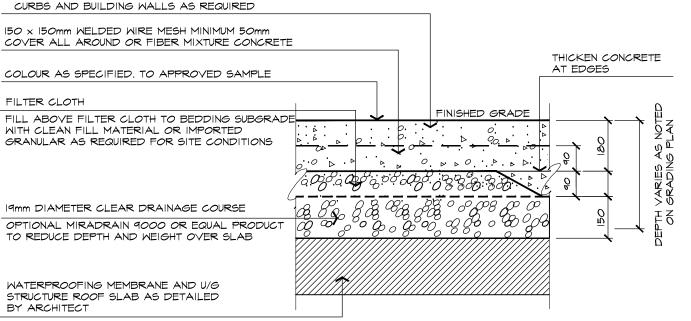

HEAVY-DUTY CONCRETE PAVING

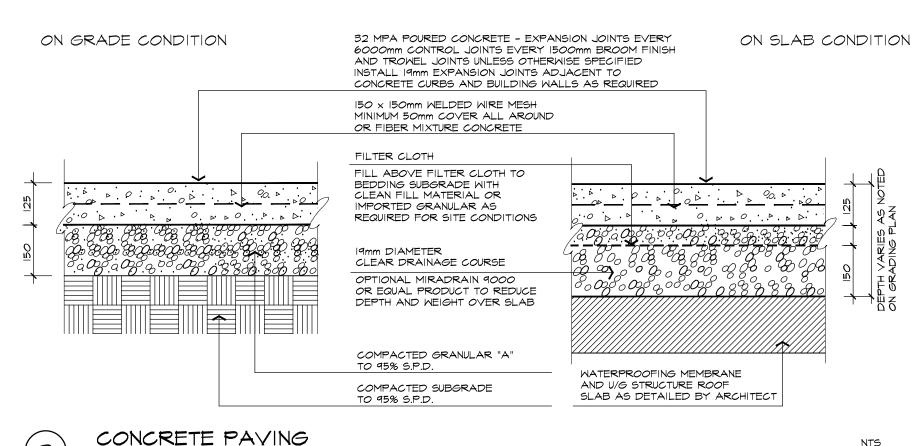

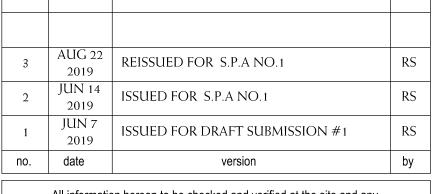

All information hereon to be checked and verified at the site and any discrepancies must be reported to and clarified by the landscape architect before commencing work. All drawings, specifications, details, digital information, etc., prepared by the landscape architect are instruments of service and as such are his property and must be returned at his request.



LEXANDER BUDREVI LANDSCAPE ARCHITECTS 895 Don Mills Road, Second Tower, Suite 212 Toronto, Ontario, Canada, M3C 1W3 **4** 416.444.5201 **\$** 416.444.5208

www.budrevics.com

project

ABAL 05102-991122


308-314 JARVIS STREET & 225 MUTUAL STREET TORONTO, ONTARIO


GRAYWOOD DEV.'S / ALTERRA GROUP

ABAL 05202X-170424

# HARDSCAPING DETAILS

drawn RS
file 3298 D3 V3-190822
project no.
3298
sheet no.
D3

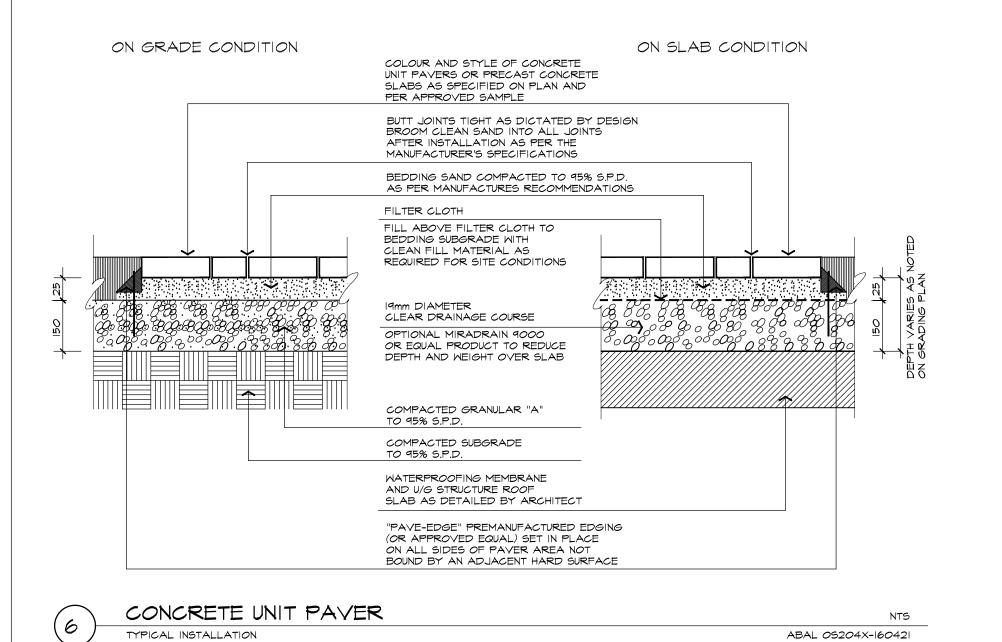

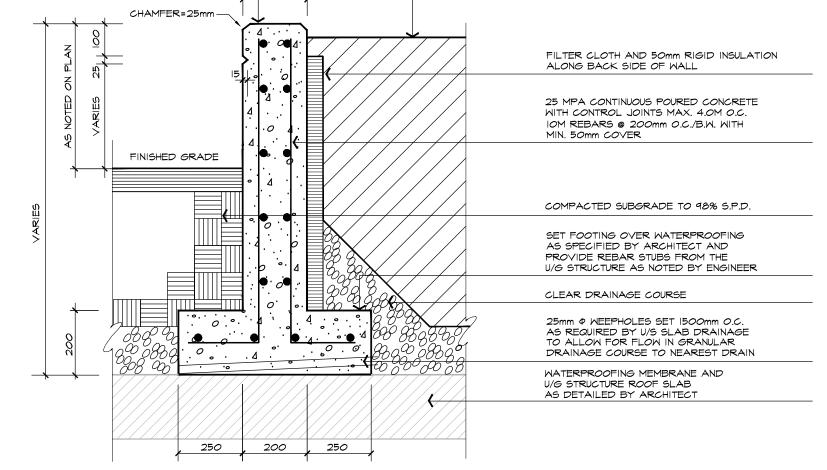

PLANTING MIX AS SPECIFIED

GENERAL NOTES: REPLACE 150mm OF 19mm ¢ CLEAR CRUSHED STONES OVER UNDERGROUND STRUCTURE SLAB WITH "MIRADRAIN 9000" AS MANUFACTURED BY MIRAFI INC. OR APPROVED EQUAL IF REQUIRED TO ACHIEVE REDUCED OVERALL COVERAGE DEPTH

- 2. APPROVED SHOP DRAWINGS FOR POURED OR PRECAST DECORATIVE PLANTER CURB MUST BE STAMPED BY A STRUCTURAL ENGINEER AND BE SUBMITTED FOR MUNICIPAL LANDSCAPE APPROVAL
- 3. CONCRETE FINISH IN ABSENCE OF ARCHITECTURAL SPECIFICATION FOR DECORATIVE CONCRETE COLOUR AND TEXTURE, LANDSCAPE ARCHITECT TO APPROVE SAMPLE.

DECORATIVE PLANTER ABAL 0560|X-17042|

**APPENDIX V** 

**Sun Shadow Study** 







1 MARCH 21-0918 AM 1:2000



3 MARCH 21-1118 AM 1:2000



2 SPAB11 1:2000



(4) MARCH 21-1218 PM 1:2000

SCALE 0m 20m 50m 100m 200m 1:2000

# <u>LEGEND</u>

Shadow of the Proposed Scheme (June 14, 2019)

Shadow of Proposed Scheme that exceeds boundary of Settlement Scheme (November 28,2017)

Shadow of the Settlement Scheme (November 28,2017)

TURNER FLEISCHER

> 67 Lesmill Road Toronto, ON, M3B 2T8 T 416 425 2222 turnerfleischer.com

This drawing, as an instrument of service, is provided by and is the property of Turner Fleischer Architects Inc.

The contractor must verify and accept responsibility for all dimensions and conditions on site and must notify
Turner Fleischer Architects Inc. of any variations from the supplied information. This drawing is not to be
scaled. The architect is not responsible for the accuracy of survey, structural, mechanical, electrical, etc.,
information shown on this drawing. Refer to the appropriate consultant's drawings before proceeding with
the work. Construction must conform to all applicable codes and requirements of authorities having
jurisdiction. The contractor working from drawings not specifically marked 'For Construction' must assume
full responsibility and bear costs for any corrections or damages resulting from his work.

1 | 2019-06-14 | ISSUED FOR SPA # | DATE | DESCRIPTION





PHANTOM DEVELOPMENTS

**Street**Toronto, Ontario, Canada

Toronto, Ontano, Cana


SHADOW STUDY - MARCH

(DAYLIGHT SAVING TIME)


18.189CS
PROJECT DATE
2019-04-09
DRAWN BY
SRS
CHECKED BY
AYU
SCALE

1:2000




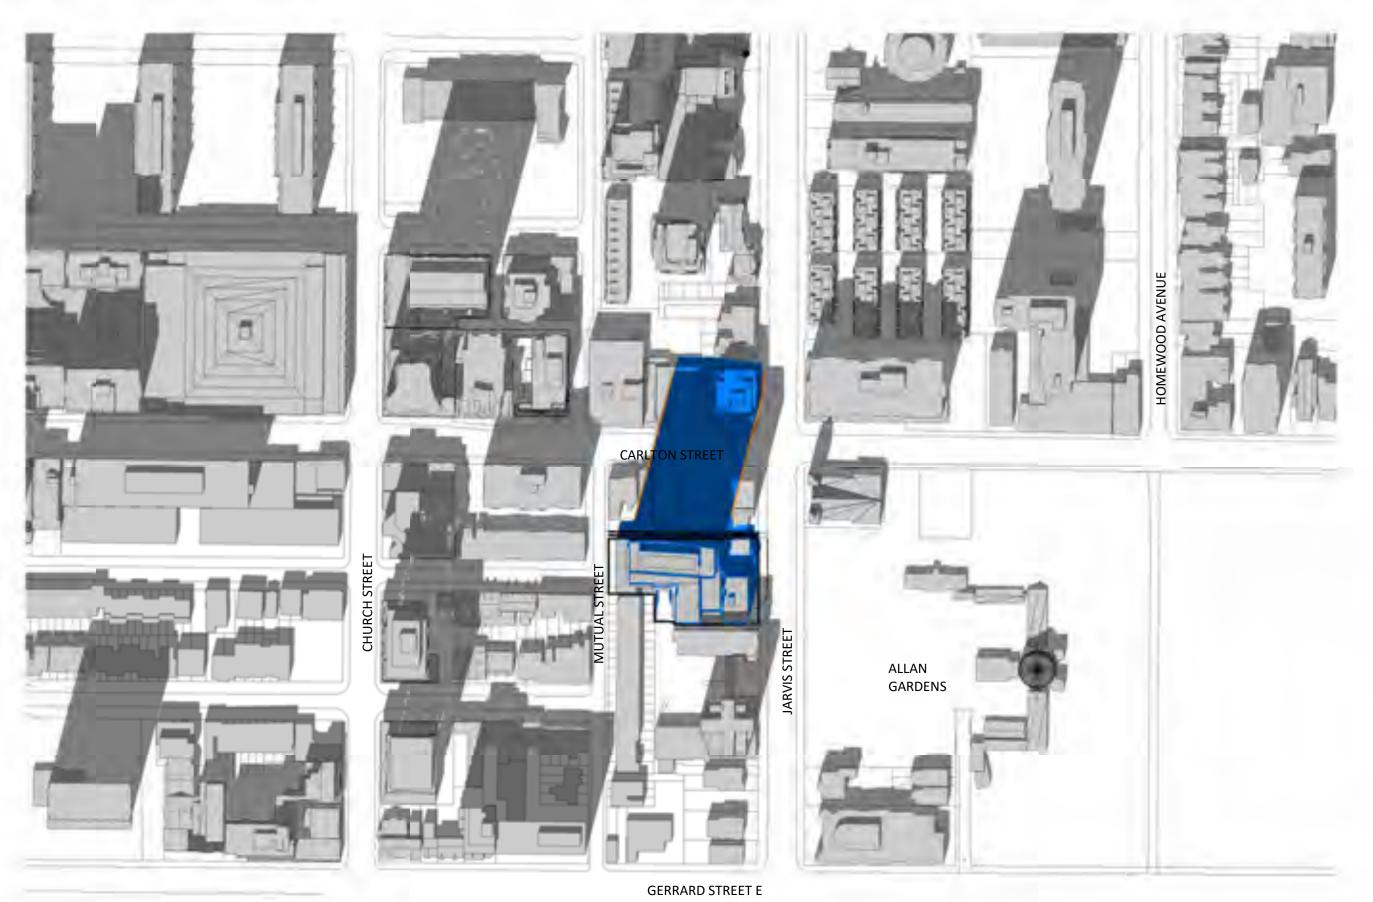


1 MARCH 21-1318 PM 1:2000

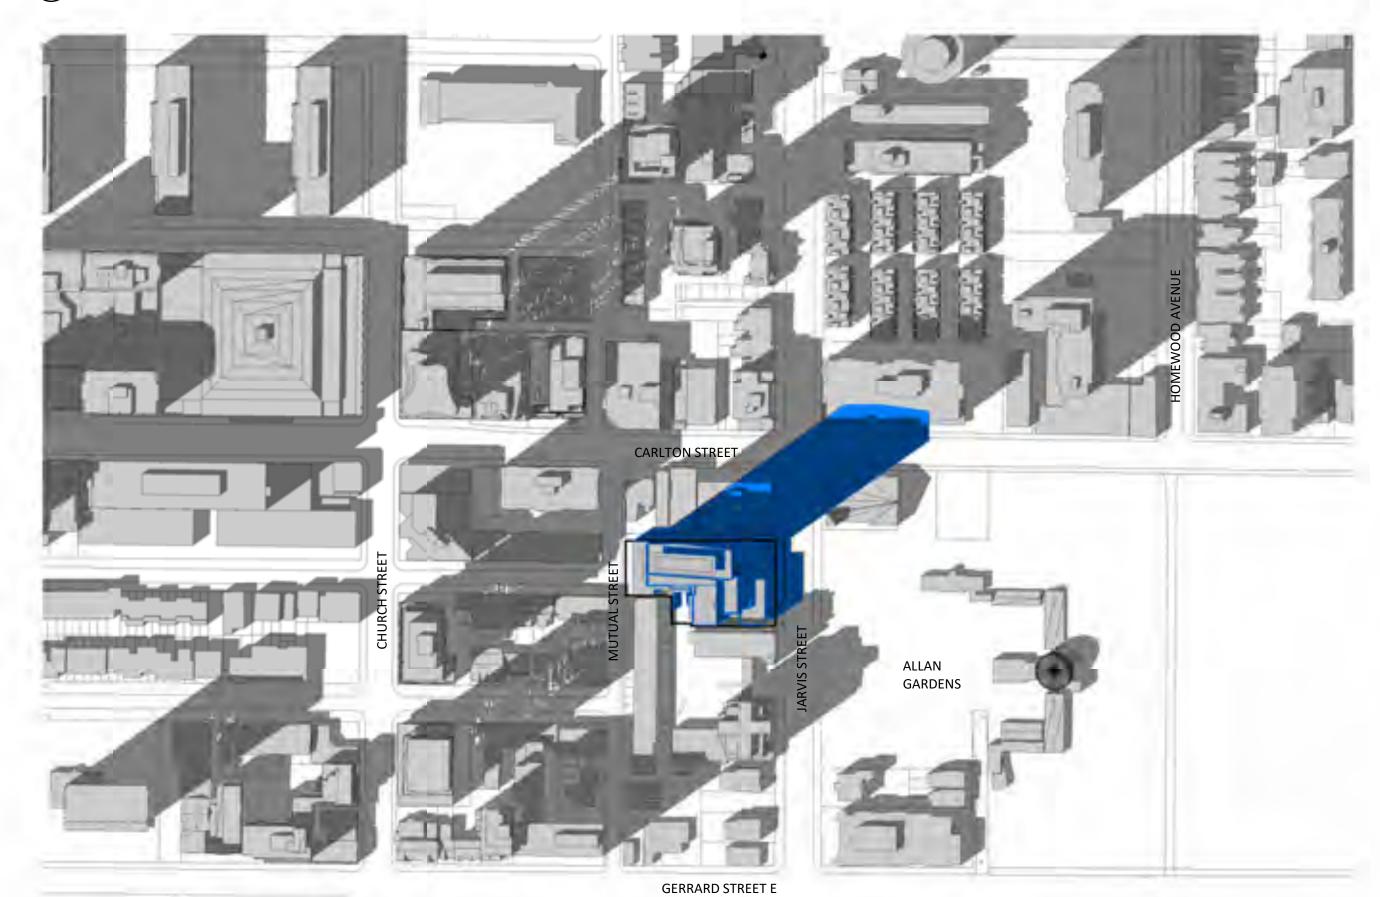

3 MARCH 21-1518 PM 1:2000

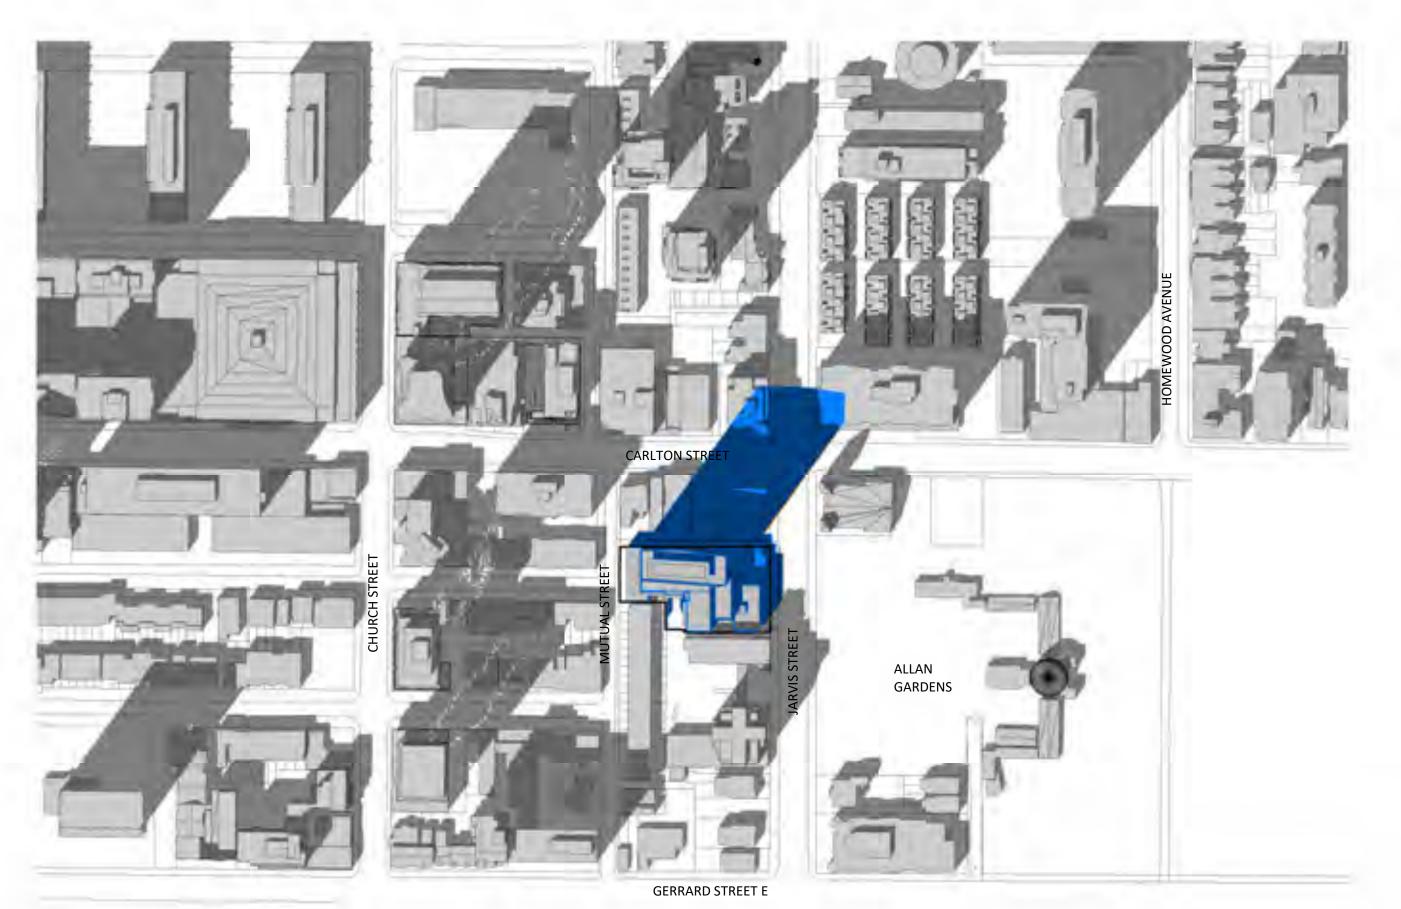


2 SPA812 MARCH 21-1418 PM 1:2000

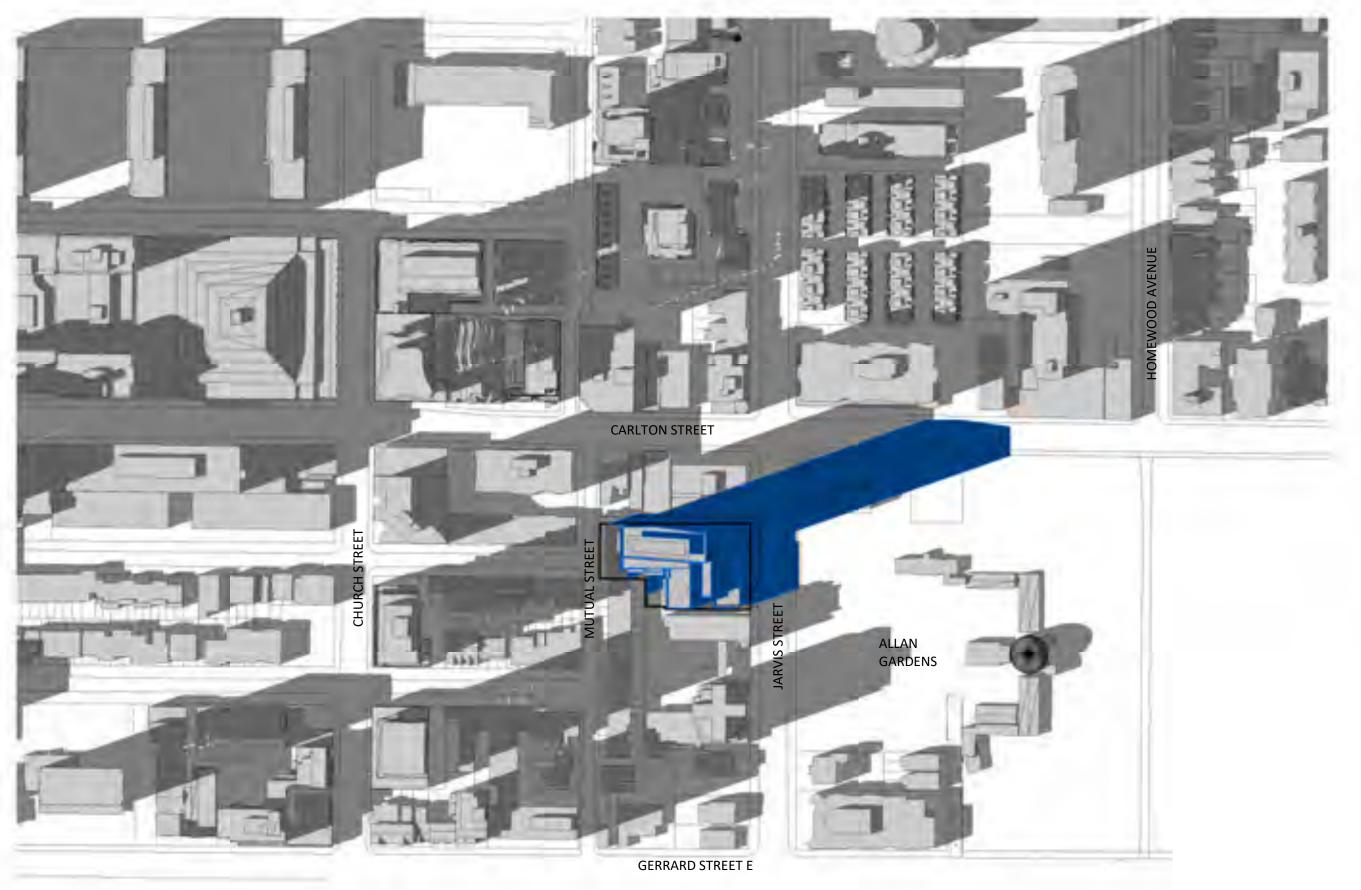

4 MARCH 21-1618 PM 1:2000

<u>LEGEND</u>

Shadow of the Proposed Scheme (June 14, 2019)

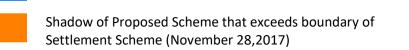

Shadow of the Settlement Scheme (November 28,2017)

# TURNER FLEISCHER

67 Lesmill Road Toronto, ON, M3B 2T8 T 416 425 2222 turnerfleischer.com

This drawing, as an instrument of service, is provided by and is the property of Turner Fleischer Architects Inc. The contractor must verify and accept responsibility for all dimensions and conditions on site and must notify Turner Fleischer Architects Inc. of any variations from the supplied information. This drawing is not to be scaled. The architect is not responsible for the accuracy of survey, structural, mechanical, electrical, etc., information shown on this drawing. Refer to the appropriate consultant's drawings before proceeding with the work. Construction must conform to all applicable codes and requirements of authorities having jurisdiction. The contractor working from drawings not specifically marked 'For Construction' must assume full responsibility and bear costs for any corrections or damages resulting from his work.

1 | 2019-06-14 | ISSUED FOR SPA | AY | # | DATE | DESCRIPTION |



308-314 Jarvis Street & 225 Mutual
Street

PHANTOM DEVELOPMENTS

Toronto, Ontario, Canada


SHADOW STUDY - MARCH

(DAYLIGHT SAVING TIME)


PROJECT NO.
18.189CS
PROJECT DATE
2019-04-09
DRAWN BY
SRS
CHECKED BY
AYU

1:2000



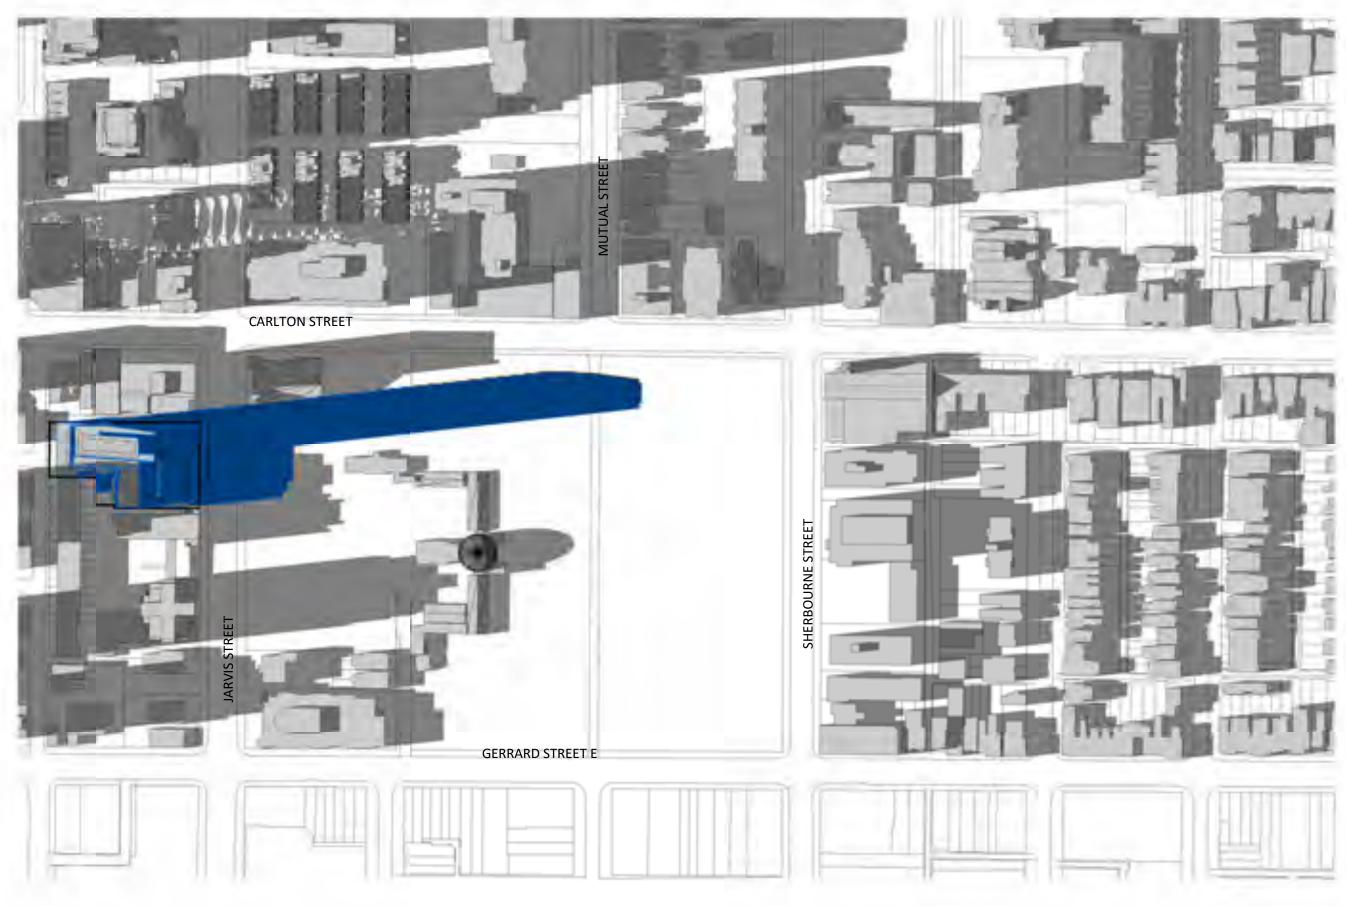



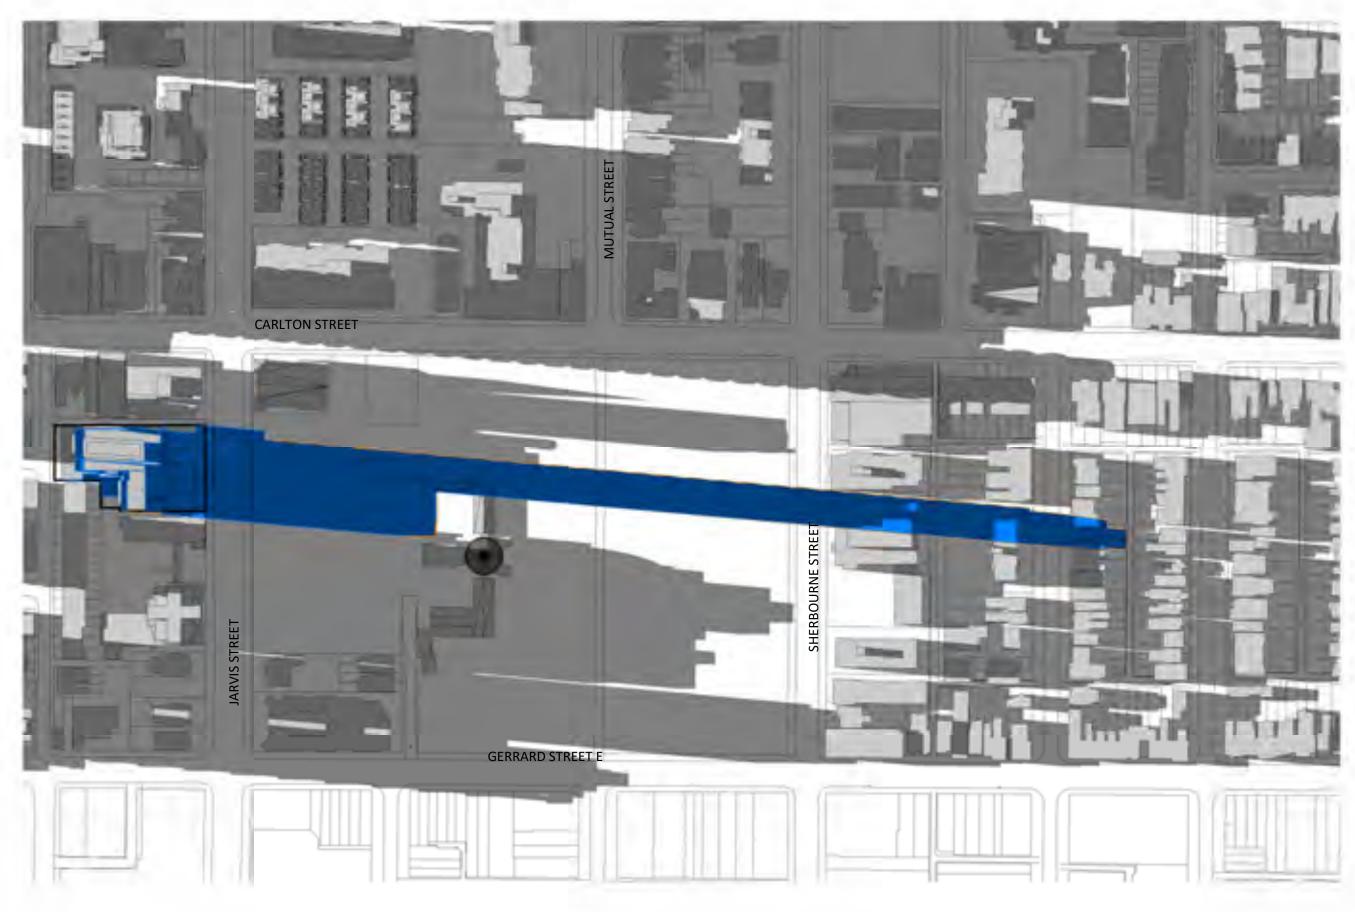

2 SPA813 MARCH 21-1818 PM 1:2000



# **LEGEND**

Shadow of the Proposed Scheme (June 14, 2019)

Shadow of Proposed Scheme that exceeds boundary of Settlement Scheme (November 28,2017)

Shadow of the Settlement Scheme (November 28,2017)

# TURNER FLEISCHER

67 Lesmill Road Toronto, ON, M3B 2T8 T 416 425 2222 turnerfleischer.com

This drawing, as an instrument of service, is provided by and is the property of Turner Fleischer Architects Inc.
The contractor must verify and accept responsibility for all dimensions and conditions on site and must notify
Turner Fleischer Architects Inc. of any variations from the supplied information. This drawing is not to be
scaled. The architect is not responsible for the accuracy of survey, structural, mechanical, electrical, etc.,
information shown on this drawing. Refer to the appropriate consultant's drawings before proceeding with
the work. Construction must conform to all applicable codes and requirements of authorities having
jurisdiction. The contractor working from drawings not specifically marked 'For Construction' must assume
full responsibility and bear costs for any corrections or damages resulting from his work.




Toronto, Ontario, Canada

SHADOW STUDY - MARCH


(DAYLIGHT SAVING TIME)

PROJECT NO. 18.189CS PROJECT DATE 2019-04-09 DRAWN BY
SRS
CHECKED BY
AYU
SCALE 1:2000




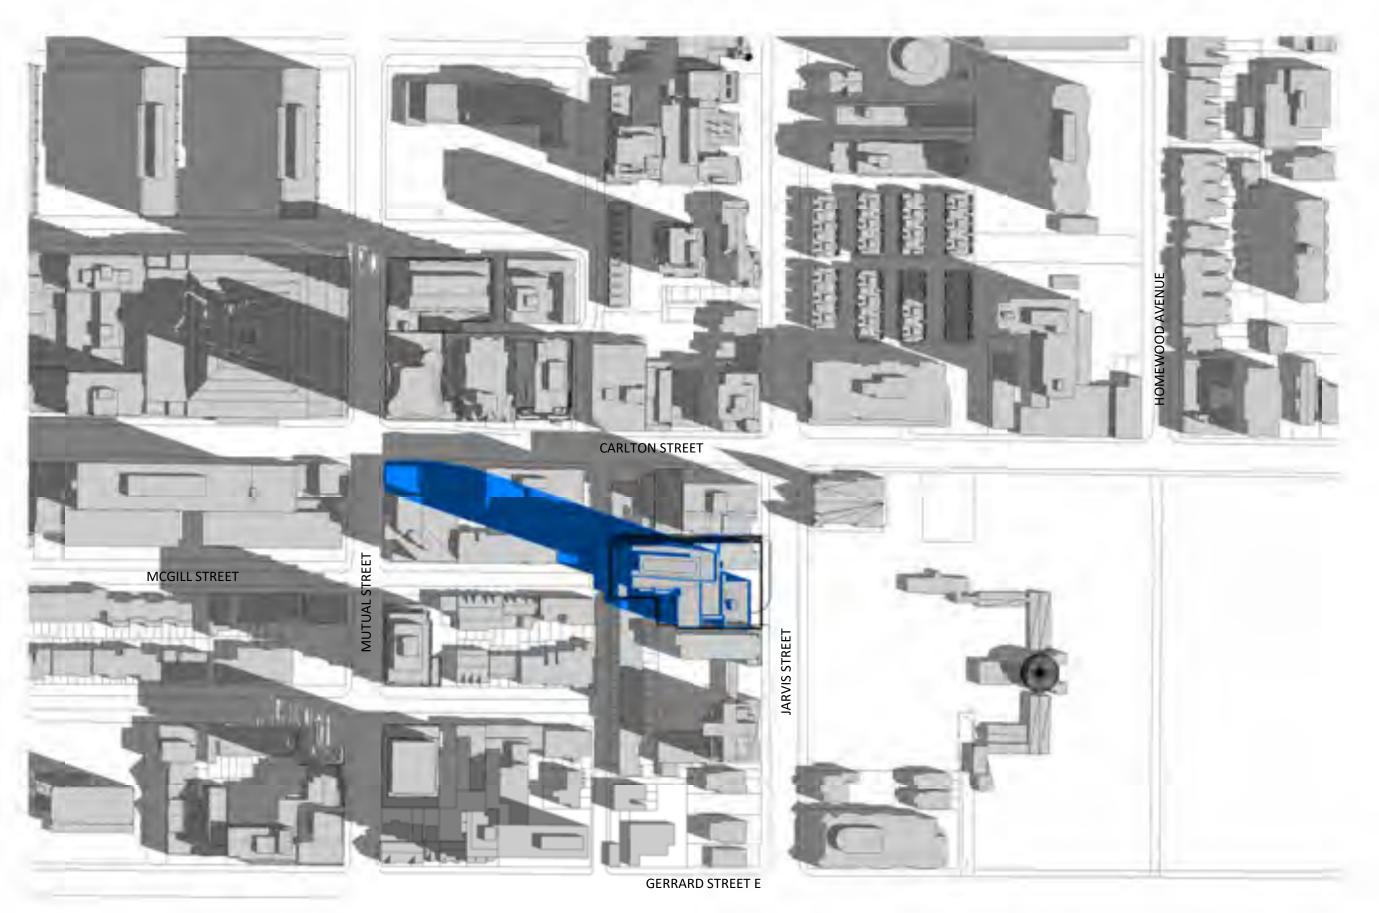


JUNE 21-0918 AM
1: 2000

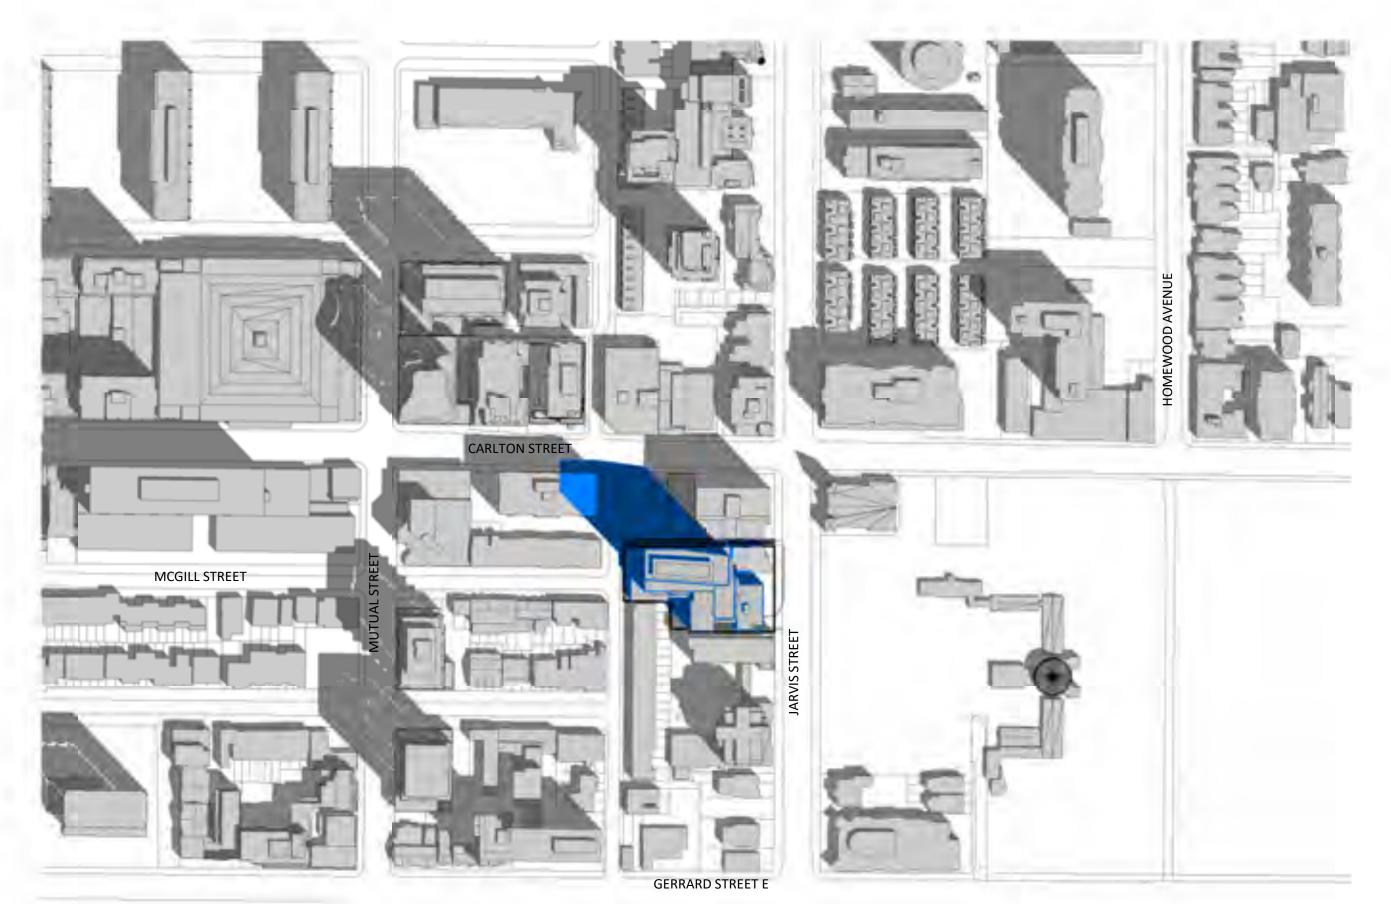

3 JUNE 21-1118 AM 1:2000

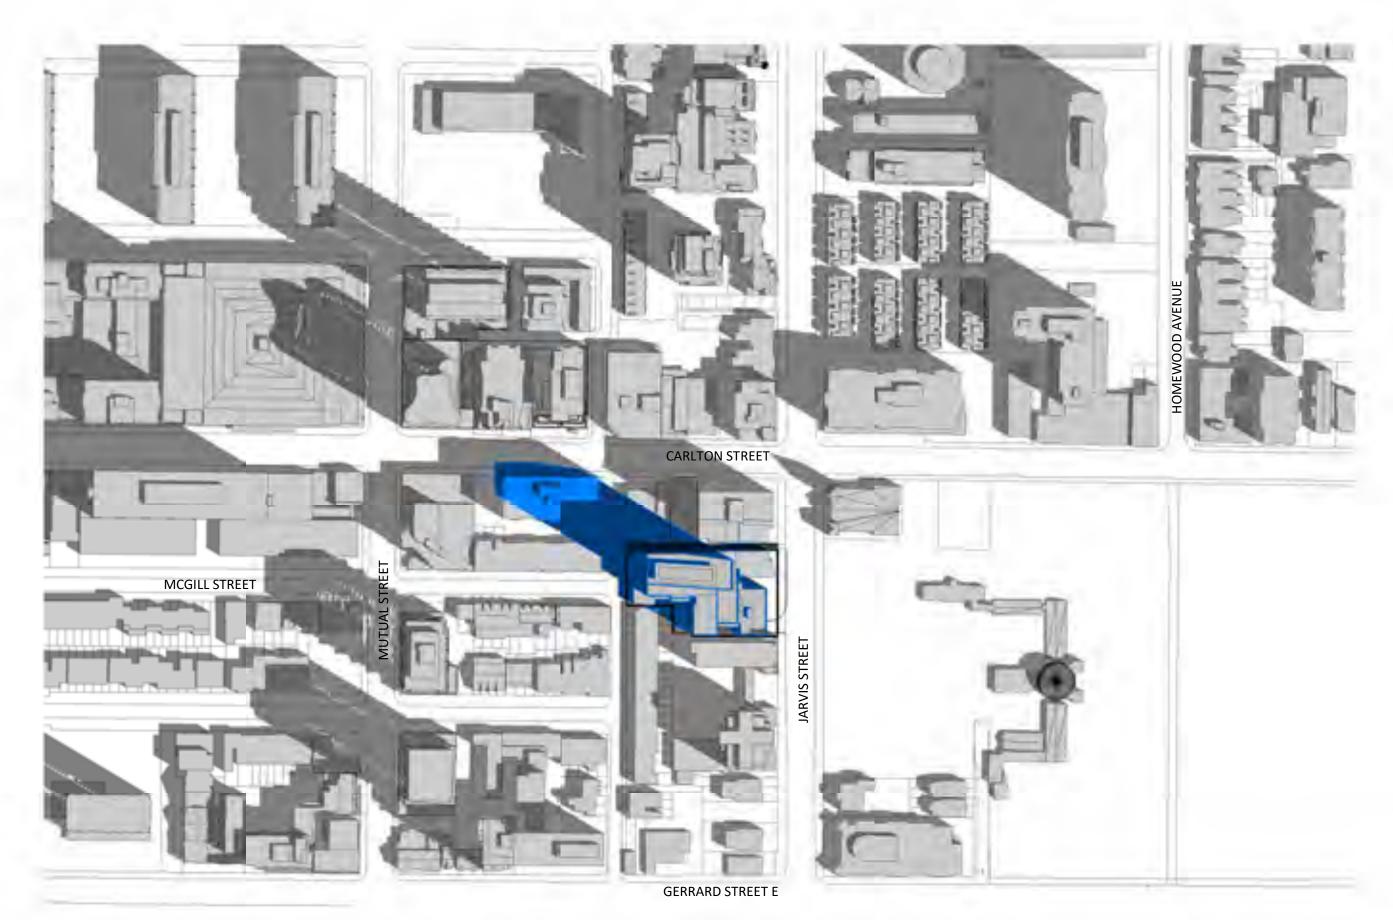

JUNE 21-1018 AM
1:2000

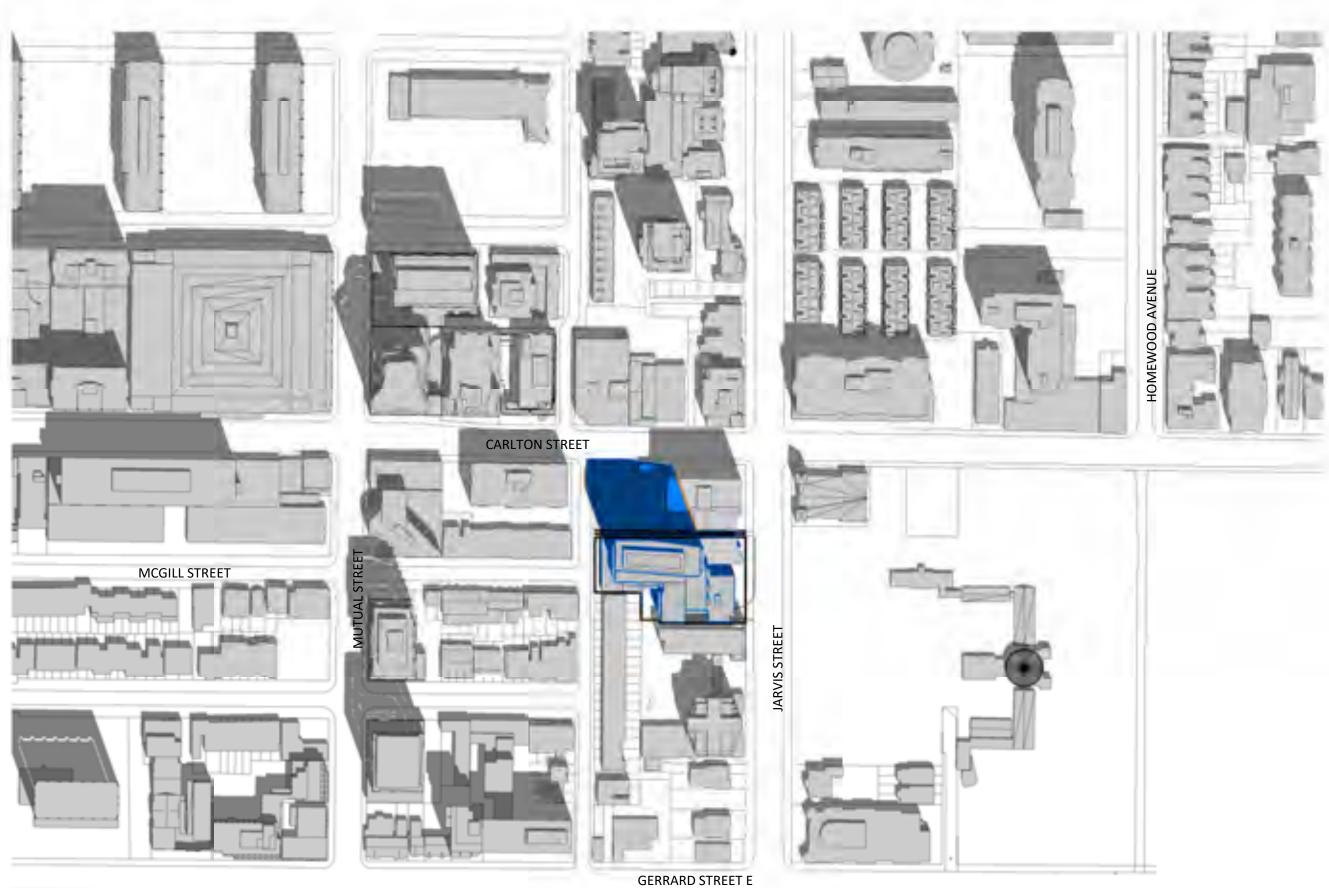

JUNE 21-1218 PM
1:2000

SCALE 0m 20m 50m 100m 200m 1:2000

# <u>LEGEND</u>

Shadow of the Proposed Scheme (June 14, 2019)

Shadow of Proposed Scheme that exceeds boundary of Settlement Scheme (November 28,2017)

Shadow of the Settlement Scheme (November 28,2017)

TURNER FLEISCHER

> 67 Lesmill Road Toronto, ON, M3B 2T8 T 416 425 2222 turnerfleischer.com

This drawing, as an instrument of service, is provided by and is the property of Turner Fleischer Architects Inc. The contractor must verify and accept responsibility for all dimensions and conditions on site and must notify Turner Fleischer Architects Inc. of any variations from the supplied information. This drawing is not to be scaled. The architect is not responsible for the accuracy of survey, structural, mechanical, electrical, etc., information shown on this drawing. Refer to the appropriate consultant's drawings before proceeding with the work. Construction must conform to all applicable codes and requirements of authorities having jurisdiction. The contractor working from drawings not specifically marked 'For Construction' must assume full responsibility and bear costs for any corrections or damages resulting from his work.

1 | 2019-06-14 | ISSUED FOR SPA | # | DATE | DESCRIPTION



308-314 Jarvis Street & 225 Mutual Street


Toronto, Ontario, Canada

SHADOW STUDY - JUNE
(DAYLIGHT SAVING TIME)


PROJECT NO.
18.189CS
PROJECT DATE
2019-04-09
DRAWN BY
SRS
CHECKED BY
AYU
SCALE

1:2000




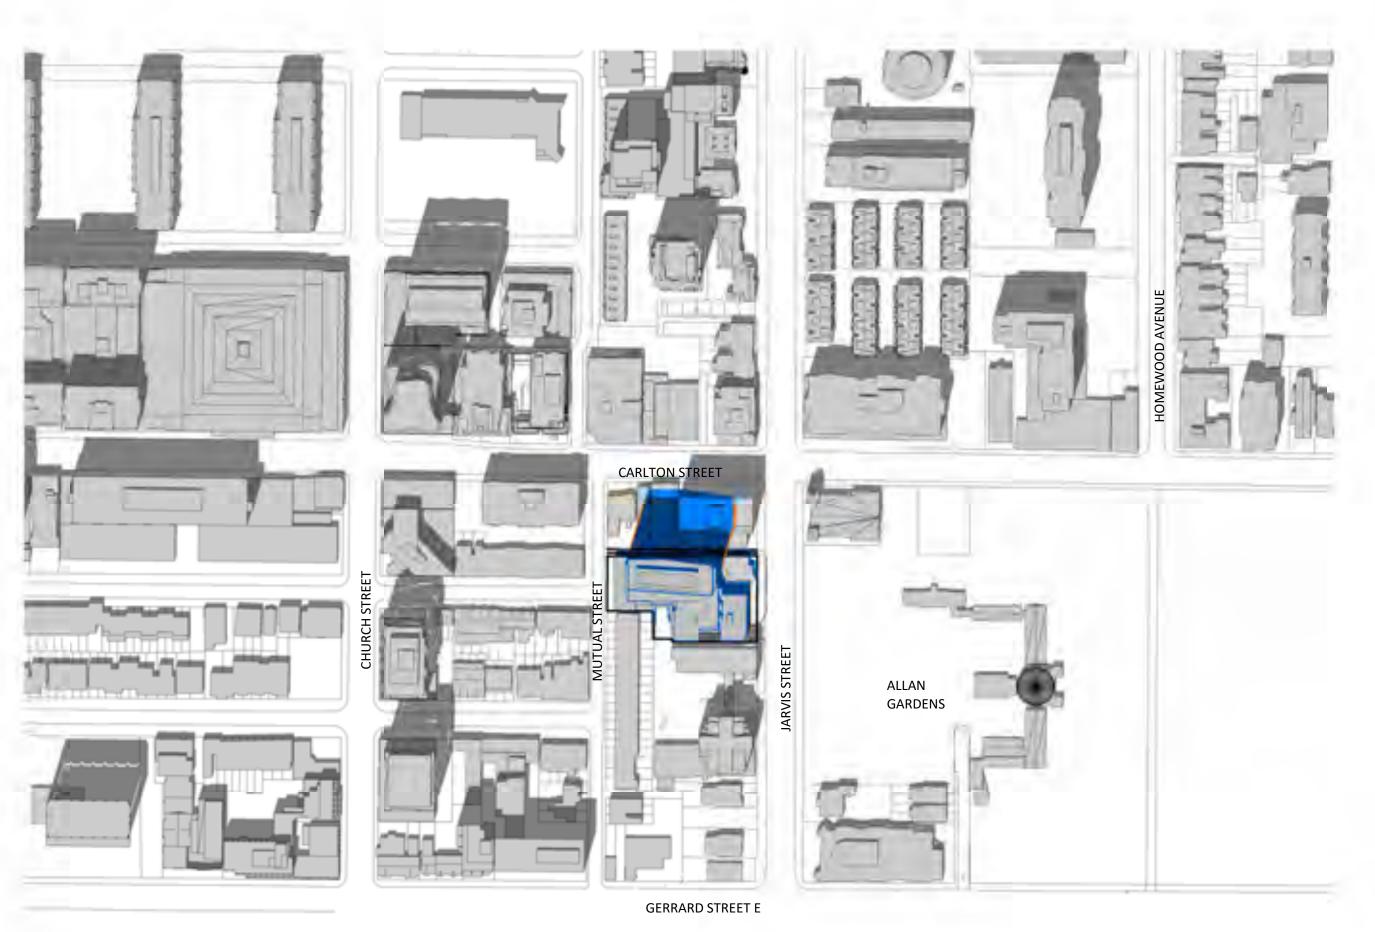




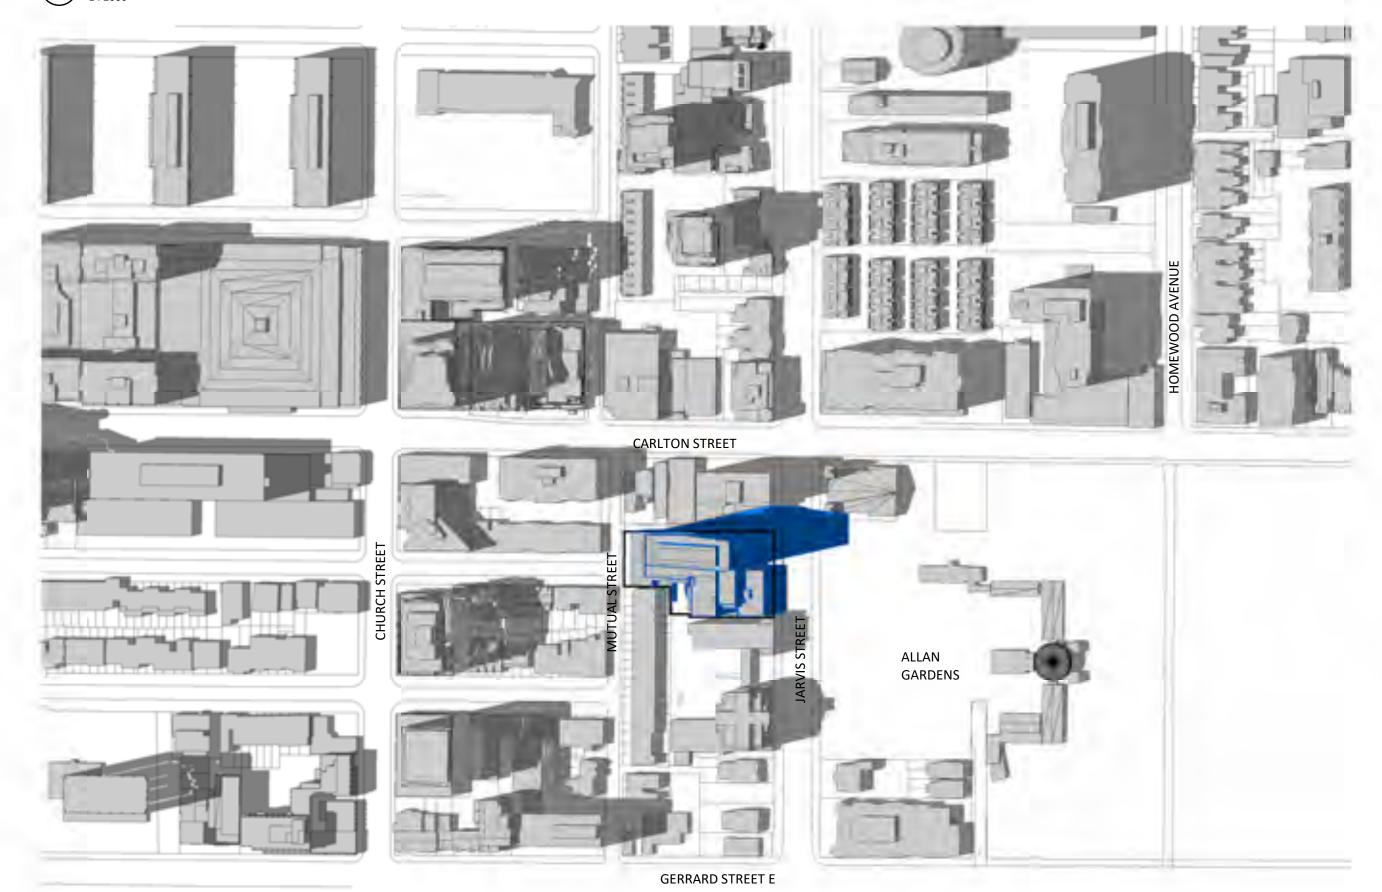

3 JUNE 21-1518 PM 1:2000

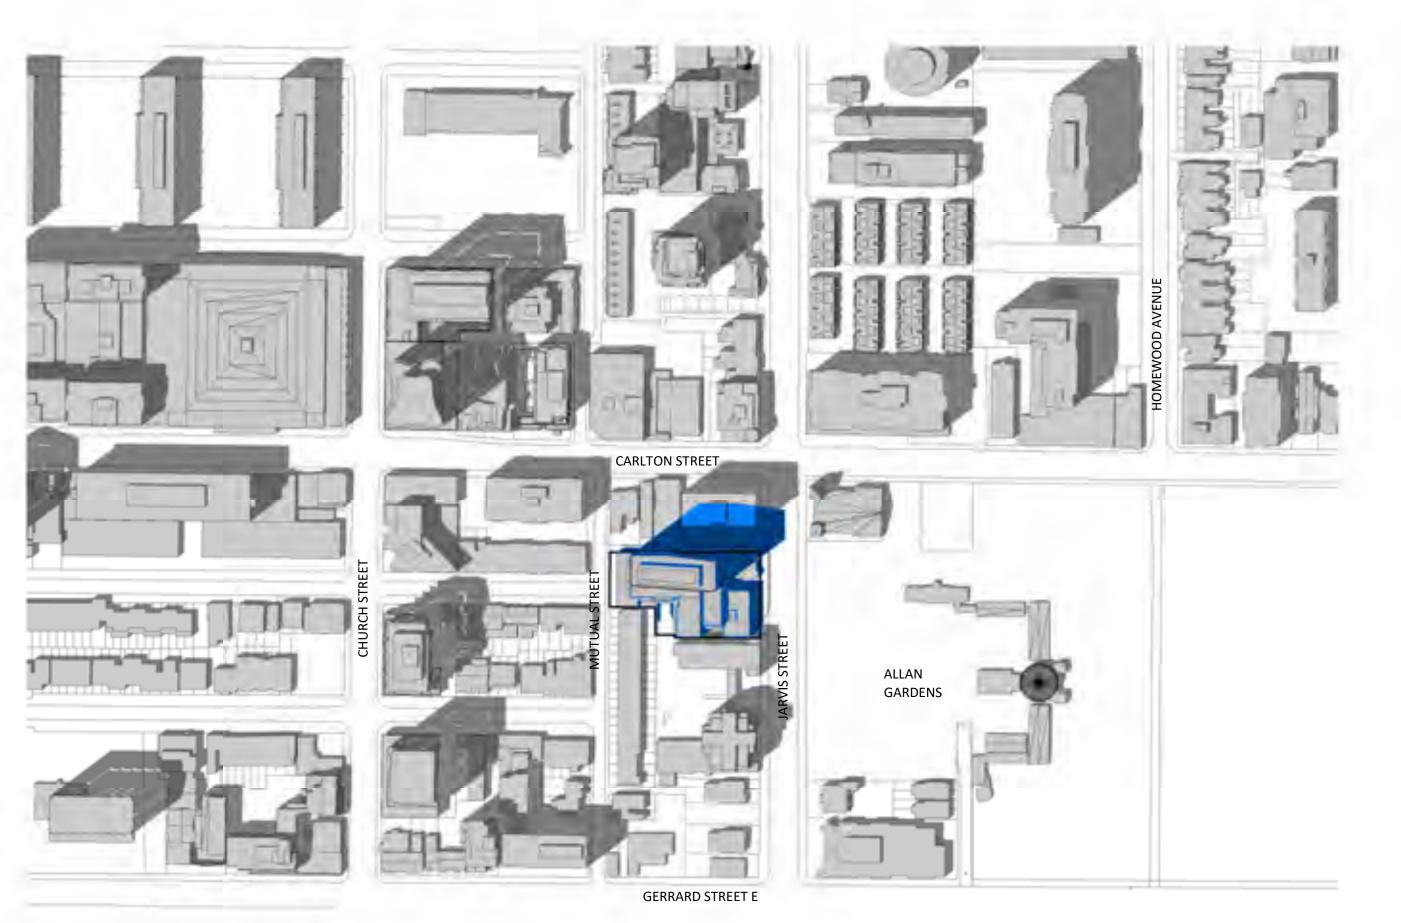

2 JUNE 21-1418 PM 1:2000

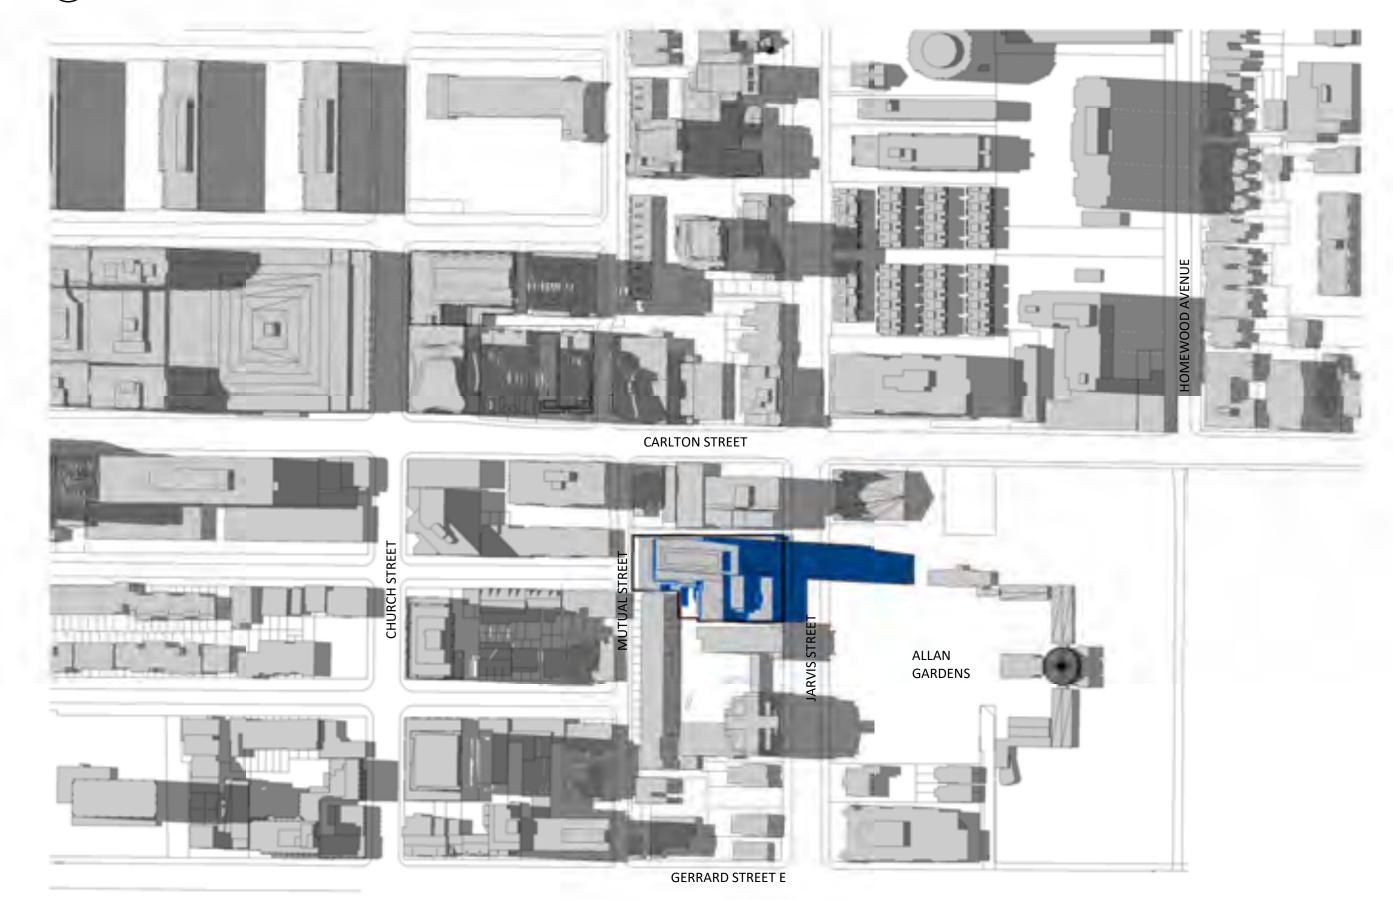

JUNE 21-1618 PM
1:2000



# **LEGEND**

Shadow of the Proposed Scheme (June 14, 2019)

Shadow of Proposed Scheme that exceeds boundary of Settlement Scheme (November 28,2017)

Shadow of the Settlement Scheme (November 28,2017)



67 Lesmill Road Toronto, ON, M3B 2T8 T 416 425 2222 turnerfleischer.com

This drawing, as an instrument of service, is provided by and is the property of Turner Fleischer Architects Inc. The contractor must verify and accept responsibility for all dimensions and conditions on site and must notify Turner Fleischer Architects Inc. of any variations from the supplied information. This drawing is not to be scaled. The architect is not responsible for the accuracy of survey, structural, mechanical, electrical, etc., information shown on this drawing. Refer to the appropriate consultant's drawings before proceeding with the work. Construction must conform to all applicable codes and requirements of authorities having jurisdiction. The contractor working from drawings not specifically marked 'For Construction' must assume full responsibility and bear costs for any corrections or damages resulting from his work.

1 | 2019-06-14 | ISSUED FOR SPA | # | DATE | DESCRIPTION



PHANTOM DEVELOPMENTS

Toronto, Ontario, Canada

Toronto, Ontano, Gan

IADOW STUDY - JUN

SHADOW STUDY - JUNE (DAYLIGHT SAVING TIME)

PROJECT NO.
18.189CS
PROJECT DATE
2019-04-09
DRAWN BY
SRS
CHECKED BY
AYU
SCALE

1:2000







2 SPA816 JUNE 21-1818 PM 1:2000



67 Lesmill Road Toronto, ON, M3B 2T8 T 416 425 2222 turnerfleischer.com

This drawing, as an instrument of service, is provided by and is the property of Turner Fleischer Architects Inc.
The contractor must verify and accept responsibility for all dimensions and conditions on site and must notify
Turner Fleischer Architects Inc. of any variations from the supplied information. This drawing is not to be
scaled. The architect is not responsible for the accuracy of survey, structural, mechanical, electrical, etc.,
information shown on this drawing. Refer to the appropriate consultant's drawings before proceeding with
the work. Construction must conform to all applicable codes and requirements of authorities having
jurisdiction. The contractor working from drawings not specifically marked 'For Construction' must assume
full responsibility and bear costs for any corrections or damages resulting from his work.



Toronto, Ontario, Canada

SHADOW STUDY - JUNE

(DAYLIGHT SAVING TIME)


PROJECT NO. 18.189CS PROJECT DATE 2019-04-09 DRAWN BY SRS CHECKED BY AYU SCALE 1:2000




SPA816

<u>LEGEND</u> Shadow of the Proposed Scheme (June 14, 2019) Shadow of Proposed Scheme that exceeds boundary of Settlement Scheme (November 28,2017)

Shadow of the Settlement Scheme (November 28,2017)

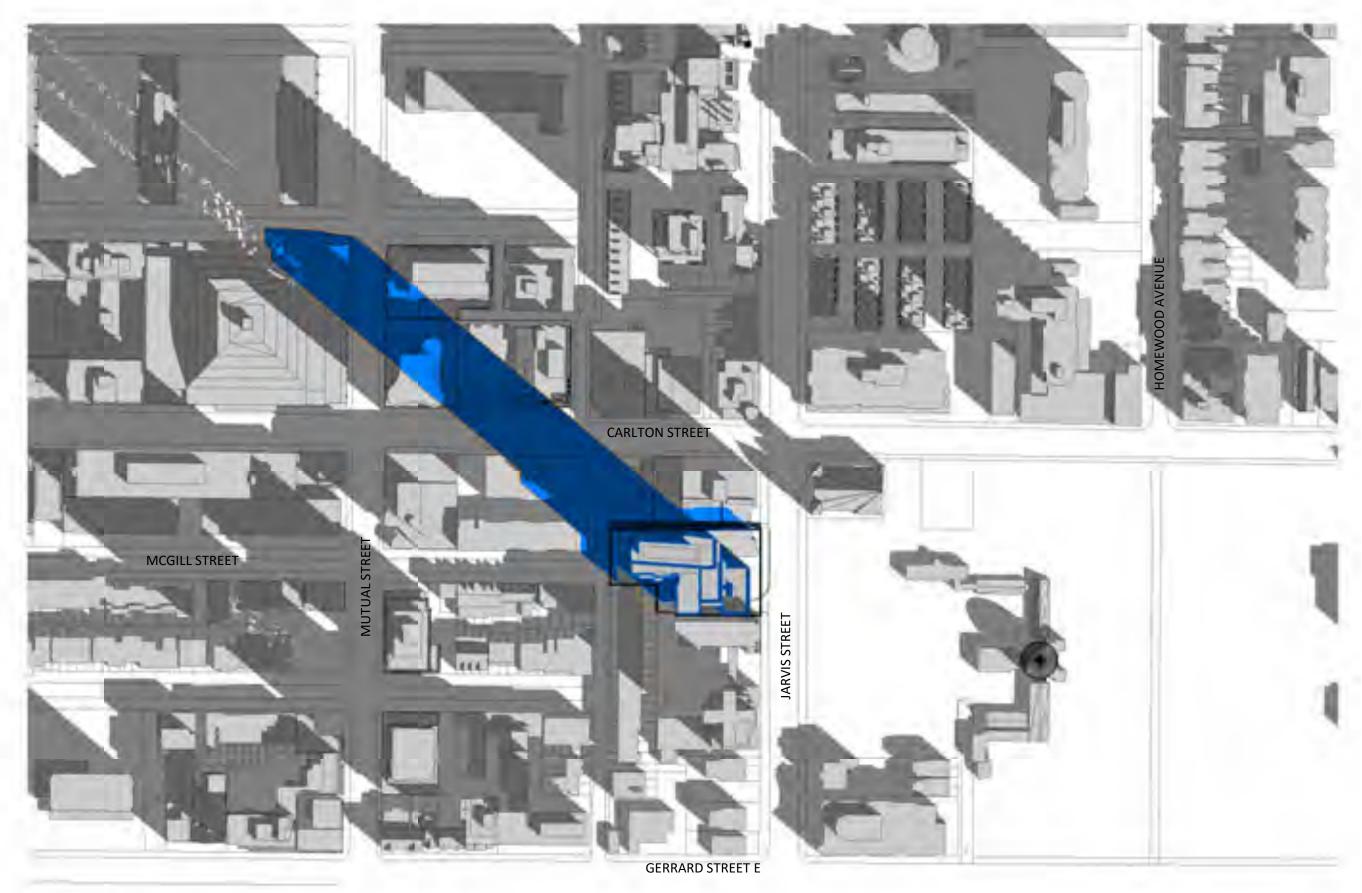

1 SEPTEMBER 21-0918 AM 1:2000

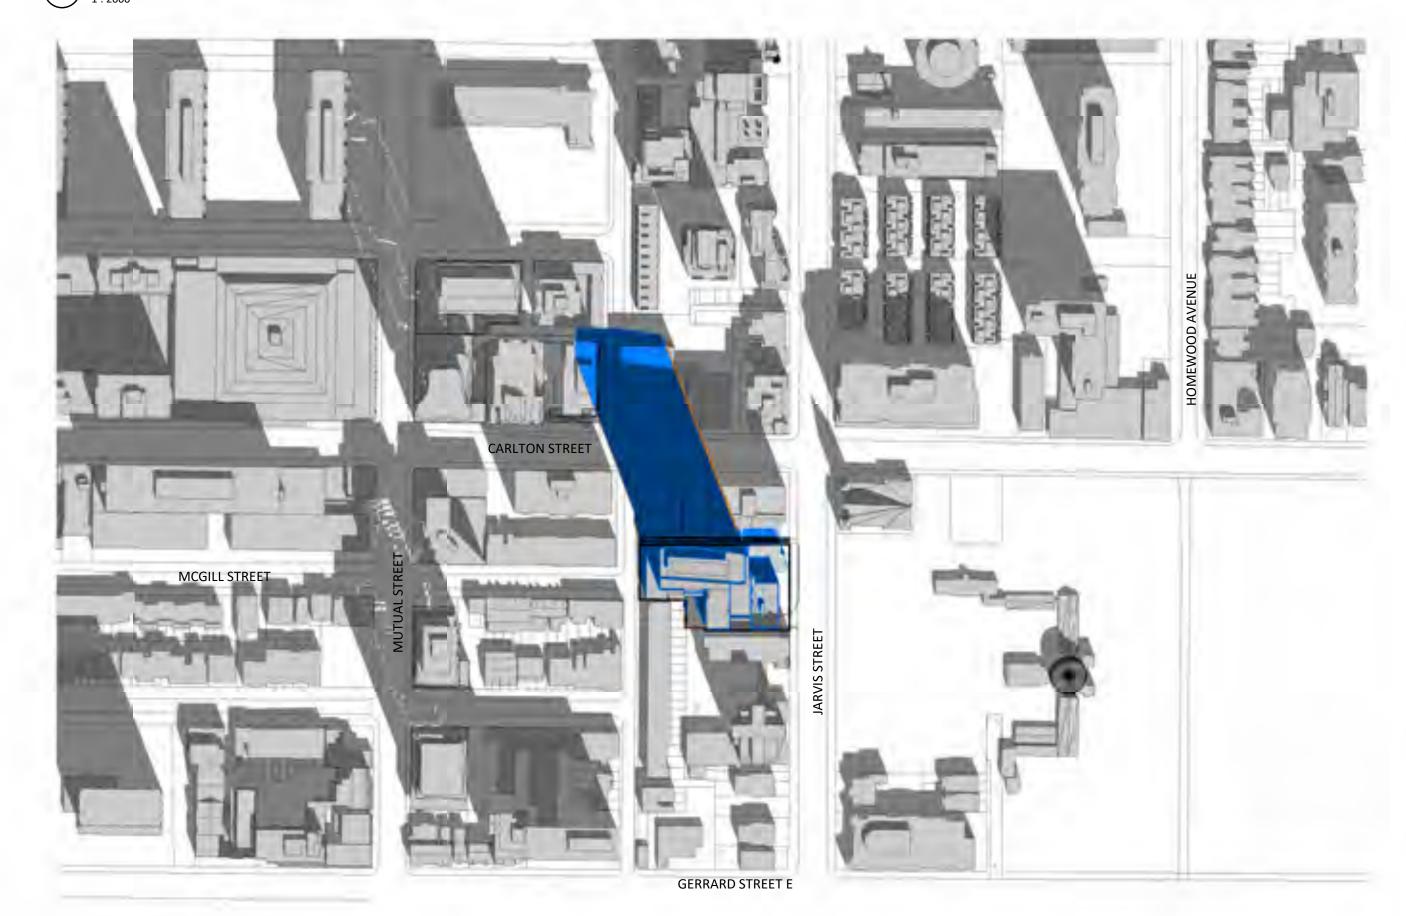

3 SEPTEMBER 21-1118 AM 1:2000



2 SEPTEMBER 21-1018 AM 1:2000



4 SEPTEMBER 21-1218 PM 1:2000

# **LEGEND**

Shadow of the Proposed Scheme (June 14, 2019)

Shadow of Proposed Scheme that exceeds boundary of Settlement Scheme (November 28,2017)

Shadow of the Settlement Scheme (November 28,2017)

TURNER FLEISCHER

67 Lesmill Road Toronto, ON, M3B 2T8 T 416 425 2222 turnerfleischer.com

This drawing, as an instrument of service, is provided by and is the property of Turner Fleischer Architects Inc. The contractor must verify and accept responsibility for all dimensions and conditions on site and must notify Turner Fleischer Architects Inc. of any variations from the supplied information. This drawing is not to be scaled. The architect is not responsible for the accuracy of survey, structural, mechanical, electrical, etc., information shown on this drawing. Refer to the appropriate consultant's drawings before proceeding with the work. Construction must conform to all applicable codes and requirements of authorities having jurisdiction. The contractor working from drawings not specifically marked 'For Construction' must assume full responsibility and bear costs for any corrections or damages resulting from his work.



308-314 Jarvis Street & 225 Mutual

PHANTOM DEVELOPMENTS

Toronto, Ontario, Canada

18.189CS

2019-04-09

DRAWN BY SRS


CHECKED BY AYU SCALE


1:2000

SHADOW STUDY - SEPTEMBER

(DAYLIGHT SAVING TIME)


PROJECT DATE

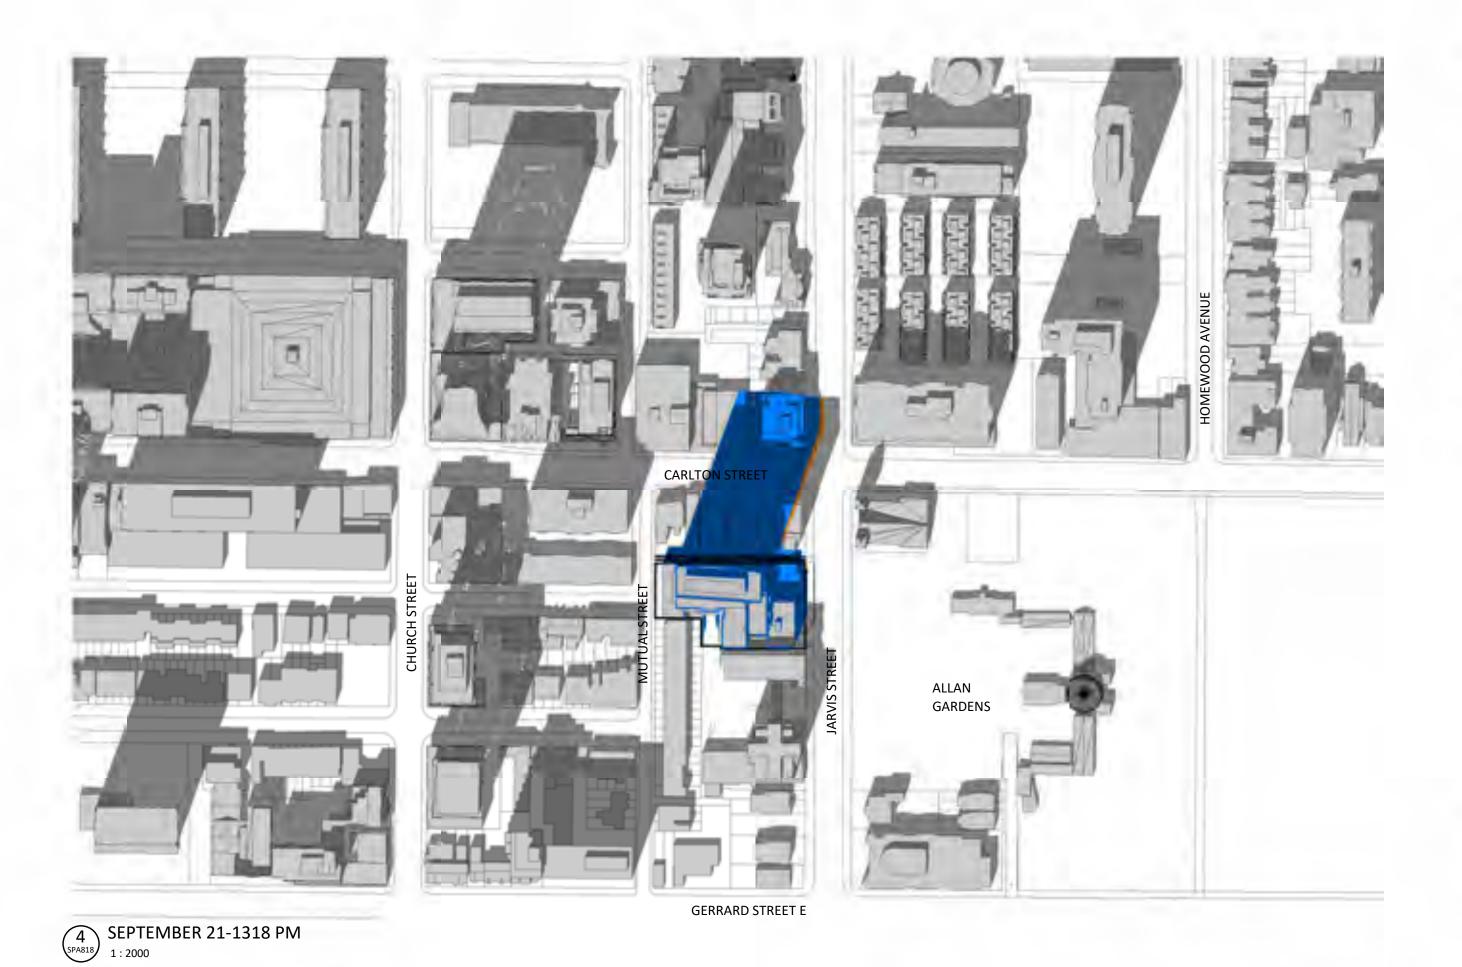

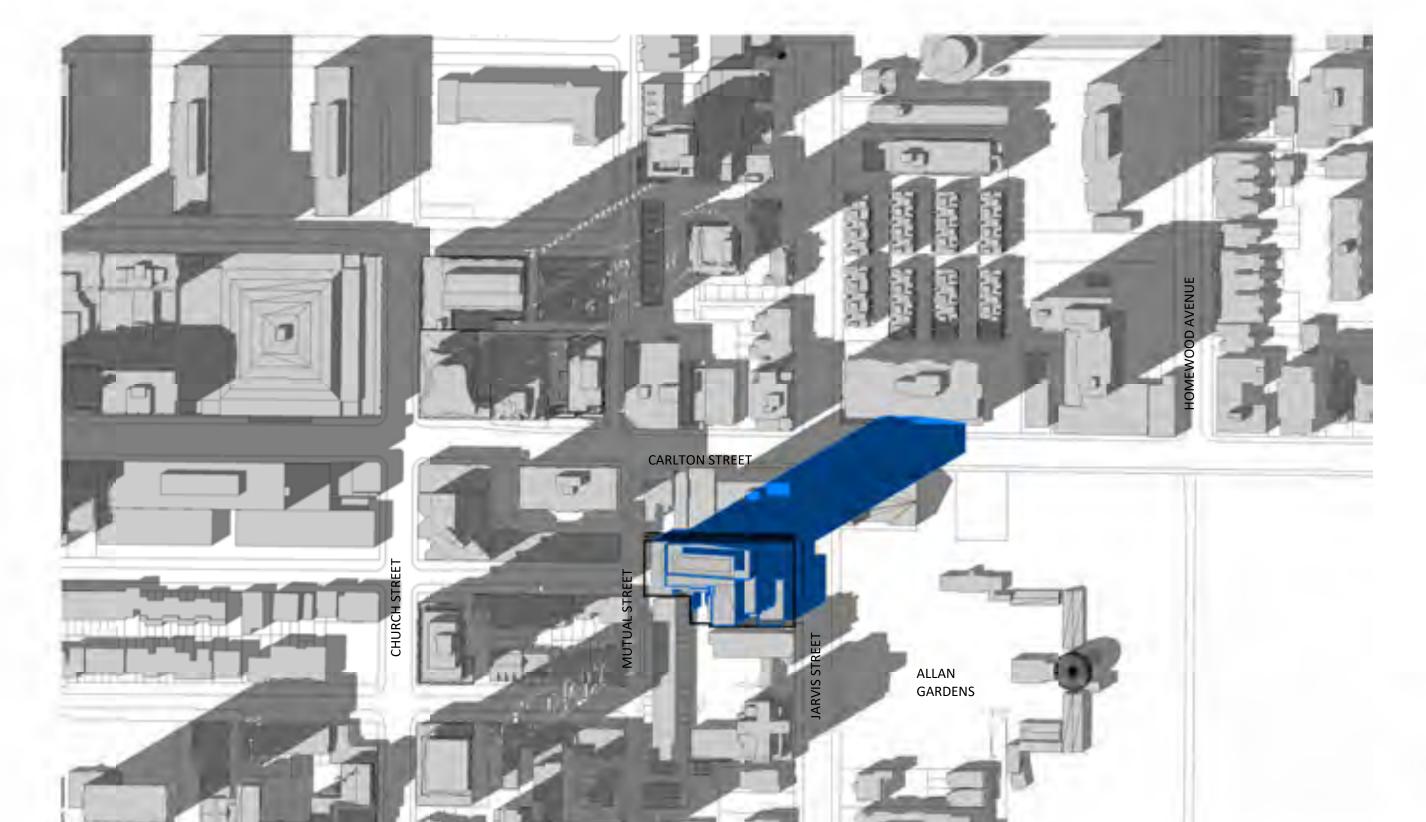


2 SEPTEMBER 21-1518 PM 1:2000

GERRARD STREET E

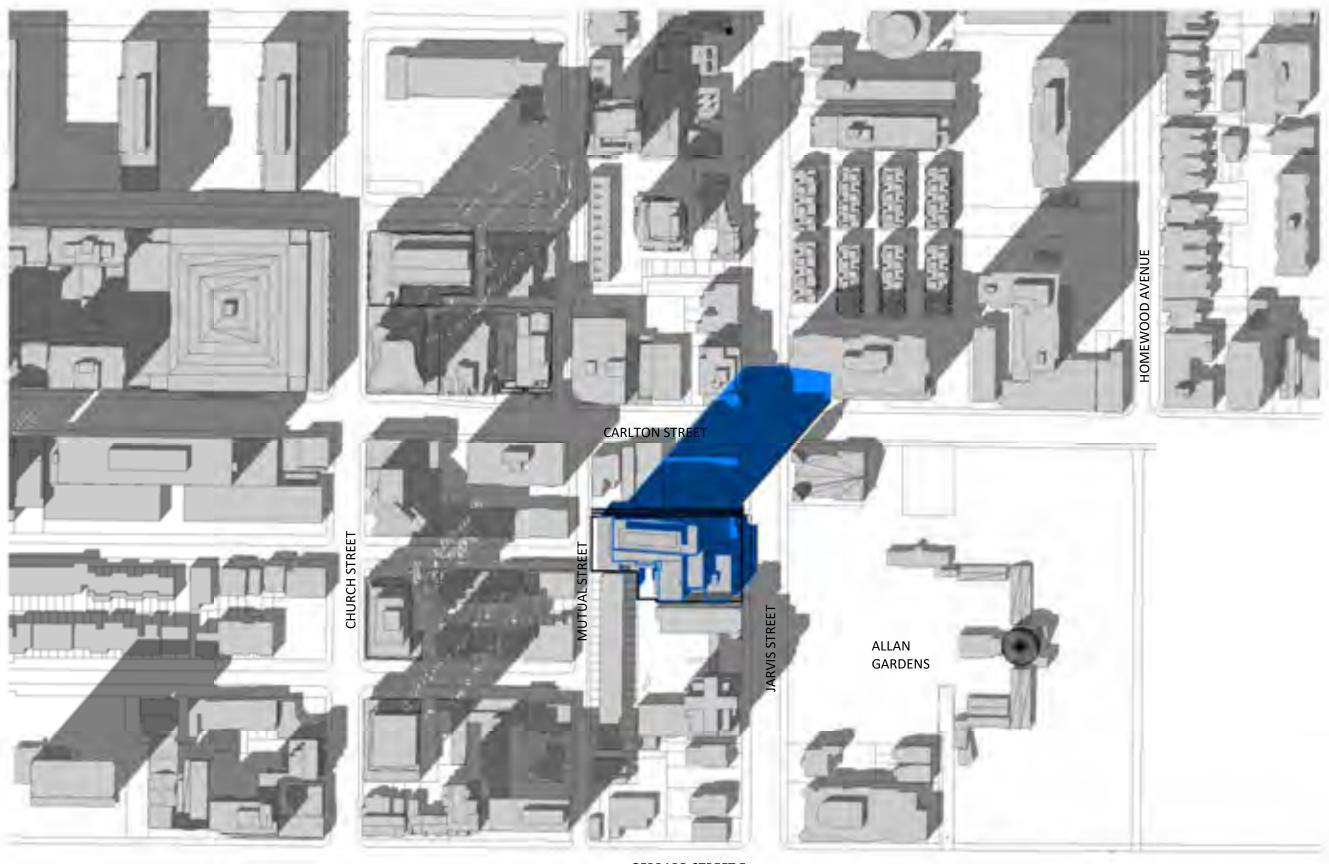

1 SEPTEMBER 21-1418 PM 1:2000

GERRARD STREET E

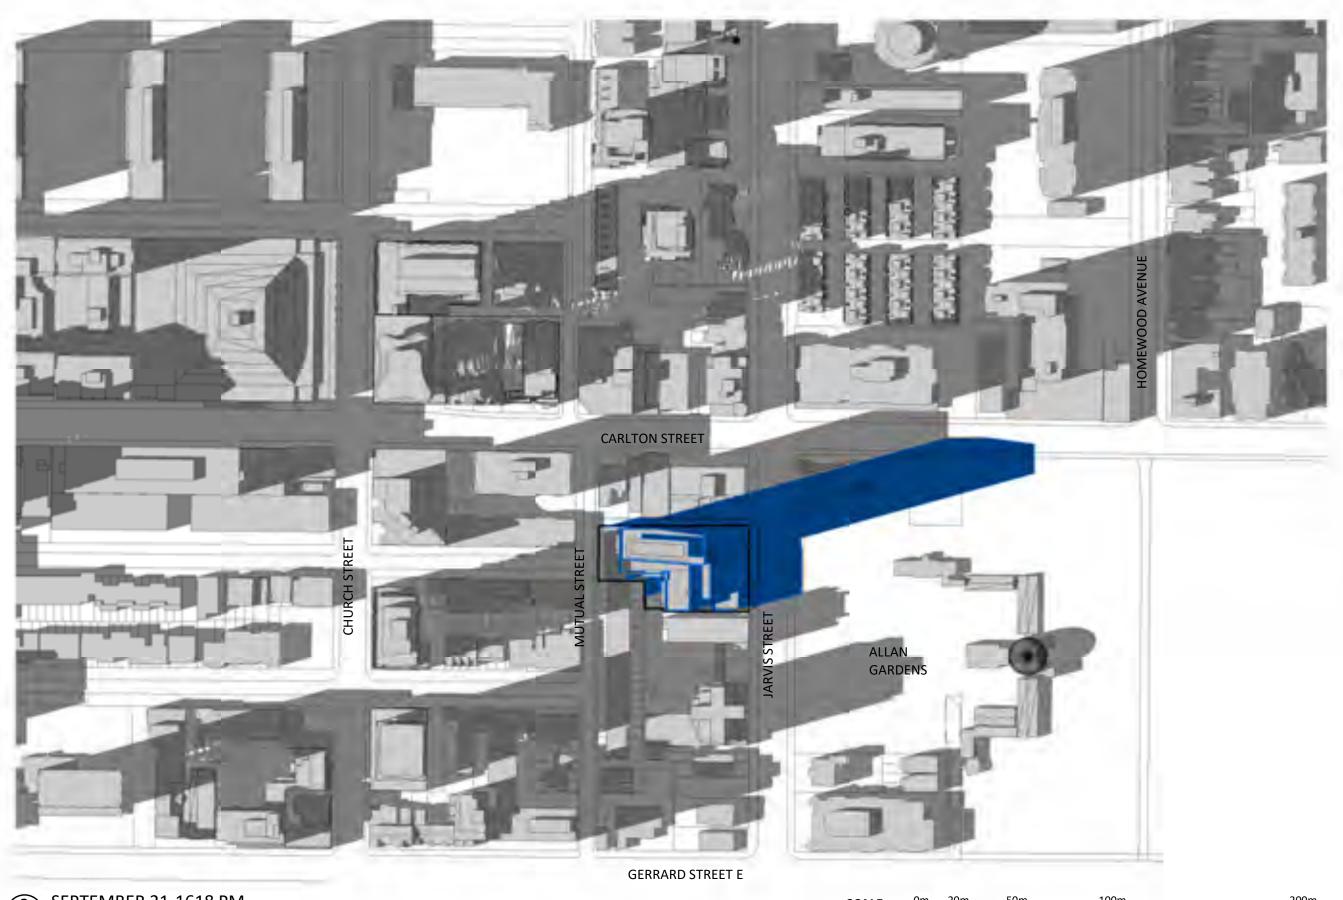

3 SEPTEMBER 21-1618 PM 1:2000

# <u>LEGEND</u>

Shadow of the Proposed Scheme (June 14, 2019)

Shadow of Proposed Scheme that exceeds boundary of Settlement Scheme (November 28,2017)

Shadow of the Settlement Scheme (November 28,2017)

TURNER FLEISCHER

67 Lesmill Road Toronto, ON, M3B 2T8 T 416 425 2222 turnerfleischer.com

This drawing, as an instrument of service, is provided by and is the property of Turner Fleischer Architects Inc. The contractor must verify and accept responsibility for all dimensions and conditions on site and must notify Turner Fleischer Architects Inc. of any variations from the supplied information. This drawing is not to be scaled. The architect is not responsible for the accuracy of survey, structural, mechanical, electrical, etc., information shown on this drawing. Refer to the appropriate consultant's drawings before proceeding with the work. Construction must conform to all applicable codes and requirements of authorities having jurisdiction. The contractor working from drawings not specifically marked 'For Construction' must assume full responsibility and bear costs for any corrections or damages resulting from his work.

1 | 2019-06-14 | ISSUED FOR SPA | # | DATE | DESCRIPTION

308-314 Jarvis Street & 225 Mutual

PHANTOM DEVELOPMENTS

Toronto, Ontario, Canada


SHADOW STUDY - SEPTEMBER

(DAYLIGHT SAVING TIME)

PROJECT NO. 18.189CS PROJECT DATE 2019-04-09 DRAWN BY CHECKED BY AYU SCALE 1:2000





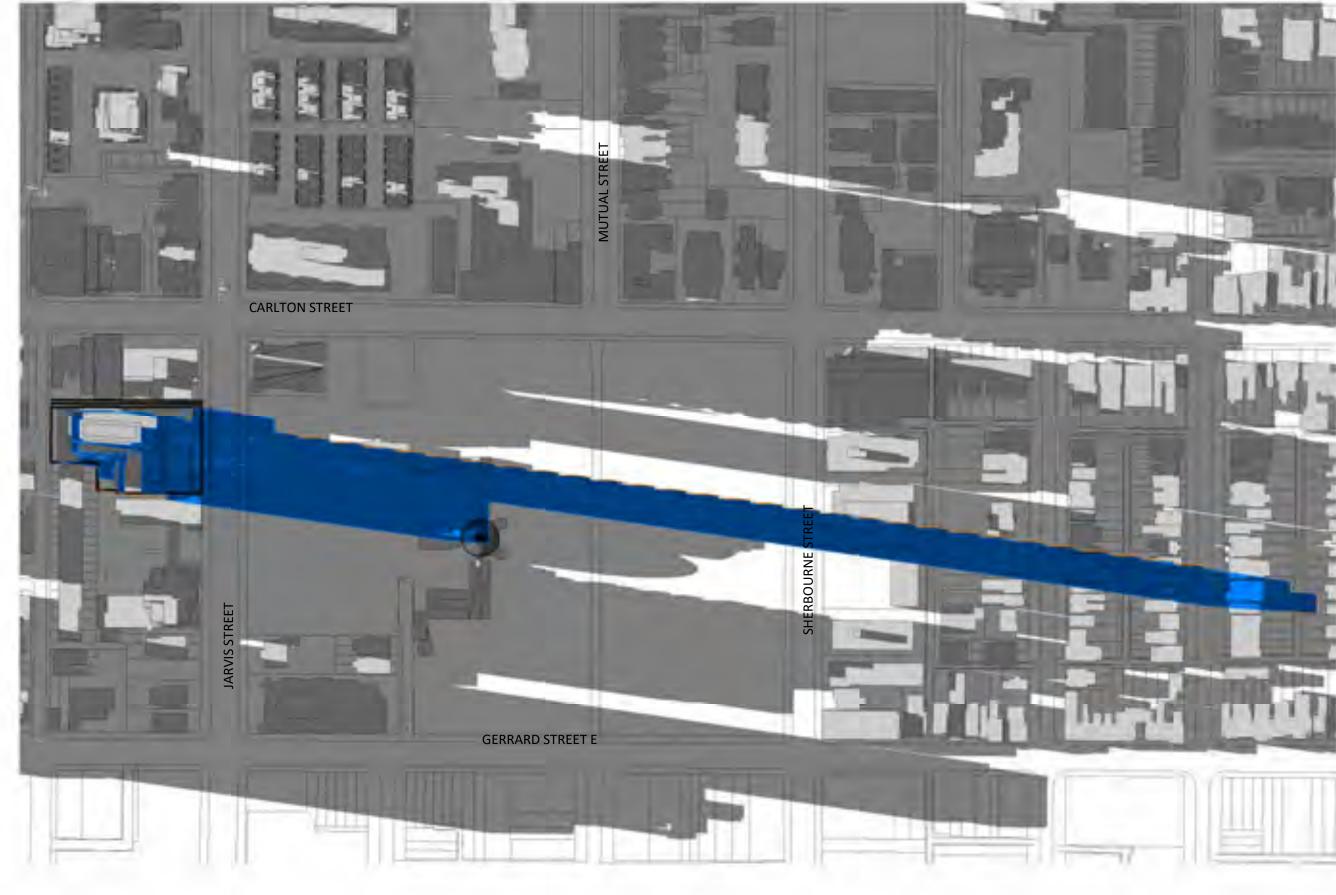

2 SEPTEMBER 21-1818 PM 1:2000

# **LEGEND**

Shadow of the Proposed Scheme (June 14, 2019)


Shadow of Proposed Scheme that exceeds boundary of Settlement Scheme (November 28,2017)

Shadow of the Settlement Scheme (November 28,2017)

TURNER FLEISCHER

67 Lesmill Road Toronto, ON, M3B 2T8 T 416 425 2222 turnerfleischer.com

This drawing, as an instrument of service, is provided by and is the property of Turner Fleischer Architects Inc.
The contractor must verify and accept responsibility for all dimensions and conditions on site and must notify
Turner Fleischer Architects Inc. of any variations from the supplied information. This drawing is not to be
scaled. The architect is not responsible for the accuracy of survey, structural, mechanical, electrical, etc.,
information shown on this drawing. Refer to the appropriate consultant's drawings before proceeding with
the work. Construction must conform to all applicable codes and requirements of authorities having
jurisdiction. The contractor working from drawings not specifically marked 'For Construction' must assume
full responsibility and bear costs for any corrections or damages resulting from his work.

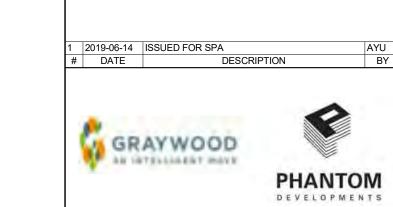

308-314 Jarvis Street & 225 Mutual

Toronto, Ontario, Canada

SHADOW STUDY - SEPTEMBER

(DAYLIGHT SAVING TIME)

DRAWN BY SRS

PROJECT NO. 18.189CS PROJECT DATE 2019-04-09 CHECKED BY AYU SCALE 1:2000



**APPENDIX VI** 

City of Toronto Heritage Impact Assessment Terms of Reference



#### TERMS OF REFERENCE.

took	Mortings Super: Assessment
Beerlyste	I industry (legaler Annual property of the pro
	This made will be known on a flavough analysembles of the signifigures will be significant will be significant and because and the significant will be significant production. Aboutly, we begin the product development or the discount will be so as the consecuency, as the sidness rather and consecuency as the sidness rather and analysis of the significant and analysis of the significant and analysis of the sidness of the sid
	The construction printing will apply compression printing of desirable descriptions until not exception of the control of the
	Was fee a fix pressed of top-seq miteralities received in telephone of top-seq of the particular in Allinea teath.
Figure Repaired	A WA is proposed for the federates personnel man. If the present is an in Cort of Federal 1 and American in Cort of Telegraph of the American in Cort of Telegraph of the American in Cort of Telegraph
	A STA part has explained by mell fall the Stateman and considerable application types     Tomore lead or Malor Variance and Building Protein applications for ally prosently excepting to the Copy of Tomore A. Income of Stateman Properties and Copy of Tomore A. Income of Stateman Properties and Stateman and Action Copy of Stateman and Sta
Estando	The first will extract the street of the speciment tracking a point of the speciment of the side of the 10 per 10
	Farence The USE and the Street or cough the provide artifacts should be commonly the out among the form of the common of the com

	Bridge Report Eventured
	Committee of the commit
	Thomas
	The State County State of County (not county) and the county of the county of County (not county) and the county of County and
Supplied.	The REA will delive, but it we desire to be different belonging
Taken	Distriction in Development No.
	P Parcel marks of which below from man, and winn, Brown, pleasured to the party of
	The transport of Nagarithanes of State Period, The patternyl becomes value and baryons continued and the patternyl state of the patternyl patternyl
	Printed and the printed printings of the second brings covers, in the printings
	A proportion of a first particles and light quite their prompting the annual of the particle prompting the particle particles.







