Toronto, ON, M3B 2T8 T 416 425 2222 turnerfleischer.com PROPOSED DEVELOPMENT PROPOSED DEVELOPMENT 34 STOREY **34 STOREY GREEN ROOF** I responsibility and bear costs for any corrections or damages resulting from his work. **GREEN ROOF EXTERIOR FINISHES LEGEND** ROOF ROOF 207.500 207.500 1A BRICK - DARK RED (ROSE) 1B CONCRETE M.P.H. 2A METAL PANEL - PURPLE 202.500 202.500 2B METAL PANEL - DARK GREY FLOOR 34 FLOOR 34 2C LOUVRE - MEDIUM GREY 198.350 198.350 ALUMINIUM CAP - LIGHT GREY FLOOR 33 FLOOR 33 195.400 195.400 4 EIFS PANEL SANDBLASTED - DARK GREY FLOOR 32 FLOOR 32 5 CLEAR GLAZING 192.450 192.450 5A BIRD FRIENDLY GLASS FLOOR 31 FLOOR 31 189.500 189.500 6A | SPANDREL GLASS - LIGHT GREY FLOOR 30 FLOOR 30 6B | SPANDREL GLASS - DARK RED 186.550 186.550 6C | SPANDREL GLASS - DARK GREY FLOOR 29 FLOOR 29 183.600 183.600 FROSTED GLASS - WHITE FLOOR 28 FLOOR 28 ALUMINIUM WINDOW FRAME - DARK GREY 180.650 180.650 FLOOR 27 FLOOR 27 GENERAL NOTES IN ACCORDANCE WITH THE BIRD-FRIENDLY DEVELOPMENT GUIDELINES (FIRST 12 METERS ABOVE GRADE AND 177.700 177.700 4 METERS ABOVE GREEN FEATURE): FLOOR 26 FLOOR 26 PROVISION OF VISUAL MARKERS
VISUAL MARKERS TO ALERT BIRDS WILL BE PROVIDED. METHODS
OF ACHIEVING THIS ARE AS FOLLOWS:
- VISUAL MARKERS APPLIED TO GLASS WITH A 174.750 174.750 FLOOR 25 FLOOR 25 - VISUAL MARKERS APPLIED TO GLASS WITH A
SPACING OF 100mm x 100mm
- LOW REFLECTANCE OR OPAQUE MATERIALS
- BUILDING-INTERGRATED STRUCTURES TO MUTE
REFLECTIONS ON GLASS SURFACES 171.800 171.800 FLOOR 24 FLOOR 24 2B REDUCTION OF LIGHT POLLUTION
- REDUCTION OF LIGHT POLLUTION FROM INTERIOR 168.850 168.850 LIGHTS, PARTICULARLY DURING MIGRATION PERIODS
- SELECTION OF APPROPRIATE EXTERNAL LIGHTING FIXTURES TO ELIMINATE DIRECT UPWARDS LIGHT
REDUCE SPILL LIGHT AND OPTIMIZE USEFUL LIGHT FLOOR 23 FLOOR 23 165.900 165.900 DENSITY PATTERN BETWEEN NO FLOOR 22 FLOOR 22 162.950 162.950 FLOOR 21 FLOOR 21 160.000 160.000 FLOOR 20 FLOOR 20 157.050 157.050 FLOOR 19 FLOOR 19 154.100 FLOOR 18 FLOOR 18 151.150 151.150 FRITTED GLASS WILL BE TREATED WITH A DENSITY PATTERN OF VISUAL MARKERS NO MORE THAN 100mm X 100mm APRT FOR THE FIRST 12M ABOVE GRADE. (TORONTO GREEN STANDARD EC4.1) FLOOR 17 FLOOR 17 148.200 148.200 FLOOR 16 FLOOR 16 145.250 145.250 FLOOR 15 FLOOR 15 142.300 142.300 FLOOR 14 FLOOR 14 139.350 139.350 BIRD FRIENDLY GLAZING FLOOR 13 **4M ABOVE ROOFTOP VEGETATION** FLOOR 13 136.400 136.400 OUTDOOR FLOOR 12 FLOOR 12 **AMENITY** 133.450 133.450 1A FLOOR 11 FLOOR 11 OUTDOOR 2020-08-21 ISSUED FOR SPA 2020-02-03 ISSUED FOR SPA **AMENITY** 130.500 130.500 FLOOR 10 FLOOR 10 126.950 126.950 FLOOR 9 FLOOR 9 124.000 GRAYWOOD 124.000 FLOOR 8 FLOOR 8 121.050 121.050 FLOOR 7 FLOOR 7 117.650 117.650 FLOOR 6 FLOOR 6 JAC CONDOS 114.700 114.700 ROOF FLOOR 5 FLOOR 5 308-314 Jarvis Street & 225 Mutual Street, Toronto, Ontario, Canada 111.900 111.900 FLOOR 4 FLOOR 4 109.100 109.100 FLOOR 3 OWNHOUSE FL3 FLOOR 3 106.300 106.300 105.900 **EAST AND NORTH ELEVATIONS** FLOOR 2 FLOOR 2 TOWNHOUSE FL2 103.350 103.350 102.900 TÖWNHOUSE FL1 PROJECT NO. CANOPY ESTABLISHED GRADE ESTABLISHED GRADE 99.900 18.189CS PROJECT DATE MUTUAL ST. HERITAGE BUILDING HERITAGE BUILDING MCCLEAR PLFLOOR 1 FLØOR 1 DRIVEWAY RETAIL ENTRANCE RESIDENTIAL ENTRANCE 2020-08-18 1B 5A 1A 1B 5 98.250 DRAWN BY JARVIS ST. 5A 1B Author MCCLEAR PL. CHECKED BY Checker BELL L.FLEISCHER SCALE EAST ELEVATION
1: 250 NORTH ELEVATION
1:250 LICENCE As indicated

**TURNER FLEISCHER** 


67 Lesmill Road


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PHANTOM

### PROPOSED DEVELOPMENT **34 STOREY**

#### PROPOSED DEVELOPMENT **34 STOREY**



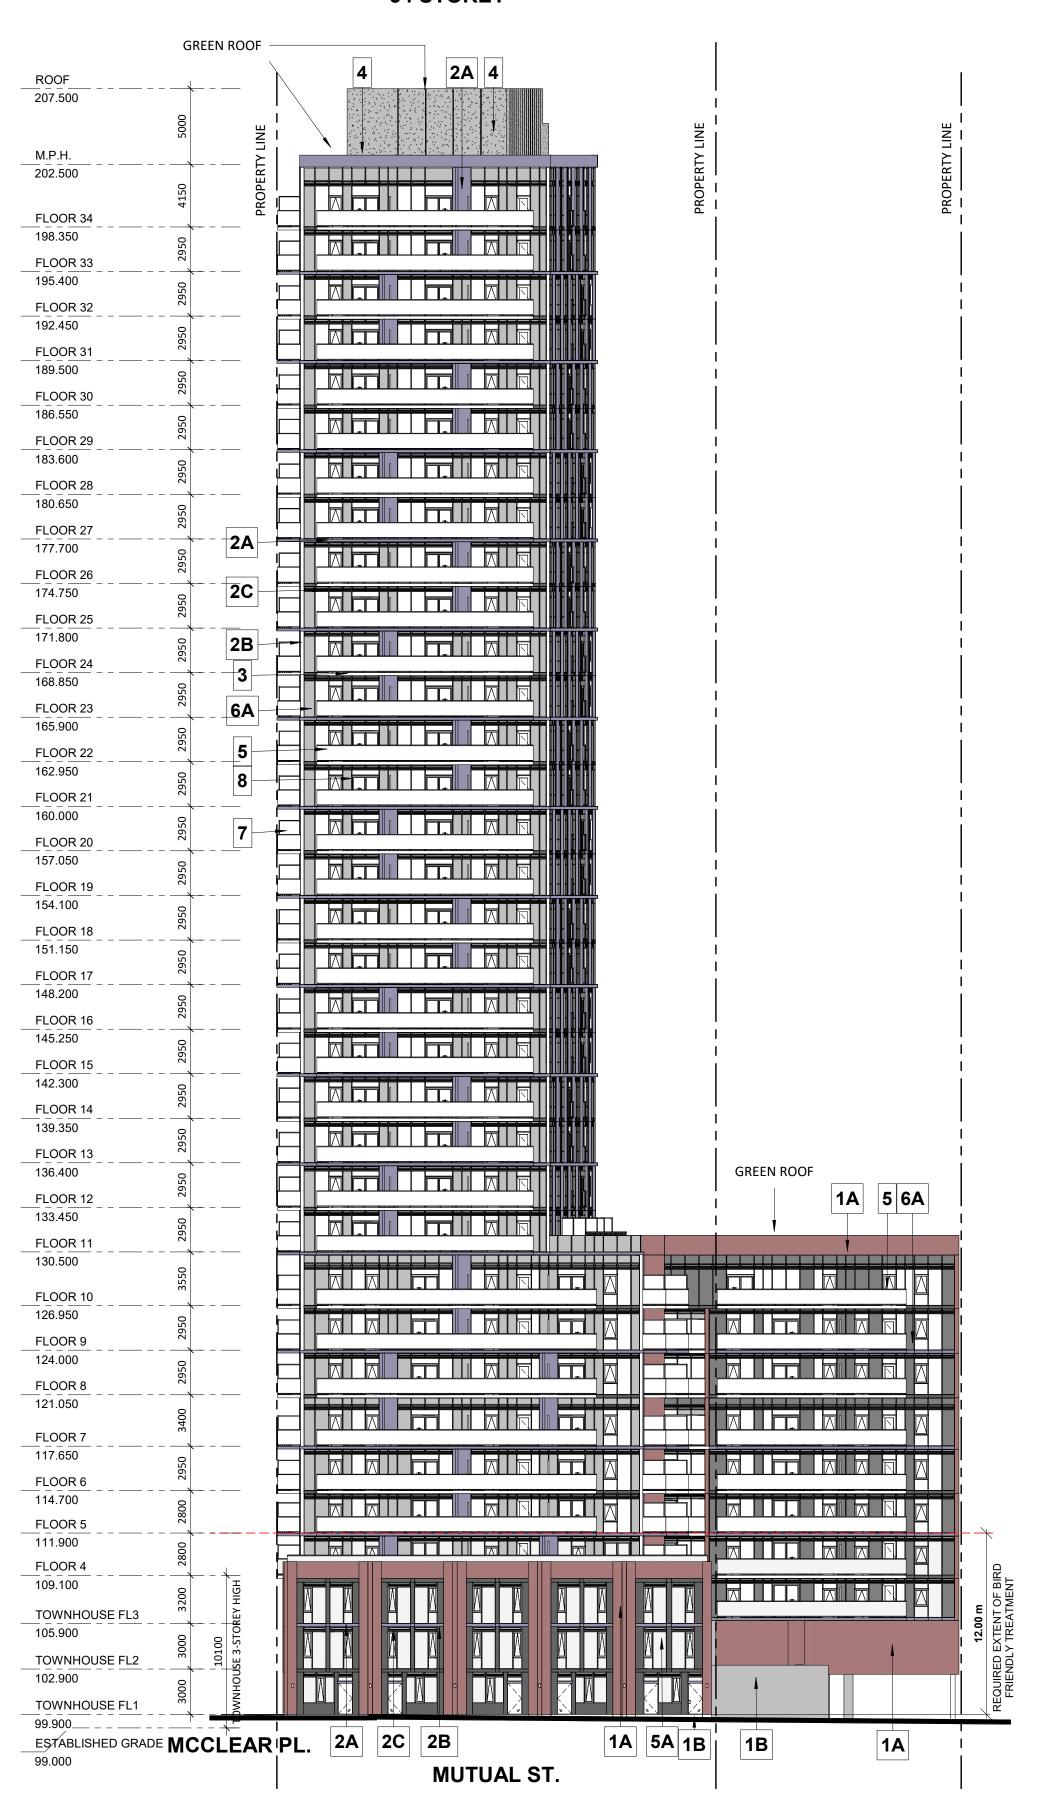

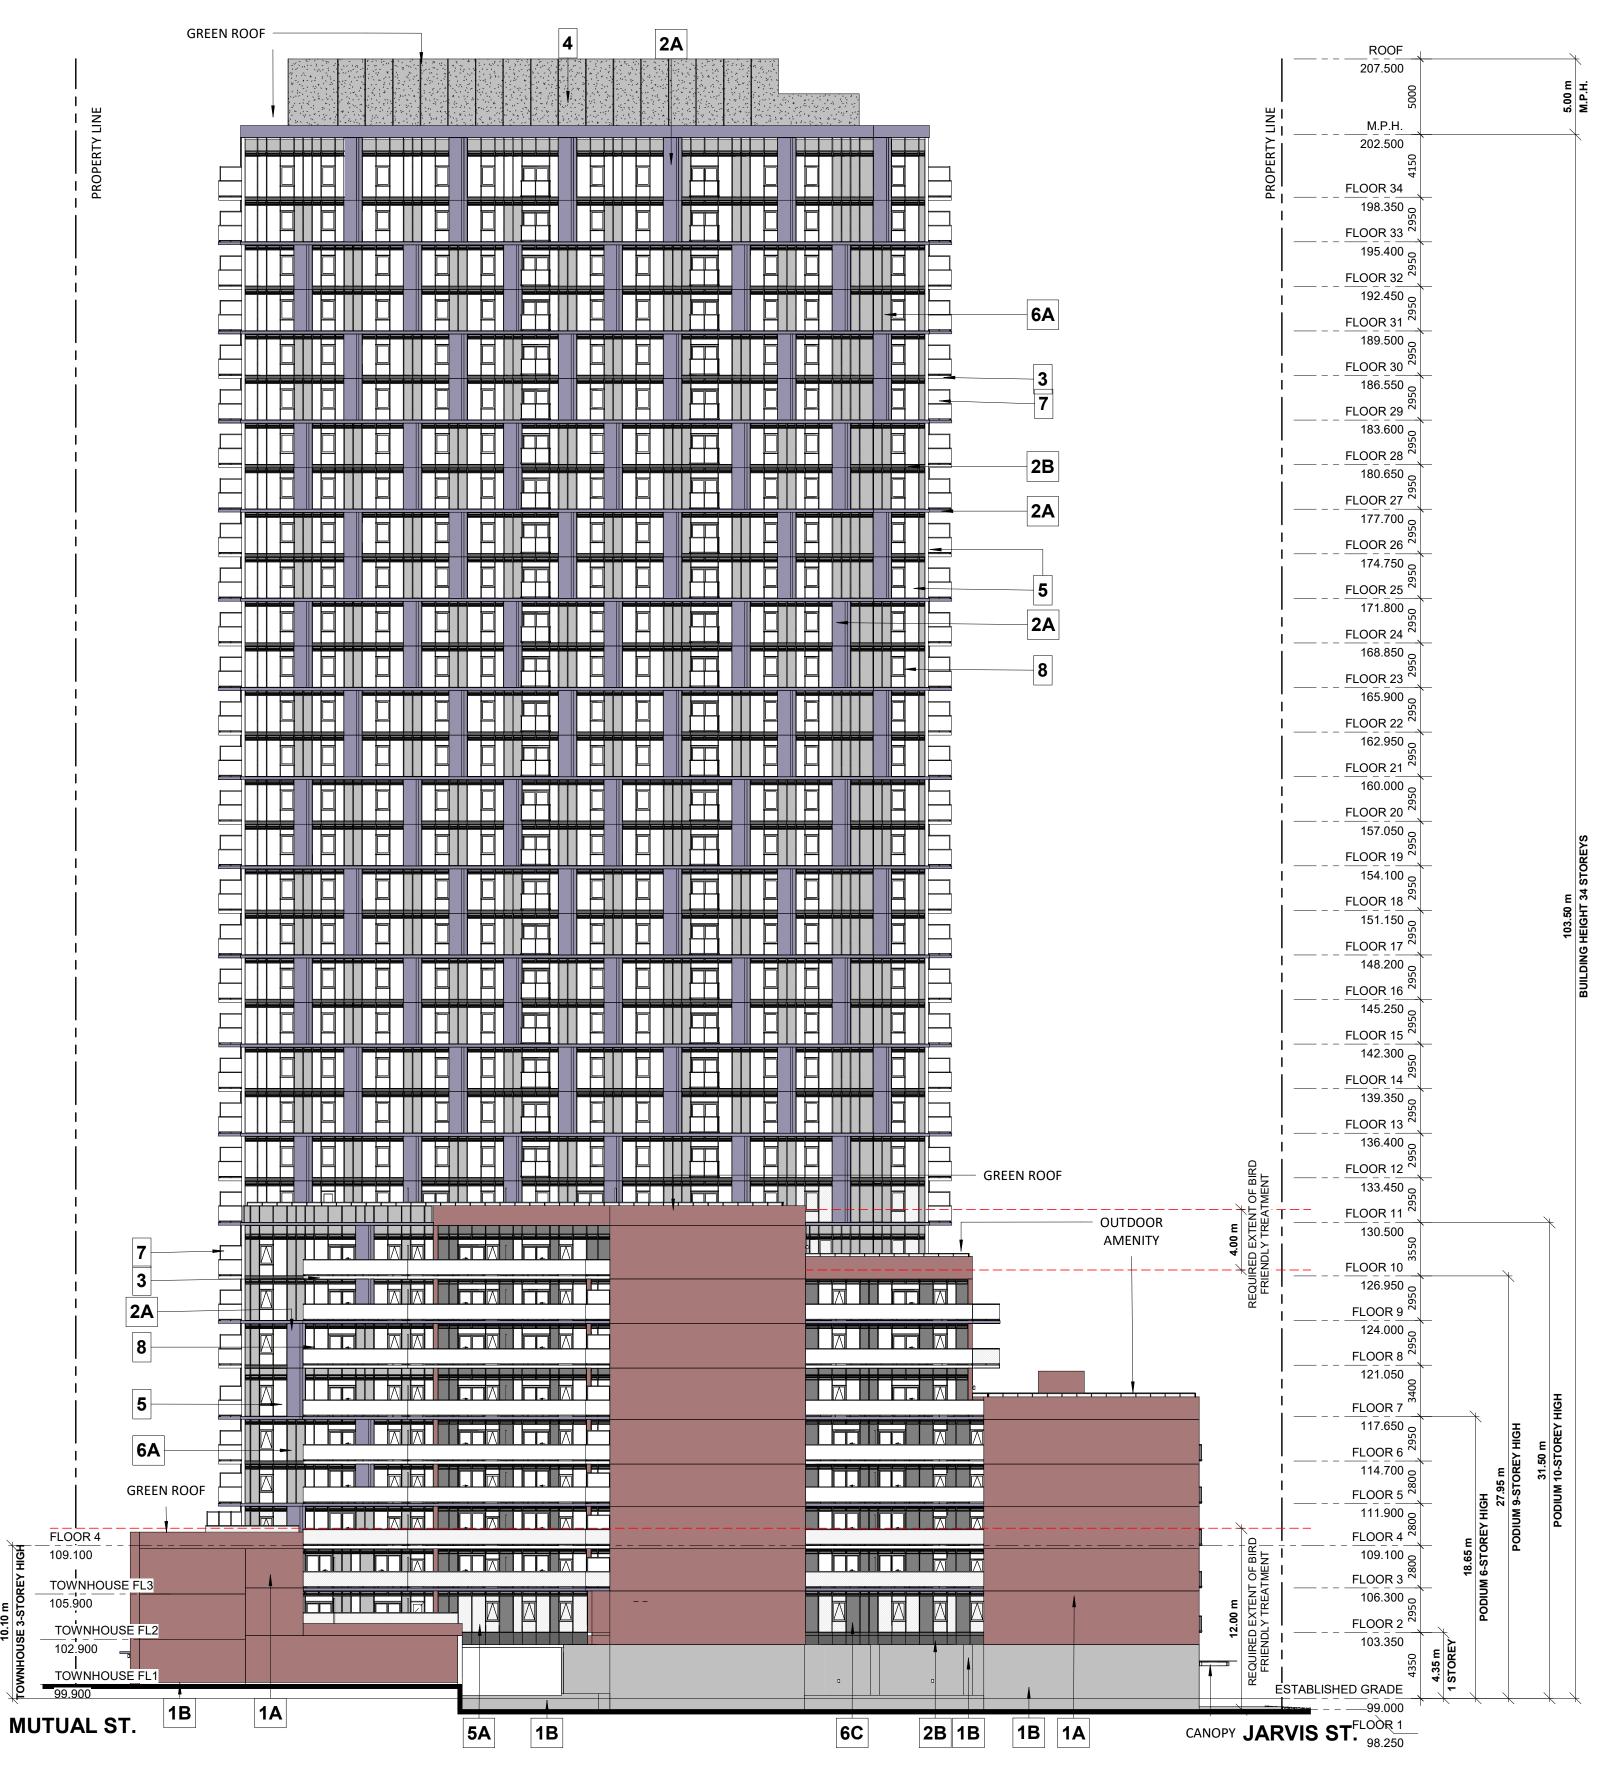WEST ELEVATION

1:250



## **TURNER FLEISCHER**

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PROVISION OF VISUAL MARKERS
VISUAL MARKERS TO ALERT BIRDS WILL BE PROVIDED. METHODS
OF ACHIEVING THIS ARE AS FOLLOWS:

- VISUAL MARKERS APPLIED TO GLASS WITH A
SPACING OF 100mm x 100mm

- LOW REFLECTANCE OR OPAQUE MATERIALS
- BUILDING-INTERGRATED STRUCTURES TO MUTE
REFLECTIONS ON GLASS SURFACES REDUCTION OF LIGHT POLLUTION

- REDUCTION OF LIGHT POLLUTION FROM INTERIOR
LIGHTS, PARTICULARLY DURING MIGRATION PERIODS

- SELECTION OF APPROPRIATE EXTERNAL LIGHTING FIXTURES TO ELIMINATE DIRECT UPWARDS LIGHT
REDUCE SPILL LIGHT AND OPTIMIZE USEFUL LIGHT DENSITY PATTERN BETWEEN NO

FRITTED GLASS WILL BE TREATED WITH A DENSITY PATTERN OF VISUAL MARKERS NO MORE THAN 100mm X 100mm APRT FOR THE FIRST 12M ABOVE GRADE. (TORONTO GREEN STANDARD EC4.1)



JAC CONDOS

308-314 Jarvis Street & 225 Mutual Street, Toronto, Ontario, Canada

WEST AND SOUTH ELEVATIONS

PROJECT NO. 18.189CS PROJECT DATE 2020-08-18 DRAWN BY Author CHECKED BY Checker SCALE As indicated







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## **EXTERIOR FINISHES LEGEND**

- 1A BRICK DARK RED (ROSE)
- 1B CONCRETE
- 2A METAL PANEL PURPLE
- 2B METAL PANEL DARK GREY
- 2C LOUVRE MEDIUM GREY
- 3 ALUMINIUM CAP LIGHT GREY
- 4 EIFS PANEL SANDBLASTED DARK GREY
- 5 CLEAR GLAZING
- 5A BIRD FRIENDLY GLASS
- 6A SPANDREL GLASS LIGHT GREY
- 6B SPANDREL GLASS DARK RED 6C SPANDREL GLASS - DARK GREY
- 7 FROSTED GLASS WHITE
- 8 ALUMINIUM WINDOW FRAME DARK GREY

GENERAL NOTES IN ACCORDANCE WITH THE BIRD-FRIENDLY DEVELOPMENT GUIDELINES (FIRST 12 METERS ABOVE GRADE AND 4 METERS ABOVE GREEN FEATURE):

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REFLECTIONS ON GLASS SURFACES

REDUCTION OF LIGHT POLLUTION

- REDUCTION OF LIGHT POLLUTION FROM INTERIOR PARTICULARLY DURING MIGRATION PERIODS

- SELECTION OF APPROPRIATE EXTERNAL LIGHTING FIXTURES TO ELIMINATE DIRECT UPWARDS LIGHT.

REDUCE

SPILL LIGHT AND OPTIMIZE USEFUL LIGHT

DENSITY PATTERN BETWEEN NO MORE THAN 100mm x 100mm APART (\*1)

FRITTED GLASS WILL BE TREATED WITH A DENSITY PATTERN OF VISUAL MARKERS NO MORE THAN 100mm X 100mm APRT FOR THE FIRST 12M ABOVE GRADE. (TORONTO GREEN STANDARD EC4.1)

4 | 2020-08-21 | ISSUED FOR SPA 2 | 2020-02-03 | ISSUED FOR SPA 1 | 2019-06-14 | ISSUED FOR SPA # | DATE | DES

GRAYWOOD E PHANTOM

JAC CONDOS

308-314 Jarvis Street & 225 Mutual Street, Toronto, Ontario, Canada

RETAIL ENTRANCE

DRAWING BUILDING

1 TO 50 EAST ELEVATION PART A

PROJECT NO. 18.189CS PROJECT DATE 2020-08-18 DRAWN BY MDL

CHECKED BY AYU SCALE

As indicated

LICENCE

SPA311A

EAST ELEVATION 1-50 PART A

1:50





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#### **EXTERIOR FINISHES LEGEND**

- 1A BRICK DARK RED (ROSE)
- 1B CONCRETE
- 2A METAL PANEL PURPLE
- 2B METAL PANEL DARK GREY
- 2C LOUVRE MEDIUM GREY
- 3 ALUMINIUM CAP LIGHT GREY
- 4 EIFS PANEL SANDBLASTED DARK GREY
- 5 CLEAR GLAZING
- FA DIDD EDIENDLY OLAC
- 5A BIRD FRIENDLY GLASS
- 6A SPANDREL GLASS LIGHT GREY
- 6B SPANDREL GLASS DARK RED

6C | SPANDREL GLASS - DARK GREY

- 7 FROSTED GLASS WHITE
- 8 ALUMINIUM WINDOW FRAME DARK GREY
- ALOWINION WINDOW FRANK

## GENERAL NOTES IN ACCORDANCE WITH THE BIRD-FRIENDLY DEVELOPMENT GUIDELINES (FIRST 12 METERS ABOVE GRADE AND 4 METERS ABOVE GREEN FEATURE):

PROVISION OF VISUAL MARKERS
VISUAL MARKERS TO ALERT BIRDS WILL BE PROVIDED. METHODS
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- BUILDING-INTERGRATED STRUCTURES TO MUTE
REFLECTIONS ON GLASS SURFACES

REDUCTION OF LIGHT POLLUTION

- REDUCTION OF LIGHT POLLUTION FROM INTERIOR PARTICULARLY DURING MIGRATION PERIODS

- SELECTION OF APPROPRIATE EXTERNAL LIGHTING FIXTURES TO ELIMINATE DIRECT UPWARDS LIGHT.

REDUCE

DENSITY PATTERN BETWEEN NO MORE

THAN 100mm x 100mm APART (\*1)

DENSITY PATTERN BETWEEN NO MORE THAN 100mm x 100mm APART (\*1)

THAN 100mm x 10

DETAIL NOTES:

1. FRITTED ELASS WILL BE TREATED WITH A DENSITY PATTERN OF VISUAL MARKERS NO MORE THAN 100mm X 100mm APRT FOR THE FIRST 12M ABOVE GRADE. (TORONTO GREEN STANDARD EC4.1)

2020-08-21 ISSUED FOR SPA A



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DRAWIN

1 TO 50 EAST ELEVATION PART B

PROJECT NO.
18.189CS
PROJECT DATE
2020-08-18
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SPA311B



SPA312A



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#### **EXTERIOR FINISHES LEGEND**

1A BRICK - DARK RED (ROSE)

1B CONCRETE

2A METAL PANEL - PURPLE

2B METAL PANEL - DARK GREY

2C LOUVRE - MEDIUM GREY

3 ALUMINIUM CAP - LIGHT GREY

4 EIFS PANEL SANDBLASTED - DARK GREY

5 CLEAR GLAZING

5A BIRD FRIENDLY GLASS

6A SPANDREL GLASS - LIGHT GREY

6B SPANDREL GLASS - DARK RED

6C SPANDREL GLASS - DARK GREY

7 FROSTED GLASS - WHITE

8 ALUMINIUM WINDOW FRAME - DARK GREY

## GENERAL NOTES IN ACCORDANCE WITH THE BIRD-FRIENDLY DEVELOPMENT GUIDELINES (FIRST 12 METERS ABOVE GRADE AND 4 METERS ABOVE GREEN FEATURE):

PROVISION OF VISUAL MARKERS
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REFLECTIONS ON GLASS SURFACES

REDUCTION OF LIGHT POLLUTION
- REDUCTION OF LIGHT POLLUTION FROM INTERIOR
LIGHTS,
PARTICULARLY DURING MIGRATION PERIODS
- SELECTION OF APPROPRIATE EXTERNAL LIGHTING
FIXTURES TO ELIMINATE DIRECT UPWARDS LIGHT.

REDUCE

DENSITY PATTERN BETWEEN NO
MORE
THAN 100mm x 100mm APART (1)

O

Z

DENSITY PATTERN BETWEEN NO MORE THAN 100mm x 100mm APART (\*1)

THAN 100mm x 100mm APART (\*1)

THAN 100mm x 100mm x 100mm APART (\*1)

DETAIL NOTES:

1. FRITTED GLASS WILL BE TREATED WITH A DENSITY PATTERN OF VISUAL MARKERS NO MORE THAN 100mm X 100mm APRT FOR THE FIRST 12M ABOVE GRADE. (TORONTO GREEN STANDARD EC4.1)

4 | 2020-08-21 | ISSUED FOR SPA



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DRAWIN

1 TO 50 WEST ELEVATION PART B

PROJECT NO.
18.189CS
PROJECT DATE
2020-08-18
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Author
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SCALE

As indicated



SPA312B

WEST ELEVATION 1-50 PART B

1:50





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### **EXTERIOR FINISHES LEGEND**

1A BRICK - DARK RED (ROSE)

1B CONCRETE

2A METAL PANEL - PURPLE

2B METAL PANEL - DARK GREY

2C LOUVRE - MEDIUM GREY

3 ALUMINIUM CAP - LIGHT GREY

4 EIFS PANEL SANDBLASTED - DARK GREY

5A BIRD FRIENDLY GLASS

6B SPANDREL GLASS - DARK RED

6C SPANDREL GLASS - DARK GREY

8 ALUMINIUM WINDOW FRAME - DARK GREY

GENERAL NOTES IN ACCORDANCE WITH THE BIRD-FRIENDLY DEVELOPMENT GUIDELINES (FIRST 12 METERS ABOVE GRADE AND 4 METERS ABOVE GREEN FEATURE):

PROVISION OF VISUAL MARKERS
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REFLECTIONS ON GLASS SURFACES

REDUCTION OF LIGHT POLLUTION

- REDUCTION OF LIGHT POLLUTION FROM INTERIOR
LIGHTS, PARTICULARLY DURING MIGRATION PERIODS

- SELECTION OF APPROPRIATE EXTERNAL LIGHTING
FIXTURES TO ELIMINATE DIRECT UPWARDS LIGHT.

REDUCE SPILL LIGHT AND OPTIMIZE USEFUL LIGHT DENSITY PATTERN BETWEEN NO MORE THAN 100mm x 100mm APART (\*1)

4 | 2020-08-21 | ISSUED FOR SPA 2 | 2020-02-03 | ISSUED FOR SPA 1 | 2019-06-14 | ISSUED FOR SPA # | DATE | DES



JAC CONDOS

1 TO 50 SOUTH ELEVATION PART B

MDL CHECKED BY AYU SCALE As indicated



SPA313B


### 67 Lesmill Road Toronto, ON, M3B 2T8 T 416 425 2222 turnerfleischer.com scaled. The architect is not responsible for the accuracy of survey, structural, mecnanical, electrical, etc., information shown on this drawing. Refer to the appropriate consultant's drawings before proceeding with the work. Construction must conform to all applicable codes and requirements of authorities having jurisdiction. The contractor working from drawings not specifically marked 'For Construction' must assume full responsibility and bear costs for any corrections or damages resulting from his work. OUTDOOR **EXTERIOR FINISHES LEGEND AMENITY** 1A BRICK - DARK RED (ROSE) 1B CONCRETE 2A METAL PANEL - PURPLE 2B METAL PANEL - DARK GREY 2C LOUVRE - MEDIUM GREY FLOOR 7 117.650 3 ALUMINIUM CAP - LIGHT GREY 4 EIFS PANEL SANDBLASTED - DARK GREY 6C 5 CLEAR GLAZING 5A BIRD FRIENDLY GLASS 6A SPANDREL GLASS - LIGHT GREY 6B SPANDREL GLASS - DARK RED 6C SPANDREL GLASS - DARK GREY FLOOR 6 114.700 7 FROSTED GLASS - WHITE 8 ALUMINIUM WINDOW FRAME - DARK GREY GENERAL NOTES IN ACCORDANCE WITH THE BIRD-FRIENDLY DEVELOPMENT GUIDELINES (FIRST 12 METERS ABOVE GRADE AND 4 METERS ABOVE GREEN FEATURE): 6B PROVISION OF VISUAL MARKERS VISUAL MARKERS TO ALERT BIRDS WILL BE PROVIDED. METHODS OF ACHIEVING THIS ARE AS FOLLOWS: - VISUAL MARKERS APPLIED TO GLASS WITH A MAXIMUM SPACING OF 100mm x 100mm - LOW REFLECTANCE OR OPAQUE MATERIALS - BUILDING-INTERGRATED STRUCTURES TO MUTE REFLECTIONS ON GLASS SURFACES FLOOR 5 111.900 REDUCTION OF LIGHT POLLUTION - REDUCTION OF LIGHT POLLUTION FROM INTERIOR PARTICULARLY DURING MIGRATION PERIODS - SELECTION OF APPROPRIATE EXTERNAL LIGHTING FIXTURES TO ELIMINATE DIRECT UPWARDS LIGHT. REDUCE SPILL LIGHT AND OPTIMIZE USEFUL LIGHT DENSITY PATTERN BETWEEN NO MORE THAN 100mm x 100mm APART (\*1) FLOOR 4 109.100 FRITTED GLASS WILL BE TREATED WITH A DENSITY PATTERN OF VISUAL MARKERS NO MORE THAN 100mm X 100mm APRT FOR THE FIRST 12M ABOVE GRADE. (TORONTO GREEN STANDARD EC4.1) FLOOR 3 106.300 4 2020-08-21 ISSUED FOR SPA 2 2020-02-03 ISSUED FOR SPA 1 2019-06-14 ISSUED FOR SPA # DATE DE FLOOR 2 103.350 JAC CONDOS 308-314 Jarvis Street & 225 Mutual Street, Toronto, Ontario, Canada WALL EXIT BIKE STORAGE ESTABLISHED GRADE SCONCE 99.000 ROOM MCLEAR PL. HERITAGE BUILDING 6' TALL GLASS SCREEN FLØOR 1 LANDSCAPE PROJECT NO. 98.250 **SCREENING WALL** 18.189CS PROJECT DATE JARVIS ST. 2020-08-18 DRAWN BY MDL NORTH ELEVATION 1-50 PART A 1:50 CHECKED BY AYU SCALE As indicated SPA314A

# TURNER FLEISCHER

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1 TO 50 NORTH ELEVATION PART A





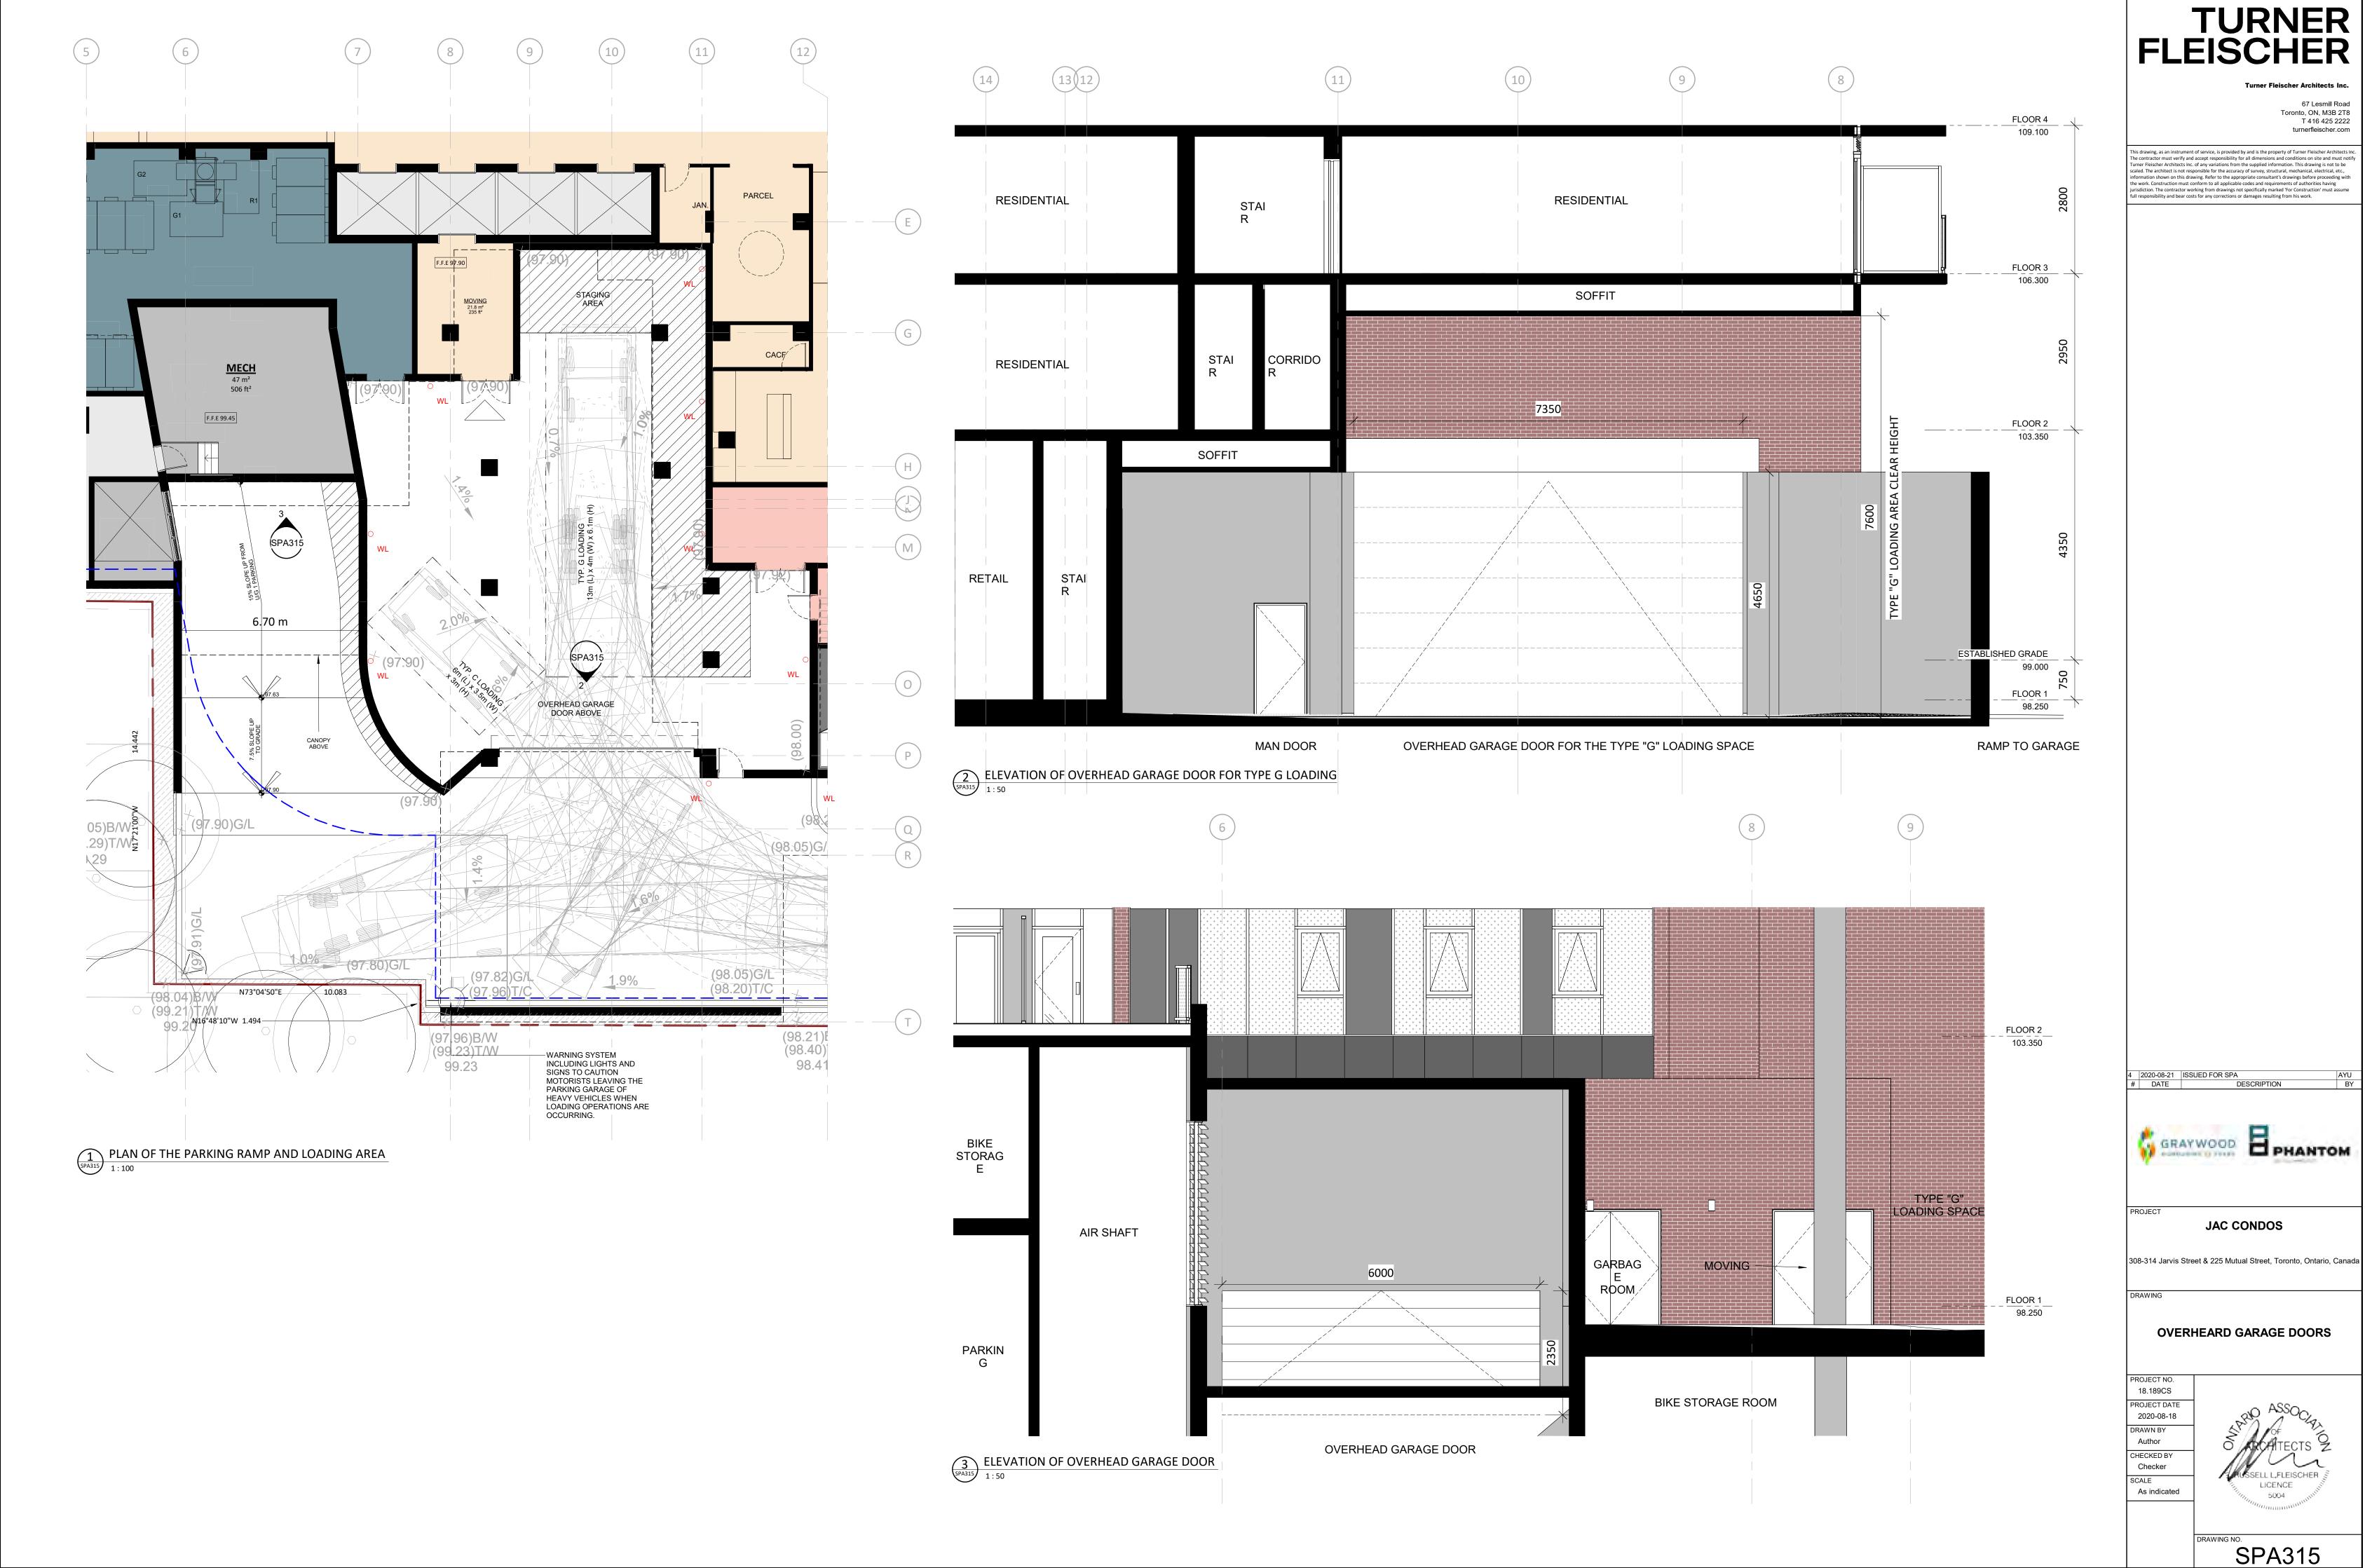

## 308 -314 JARVIS ST. PROPOSED EVELOPMENT Ten Call Her milliam minim Desil silver THE CHINE minima THE REAL PROPERTY. 111 CALTON ST. toll allam PARKSIDE STUDENT RESIDENCE The Chine muniam 296 JARVIS ST. minism TO HUHER THE POSITION AND PARTY. militam ATHERINET. THE RESIDENCE THE RESERVE Test et et 300 JARVIS ST. 330 JARVIS ST. RAMADA PLAZA 354 JARVIS ST. 336 - 344 JARVIS ST. NATIONAL BALLET SCHOOL OF CANADA PEDE 288 JARVIS ST.

**CARLTON STREET** 








BRICK - YELLOW RENDER-YELLOW




CONCRETE - GREY MURAL


MCCLEAR PL.

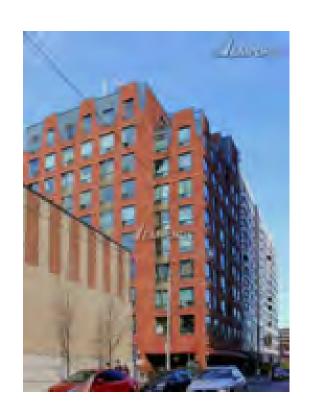

BRICK - RED METAL ROOF - GREEN

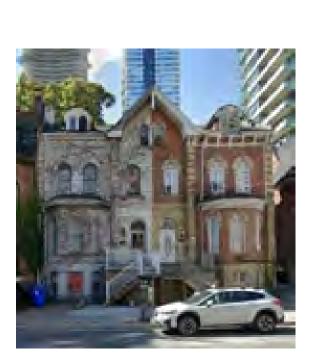

BRICK - RED AND YELLOW

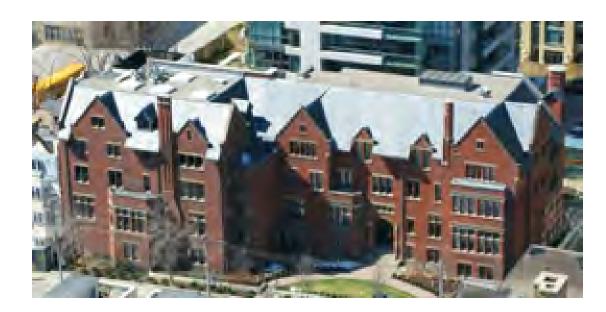

BRICK - RED SLATE ROOF - GREY



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4 | 2020-08-21 | ISSUED FOR SPA # | DATE | DE GRAYWOOD B PHANTOM

DESCRIPTION

JAC CONDOS

308-314 Jarvis Street & 225 Mutual Street, Toronto, Ontario, Canada

**JARVIS STREET ELEVATION** 

PROJECT NO. 18.189CS PROJECT DATE 2020-08-18 Author CHECKED BY Checker





**CARLTON STREET** 

MCCLEAR PL.



BRICK - YELLOW



BRICK - YELLOW METAL PANEL - BEIGE CONCRETE PRECAST



BRICK - RED WOOD SHINGLE - BLACK



BRICK - RED SIDING - BROWN ROOF - ASPHALT SHINGLE GREY



BRICK - RED SLATE ROOF - GREY



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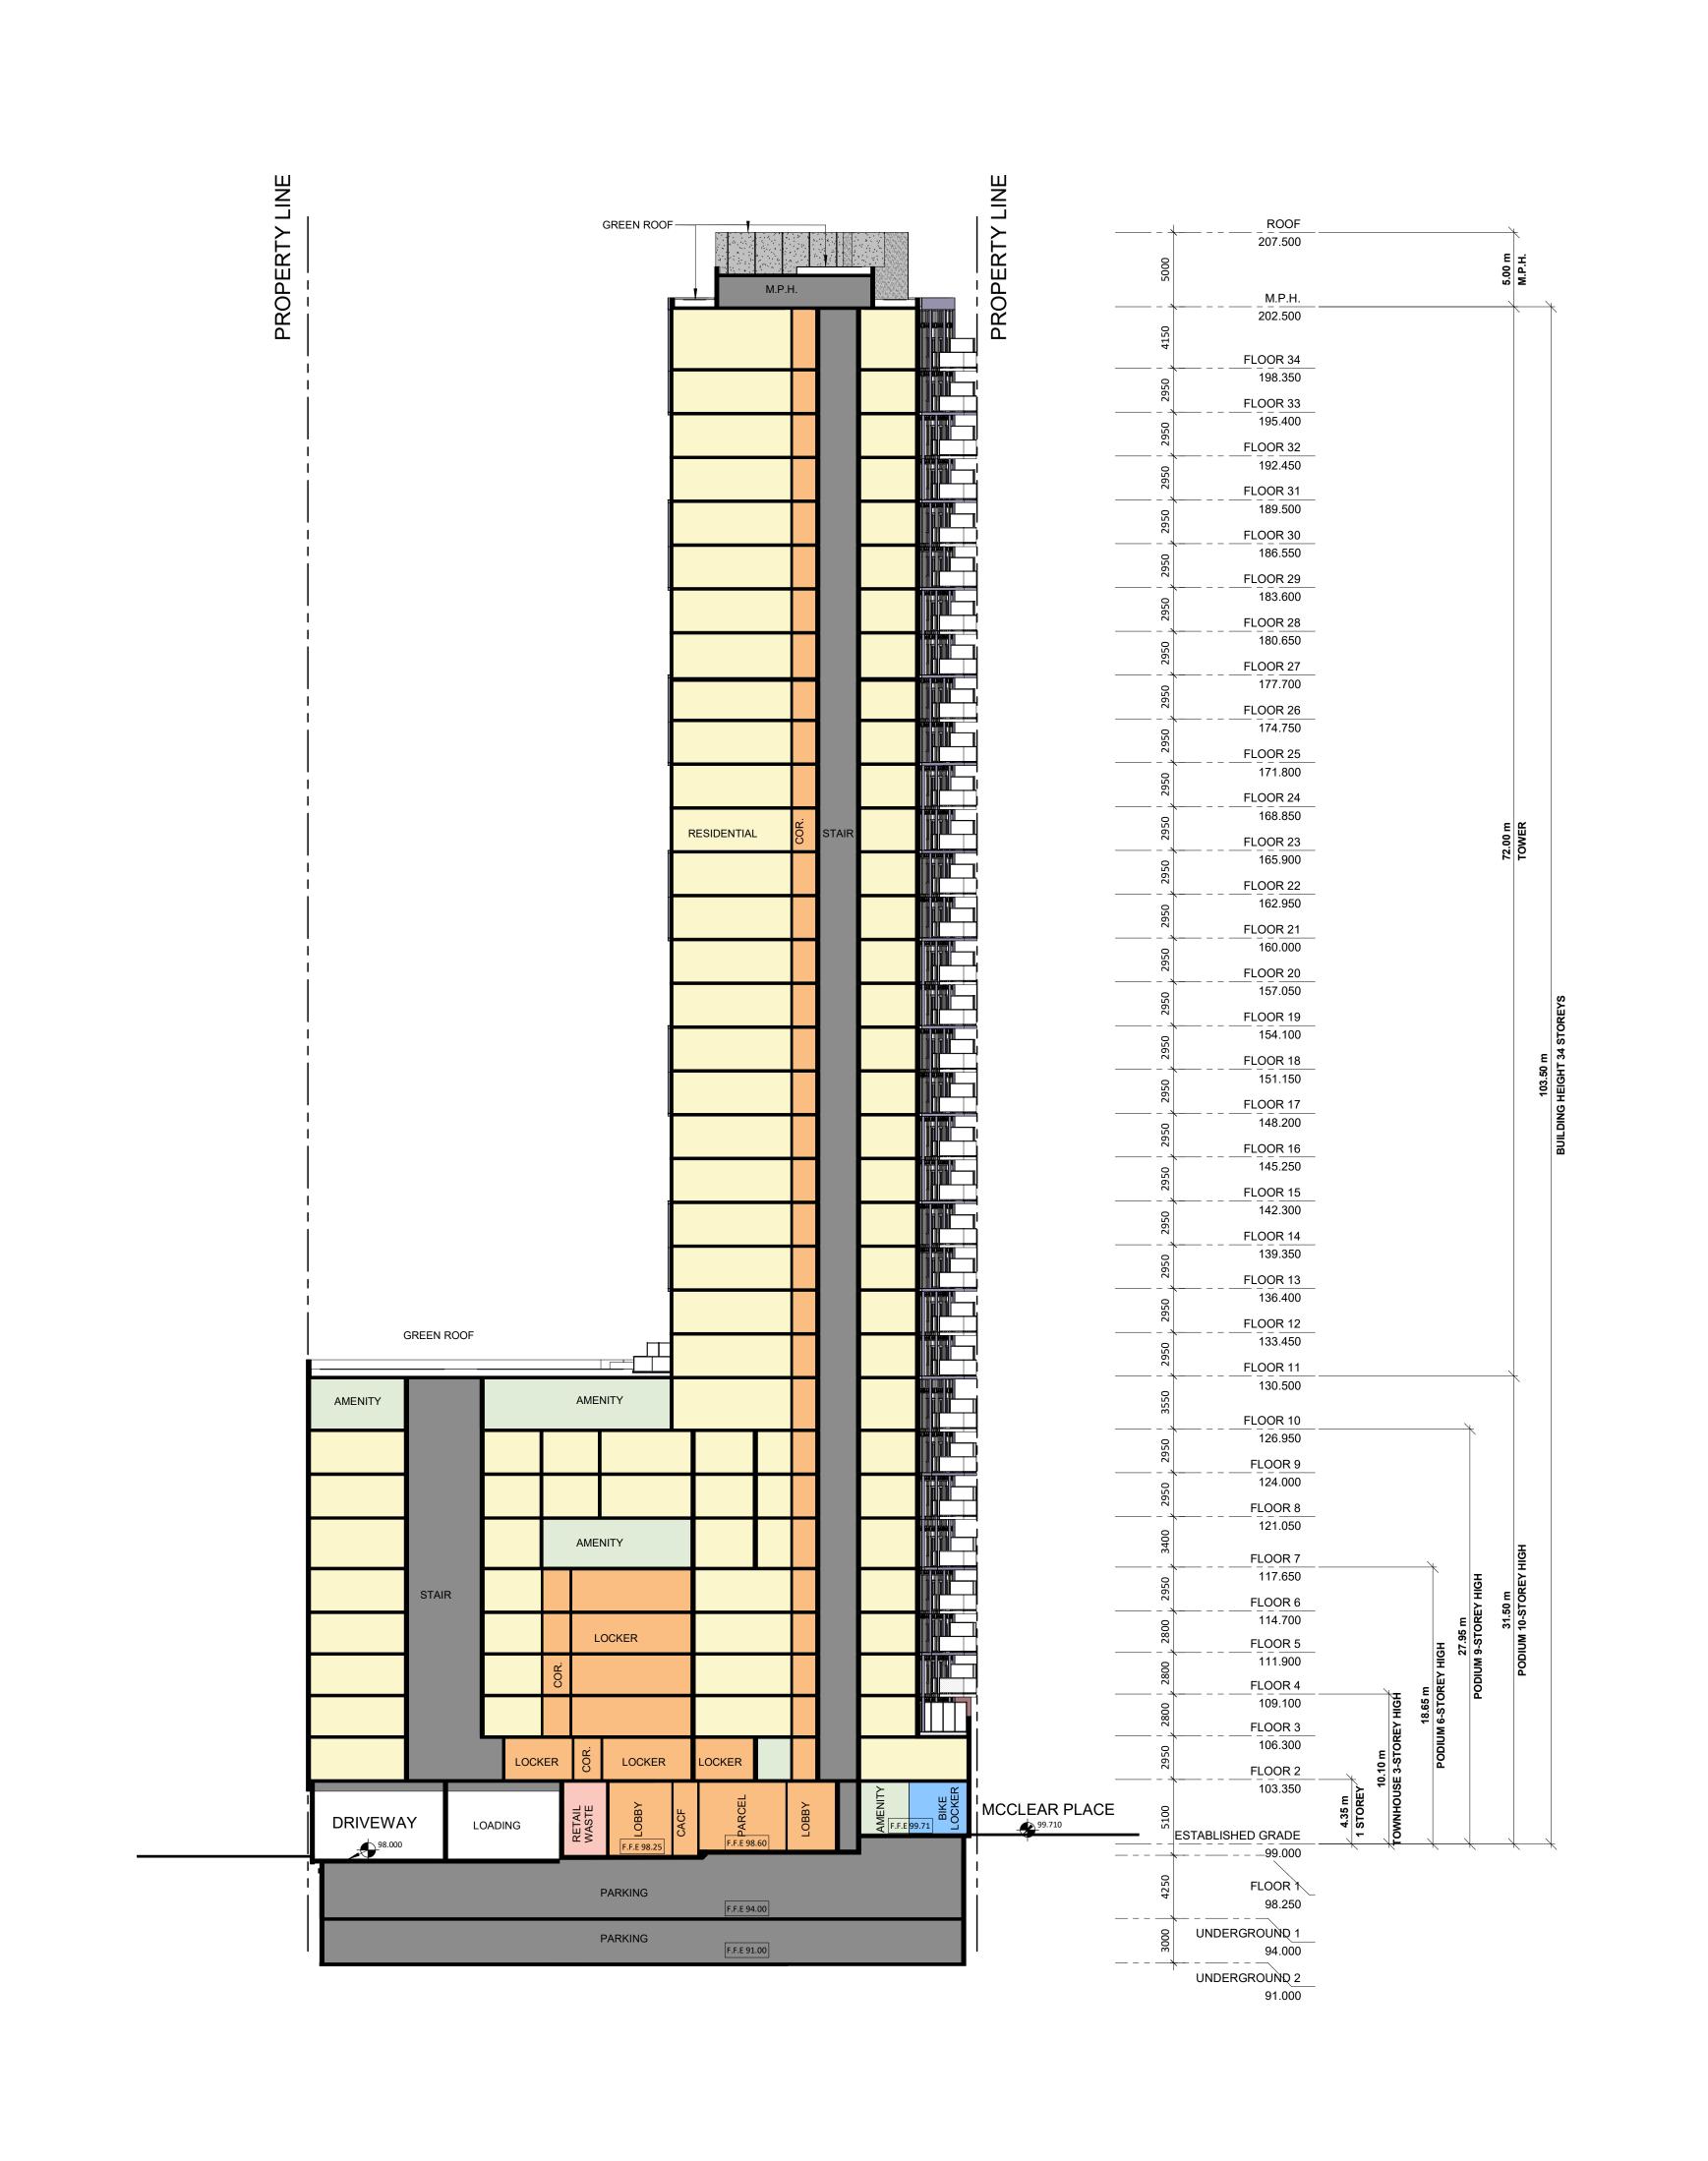


308-314 Jarvis Street & 225 Mutual Street, Toronto, Ontario, Canada

MUTUAL STREET ELEVATION

PROJECT NO.
18.189CS
PROJECT DATE
2020-08-18
DRAWN BY
MDL
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PROJECT JAC CONDOS


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NORTH-SOUTH SECTION


PROJECT NO. 18.189CS PROJECT DATE 2020-08-18 DRAWN BY MNZ

SCALE

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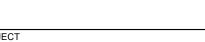
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JAC CONDOS

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DRAWING

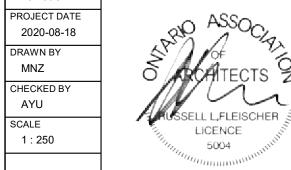**WEST-EAST SECTION** 
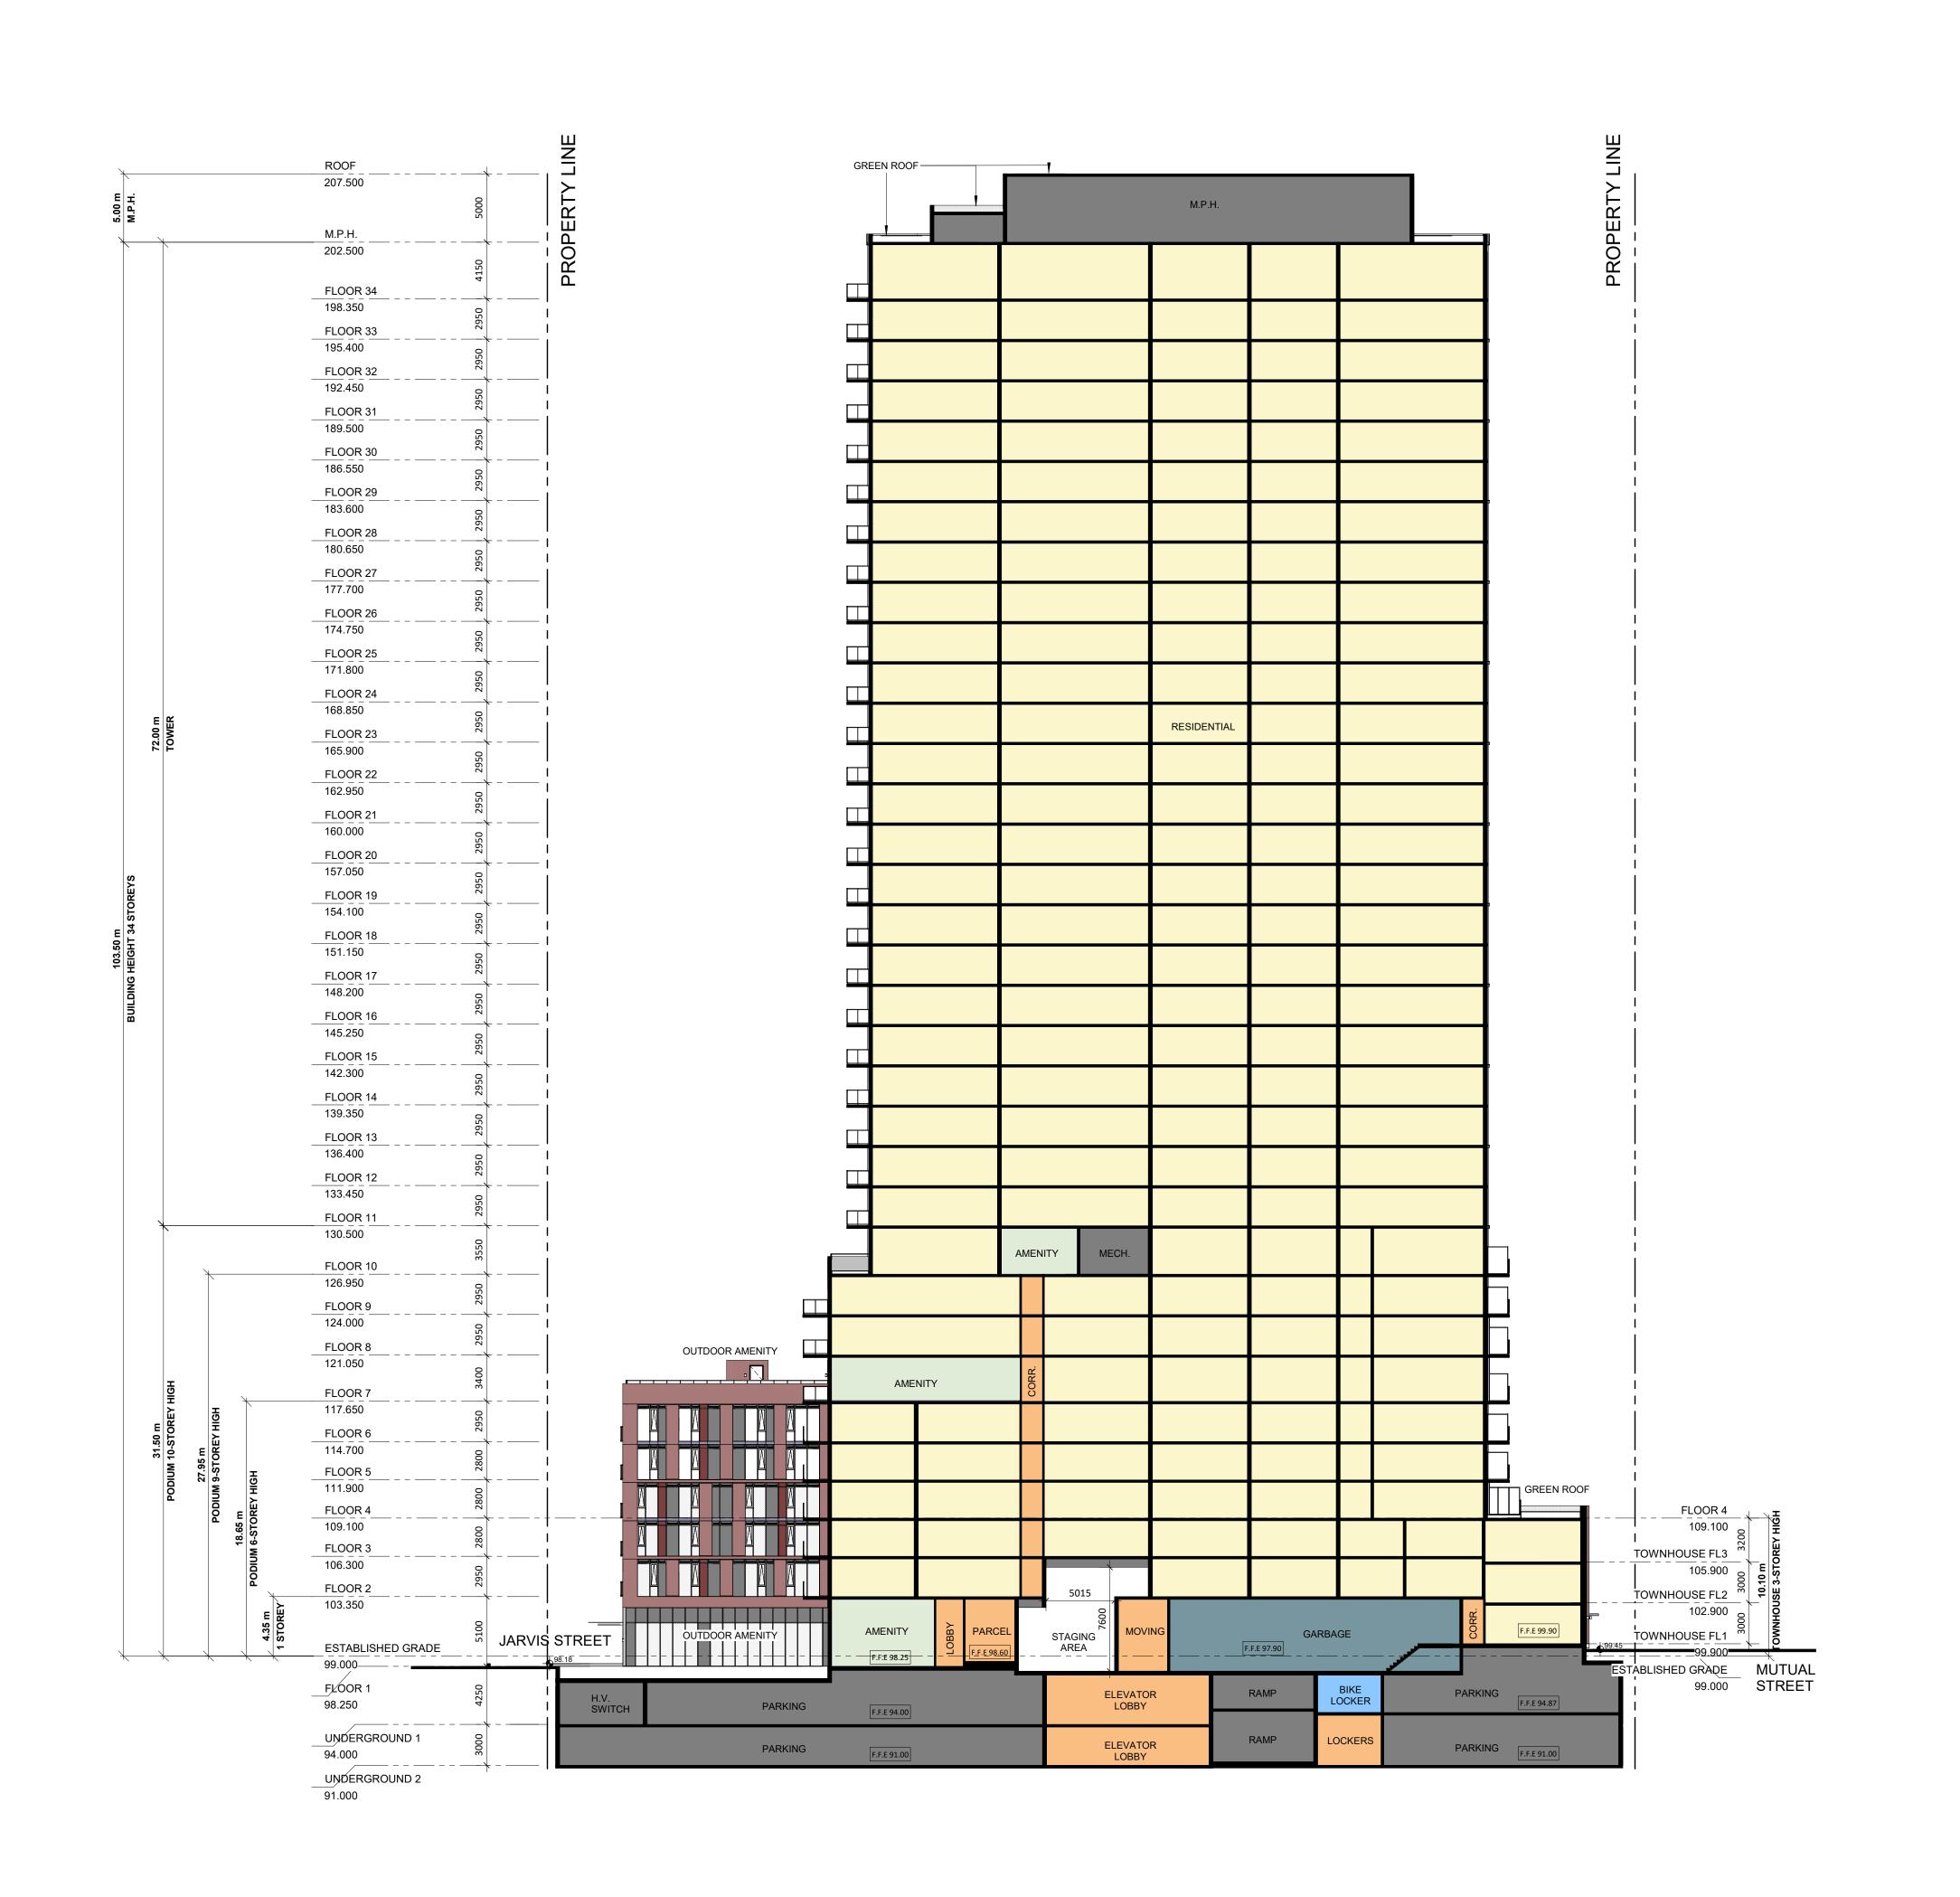
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PROJECT DATE
2020-08-18
DRAWN BY
MNZ
CHECKED BY
AYU

SCALE


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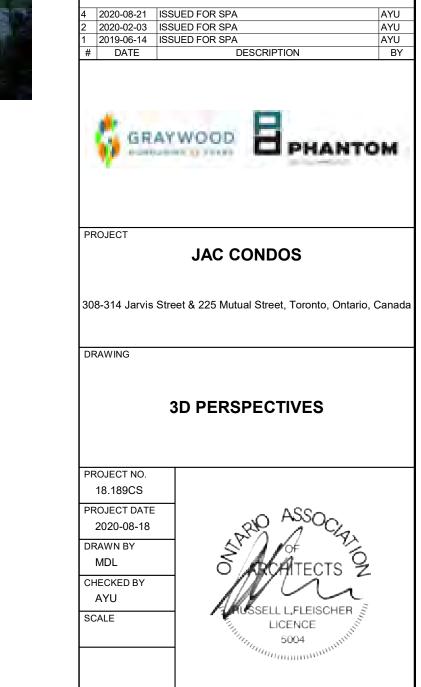
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AERIAL VIEW LOOKING SOUTHWEST FROM CARLTON ST. AND ALLAN GARDENS



PEDESTRIAN VIEW LOOKING WEST FROM JARVIS ST.



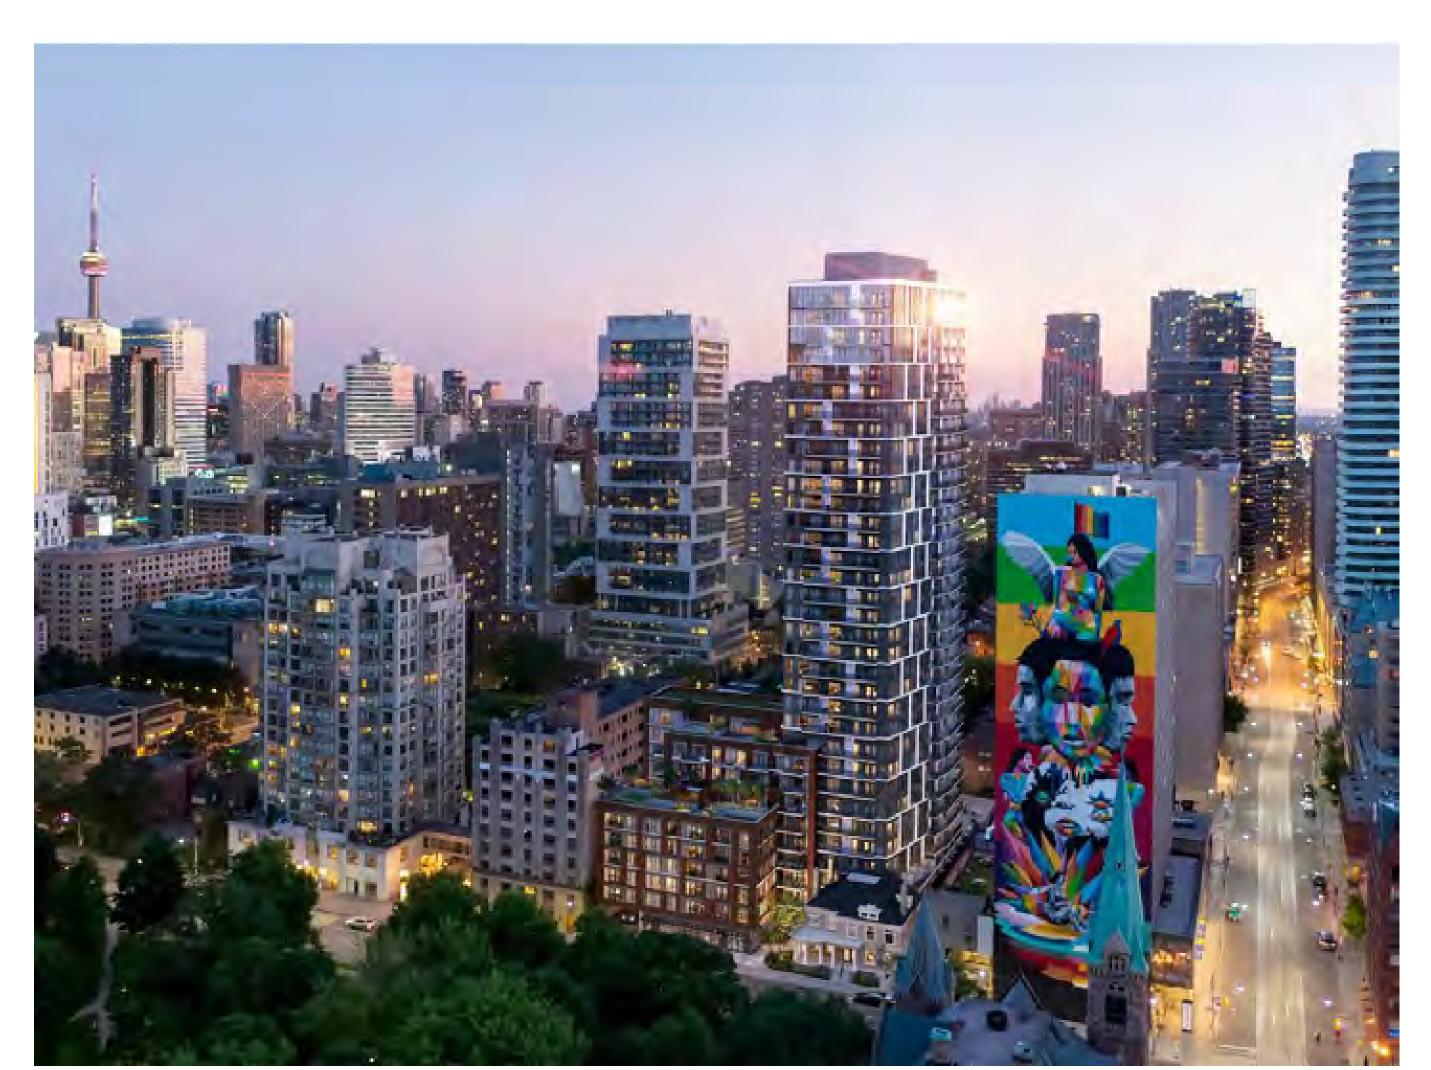

PEDESTRIAN VIEW LOOKING NORTHWEST FROM ALLAN GARDENS



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**3D PERSPECTIVES** 

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