Christopher J. Tanzola Partner Direct 416-730-0645 Cell 416-428-7493 ctanzola@overlandllp.ca Overland LLP 5255 Yonge St, Suite 1101 Toronto, ON M2N 6P4 Tel 416-730-0337 overlandllp.ca



#### WITHOUT PREJUDICE

March 25, 2022

#### VIA EMAIL

Sara Amini
Solicitor, Planning & Administrative Tribunal Law
City of Toronto, Legal Services Division
Metro Hall, 26<sup>th</sup> Floor
55 John Street
Toronto, ON M5V 3C6

Dear Ms. Amini:

RE: 2810-2814 Bayview Avenue

Applications for Official Plan Amendment and Zoning By-law Amendment

City File Nos. 19150397 NNY 18 OZ

OLT Case Nos. OLT-21-001387, OLT-21-001388

\*\* Offer to Settle \*\*

We are the lawyers for Dormer Bay Inc. ("**Dormer**"), being the owner of the properties municipally known as 2810, 2812 and 2814 Bayview Avenue (collectively, the "**Property**").

This Offer to Settle is being made in respect of the above-noted applications filed by Dormer for an Official Plan Amendment and Zoning By-law Amendment, which are the subject of the above-noted appeals (OLT Case Nos. OLT-21-001387, OLT-21-001388, collectively the "Appeals"), before the Ontario Land Tribunal (the "Tribunal"). Dormer made an application for Site Plan Control Approval, which was deemed complete as of February 8, 2022 (City File No. 22 110426 NNY 18 SA, the "Site Plan").

A Request for Directions Report dated October 25, 2021 was prepared by City Staff recommended supporting the Official Plan and Zoning By-law Amendments at the Tribunal hearing, and to continue discussions with the Applicant and the Ministry of Transportation in respect of securing site access from Bayview Avenue. However, on December 15, 2021, City Council made the decision to direct the City Solicitor to attend the Tribunal hearing in opposition to the vehicular access and parking spaces proposed, and to retain outside consultants if necessary.

The Appeals are scheduled to proceed to a first Case Management Conference on May 3, 2022 (the "CMC").



In response to comments from area residents and the local Councillor, our client is prepared to settle the Appeals and resolve the Site Plan in principle on the basis of the following matters described below:

- 1. The Proposal may contain a maximum of 30 residential parking spaces and an additional 6 visitor parking spaces;
- 2. Vehicular access will be located from Irvington Crescent, as depicted in the Site Plan;
- 3. The provision of a \$70,000 Section 37 contribution for community improvements payable upon the issuance of the first above grade building permit;
- 4. The City will support in principle the Development, generally in accordance with the attached plans submitted with the Site Plan (with necessary revisions to pages d A2.01, dA2.02, and dA2.03 to depict 30 residential and 6 visitor parking spaces in the underground levels), consisting of:
  - a. A 7-storey apartment building containing 67 apartment dwelling units, including 35 one-bedroom units (52%), 21 two-bedroom units (31%) and 11 three-bedroom units (16%). The general building envelope does not differ materially from the development that was contemplated at the time of the Appeals. Minor changes in height were made to accommodate mechanical components and the 7<sup>th</sup> storey footprint was revised in an effort to create larger 3-bedroom units to more closely meet the 3-bedroom unit size objectives in the City's Growing Up Guidelines.
  - b. A gross floor area of approximately 5,123 square metres, and a floor space index of 2.89.
  - c. A connected indoor and outdoor amenity space at ground floor, with a total area of 238 square metres.
  - d. Bicycle parking with 64 spaces, including 8 bicycle spaces at grade.
- 5. The City and Dormer will cooperate to finalize the Zoning By-law Amendments to 569-2013 and former City of North York Zoning By-law 7625, including the Section 37 obligations prior to any changes in legislation regarding Section 37 of the Planning Act or other changes regarding an additional community benefits charge;
- 6. The City Solicitor will advise the Tribunal of the City's support for the Official Plan Amendment and Zoning By-law Amendments at their earliest opportunity, including the upcoming CMC.

(collectively, the "Settlement Offer")

We note that the Settlement Offer is being put forward as an entire package for consideration, and must be accepted by Council in its entirety.

#### overland

If the Settlement Offer is accepted by the City, the parties agree that Dormer (as the Applicant) will lead land use planning evidence in support thereof at the OLT CMC scheduled on May 3, 2022, or as soon thereafter as directed by the Tribunal and the parties will write to the case coordinator advising of the Settlement Offer and requesting the May 3, 2022 CMC date be transformed into a settlement hearing.

In advance of the CMC, the parties will work together to resolve the final form of implementing instruments (Official Plan Amendment and Zoning By-law Amendments).

This Settlement Offer is open until the conclusion of the City's April 2022 Council Meeting, following which it will become null and void if not accepted. If the Settlement Offer is accepted, Dormer consents to the Settlement Offer and City Council's consideration thereof being made public. The City acknowledges that in the event of acceptance of the Settlement Offer, Dormer may publicly refer to the terms of the settlement.

Yours truly,

**Overland LLP** 

Per: Christopher J. Tanzola

Partner

Encl.




## **2810 - 2814 BAYVIEW AVENUE,** NORTH YORK, ONTARIO

PROPOSED RESIDENTIAL DEVELOPMENT

		v 30 2018 y 31 2020 v 20 2020 r 21 2021 r 13 2022
С	Sheet Name	July Nov Jan
11 REZOI 40		
dA0.00	Cover Sheet  Context Plan	
dA1.01 dA1.02 dA1.03	Survey Site Plan	
dA1.04 dA1.05	Site Statistics Toronto Green Standard	
A2 dA2.01	Underground Parking Level P2 Floor Plan	
dA2.02 dA2.03	Underground Parking Level P1 Floor Plan Ramp Access Lower Level 174.30	
dA2.04 dA2.05	Ground Floor Plan L1 Level 2-5 Floor Plan	
dA2.06 \4	Level 6- Top of MPH Floor Plan	
dA4.01 dA4.02	West Elevation East Elevation	
	South Elevation  North Elevation	
dA4.05 A5 dA5.01	1.50 East Elevation  Transverse Cross Section	
dA5.02	Transverse Cross Section  Longitudinal Cross Section	
<del>\</del> 6	Perspective Views	
A7 dA7.01	Sun Shadow Study - June	
	Sun Shadow Study - March/September Sun Shadow Study - December	
	SULTANT TEAM 814 Bayview Ave 18069	SURVEY:
	DORMER BAY INC.	NAME: ERTL SURVEYORS
ADDRE	ESS: UNIT 204-255 DUNCAN MILL RD. NTO, ON	ADDRESS: 1234 REID ST. UNIT 10, RICHMOND HILL, ON
TEL: 64	47 429 7090 x 103 ormerhomes.ca	TEL: 905 731 7834 www.es-ols.com
	KIRKOR ARCHITECTS & PLANNERS	PLANNER:  NAME: EVANS PLANNING INC.
ADDRE	ESS: 20 DE BOERS DR. SUITE #400, NTO, ON	ADDRESS: 8481 KEELE ST. UNIT 12, VAUGHAN, ON
TEL: 4	16 665 6060 rkorarchitects.com	TEL: 905 669 6992 x 102 www.evansplanning.com
	ENGINEER:	NOISE:
	COLE ENGINEERING	NAME: HGC ENGINEERING
	ESS: 70 VALLEYWOOD DR. HAM, ON	ADDRESS: 2000 ARGENTIA RD. PLAZA 1, SUITE 203, MISSISSAUGA, ON
	16 987 6161 bleengineering.ca	TEL: 905 826 4044 www.acoustical-consultants.com
LANDS	SCAPE ARCHITECT:	ARBORIST:
	NAK DESIGN STRATGIES	NAME: DILLON CONSULTING
AVE, T	ESS: 421 RONCESVALLES ORONTO, ON	ADDRESS: 800-235 YORKLAND BLVD. TORONTO, ON
	16 340 6724 akdesignstrategies.com	TEL: 416 229 4647 x 2350 www.dillon.ca
HYDRO	DGEOLOGICAL ENGINEER:	GEOTECHNICAL ENGINEER:
	EDWARD WONG & ASSOCIATES INC.	NAME: EDWARD WONG & ASSOCIATES INC.
UNIT 1	ESS: 441 ESNA PARK DR. 9, MARKHAM, ON	ADDRESS: 441 ESNA PARK DR. UNIT 19, MARKHAM, ON
	16 903 4288 dwardwongassociates.com	TEL: 416 903 4288 www.edwardwongassociates.com
TRAFF	IC:	PEDESTRAIN LEVEL WIND STUDY:
	TRANS-PLAN INC. ESS: 785 DUNDAS ST. W. TORONTO,	NAME: GRADIENTWIND ENGINEERING ADDRESS: 127 WALGREEN RD. OTTAWA,
ON. M	•	ON TEL: 613 836 0934 x 113
	ans-plan.com	www.gradientwind.com
AIR QL	JALITY ANALYSIS:	ELECTRICAL / LIGHTING:
	NOVUS ENVIRONMENTAL ESS: 150 RESEARCH LANE, SUITE 105,	NAME: GHD ADDRESS: 184 FRONT ST. EAST. SUITE 302
GUELF	PH, ON 26 706 8080 x 216	M55A 4N3 TORONTO, ON TEL: 416 360 1600
	ovusenv.com	www.ghd.com/en-ca/index.aspx
	ANICAL ENGINEER:	STRUCTURAL ENGINEER:
ADDRE	NOVATREND ESS: 54 West Beaver Creek Rd #200,	NAME: JABLONSKY, AST AND PARTNERS ADDRESS: 400-3 CONCORDE GATE M3C 3N7
TEL: 90	ond Hill, ON L4B 3M1 05 885 5445 X 222	TORONTO, ON TEL: 416 447 7405
	novatrend.ca / tmui@novatrend.ca	www.astint.on.ca
ENERG	SY EFFICIENCY:	
	EDGECOM	

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Authorities Having Jurisdiction
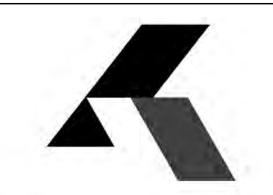
#### KIRKOR ARCHITECTS AND PLANNERS

20 De Boers Dr. # 400 Toronto ON M3J 0H1 EL 416 665 6060 kirkorarchitects.com

JAN 13, 2022 JAN 21,2021 NOV 20,2020 JULY 31,2020

Re-zoning Re-zoning Re-zoning MAY 1,2019 Drawing Title:

Cover Sheet

Dormer Homes

2810-2814 Bayview Ave.

Related File: OPA/ZBA: 19 150397NNY 18 OZ

January 13, 2022 2810-2814 Bayview Ave.

> Checked by D.S.

Project No. 18069

SHEPPARD AVE E
SHEPPARD AVE
BANNEW AVE

PROPOSED 7 STOREY

**APARTMENT USE** 

**BUILDING** 

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KIRKOR ARCHITECTS AND PLANNERS

20 De Boers Dr. # 400 Toronto ON M3J 0H1 TEL 416 665 6060 kirkorarchitects.com

No.: Revision: Date

5 Site Plan Control Application JAN 13, 2022
4 Re-zoning JAN 21,2021
3 Re-zoning NOV 20,2020
2 Re-zoning JULY 31,2020
1 Re-zoning MAY 1,2019

Date:

Context Plan

Client:

Dormer Homes

Proje

2810-2814 Bayview Ave.

Related File: OPA/ZBA: 19 150397NNY 18 OZ January 13, 2022

2810-2814 Bayview Ave.

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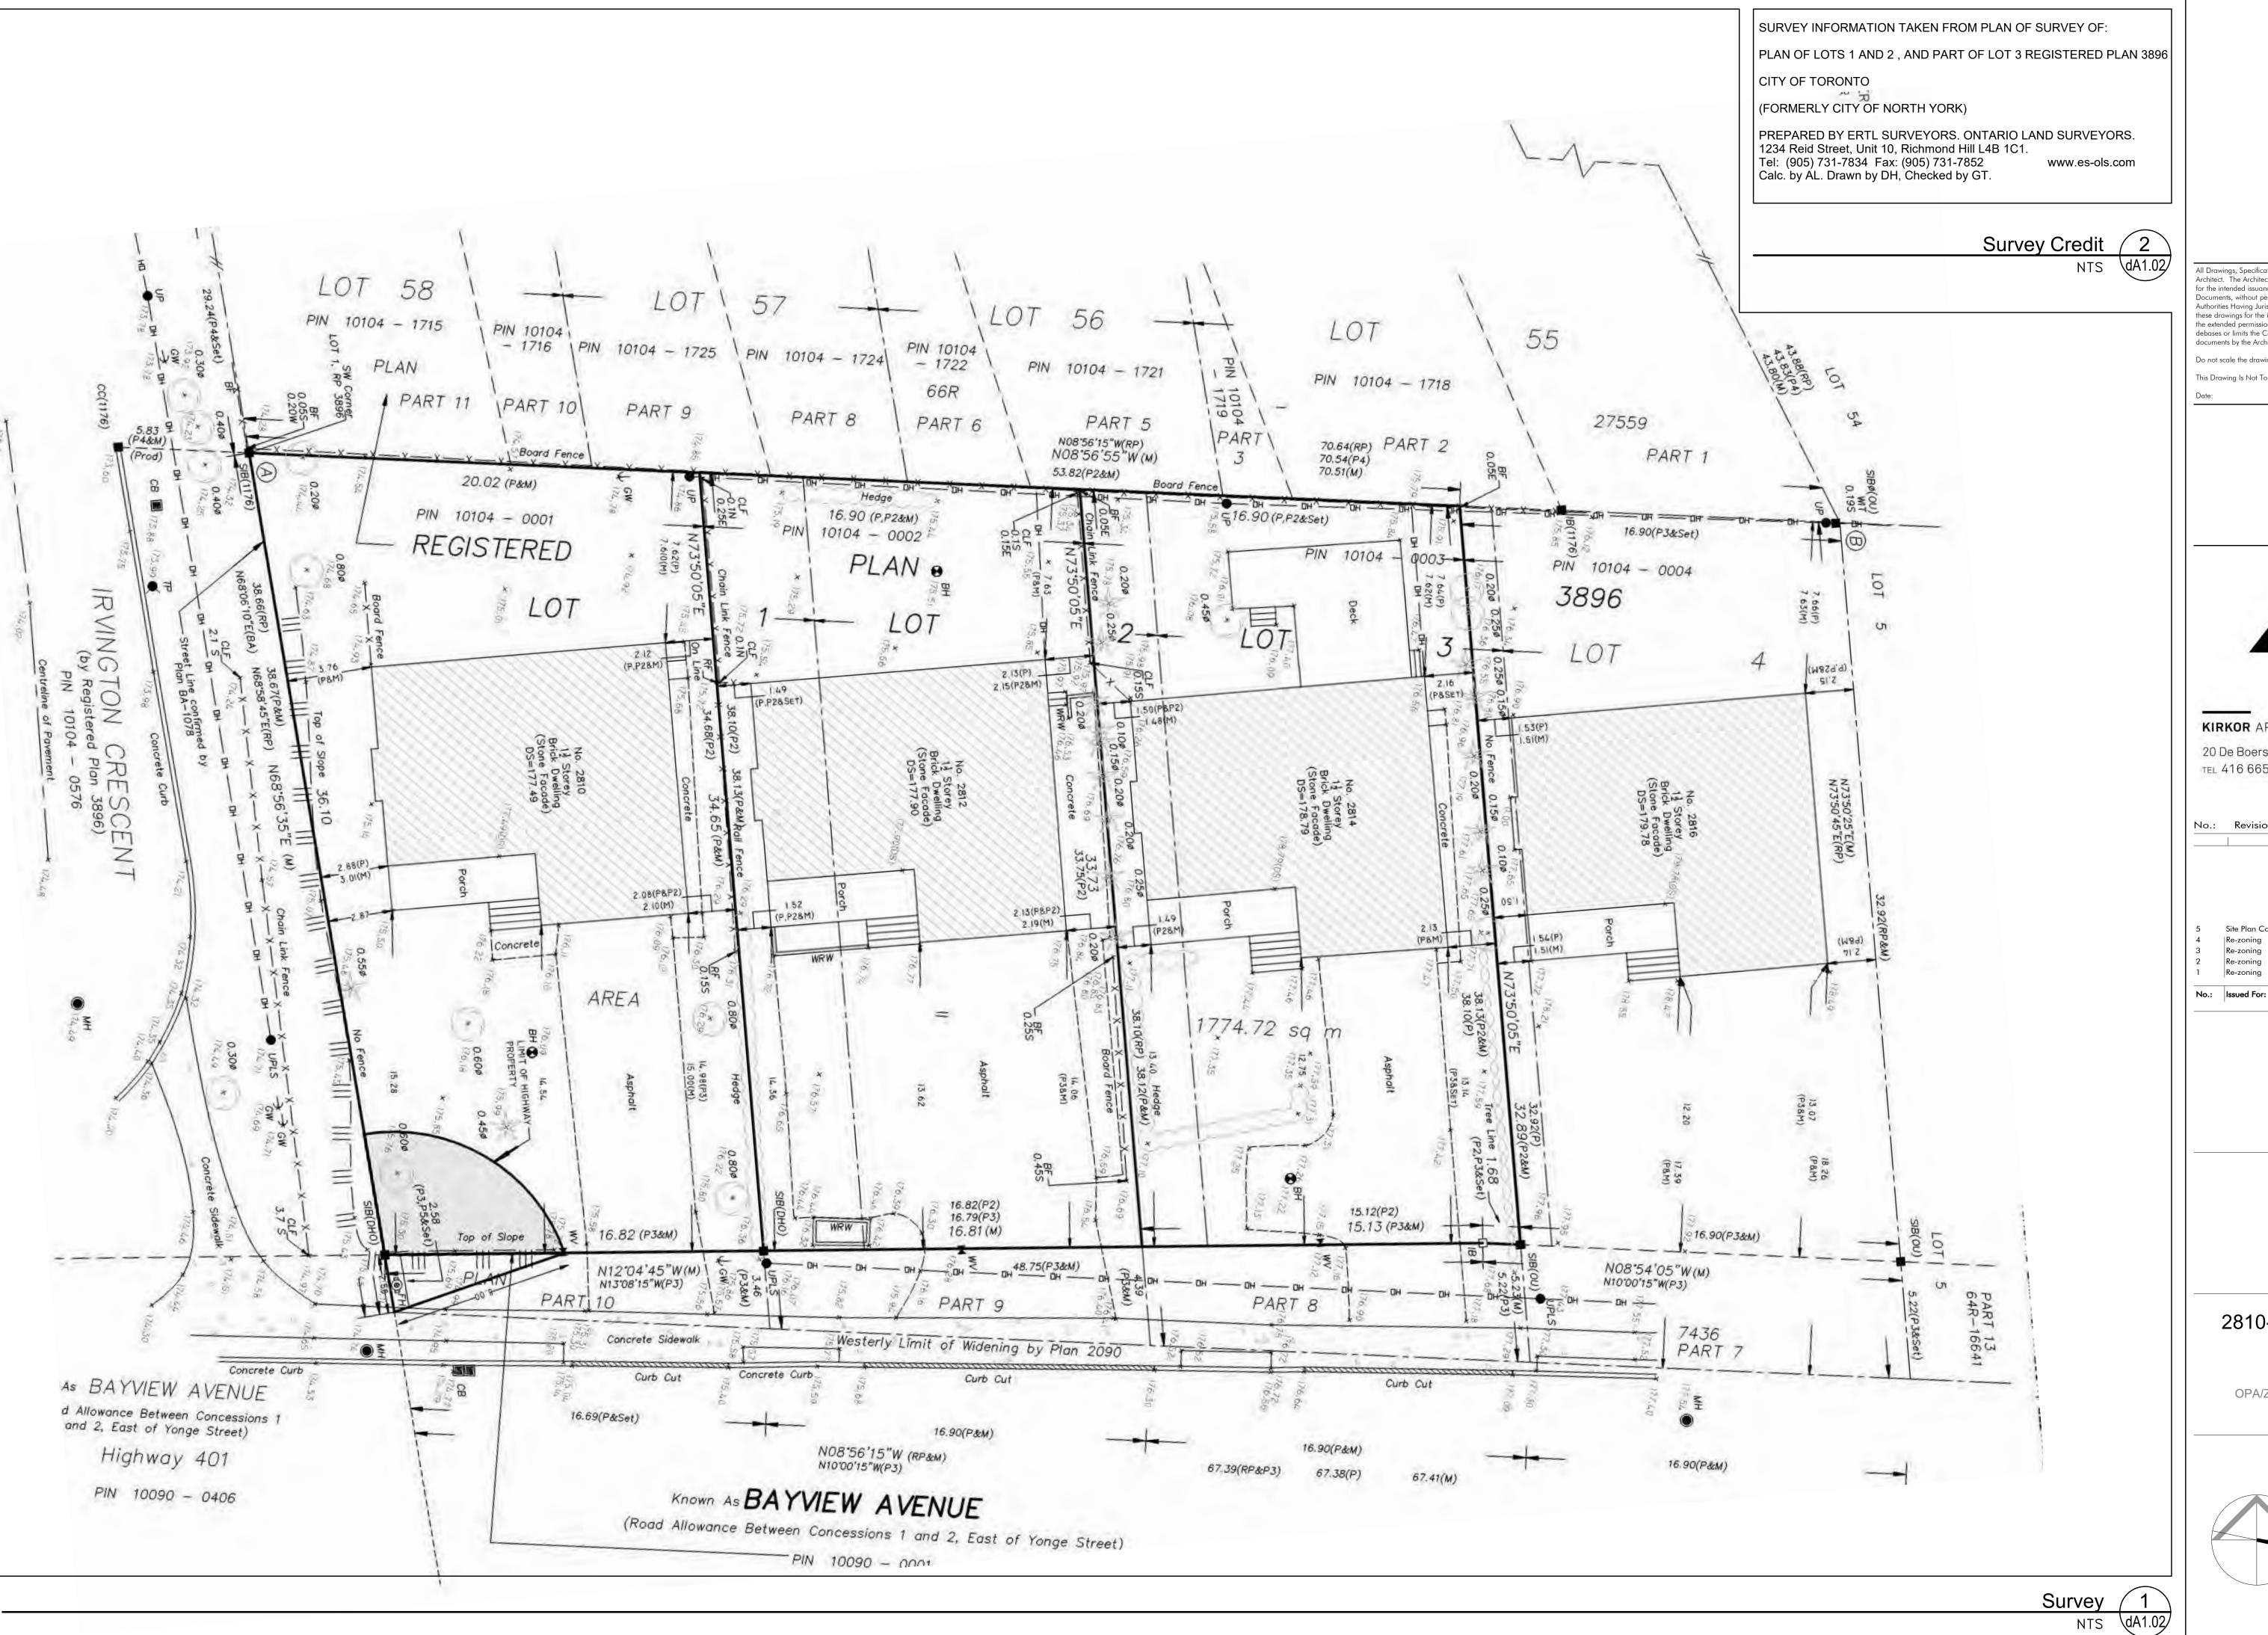
D.S.

Checked by:

Project No.:

January 13, 2022

dA1.01



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Revision:

Site Plan Control Application

Re-zoning Re-zoning Re-zoning

Drawing Title

Survey

JAN 13, 2022

JAN 21,2021

NOV 20,2020

JULY 31,2020

MAY 1,2019

**Dormer Homes** 

2810-2814 Bayview Ave.


Related File: OPA/ZBA: 19 150397NNY 18 OZ January 13, 2022

2810-2814 Bayview Ave

Drawn by

1:200 A. I. D.S.

Checked by Project No. 18069 January 13, 2022

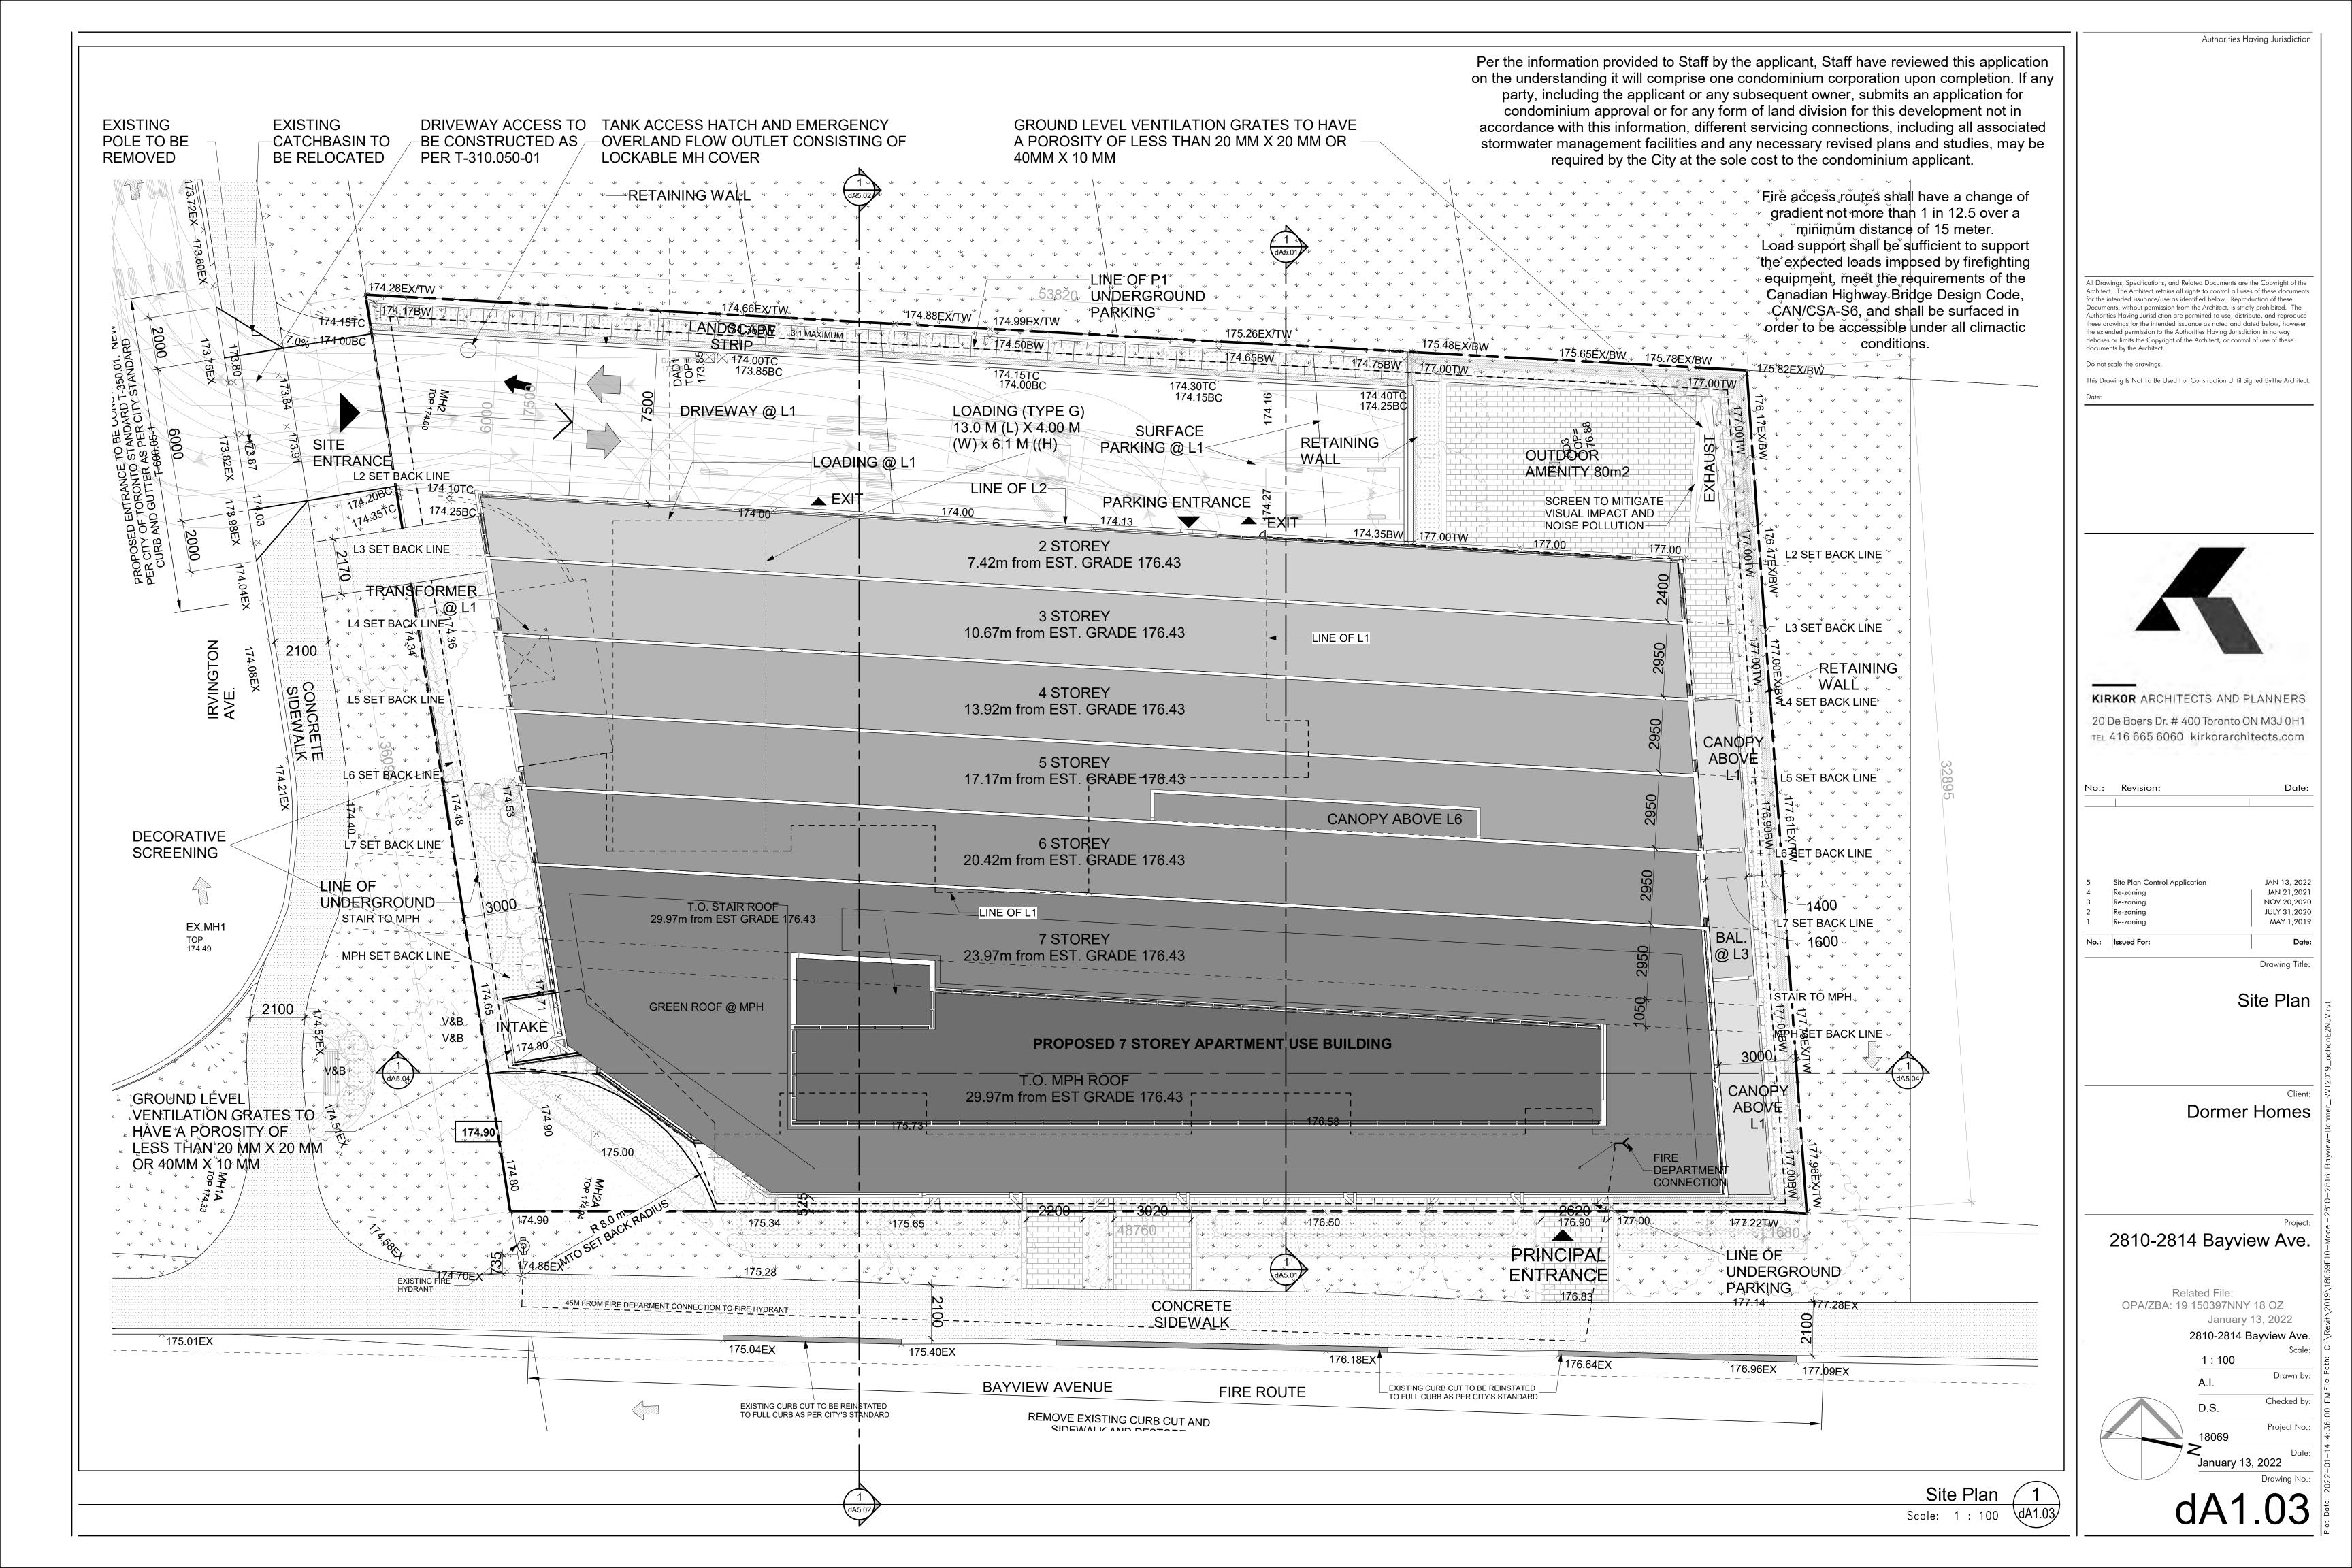

- 1. SURVEY CREDIT: PLEASE REFER TO ERTL SURVEYORS DWG FOR SURVEY INFORMATION
- 2. SITE SERVICING: PLEASE REFER TO COLE ENGINEERING DWG FOR SITE SERVICING INFORMATION
- 3. LANDSCAPE: PLEASE REFER TO NAK DWG FOR LANDSCAPE INFORMATION
- 4. TRAFFIC: PLEASE REFER TO NEXTRANS CONSULTING DWG FOR TRAFFIC INFORMATION

General Notes 6

	OBC Matrix 2 - Site Plan Approval	
	Kirkor Architects & Planners 20 De Boers Dr. Suite #400 Toronto, Ontario M3J 0H1 T: 416-665-6060 F: 416-665-1234  Name of Project:	
	2810-2816 BAYVIEW  Location: 2810-2816 BAYVIEW AVE., NORTH YORK, ONTARIO  Seal must be signed.	ed to be valid
ltem	The Ontario Building Code 2012 Containing the Building Code Act and O. Reg 332/12 in effect Jan 1, 2014  Data Matrix Part 3  High Rise Residential Buildings	OBC Reference
1	Project Description: New Residential Apartment Bldg with retail at grade and 2 levels of underground parking	1.1.2.
2	Major Occupancy(s):  Group C - Residential occupancies	3.1.2.1.(1)
3	Subsidiary Occupancy(s)  Group A2 – Assembly occupancies (Amenity Areas)	3.1.2.1.(1)
4	Building Area (m <sup>2</sup> ) 1175 m <sup>2</sup>	1.4.1.2.
5	Gross Area (m²) 5137 m²	1.4.1.2.
6	Number of Storeys 7 Above grade 7 Below grade 2	1.4.1.2. & 3.2.1
7	Number of streets/Fire Fighter Access	3.2.2.10. & 3.2.
8	Building Classification: C	
9	Sprinkler System Proposed  Building Classification  Selected compartments  Selected floor areas	3.2.2.2083
	■ Basement	3.2.1.5.
	■ In lieu of roof rating	3.2.2.17.
10	Standpipe required Yes	3.2.9.
11	Fire Alarm required Yes	3.2.4.
12	Water Service/Supply is Adequate Yes	3.2.5.7.
13	High Building Yes	3.2.6.
14	Construction Restrictions Non-combustible required	3.2.2.20 83.
15	Barrier Free Design Yes	3,8

OBC Matrix 5

	2022 LEGAL DESCRIPTION										Project No. 18-0
	PLAN OF LOTS 1 AND 2 , AND PART O	OF LOT 3 REGIS	TERED PLAN 3896								
	CITY OF TORONTO (FORMERLY CITY OF NORTH YORK)										
	SITE INFORMATION										
	Total Site Area Site Area							hectare 0.18	0.4385	sq.m. 1,774.75	19,1
ш,	Total Site Area  ESTABLISHED GRADE & BUILDIN	NG HEIGHT						0.18	0.4385	1,774.75 Geodetic	19,1 Mete
	Established Grade Building Height (to top of Residen	L. Verreit					(1	74.9+177.96)/2		176.43 200.40	23.9
	Building Height (to top of MPH) SETBACKS									206.40 min provided	29,9
	NORTH EAST (FRONT) - BAYVIEW								_	3M 0.3M	
	SOUTH WEST (REAR) MTO (FRONT LEFT BAYVIEW AVE	E CODNED!								3M 7.5M	
	LOADING SPACE	E. CORNER)								8M Radius Type	-
	Required (31 to 399 dwelling units ) Provided									G G	
	Proposed GFA In the Residential Apartment Zone catego (A) Parking, loading and bicycle parking (B) Required loading spaces at the ground (C) Storage rooms, washrooms, electrically Shower and change facilities required (E) Amenity space required by this By-later (F) Elevator shafts:	g below-ground; und level and requi cal, utility, mechan ed by any City of 1	ired bicycle parking sp. ical and ventilation roo	aces at or above-ground; ms in the basement;		ng used for.					
	(G) Garbage shafts;     (H) Mechanical penthouse; and     (I) Exit stairwells in the building.										
7.1	Building A Level P2 Level P1			floors 1 x 1 x						sq.m. 22.00 22.00	S
	Level 1 Level 2			1 x						494.57 1,051.92	5,: 11,:
	Level 3 Level 4 Level 5			1 x 1 x 1 x						970.53 810.23 689.72	10,4 8,7
	Levels 6 Levels 7			1 x						582.75 479.17	6, 5,
1	Total Proposed Buildingr A Resident  *GFA deduction for required indoor a		ne ner Zoeine Dy las	9		ratio = 2 s	am/pait			5122.89 134.00	55,
	Density / FSI	amenty (ten c)	as per Zuning Byrian	N 309-2013		18110 = 23	<b>ч</b> тынг				
	Site Area Proposed Total GFA FSI									1,774.75 5,122.89 2.89	19,1 55,1
	Residential Unit Count									2.03	
9.1	Building A floors	OT IDIO	10.4 00.1	units/floor	at libia		78.	sub-		Total	
	Level 1 1 x Level 2 1 x		1 Bed 2 Bed 0 0 6 9	3 Bed PH(3Bed) 2 0	STUDIO	1 Bed 0 6	2 Bed 0 9	3 Bed 2 0	PH(3Bed)		
1	Level     3     1 x       Level     4     1 x       Level     5     1 x       Level     6 & 7     1 x       Sub-Total     6	1	10 5 9 4 8 3 2 0	0 0 0	.0	10 9 8 2 35	5 4 3 0 21	0 0 0 0	0 0 0 9	67	
	Avg Unit Size		51.8m <sup>2</sup> 71.67m <sup>2</sup>	96.27m <sup>2</sup>	0%	52%	31%	3%	13%		
700	Dedice			20-6 A	076	- 6.0		7.0	- 1970		
	Parking Required - Including Access	sible Spaces	MINIMUM	W-C V		umber of Uni	ts per Type			MINIMUM	MAXIMU
0.1	Parking Required - Including Accessing Residential  Bachelor up to 4	15 m2	MINIMUM 0.60 per unit	MAXIMUM 0.90 per unit		umber of Uni	ts per Type			MINIMUM	MAXIMU
0.1	Parking Required - Including Accessing Residential	15 m2	0.60 per unit 1.00 per unit 0.70 per unit	MAXIMUM		0 0 35	ts per Type		- 300	0 0 24	MAXIMU
0.1	Parking Required - Including Accessing Residential  Bachelor up to 4  Bachelor over 45  1 Bed 2 Bed 3 Bed  Visitor	15 m2	0.60 per unit 1.00 per unit	MAXIMUM  0.90 per unit 1.30 per unit 1.00 per unit		0	ts per Type		- 300	0 0 24 18 11 6	MAXIMU
0.1	Parking Required - Including Accessing Residential  Bachelor up to 4  Bachelor over 45  1 Bed  2 Bed  3 Bed  Visitor  Sub-total Residents  Sub-total Visitors	15 m2	0.60 per unit 1.00 per unit 0.70 per unit 0.90 per unit 1.00 per unit	MAXIMUM  0.90 per unit 1.30 per unit 1.00 per unit 1.30 per unit 1.50 per unit		0 0 35 21	ts per Type		300	0 0 24 18 11	MAXIMU
0.1	Parking Required - Including Access Residential Bachelor up to 4 Bachelor over 45 1 Bed 2 Bed 3 Bed Visitor Sub-total Residents Sub-total Visitors Grand Total Parking Required Parking Proposed - Including Access	45 m2 5 m2	0.60 per unit 1.00 per unit 0.70 per unit 0.90 per unit 1.00 per unit	MAXIMUM  0.90 per unit 1.30 per unit 1.00 per unit 1.30 per unit 1.50 per unit 0.10 per unit	N	0 0 35 21				0 0 24 18 11 6 53	
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No.: Revision:

JAN 13, 2022 JAN 21,2021 5 Site Plan Control Application 4 Re-zoning 3 Re-zoning 2 Re-zoning 1 Re-zoning NOV 20,2020 JULY 31,2020 MAY 1,2019

No.: Issued For: Drawing Title:

Site Statistics

Dormer Homes

2810-2814 Bayview Ave.

Related File: OPA/ZBA: 19 150397NNY 18 OZ January 13, 2022

2810-2814 Bayview Ave.

Drawn by

Checked by: D.S.

Project No.: 18069

**New Non-Residential Development** The Toronto Green Standard Version 3.0 Statistics Template is submitted with Site Plan Control Applications and stand alone Zoning Bylaw Amendment applications. Complete the table and copy it directly onto the

Site Plan submitted as part of the application. For Zoning Bylaw Amendment applications: complete General Project Description and Section 1.

For Site Plan Control applications: complete General Project Description, Section 1 and Section 2. For further information, please visit www.toronto.ca/greendevelopment

Total number of residential units

11-0063 2018-05

General Project Description	Proposed
Total Gross Floor Area	5122.89 s.m
Breakdown of project components (m²)	
Residential	5122.89 s.m
Retail	n/a
Commercial	n/a
Industrial	n/a
Institutional/Other	n/a

Automobile Infrastructure	Required	Proposed	Proposed %
Number of Parking Spaces	59	59	100
Number of parking spaces dedicated for priority LEV parking	0	0	100
Number of parking spaces with EVSE	20%=11.8	12	101.69
Cycling Infrastructure	Required	Proposed	Proposed %
Number of long-term bicycle parking spaces (residential)	45	56	124.44
Number of long-term bicycle parking spaces (all other uses)	n/a	n/a	n/a
Number of long-term bicycle parking (all uses) located on:			
a) first storey of building	n/a	n/a	n/a
b) second storey of building	n/a	n/a	n/a
c) first level below-ground	6	56	933.33
d) second level below-ground	8	0	0
e) other levels below-ground	n/a	n/a	n/a

Page 1 of 3

Section 1: For Stand Alone Zoning Bylaw Amendment Applications and

Automobile Infrastructure	Required	Proposed	Proposed %
Number of Parking Spaces	59	59	100
Number of parking spaces dedicated for priority LEV parking	0	0	100
Number of parking spaces with EVSE	20%=11.8	12	101.69
Cycling Infrastructure	Required	Proposed	Proposed %
Number of long-term bicycle parking spaces (residential)	45	56	124.44
Number of long-term bicycle parking spaces (all other uses)	n/a	n/a	n/a
Number of long-term bicycle parking (all uses) located on:			
a) first storey of building	n/a	n/a	n/a
b) second storey of building	n/a	n/a	n/a
c) first level below-ground	6	56	933.33
d) second level below-ground	8	0	0
e) other levels below-ground	n/a	n/a	n/a

11-0063 2018-05

11-0063 2018-05

Toronto Green Standard Statistics 3



# **Green Roof Statistics**

The Green Roof Statistics Template is required to be submitted for Site Plan Control Applications where a green roof is required under the Toronto Municipal Code Chapter 492, Green Roofs. Complete the table below and copy it directly onto the Roof Plan submitted as part of any Site Plan Control Application requiring a green roof in accordance with the Bylaw. Refer to Section § 492-1 of the Municipal Code for a complete list of defined terms, and greater clarity and certainty regarding the intent and application of the terms included in the template. The Toronto Municipal Code Chapter 492, Green Roofs can be found online at: http://www.toronto.ca/legdocs/municode/1184 492.pdf

### **Green Roof Statistics**

**Bird-Friendly Design Statistics** 

Low-Reflectance

Opaque Glass (m²)

Visual Markers (m<sup>2</sup>)

Low-Reflectance

Visual Markers (m²

Building Window : Wall Ratio

\*For Site Plan Approval applications received before January 1, 2020, treat the first 12m above grade.

Include this section only when applicable and provide relevant floor numbers for reference

North (Floor #s)

Glazing Area (m²)


Untreated Area (m2)

Treated Area (m2)

Glazing Area (m²) Untreated Area (m2) Freated Area (m²)

		Proposed
Gross Floor Area, as defined in Green Roof Bylaw (m2)	)	5122.89
Total Roof Area (m <sup>2</sup> )		1073.98
Area of Residential Private Terraces (m <sup>2</sup> )		580.74
Rooftop Outdoor Amenity Space, if in a Residential Building (m <sup>2</sup> )		0
Area of Renewable Energy Devices (m <sup>2</sup> )		0
Tower (s)Roof Area with floor plate less than 750	m <sup>2</sup>	0
Total Available Roof Space (m <sup>2</sup> )		493.24
Green Roof Coverage	Required	Proposed
Coverage of Available Roof Space (m <sup>2</sup> )	147.97	207.24
Coverage of Available Roof Space (%)	30	42

Green Roof Bylaw Statistics 2

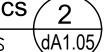

#### Statistics Template - Toronto Green Standard Version 3.0 Mid to High Rise Residential and all New Non-Residential Development

323

420

Cycling Infrastructure	Required	Proposed	Proposed %
Number of short-term bicycle parking spaces (residential)	4	8	200
Number of short-term bicycle parking spaces (all other uses)	n/a	n/a	n/a
Number of male shower and change facilities (non-residential)	n/a	n/a	n/a
Number of female shower and change facilities (non-residential)	n/a	n/a	n/a
Tree Planting & Soil Volume	Required	Proposed	Proposed %

#### Section 2: For Site Plan Control Applications

Total Soil Volume (40% of the site area ÷ 66 m² x 30 m³)


Cycling Infrastructure	Required	Proposed	Proposed %
Number of short-term bicycle parking spaces (all uses) at-grade or on first level below grade	4	8	200
UHI Non-roof Hardscape	Required	Proposed	Proposed %
Total non-roof hardscape area (m²)		654	
Total non-roof hardscape area treated for Urban Heat Island (minimum 50%) (m²)		367	56
Area of non-roof hardscape treated with: (indicate m²)			
a) high-albedo surface material		367	
b) open-grid pavement			
c) shade from tree canopy			
d) shade from high-albedo structures			
e) shade from energy generation structures			
Percentage of required car parking spaces under cover (minimum 75%)(non-residential only)			
Green & Cool Roofs	Required	Proposed	Proposed %
Available Roof Space (m²)		1073.98	
Available Roof Space provided as Green Roof (m²)	147.97	207.24	140
Available Roof Space provided as Cool Roof (m²)	0	0	100
Available Roof Space provided as Solar Panels (m²)	0	0	100

Statistics Template - Toronto Green Standard Version 3.0 Mid to High Rise Residential and all New Non-Residential Development

Water Efficiency	Required	Proposed	Proposed %
Total landscaped site area (m²)			
Landscaped site area planted with drought-tolerant plants (minimum 50%) (m² and %) (if applicable)			
Tree Planting Areas & Soil Volume	Required	Proposed	Proposed %
Total site area (m²)		1774.75	
Total Soil Volume (40% of the site area ÷ 66 m²x 30 m³)	426	685	161
Total number of planting areas (minimum of 30m³ soil)			
Total number of trees planted	15	50	333
Number of surface parking spaces (if applicable)		2	
Number of shade trees located in surface parking area interior (minimum 1 tree for 5 parking spaces)		2	4
Native and Pollinator Supportive Species	Required	Proposed	Proposed %
Total number of plants	İ		
Total number of native plants and % of total plants (min.50%)			
Bird Friendly Glazing	Required	Proposed	Proposed %
Total area of glazing of all elevations within 12m above grade (including glass balcony railings)			
Total area of treated glazing (minimum 85% of total area of glazing within 12m above grade) (m²)			
Percentage of glazing within 12m above grade treated with:			
a) Low reflectance opaque materials			
b) Visual markers			
Late of Control to the Control of			

KIRKOR ARCHITECTS AND PLANNERS

Page 3 of 3

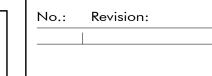

JAN 13, 2022 JAN 21,2021 Re-zoning Re-zoning NOV 20,2020 JULY 31,2020 Re-zoning MAY 1,2019

20 De Boers Dr. # 400 Toronto ON M3J 0H1 TEL 416 665 6060 kirkorarchitects.com

No.: Issued For: Drawing Title:

Toronto Green Standard

**Dormer Homes** 

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2810-2814 Bayview Ave.

Related File: OPA/ZBA: 19 150397NNY 18 OZ January 13, 2022

> 2810-2814 Bayview Ave. 1:200 Drawn by A. I.

D.S.

January 13, 2022

Checked by

Project No.

Green Roof LEVEL 3 TERRACE Terrace LEVEL 5 TERRACI Roof LEVEL 7 TERRACE GREEN ROOF @ MPH T.O. RESIDENTIAL ROOF T.O. STAIR ROOF T.O. MPH ROOF

Green Roof Layout

#### VEHICULAR PARKING SPACE LEGEND:

LEGEND

DESCRIPTION

ASSIGNED RESIDENTIAL PARKING SPACES IN RESIDENTIAL GARAGE WITH ROUGH-IN PROVISIONS FOR FUTURE EVSE INSTALLATION

UNASSIGNED VISITOR PARKING SPACES IN RESIDENTIAL GARAGE

174.32

QUANTITY 51+3 BARRIER FREE


LEGEND

DESCRIPTION QUANTITY ASSIGNED RESIDENTIAL PARKING SPACES WITH PRIORITY FOR LOW-EMITTING VEHICLES, CARPOOLING, OR RIDE-SHARING VEHICLES

12


ASSIGNED RESIDENTIAL PARKING SPACES WITH ELECTRIC VEHICLE SUPPLY EQUIPMENT (LEVEL 2 CHARGING CAPABILITY OR ELECTRIC VEHICLE ENERGY MANAGEMENT SYSTEM)

**TYPICAL PARKING SPACE:** Drive Aisle @ 6m min.

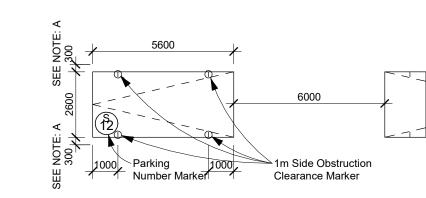

NOTE: A- PROVIDE AN ADDITIONAL 300mm FOR PARKING SPACE WIDTH

**ACCESSIBLE PARKING SPACE:** 

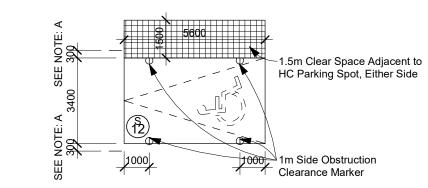

NOTE: A- PROVIDE AN ADDITIONAL 300mm FOR PARKING SPACE WIDTH

General Parking Notes 1

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Revision:

JAN 13, 2022 JAN 21,2021 Re-zoning Re-zoning Re-zoning NOV 20,2020 JULY 31,2020 MAY 1,2019

Underground Parking Level P2 Floor Plan

Dormer Homes

Drawing Title:


2810-2814 Bayview Ave.

Related File: OPA/ZBA: 19 150397NNY 18 OZ

January 13, 2022 2810-2814 Bayview Ave.

As indicated

Checked by D.S. Project No. January 13, 2022

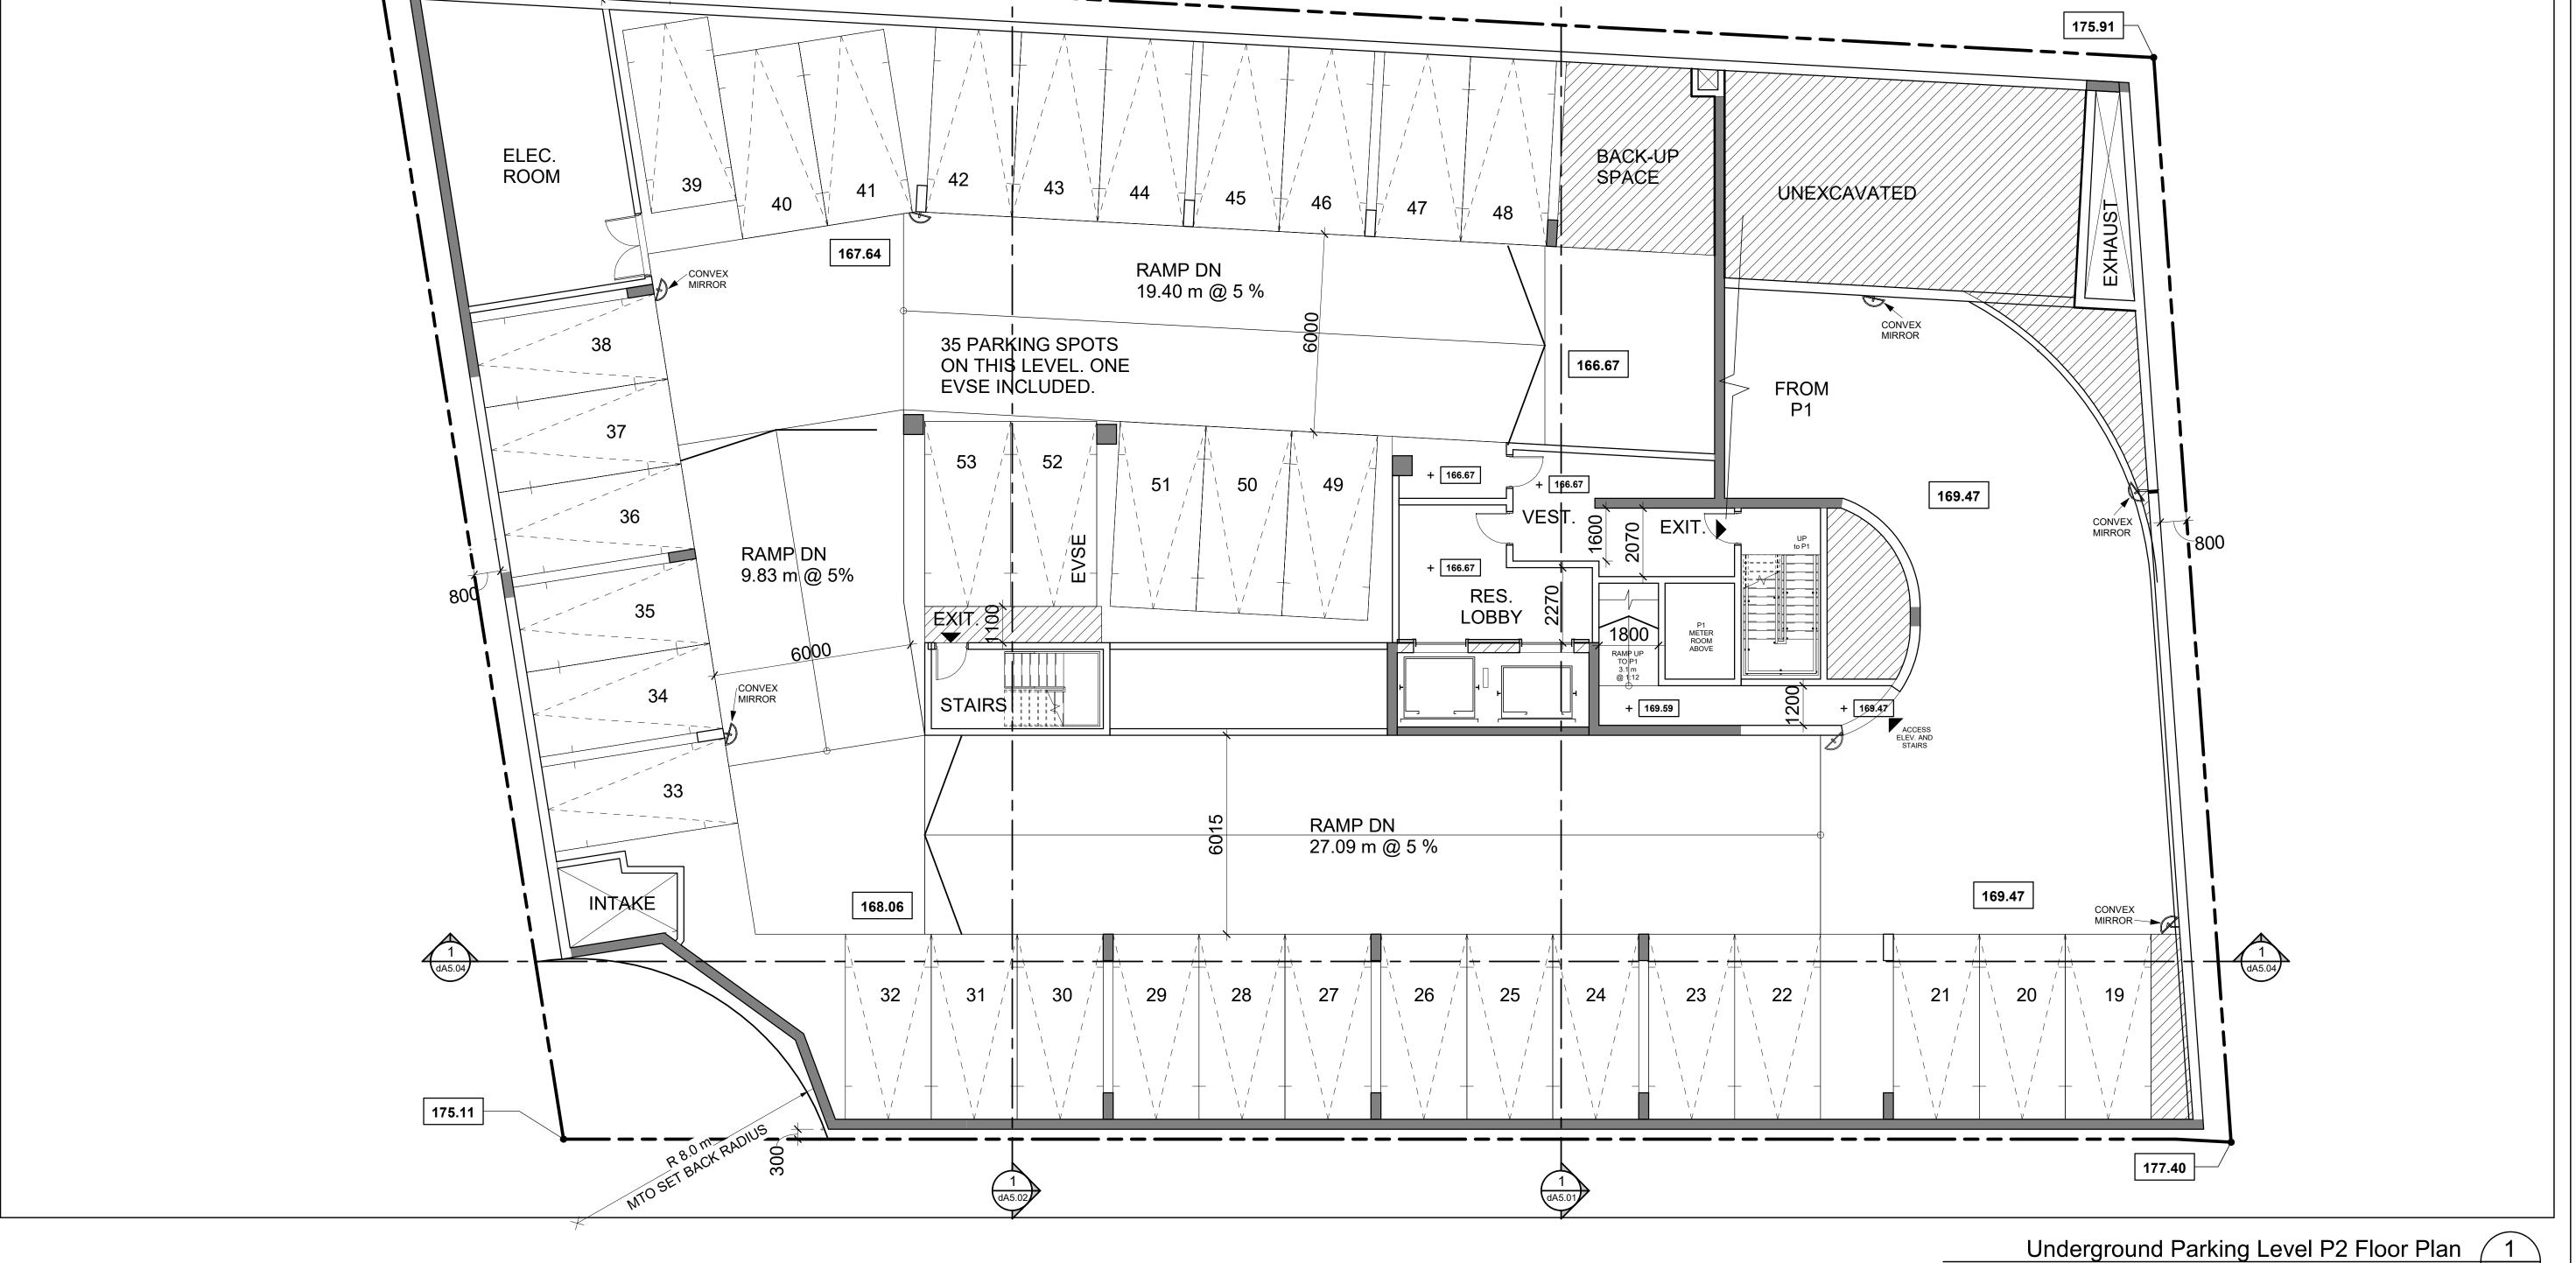

LEGEND DESCRIPTION

ASSIGNED RESIDENTIAL PARKING SPACES IN RESIDENTIAL GARAGE WITH ROUGH-IN PROVISIONS FOR FUTURE EVSE INSTALLATION

> UNASSIGNED VISITOR PARKING SPACES IN RESIDENTIAL GARAGE


QUANTITY 51+3 BARRIER FREE LEGEND

DESCRIPTION ASSIGNED RESIDENTIAL PARKING SPACES WITH PRIORITY FOR LOW-EMITTING VEHICLES, CARPOOLING, OR RIDE-SHARING VEHICLES

ASSIGNED RESIDENTIAL PARKING SPACES WITH ELECTRIC VEHICLE SUPPLY EQUIPMENT (LEVEL 2 CHARGING CAPABILITY OR ELECTRIC VEHICLE ENERGY MANAGEMENT SYSTEM)


QUANTITY

TYPICAL PARKING SPACE: Drive Aisle @ 6m min.

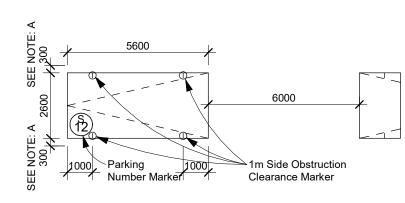

NOTE: A- PROVIDE AN ADDITIONAL 300mm FOR PARKING SPACE WIDTH

**ACCESSIBLE PARKING SPACE:** 

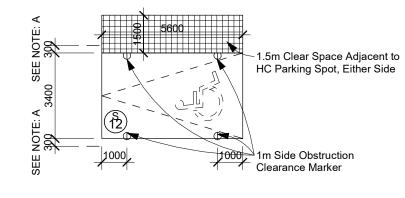

NOTE: A- PROVIDE AN ADDITIONAL 300mm FOR PARKING SPACE WIDTH WHEN OBSTRUCTIONS OCCUR BETWEEN THE FRONT AND REAR 1000mm

BICYCLE PARKING SPACE LEGEND

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Revision:

Re-zoning Re-zoning Re-zoning

**Underground Parking Level** P1 Floor Plan

**Dormer Homes** 

JAN 21,2021

NOV 20,2020

JULY 31,2020 MAY 1,2019

Drawing Title:

2810-2814 Bayview Ave.

Related File: OPA/ZBA: 19 150397NNY 18 OZ January 13, 2022


2810-2814 Bayview Ave As indicated


D.S.

Checked by Project No.

January 13, 2022


PROPERTY LINE 177.40 Underground Parking Level P1 Floor Plan Scale: 1:100

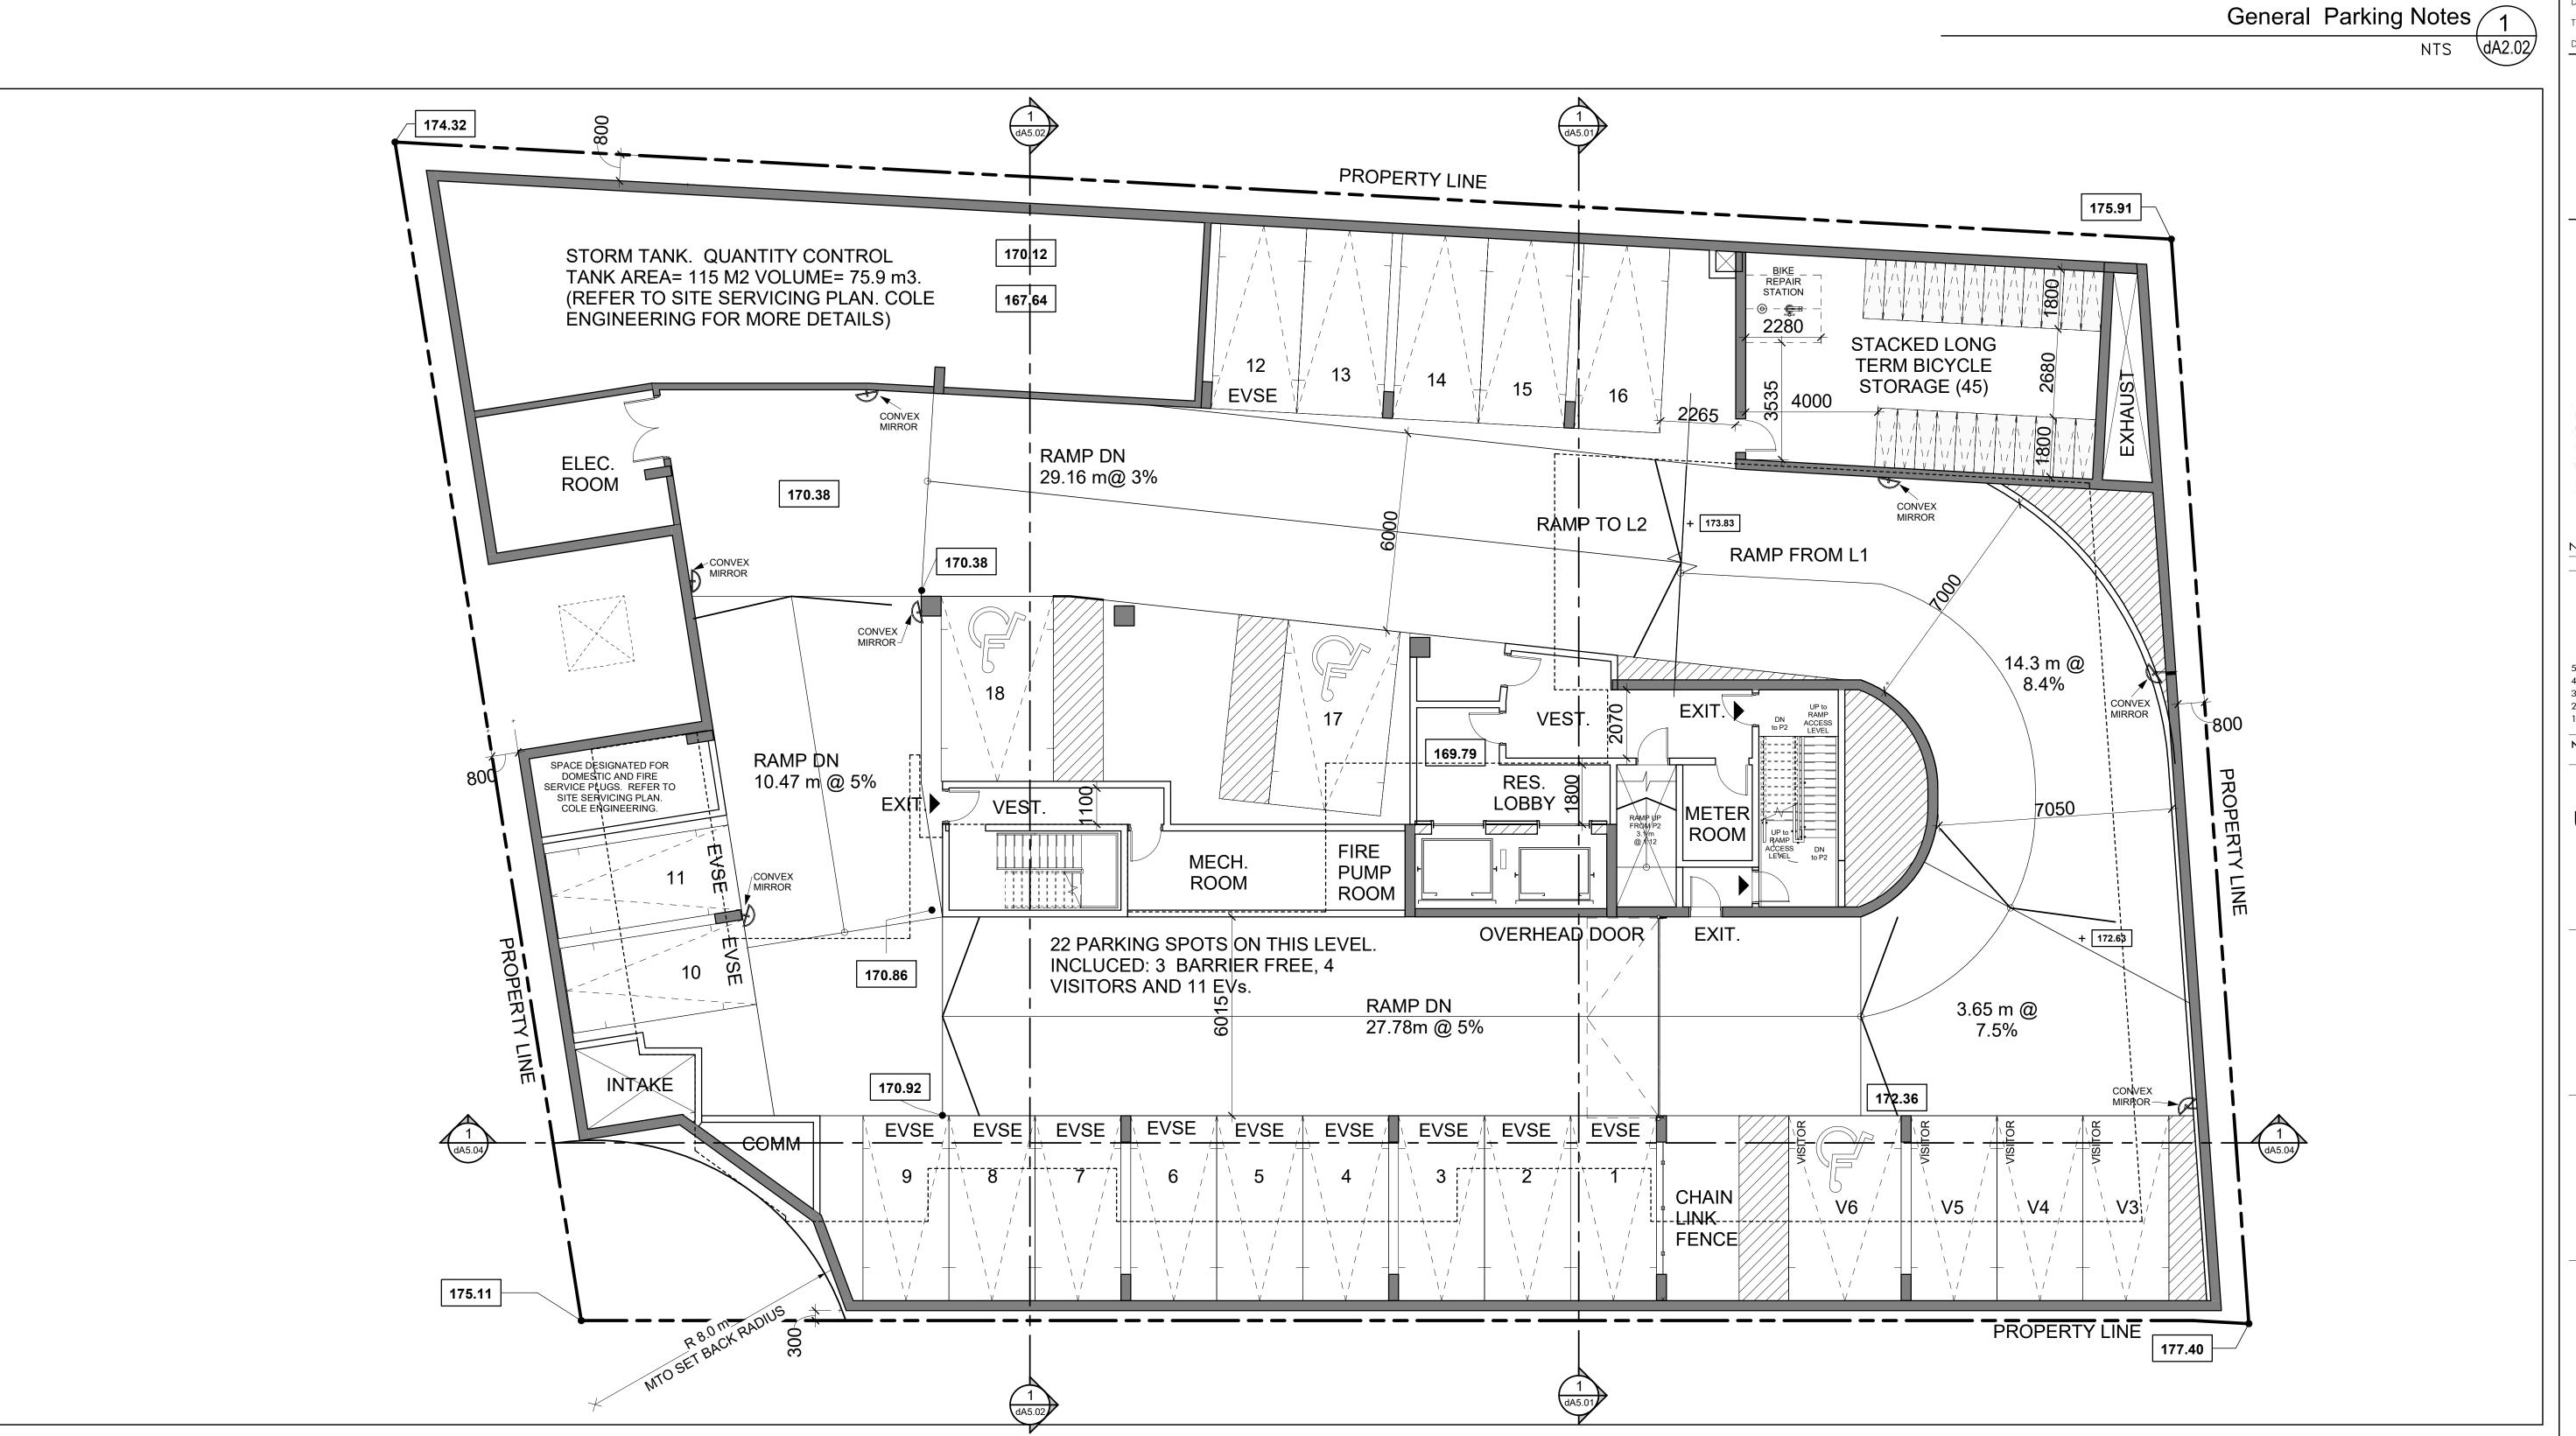

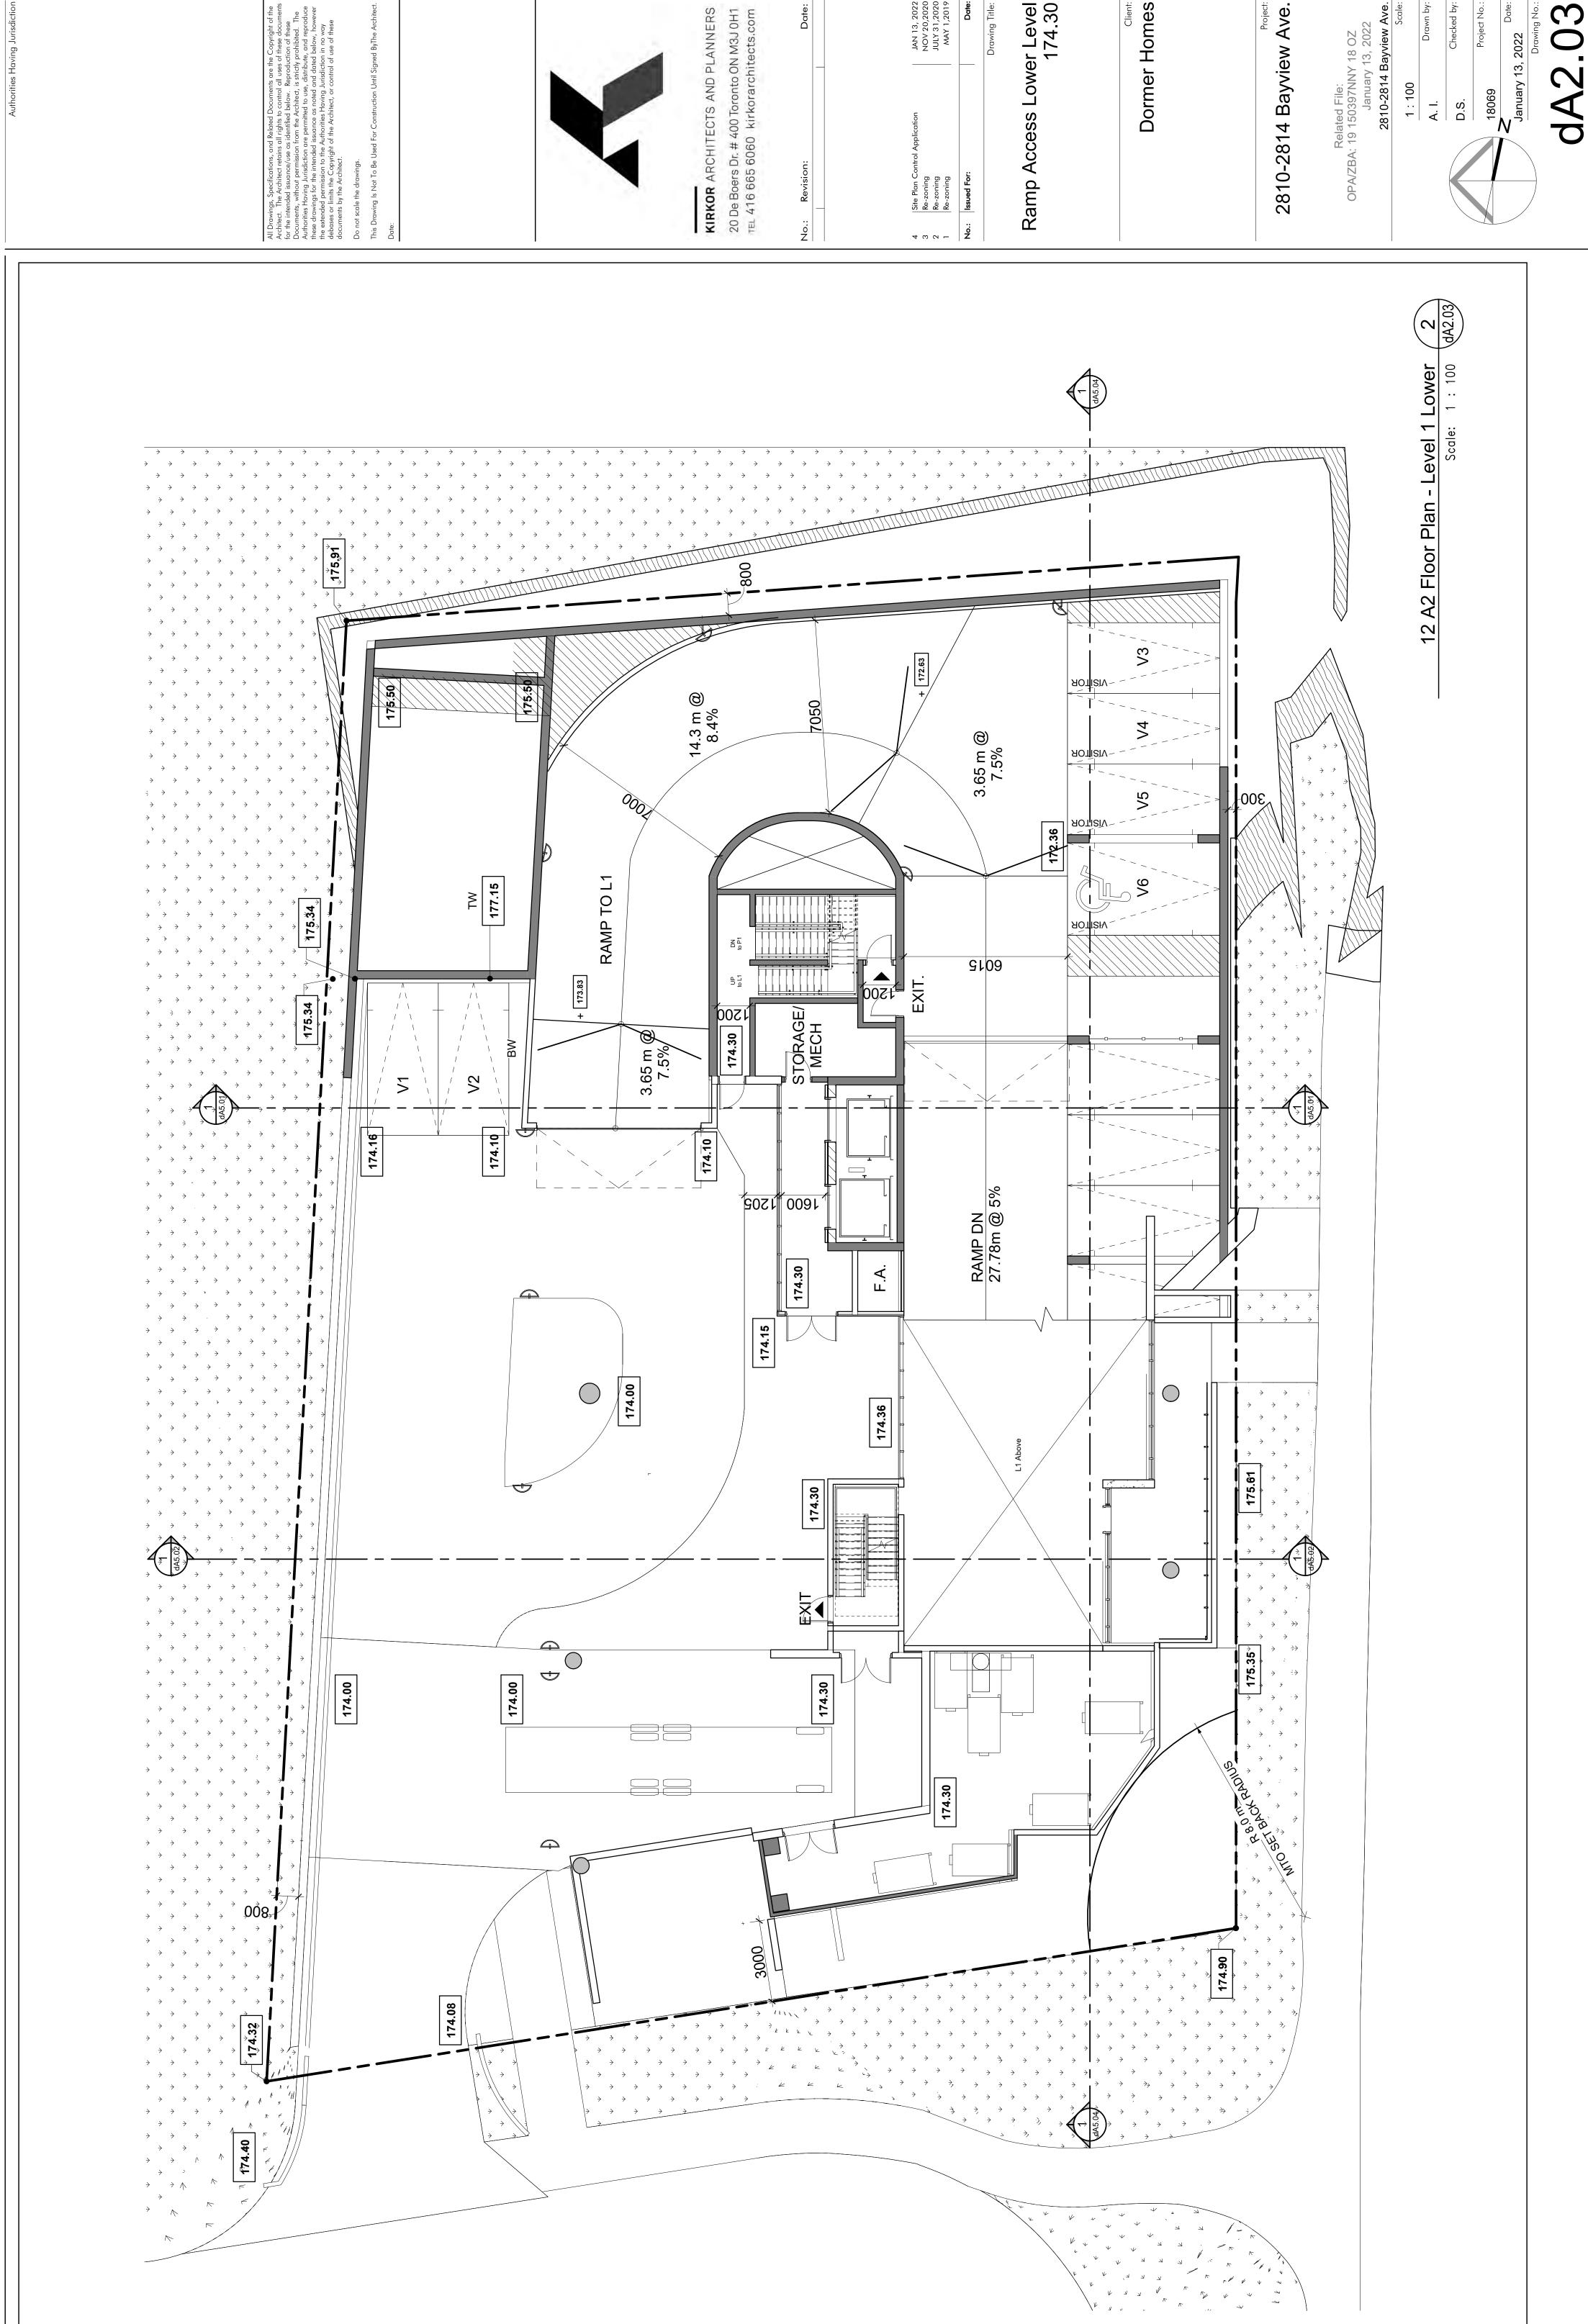



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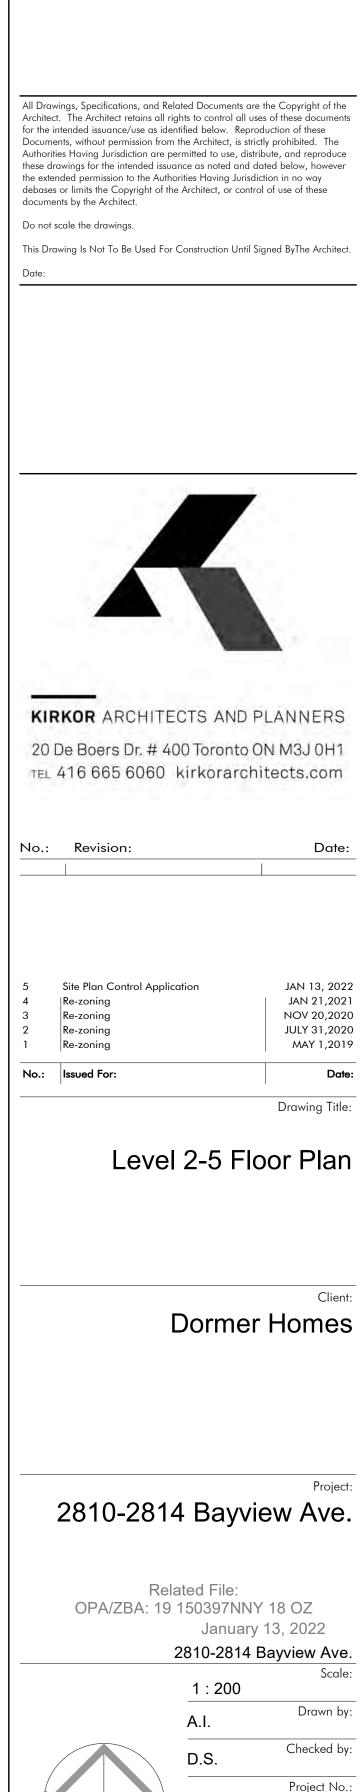
Plot Date: 2022-01-14 4:36:11 PM File Path: C:/Revit/2019/18069P10-Model-2810-2816 Bayview-Dormer\_RVT2019\_achanE2NJV.rvt Drawn by: Checked by: 2810-2814 Bayview Ave. Project No.: **Dormer Homes** 2810-2814 Bayview Ave. Related File: OPA/ZBA: 19 150397NNY 18 OZ January 13, 2022 18069 **J**anuary 13, 2022 1:100 <u>-</u> D.S.



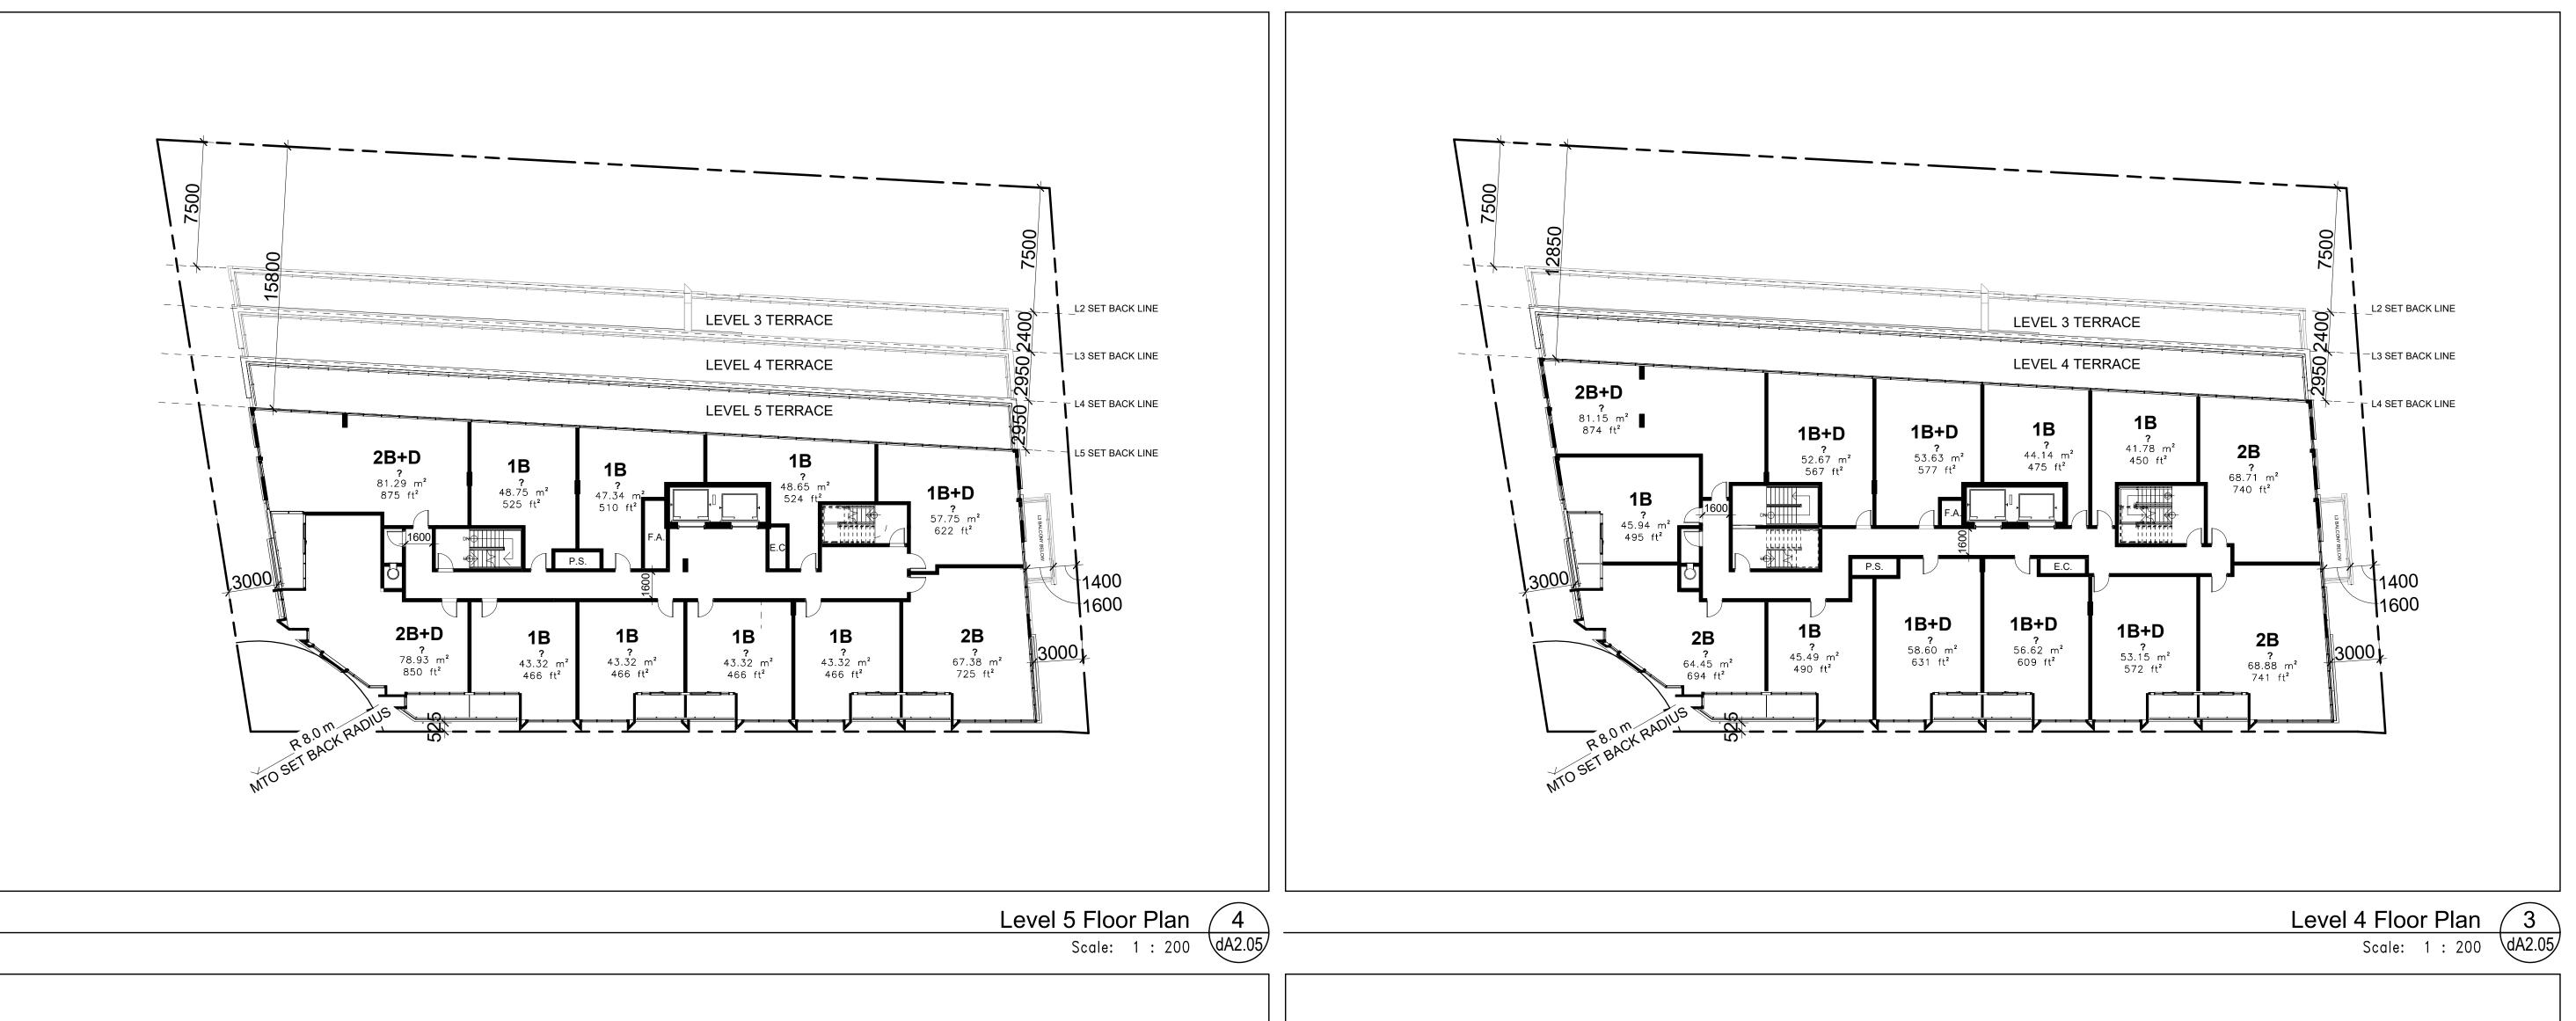



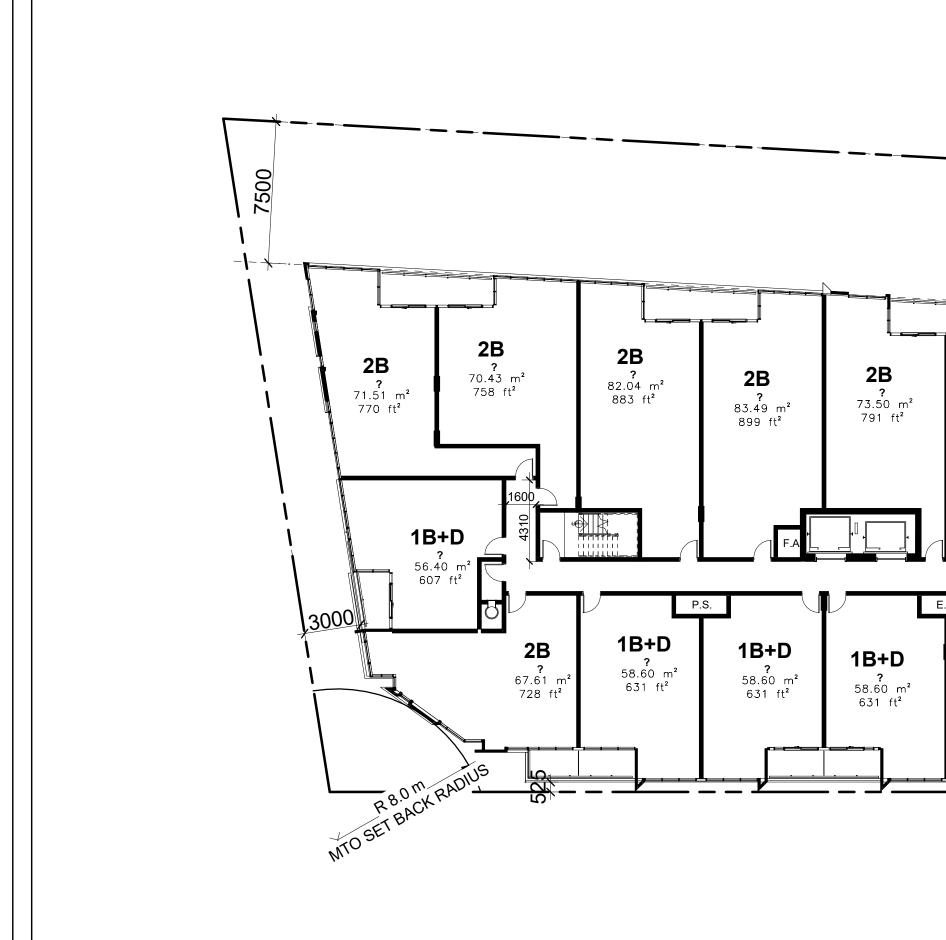

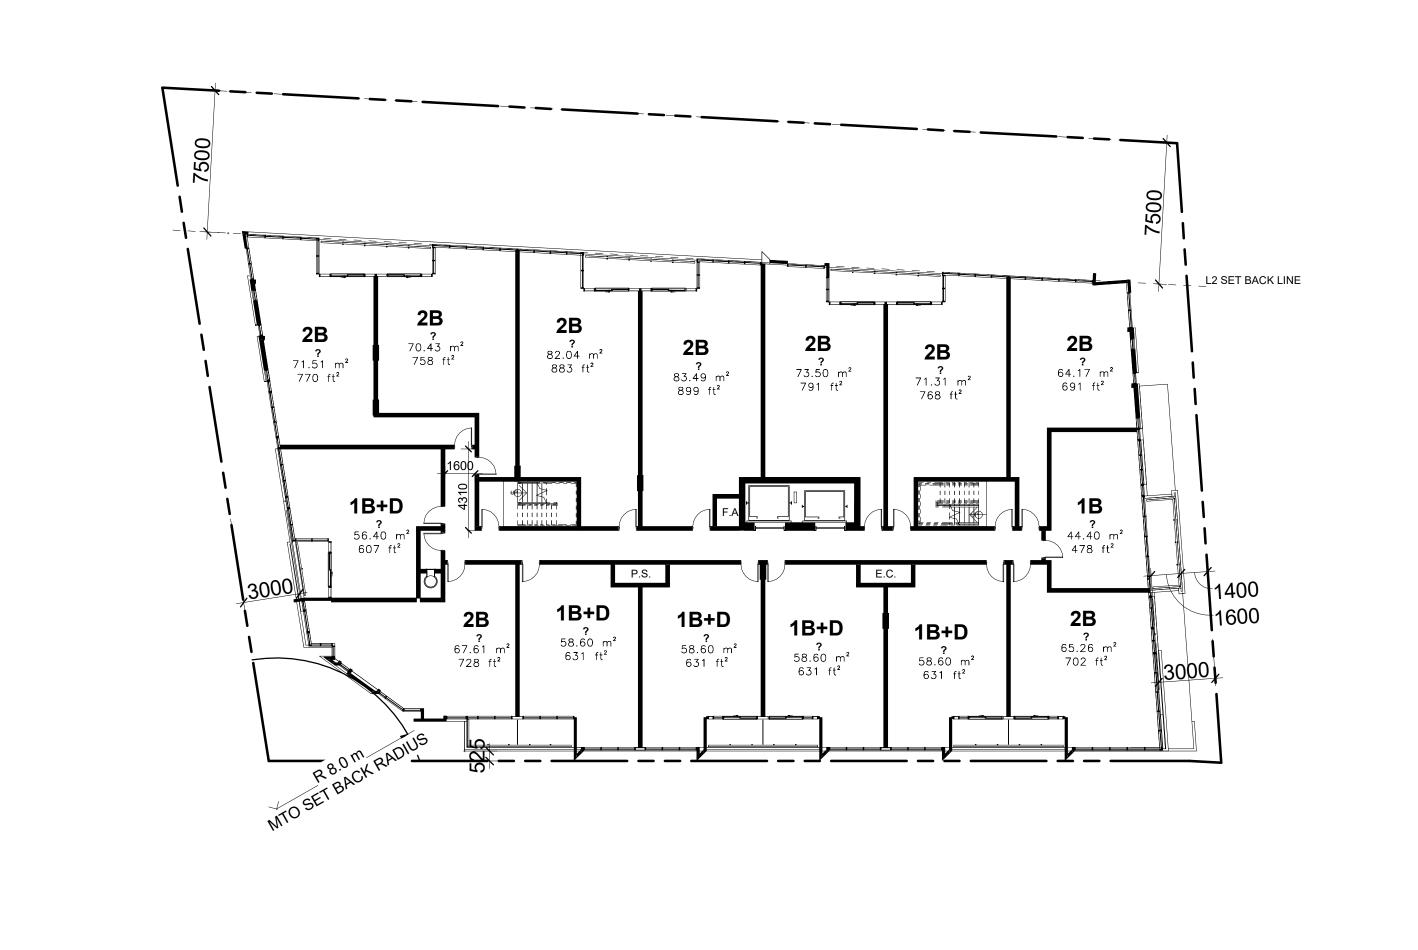

JAN 13, 2022 JAN 21,2021

NOV 20,2020 JULY 31,2020 MAY 1,2019


Drawing Title:

Drawn by

Checked by

Project No.


Authorities Having Jurisdiction

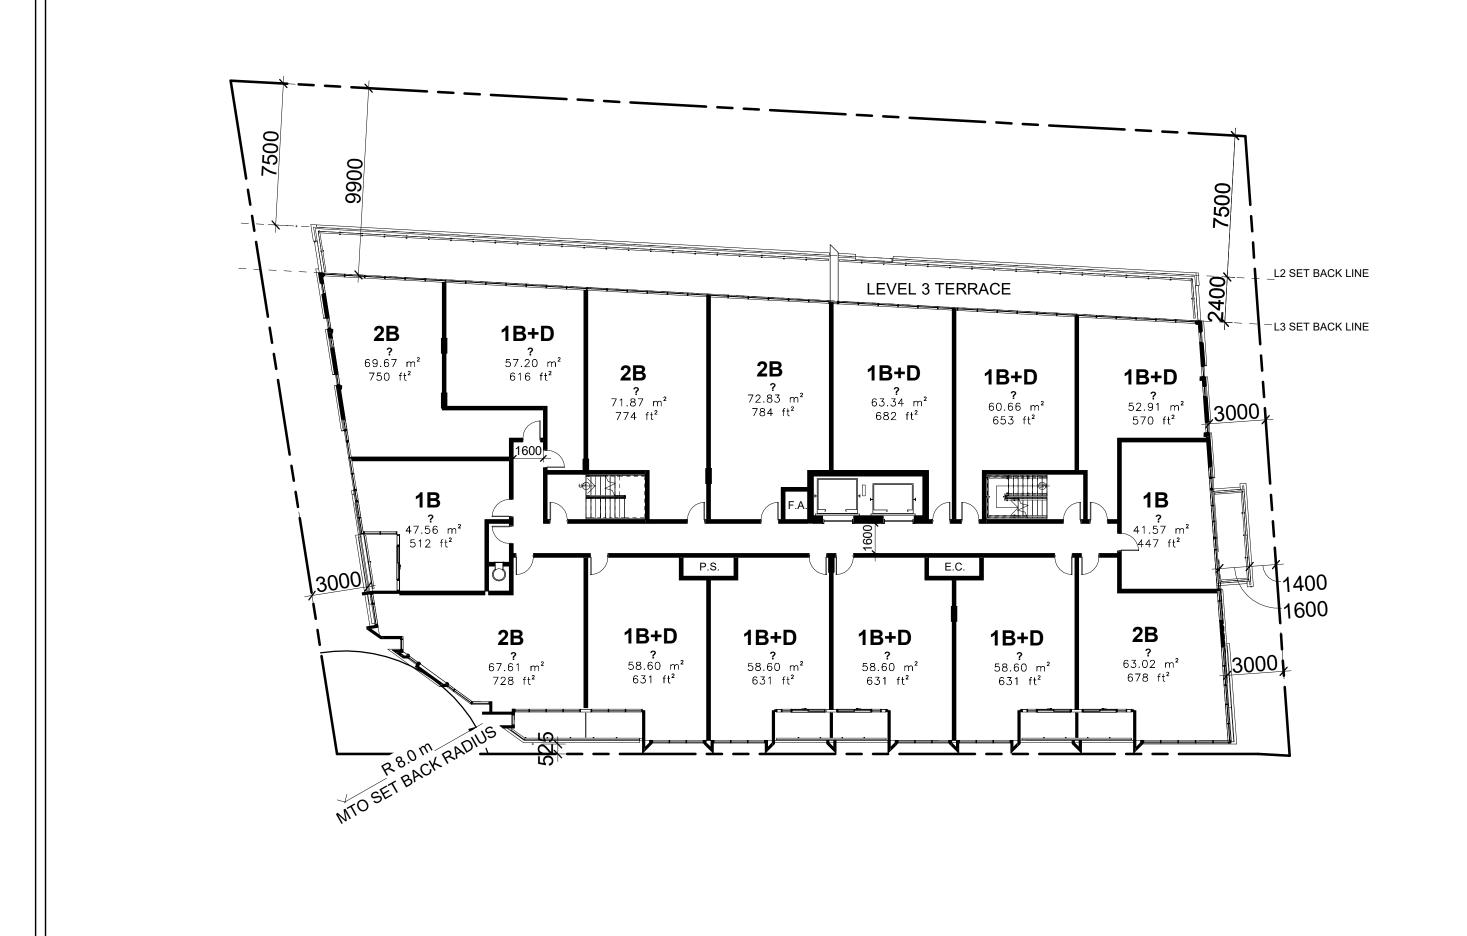



Level 3 Floor Plan 2 Scale: 1 : 200 dA2.05


Level 2 Floor Plan

2 Floor Plan 1 Scale: 1 : 200 dA2.05

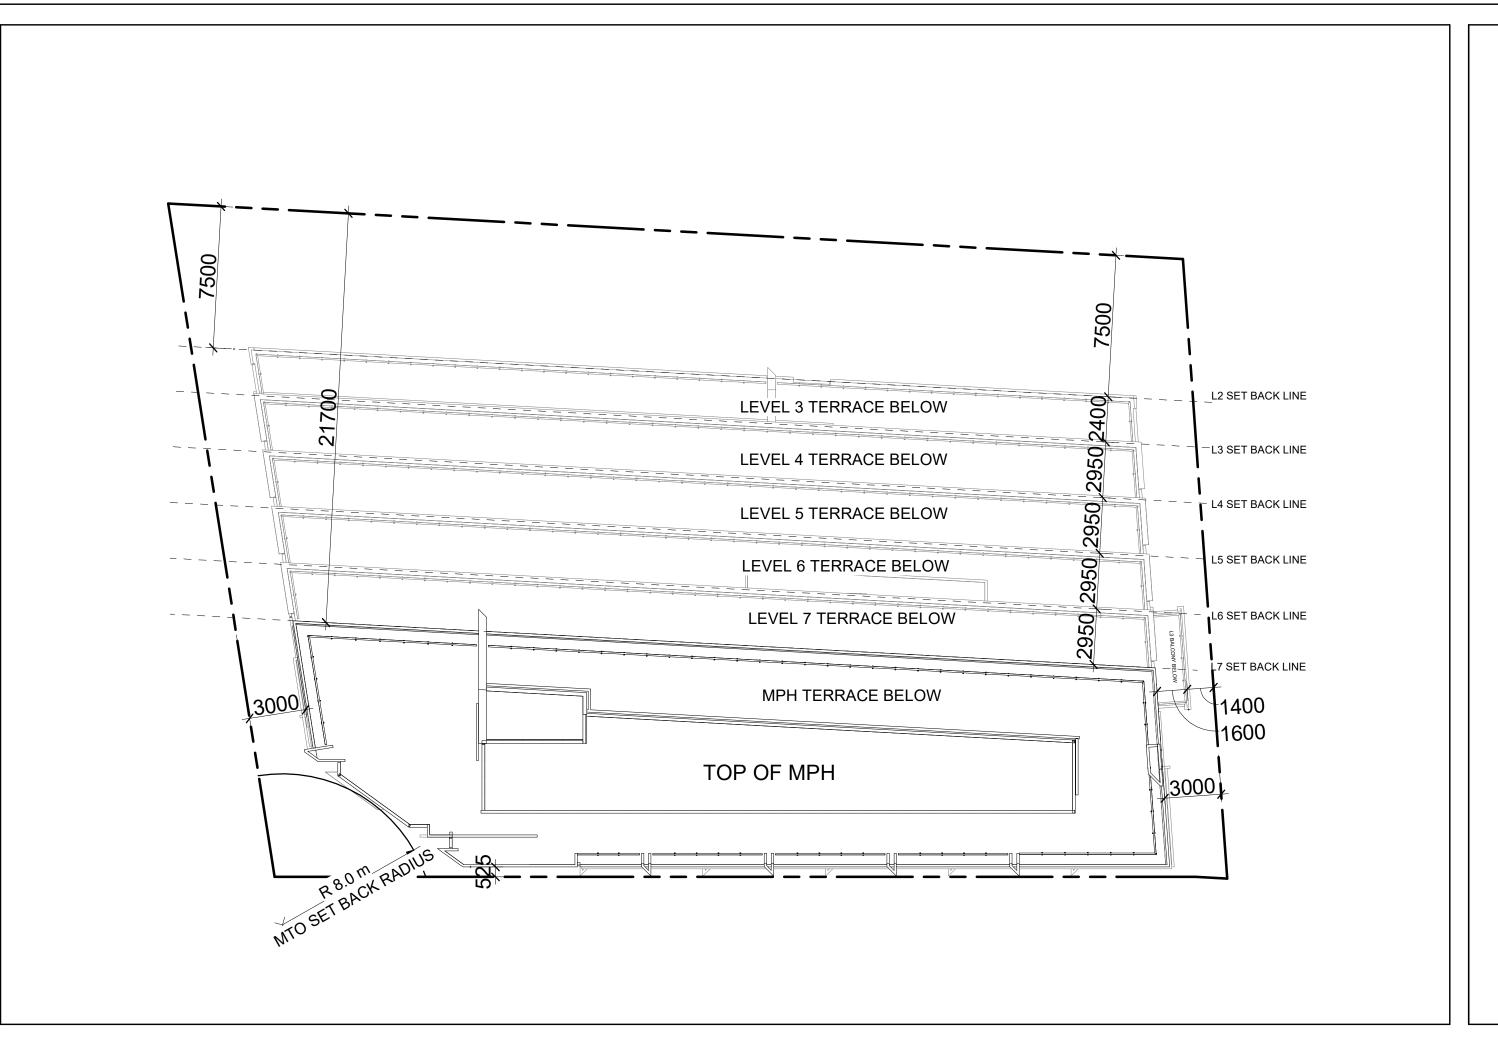


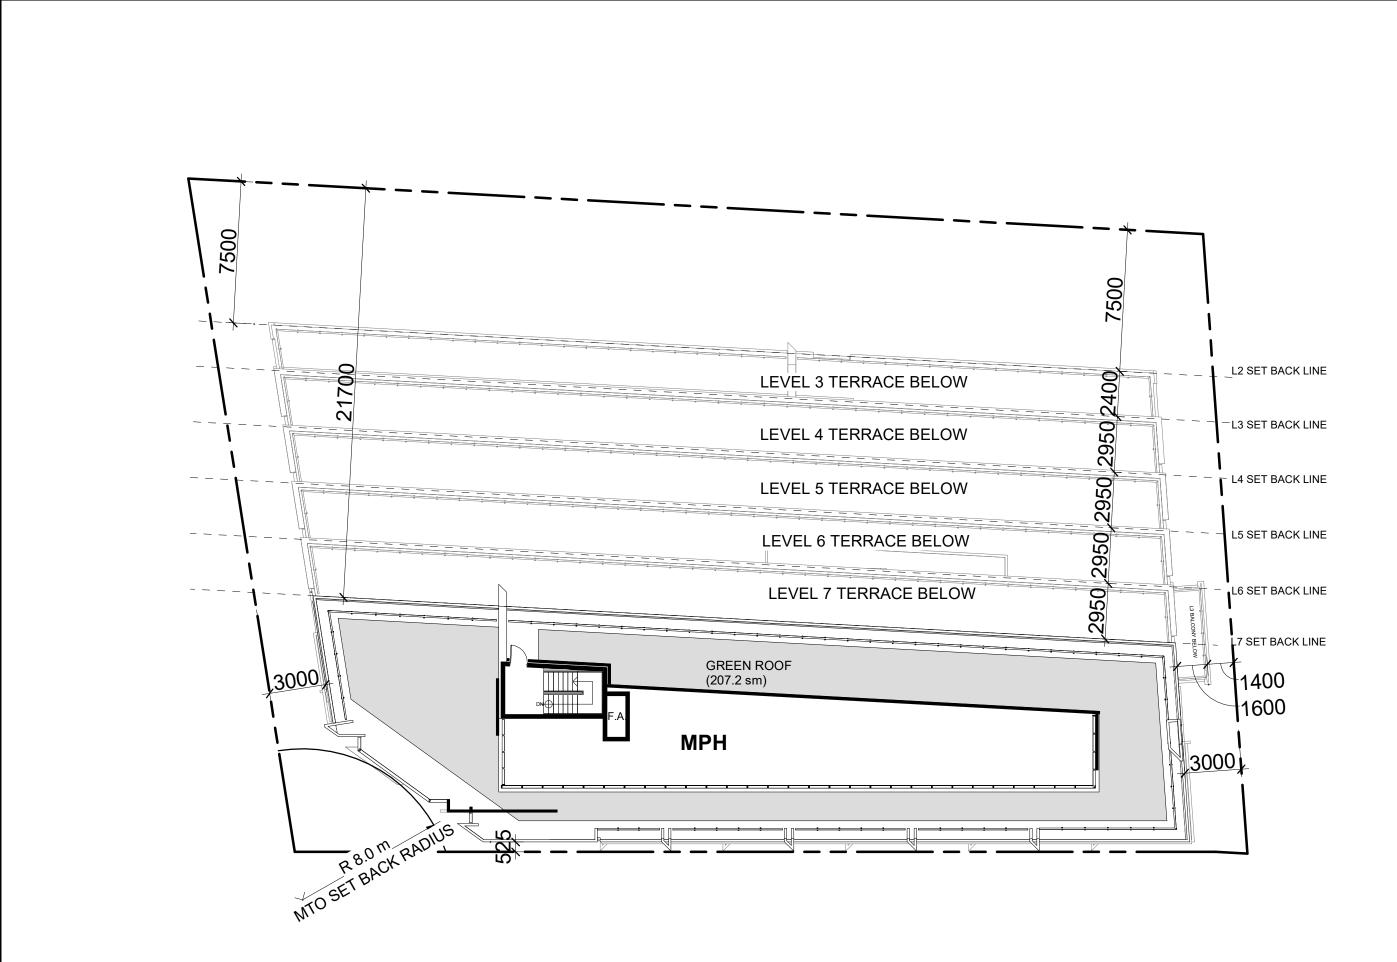

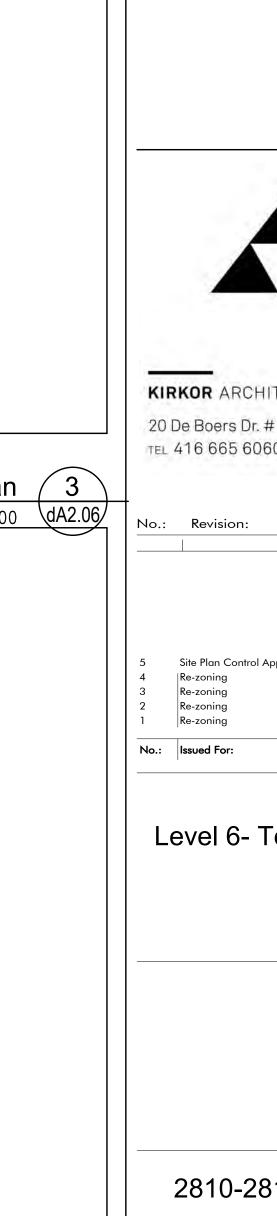

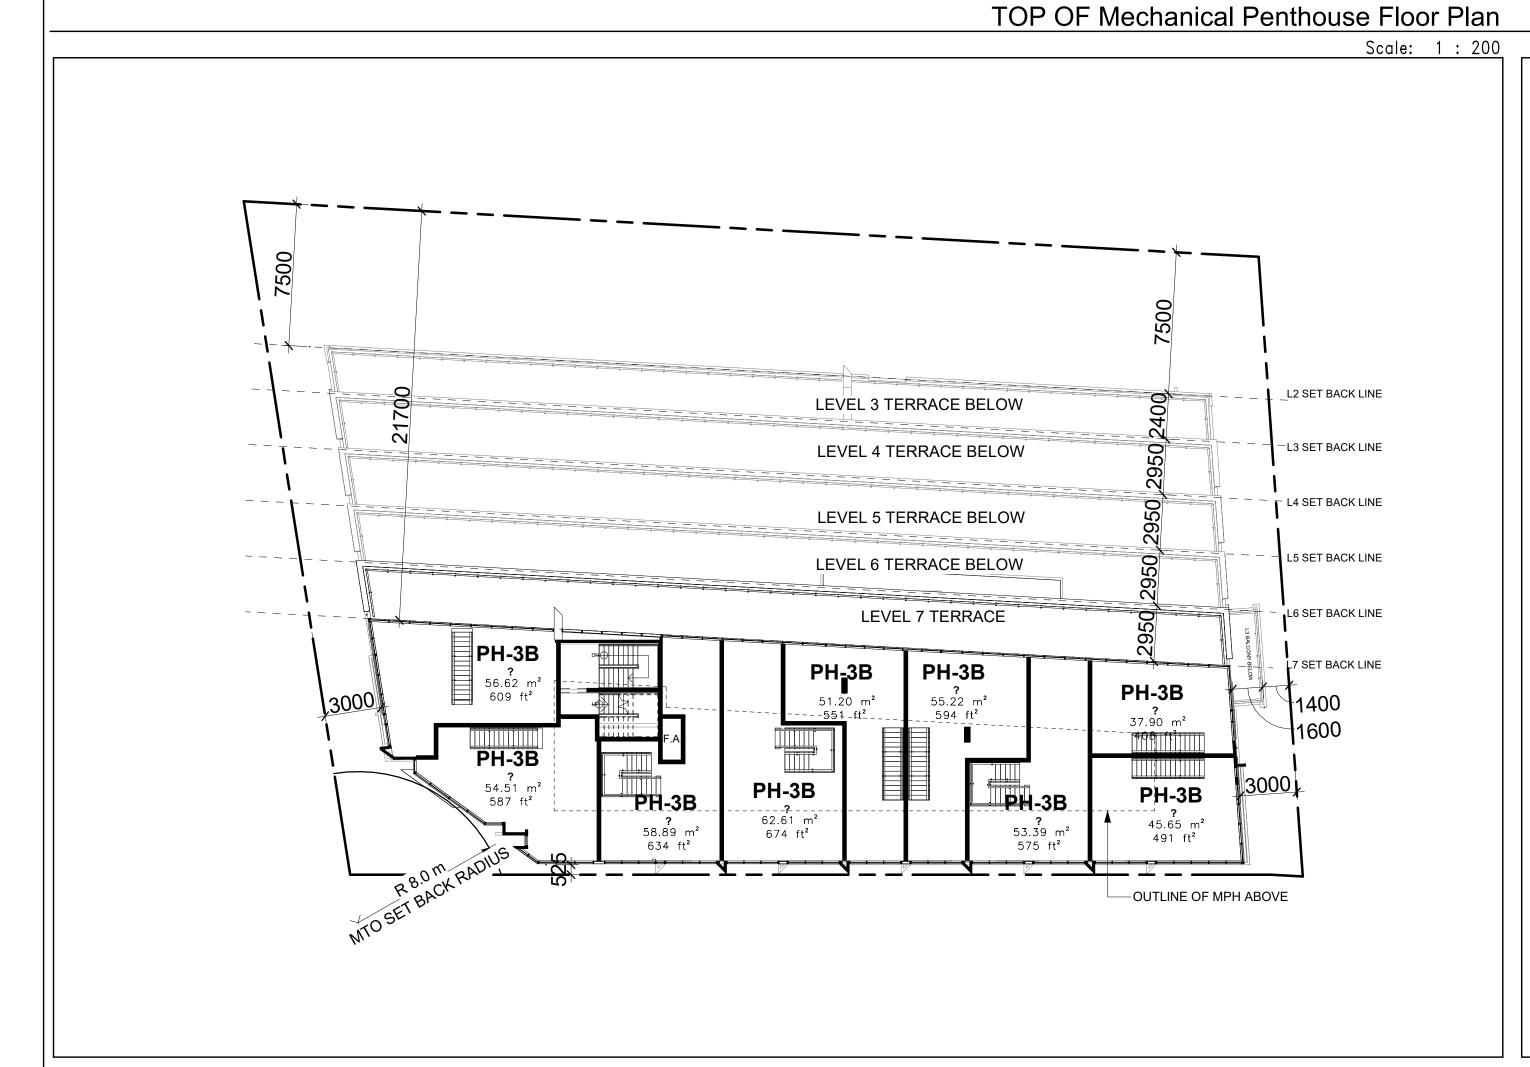

Level 7 Floor Plan 2

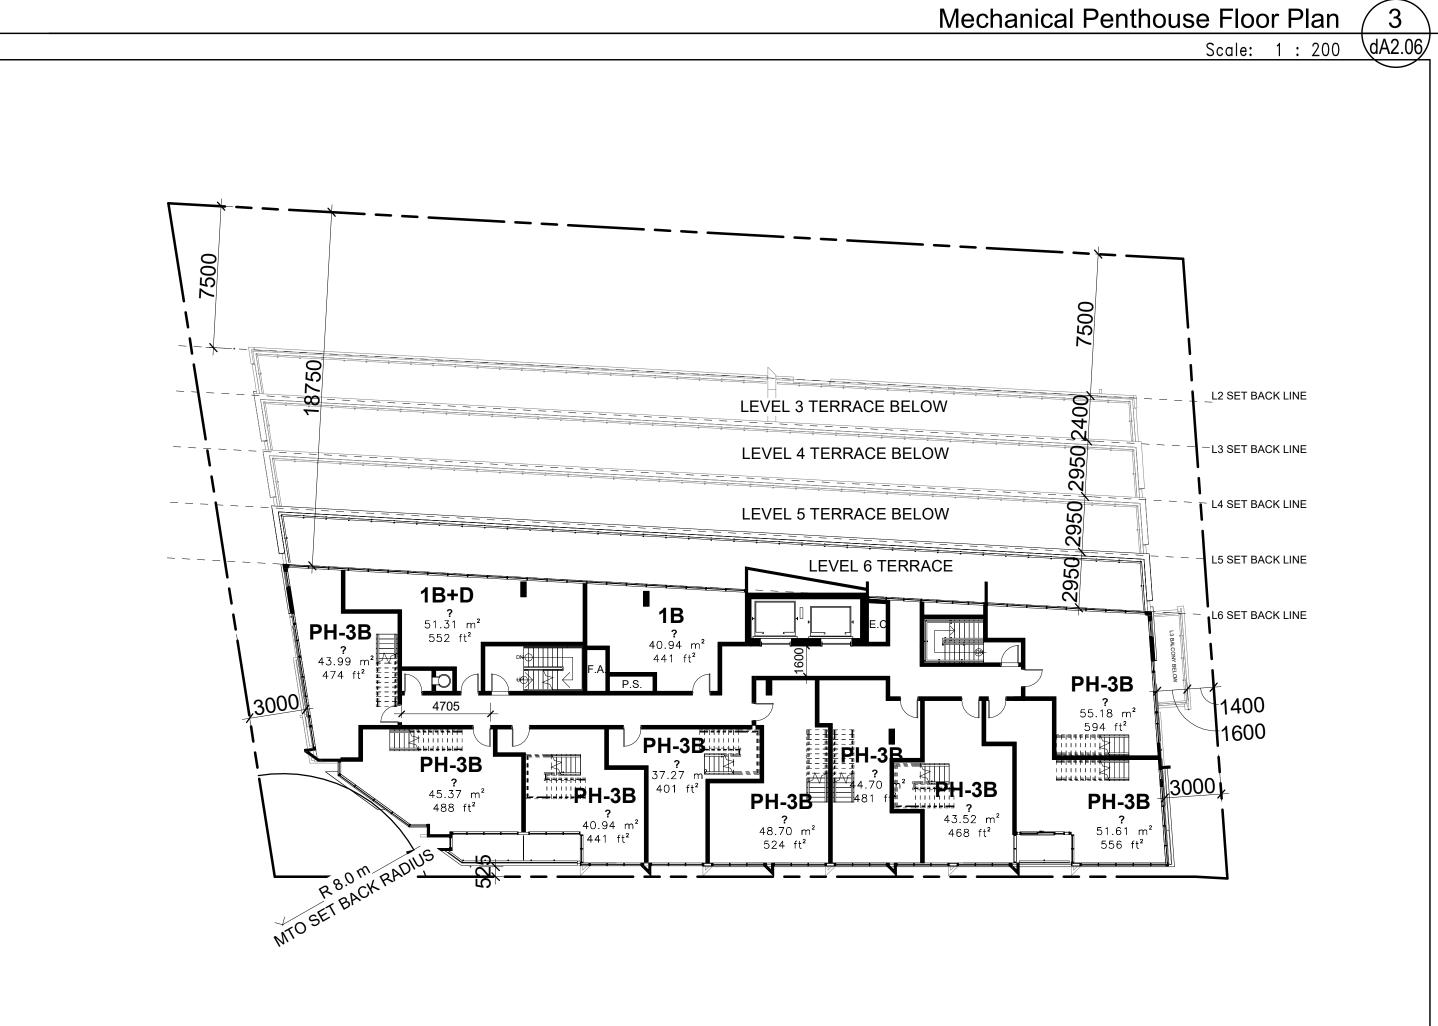

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TEL 416 665 6060 kirkorarchitects.com

 4
 Re-zoning
 JAN 21,2021

 3
 Re-zoning
 NOV 20,2020

 2
 Re-zoning
 JULY 31,2020

 1
 Re-zoning
 MAY 1,2019

 No.:
 Issued For:
 Date:

 Drawing Title:

Level 6- Top of MPH Floor Plan

Dormer Homes

2810-2814 Bayview Ave.

Related File:
OPA/ZBA: 19 150397NNY 18 OZ

January 13, 2022 2810-2814 Bayview Ave

1:200
A.I.
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18069

January

Level 6 Floor Plan

Project No.:

18069


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dA2.06



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No.: Revision:

Site Plan Control Application

Re-zoning Re-zoning

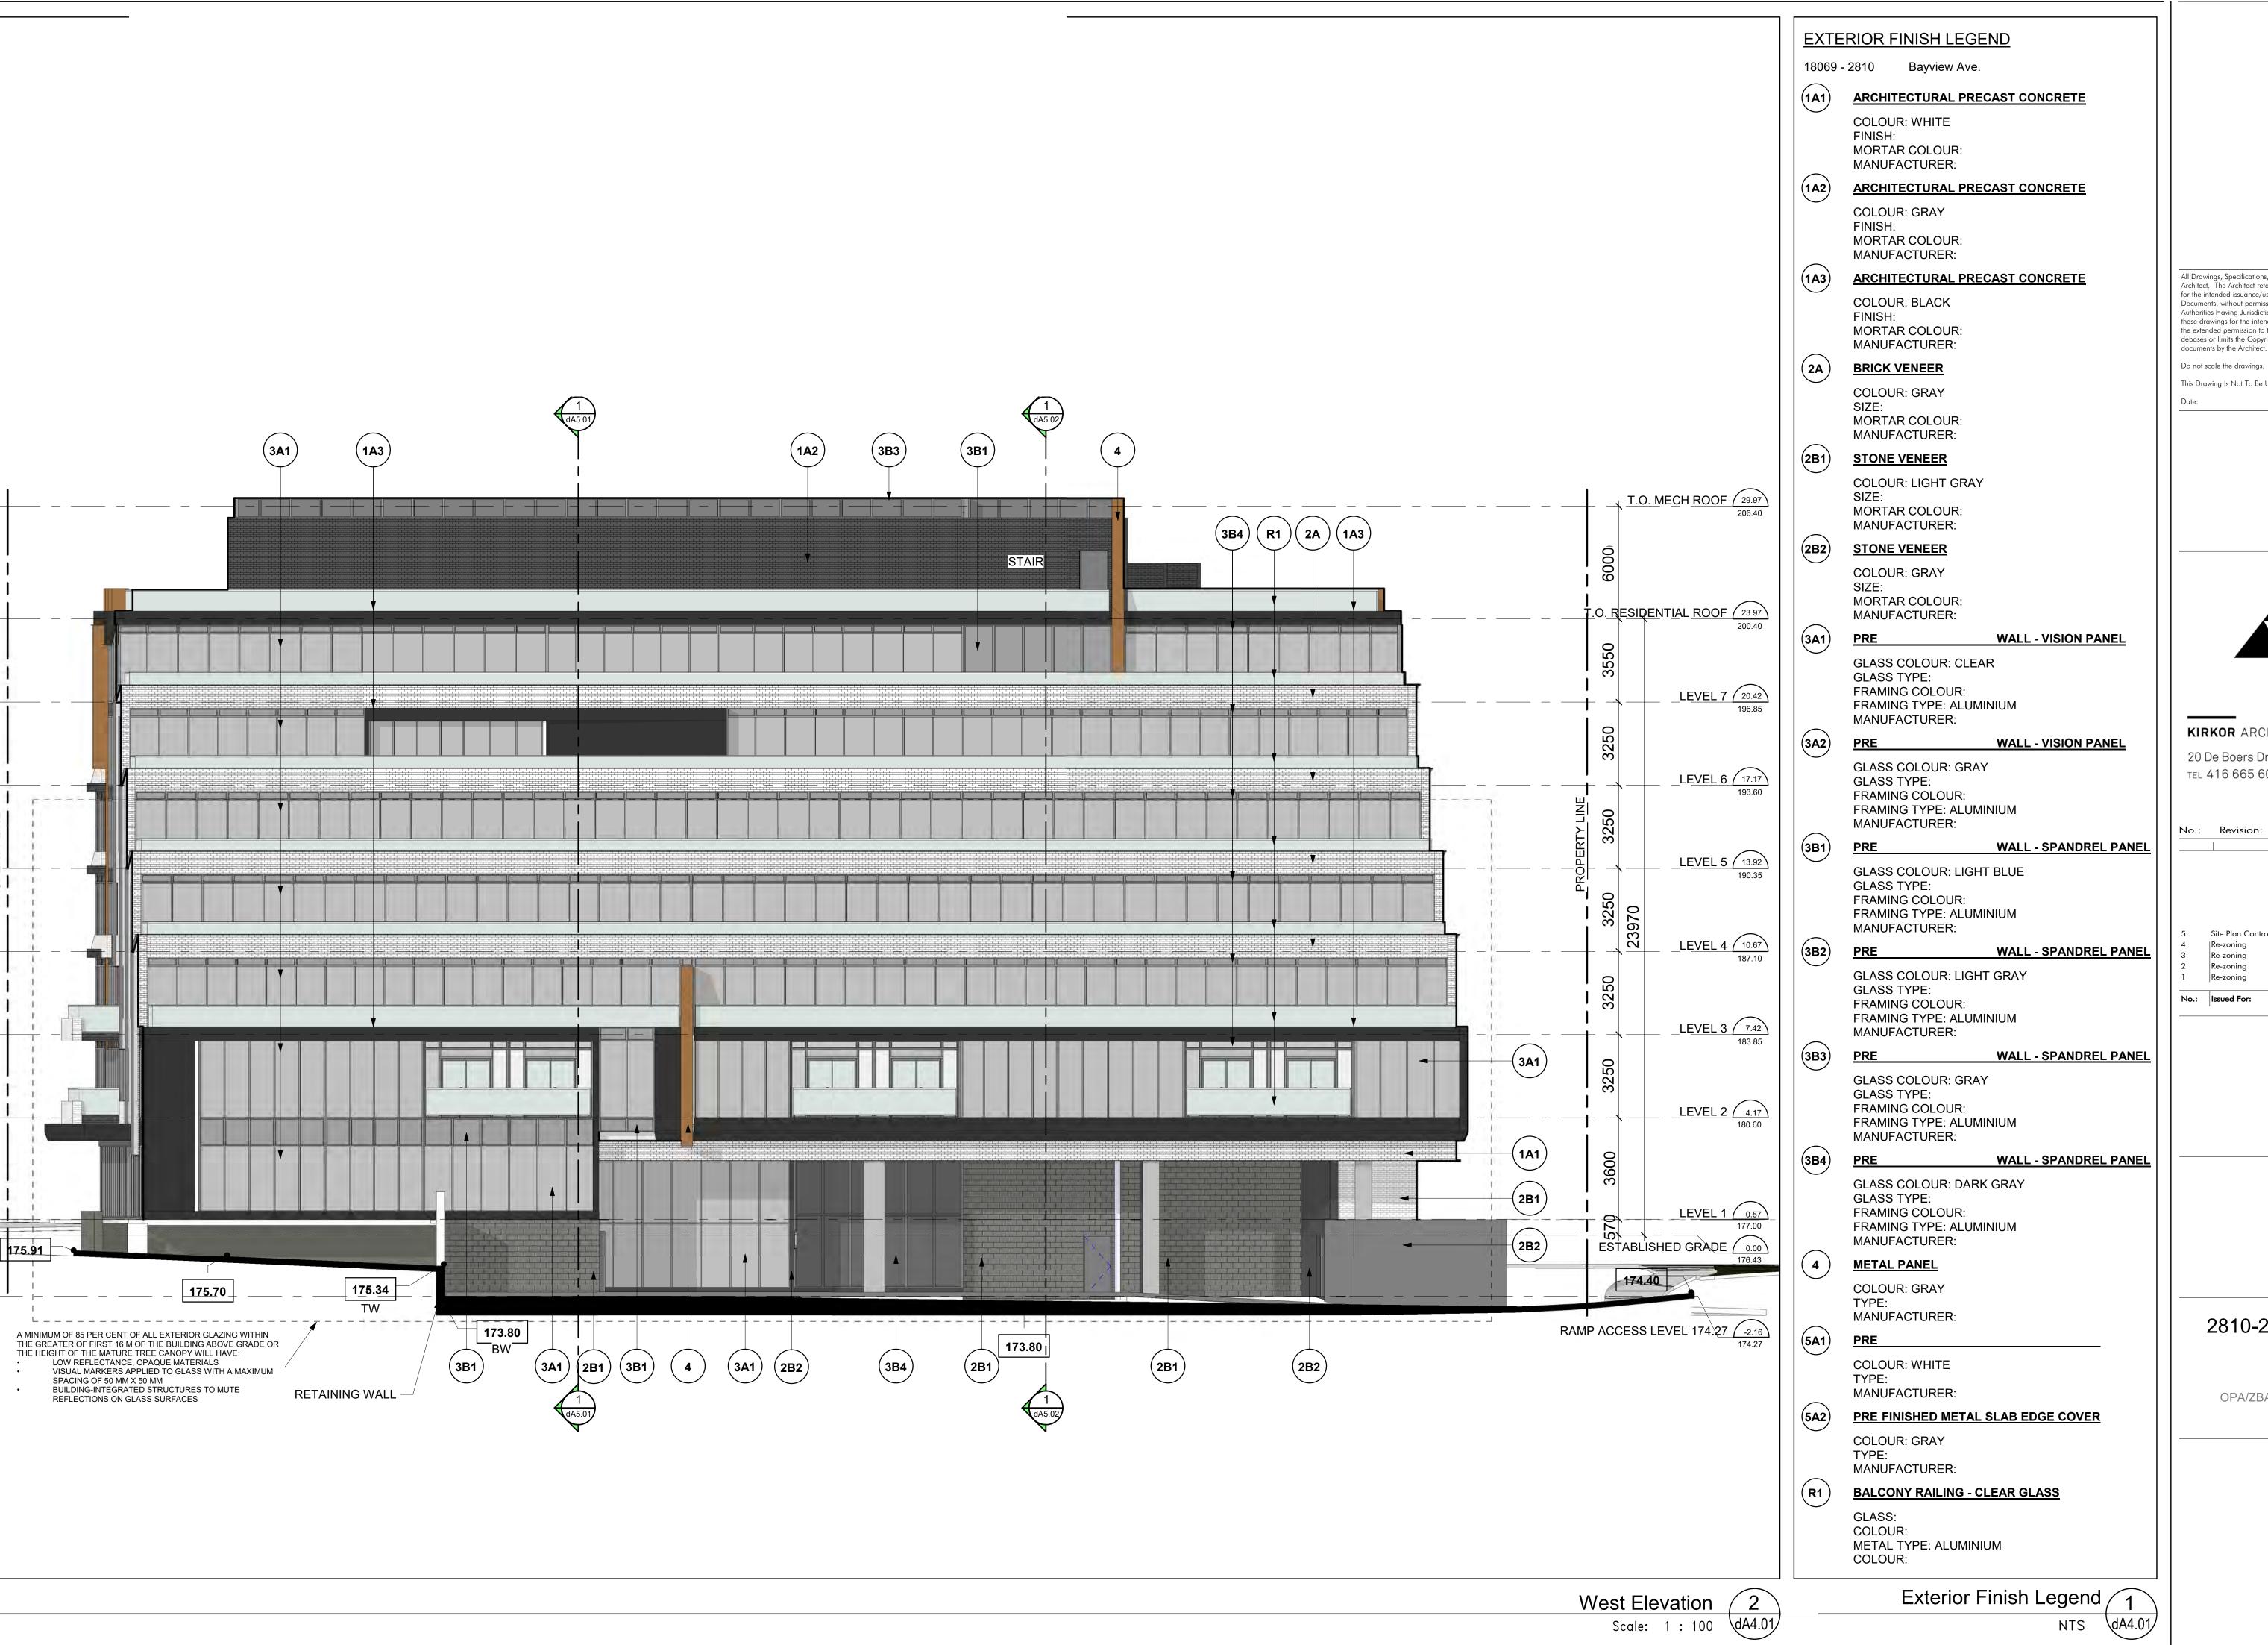Re-zoning No.: Issued For:

JAN 13, 2022

JAN 21,2021

NOV 20,2020

JULY 31,2020

Drawing Title:

MAY 1,2019

West Elevation

**Dormer Homes** 

2810-2814 Bayview Ave.


Related File:

OPA/ZBA: 19 150397NNY 18 OZ January 13, 2022

2810-2814 Bayview Ave.

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No.: Revision:

Site Plan Control Application JAN 13, 2022 JAN 21,2021 Re-zoning NOV 20,2020

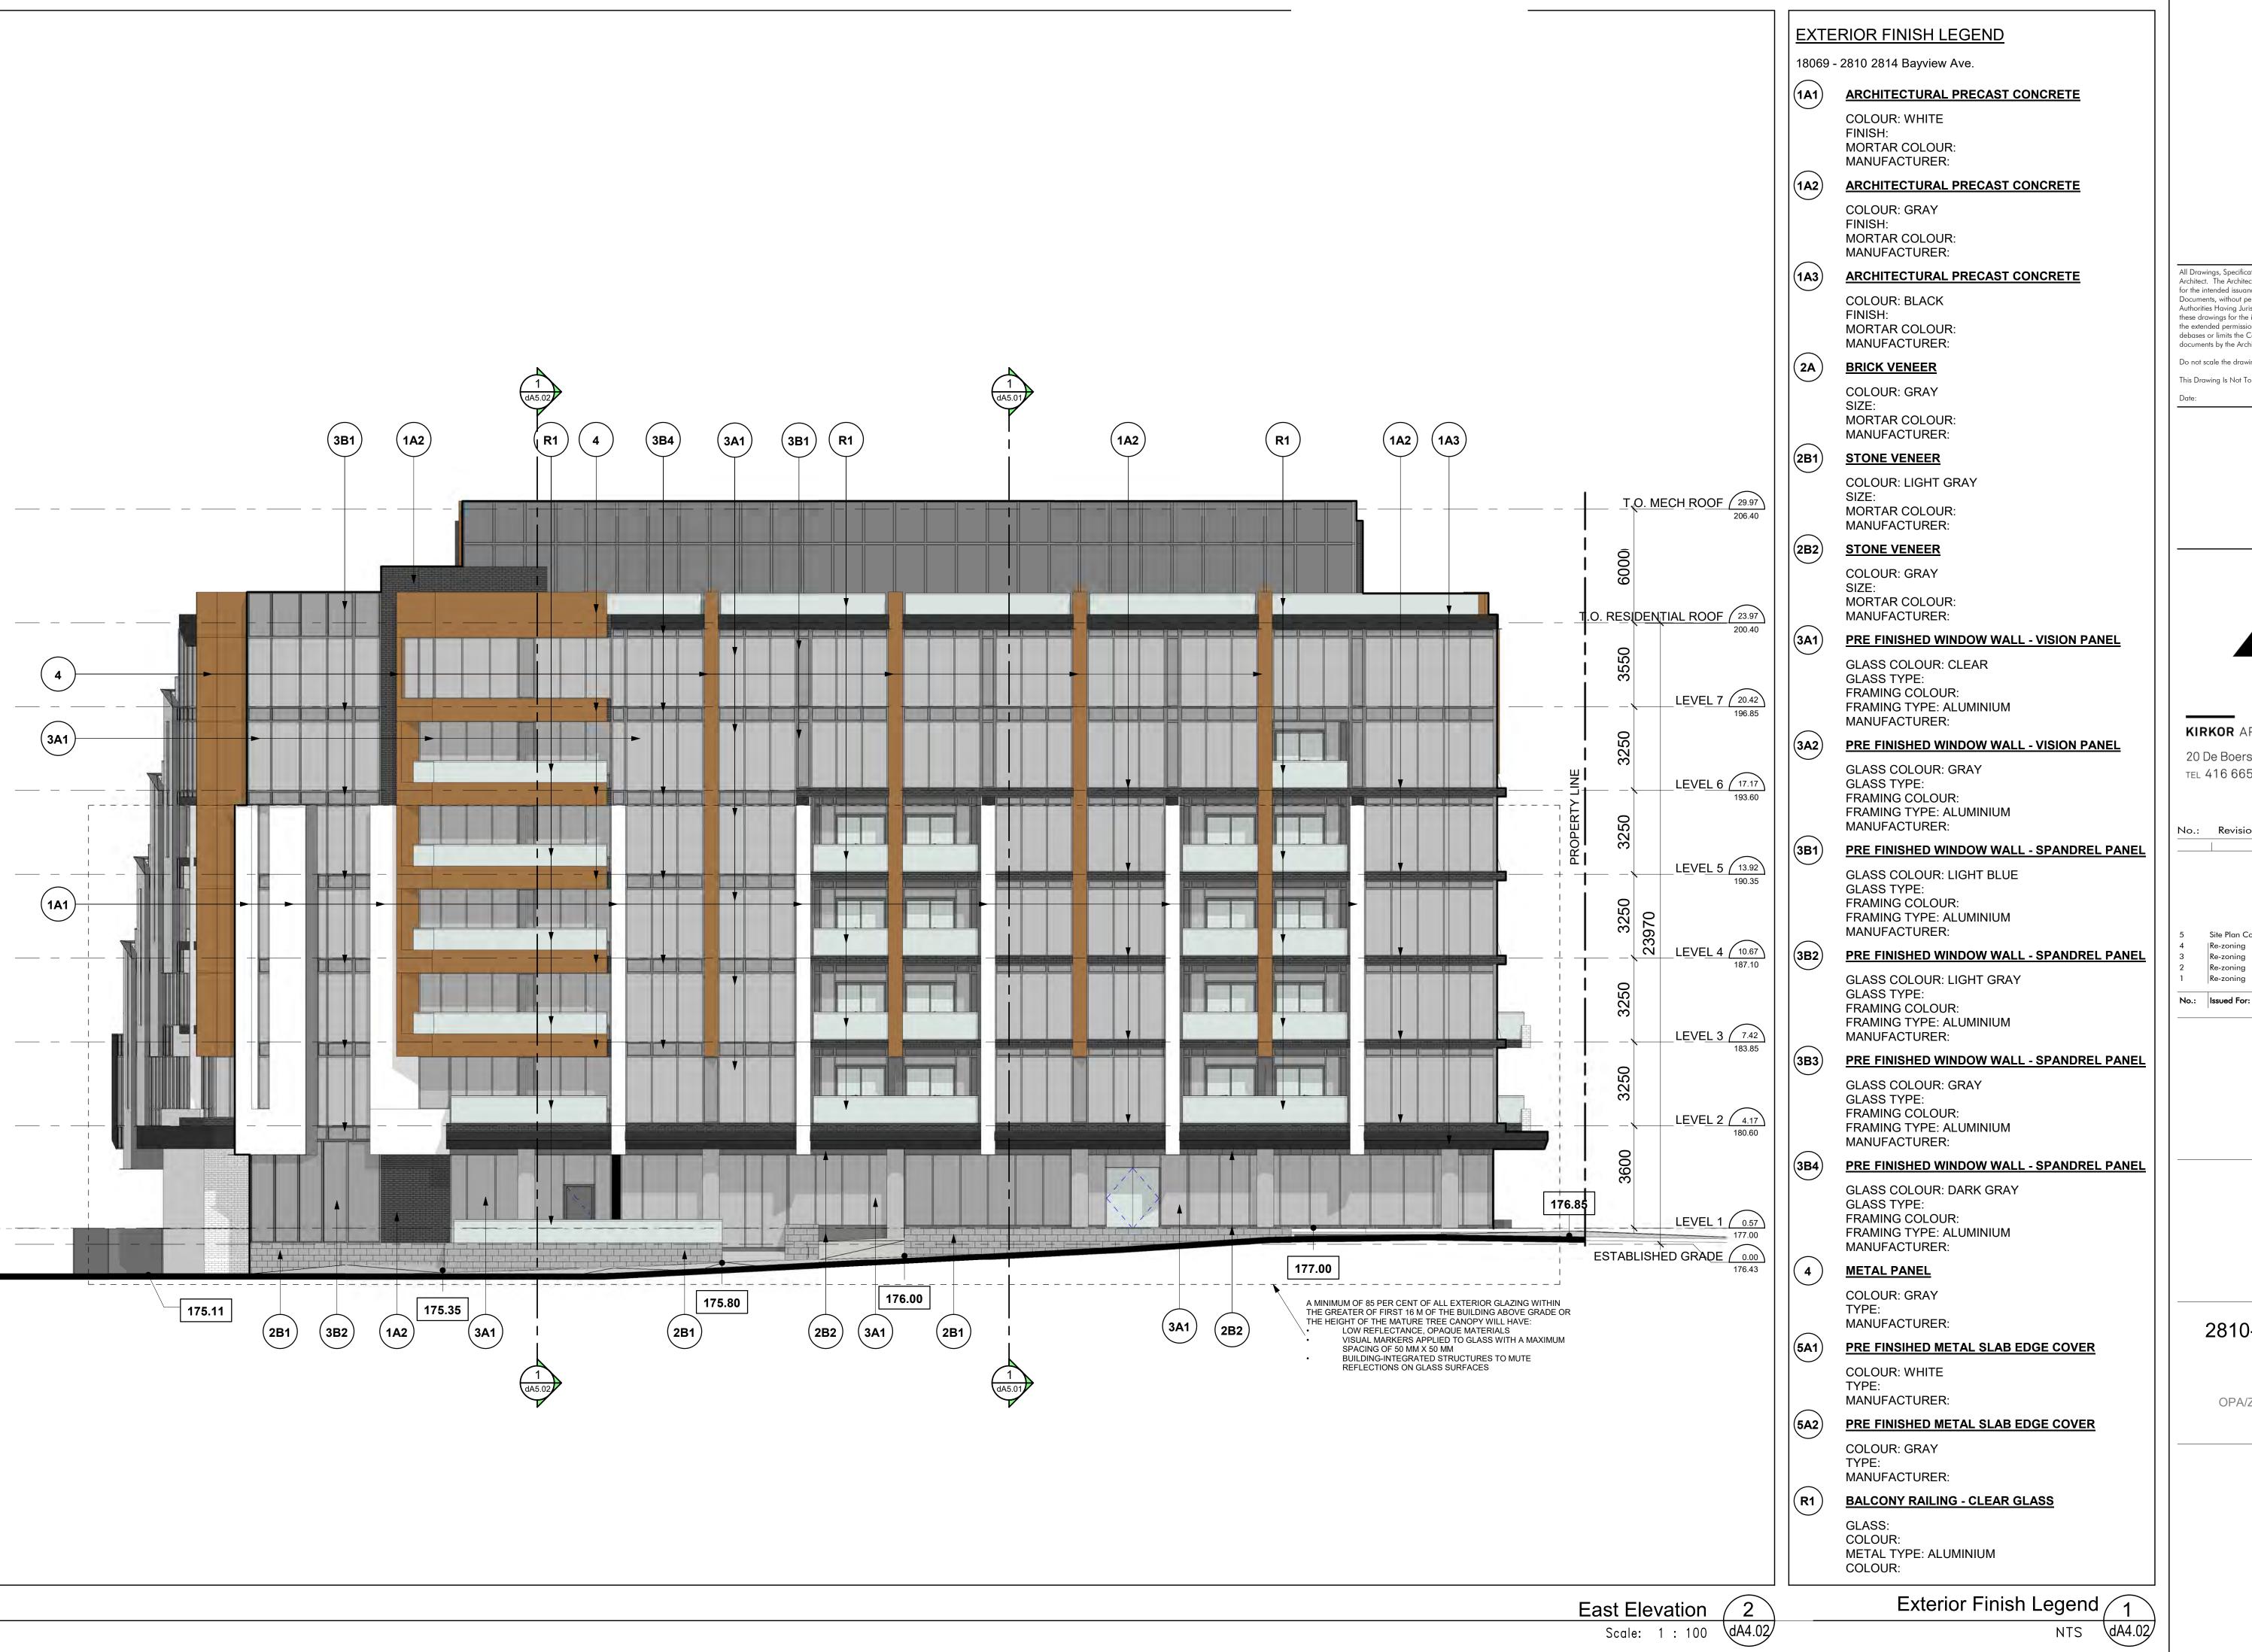Re-zoning JULY 31,2020 Re-zoning MAY 1,2019

**East Elevation** 

Drawing Title:

Dormer Homes

2810-2814 Bayview Ave.

Related File: OPA/ZBA: 19 150397NNY 18 OZ

January 13, 2022

2810-2814 Bayview Ave.

As indicated

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Project No.: 18069

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Revision:

Site Plan Control Application JAN 13, 2022 JAN 21,2021 Re-zoning NOV 20,2020 Re-zoning JULY 31,2020

MAY 1,2019 Drawing Title:

South Elevation

**Dormer Homes** 

2810-2814 Bayview Ave.

Related File: OPA/ZBA: 19 150397NNY 18 OZ

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Revision:

Site Plan Control Application JAN 13, 2022 JAN 21,2021 Re-zoning NOV 20,2020

JULY 31,2020 MAY 1,2019

North Elevation

Drawing Title:

**Dormer Homes** 

2810-2814 Bayview Ave.

Related File:

OPA/ZBA: 19 150397NNY 18 OZ January 13, 2022

2810-2814 Bayview Ave.

As indicated Drawn by A. I.

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No.: Revision:

JAN 13, 2022

Drawing Title:

1.50 East Elevation

Dormer Homes


2810-2814 Bayview Ave.

Related File: OPA/ZBA: 19 150397NNY 18 OZ January 13, 2022

2810-2814 Bayview Ave.

1:50 Drawn by A.I. Checked by D.S. Project No.:

18069

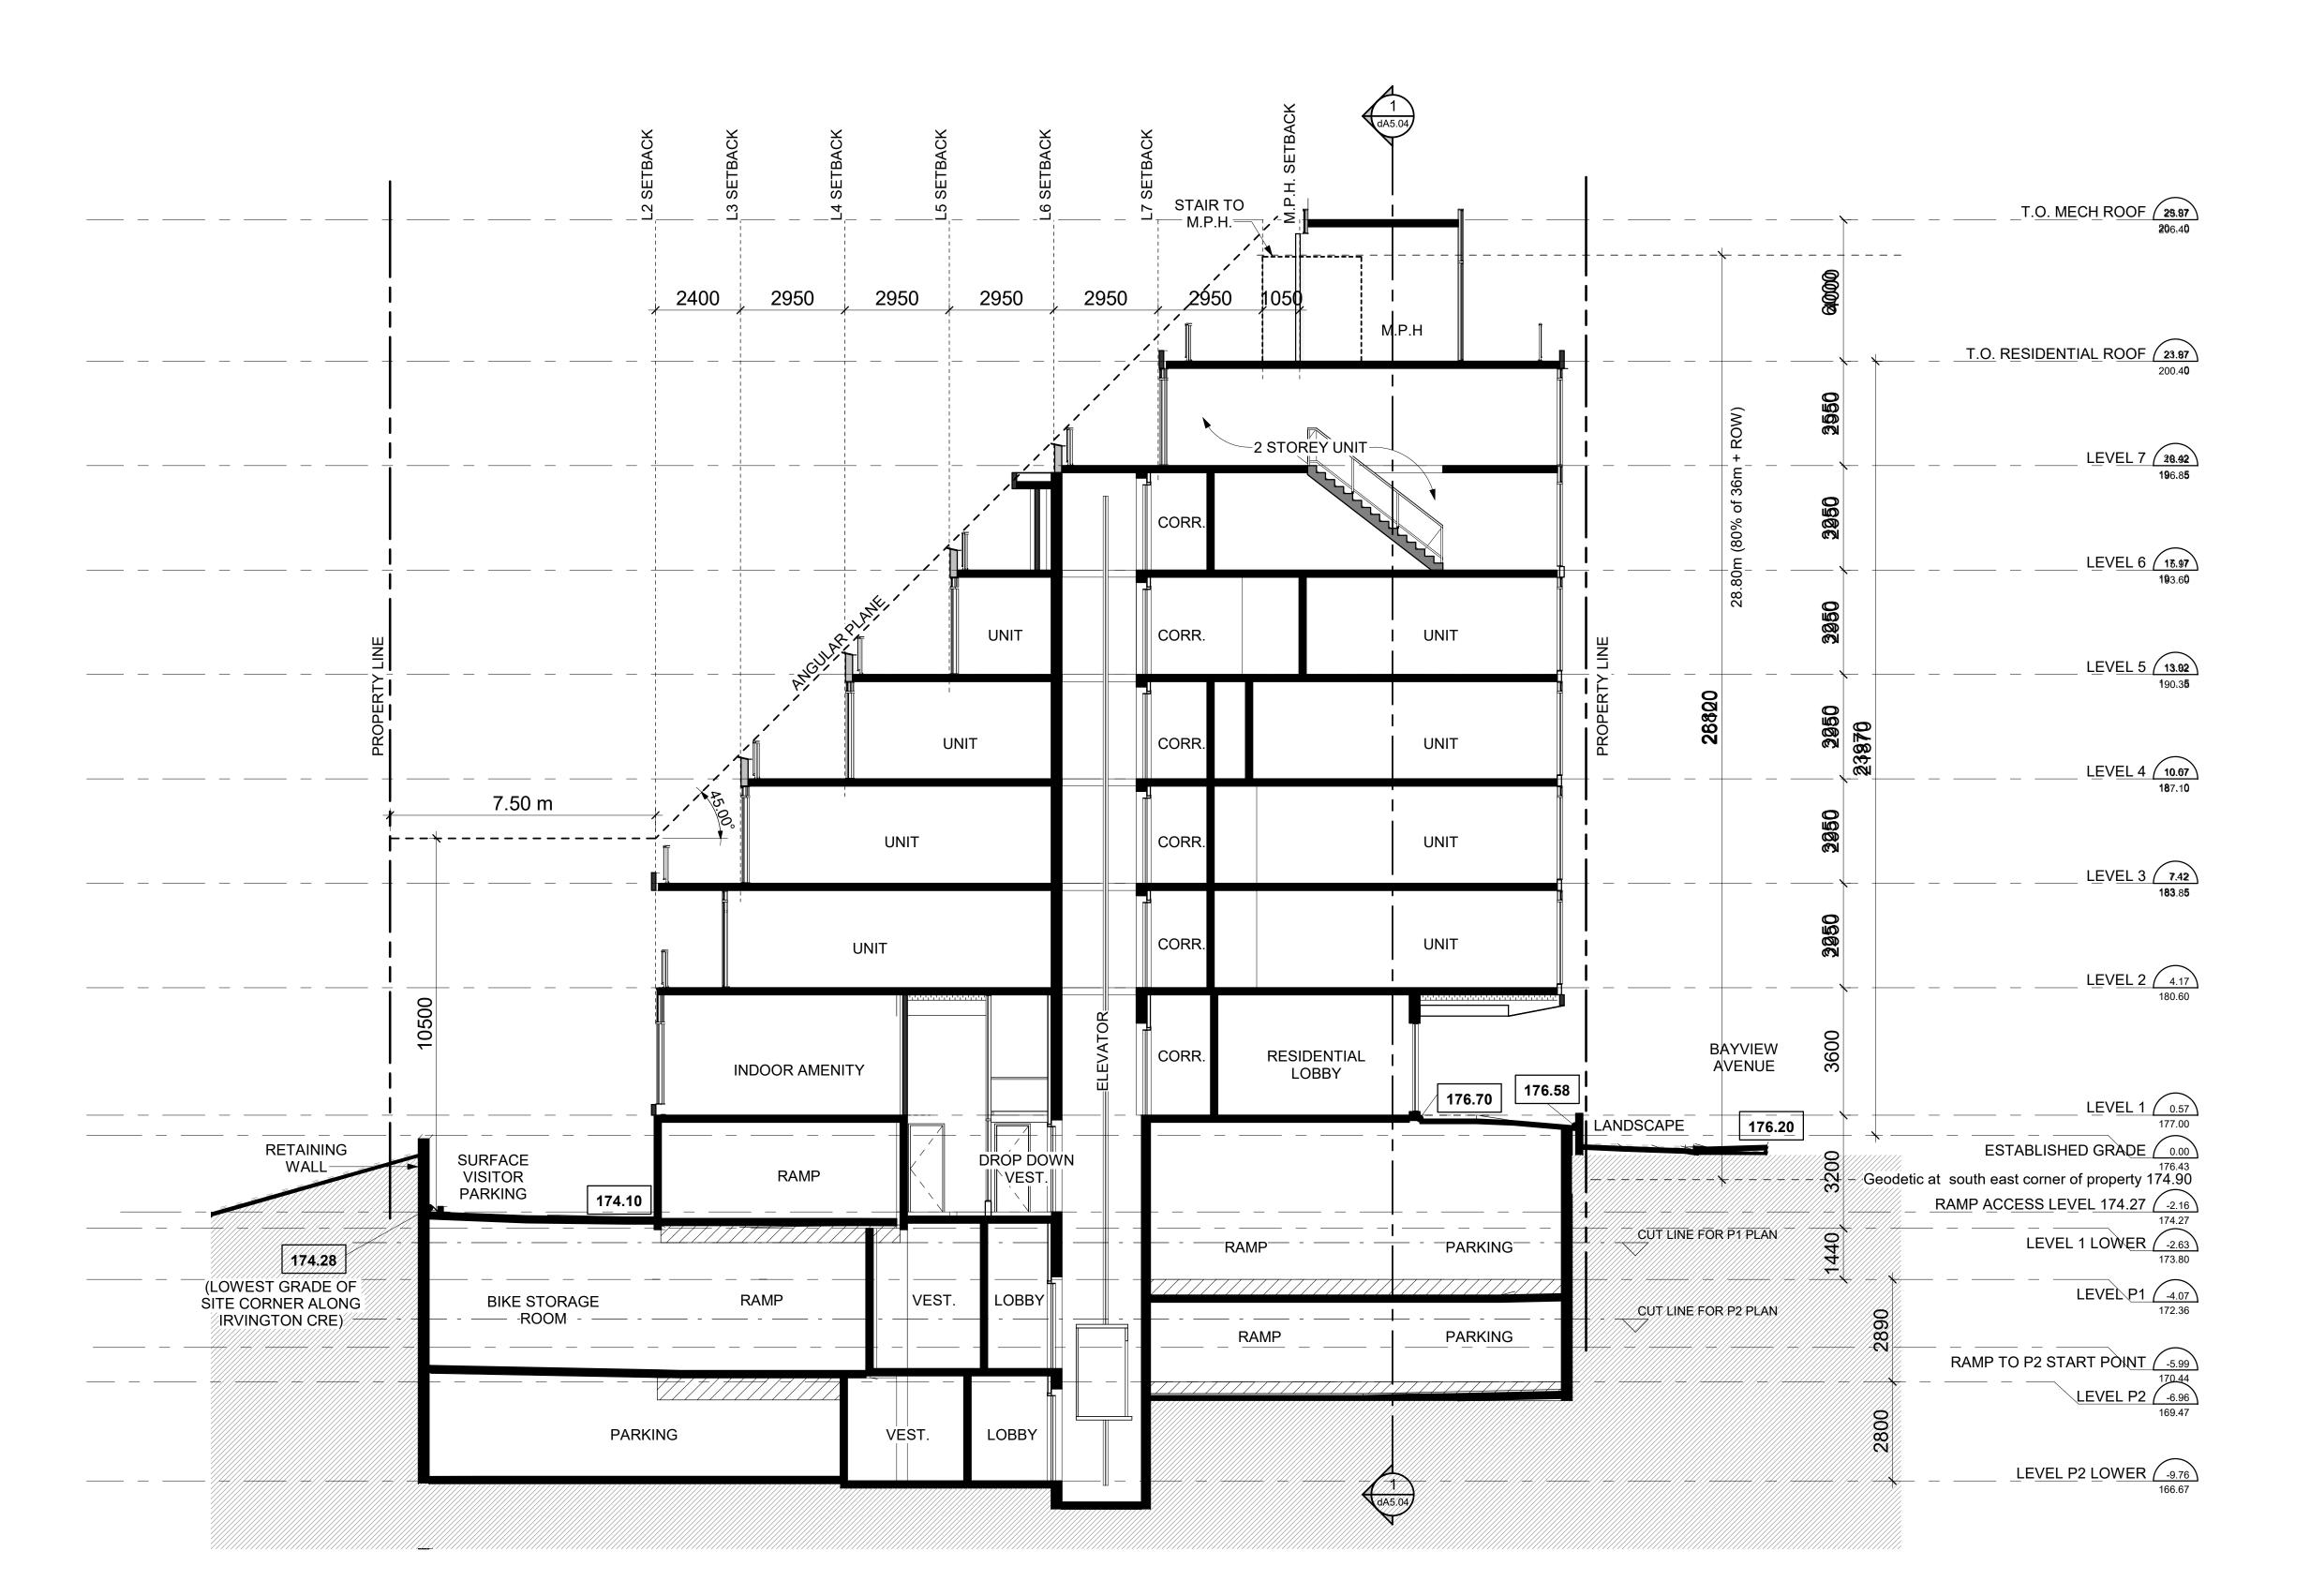

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No.: Revision:

JAN 13, 2022 JAN 21,2021 4 Re-zoning
3 Re-zoning
2 Re-zoning
1 Re-zoning NOV 20,2020 JULY 31,2020 MAY 1,2019

Drawing Title:

**Transverse Cross Section** 

Dormer Homes


2810-2814 Bayview Ave.

Related File: OPA/ZBA: 19 150397NNY 18 OZ

January 13, 2022 2810-2814 Bayview Ave.

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MAY 1,2019

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No.: Revision:

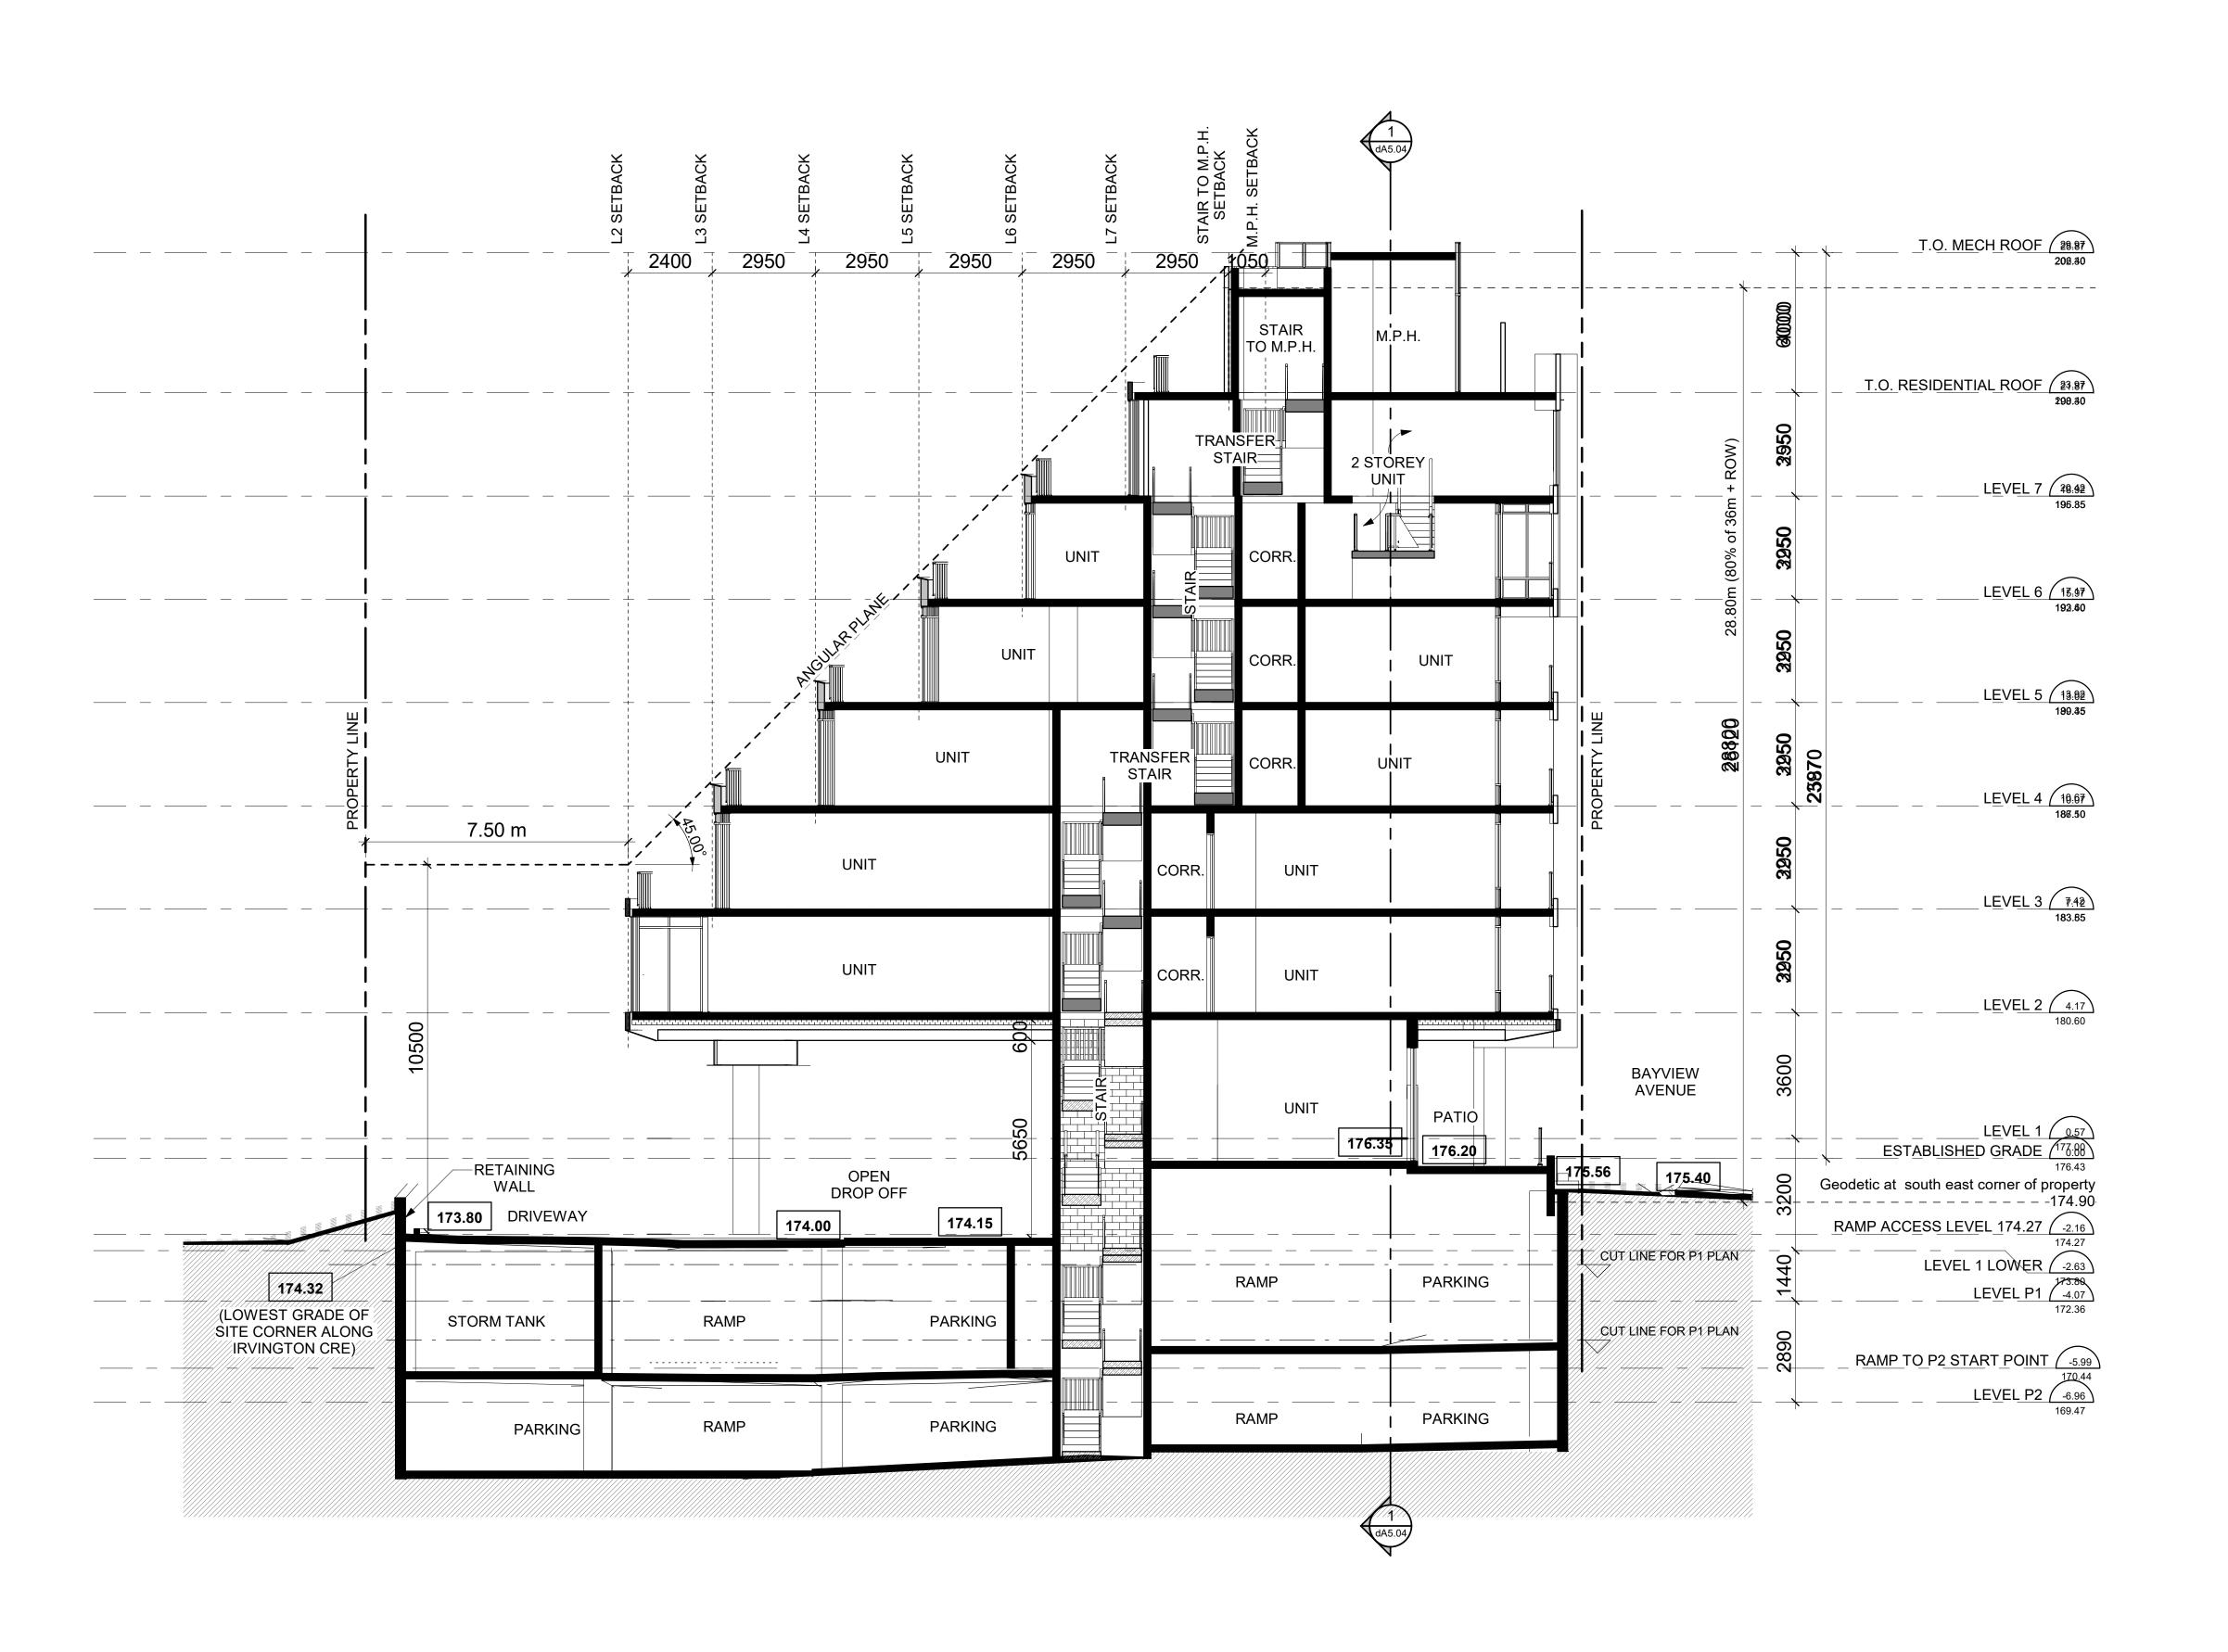Site Plan Control Application

4 Re-zoning
3 Re-zoning
2 Re-zoning
1 Re-zoning

Drawing Title:

JAN 13, 2022 JAN 21,2021

NOV 20,2020 JULY 31,2020

MAY 1,2019

Longitudinal Cross Section

Dormer Homes

2810-2814 Bayview Ave.

Related File: OPA/ZBA: 19 150397NNY 18 OZ January 13, 2022

2810-2814 Bayview Ave.

1:100 B.S. / M.S. / Drawn by:
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B.C. / D.L./ Checked by:
D.S.

Project No.


18069 January 13, 2022

Longitudinal Cross Section Scale: 1: 100 dA5.04

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Perspective Views

Dormer Homes

2810-2814 Bayview Ave.
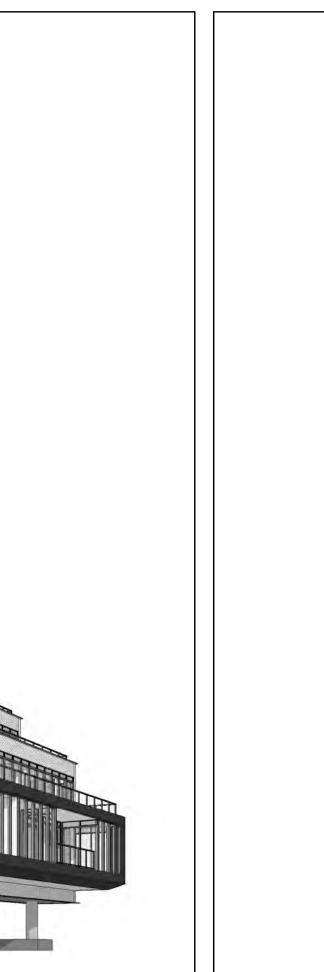
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2810-2814 Bayview Ave.

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B.C. / D.L.

January 13, 2022

SW Perspective View

NW Perspective View 2

NTS dA6.01



NE Perspective View 4