		DRAWING LIST		
Sheets: Sheet	Sheet		ssue#1 (Nov 06, 2020)	Issue#2 (June 01,2022)
Туре	Number	Sheet Name	<u>88</u>	<u> šš</u>
11 OPA				
A0				
Cover Sheet	dA0.0	Cover Sheet		•
A1			I	
	dA1.1	Survey - Existing Site		
	dA1.2	Site Context Plan Existing	•	-
	dA1.3	Site Context Plan Proposed Development		•
	dA1.4	Block Structure & Project Statistics		•
	dA1.5	Block Context Plan	-	-
	dA1.6	Block - Building Heights & Setbacks		•
	dA1.7	Phasing Plan	•	•
A2				
	dA2.1	Block - Massing (Axonometric)		•
	dA2.2	Axonometric - Block 1		•
	dA2.3	Axonometric - Block 2		-
			_	
	dA2.4	Axonometric - Block 3		
	dA2.4 dA2.5	Axonometric - Block 3 Axonometric - Block 4	-	
A3	dA2.5	Axonometric - Block 4		Ė
A3				

dA3.2 Block - Sun Shadow Study (June)

ARCHITECT

KIRKOR | Architects & Planners Clifford Korman 20 De Boers Dr. Suite #400 Toronto, ON M3J 0H1 T 416 665 6060

PLANNING

Hunter & Associates Ltd. J. Craig Hunter 15 Gervais Drive, Suite 503 Toronto, ON M3C 1Y8 T 416 434 4510

TRAFFIC

BA Consulting Group Ltd Alun S. Lloyd 45 St Clair Ave W, Toronto, ON M4V 1K9 T 416 961 7110

SURVEY

SVNG Dave Wilton 750 Oakdale Road Unit 65 & 66 Toronto, ON M3N 2Z4 T 416 749 7864

LEGAL

Stikeman Elliott LLP Barristers & Solicitors Kelly Oksenberg 5300 Commerce Court West, 199 Bay Street Toronto, ON M5L 1B9 T 416 869 5645

CIVIL / SITE SERVICING

Odan-Detech Group Inc 5230 S Service Rd Burlington, ON L7L 5K2 T 905 632 3811

GOLDEN MILE SECONDARY PLAN RIOCAN SCARBOROUGH CENTRE

MIXED USE DEVELOPMENT

1966-2050 EGLINTON AVENUE EAST & 50 THERMOS ROAD SCARBOROUGH, TORONTO, ONTARIO

CC45.17a - Confidential Appendix C- made public on June 24, 2022

Copyright of the Architect. The Architect retains all rights to control all uses of these documents for the intended issuance/use as identified below. Reproduction of these Documents, without permission from the Architect, is strictly prohibited. The Authorities Having Jurisdiction are permitted to use, distribute, and reproduce these drawings for the intended issuance as noted and dated below, however the extended permission to the Authorities Having Jurisdiction in no way debases or limits the Copyright of the Architect, or control of use of these documents by the Architect.

Authorities Having Jurisdiction

Do not scale the drawings.

This Drawing Is Not To Be Used For Construction Until Signed ByThe Architect.

KIRKOR

ARCHITECTS AND PLANNERS

20 De Boers Drive Suite 400 Toronto, ON M3J 0H1

Da Revision: Da

02 OPA Application -Resubmission June 01, 2022

Cover Sheet

Nov 06, 2020

Drawing Title

RIOCAN

RIO * CAN
REAL VISION, SOLID GROUND.

Scarborough Centre

1966-2050 EGLINTON AVENUE EAST & 50 THERMOS ROAD

& 50 THERMOS ROAD SCARBOROUGH, TORONTO, ONTARIO

Scale:

Drawn by:
Author


Checked by
Checker


Project No.


20026

Date
June 01, 2022

4000

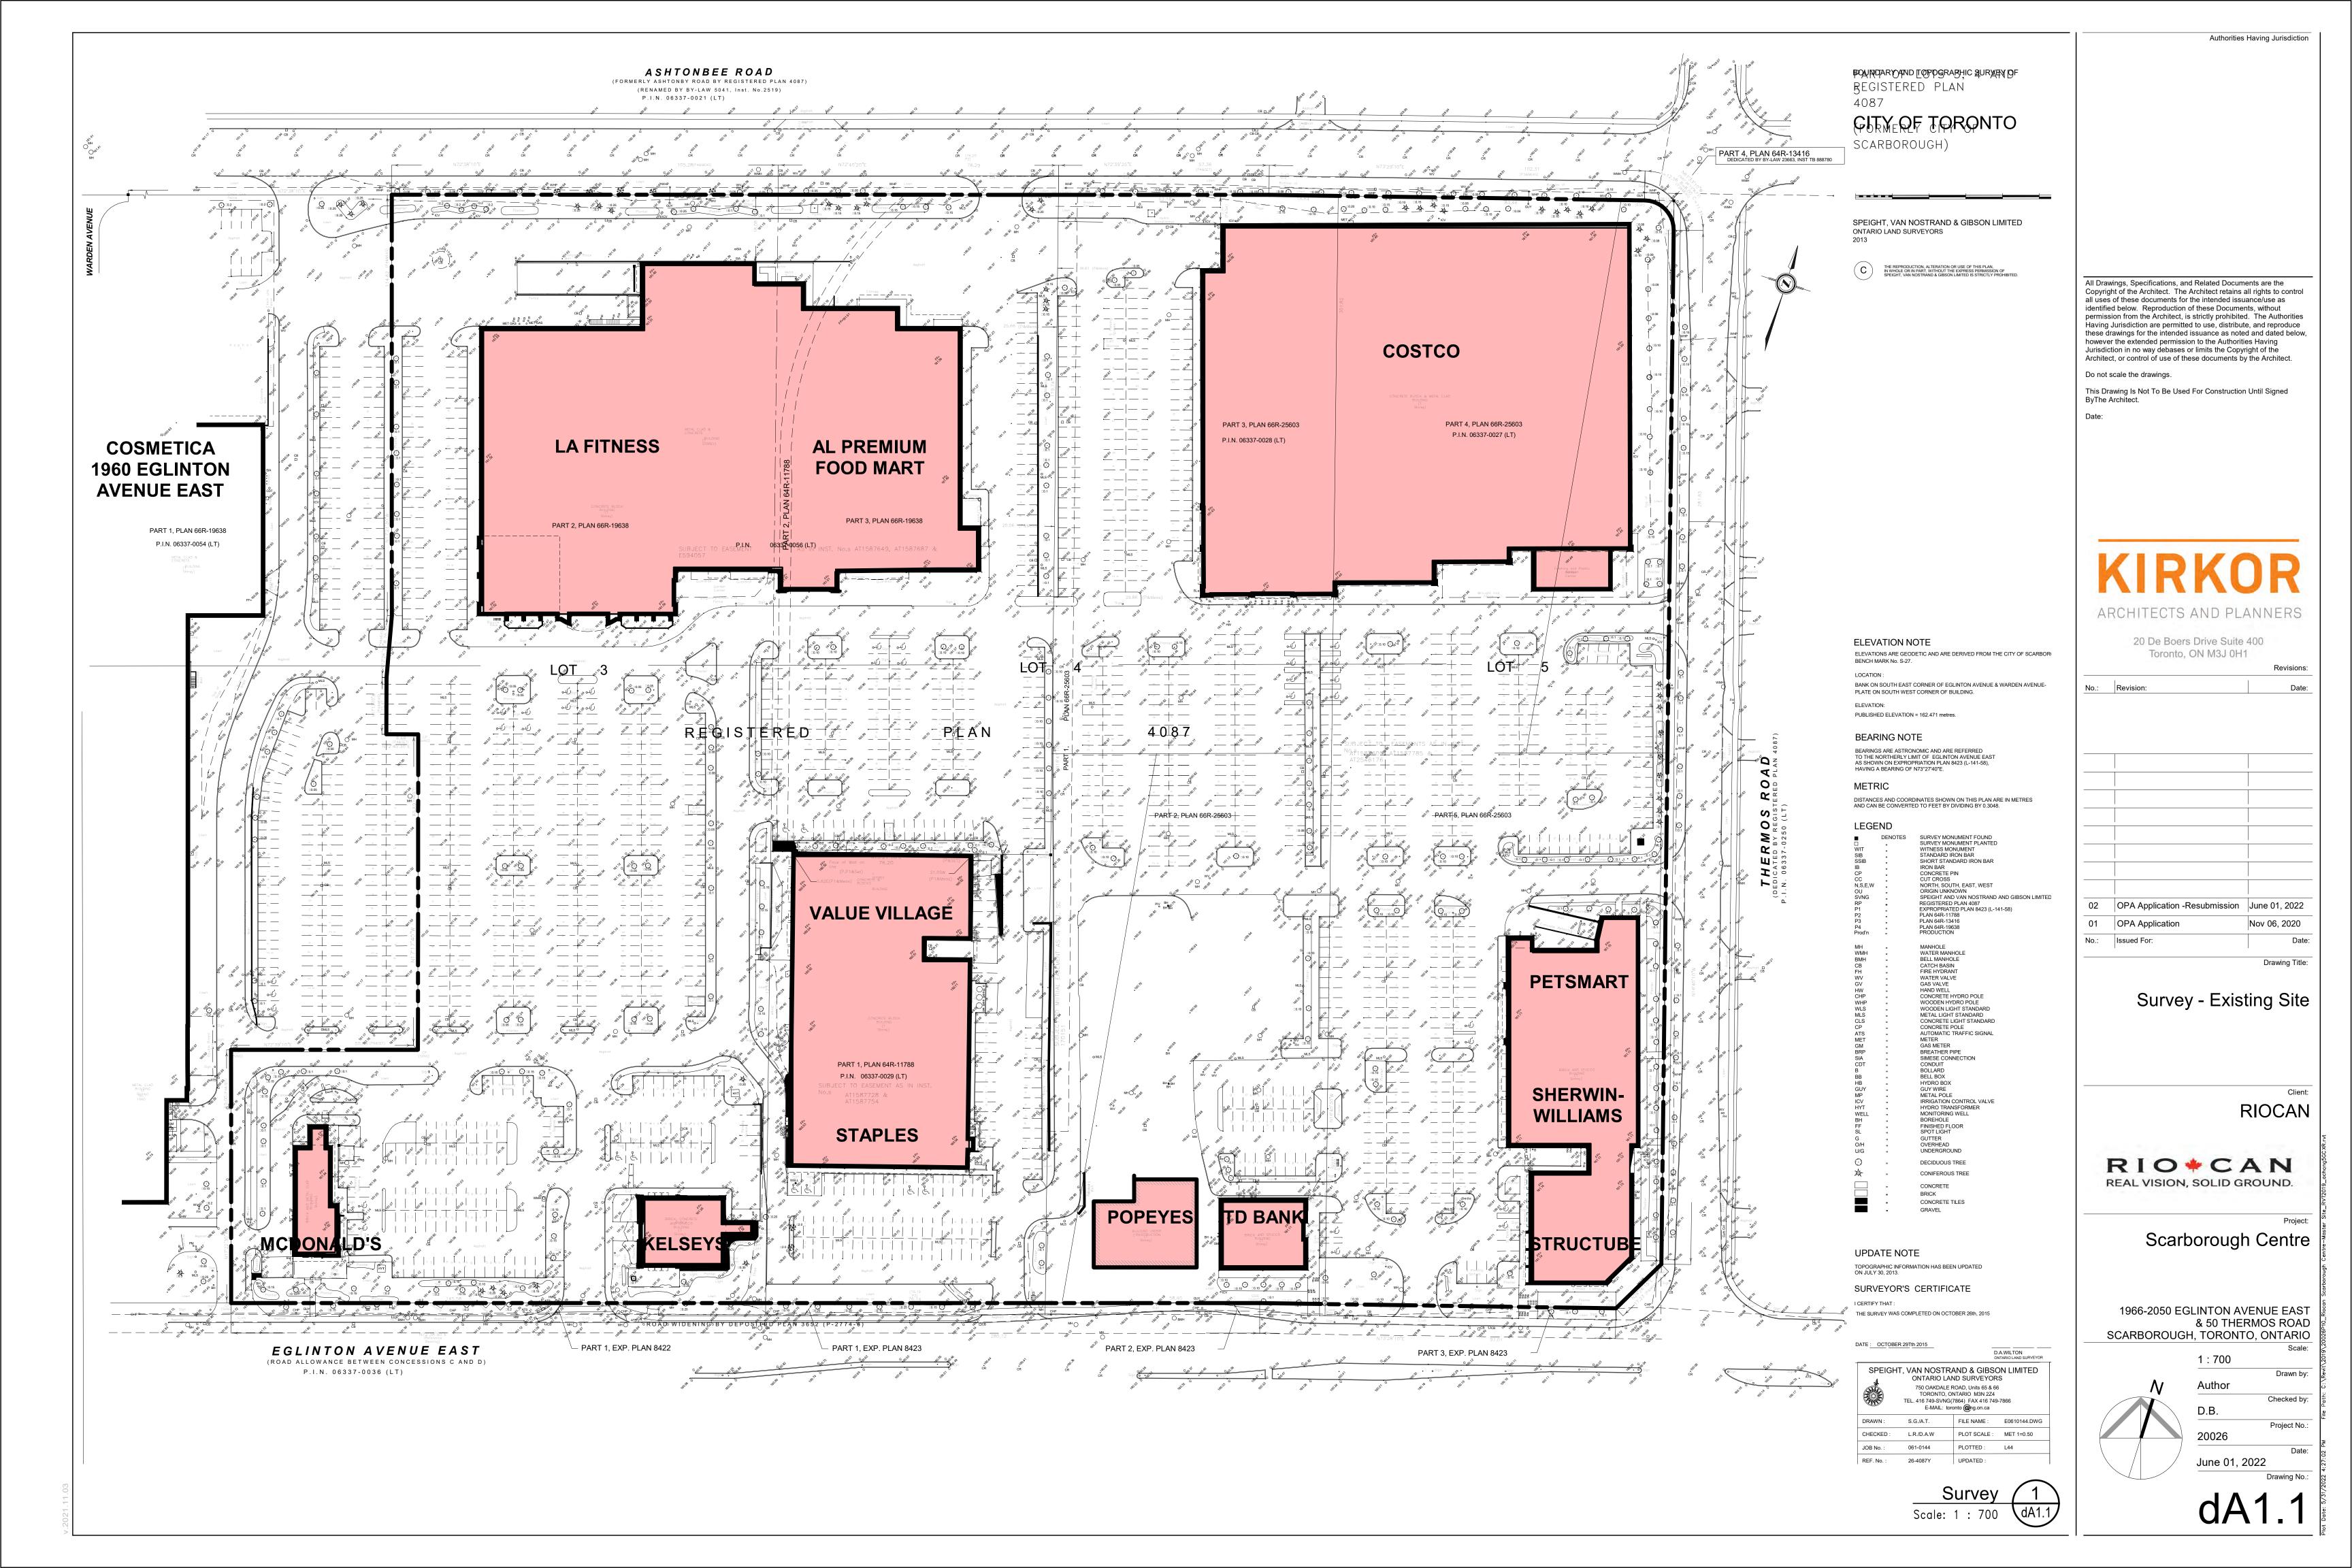

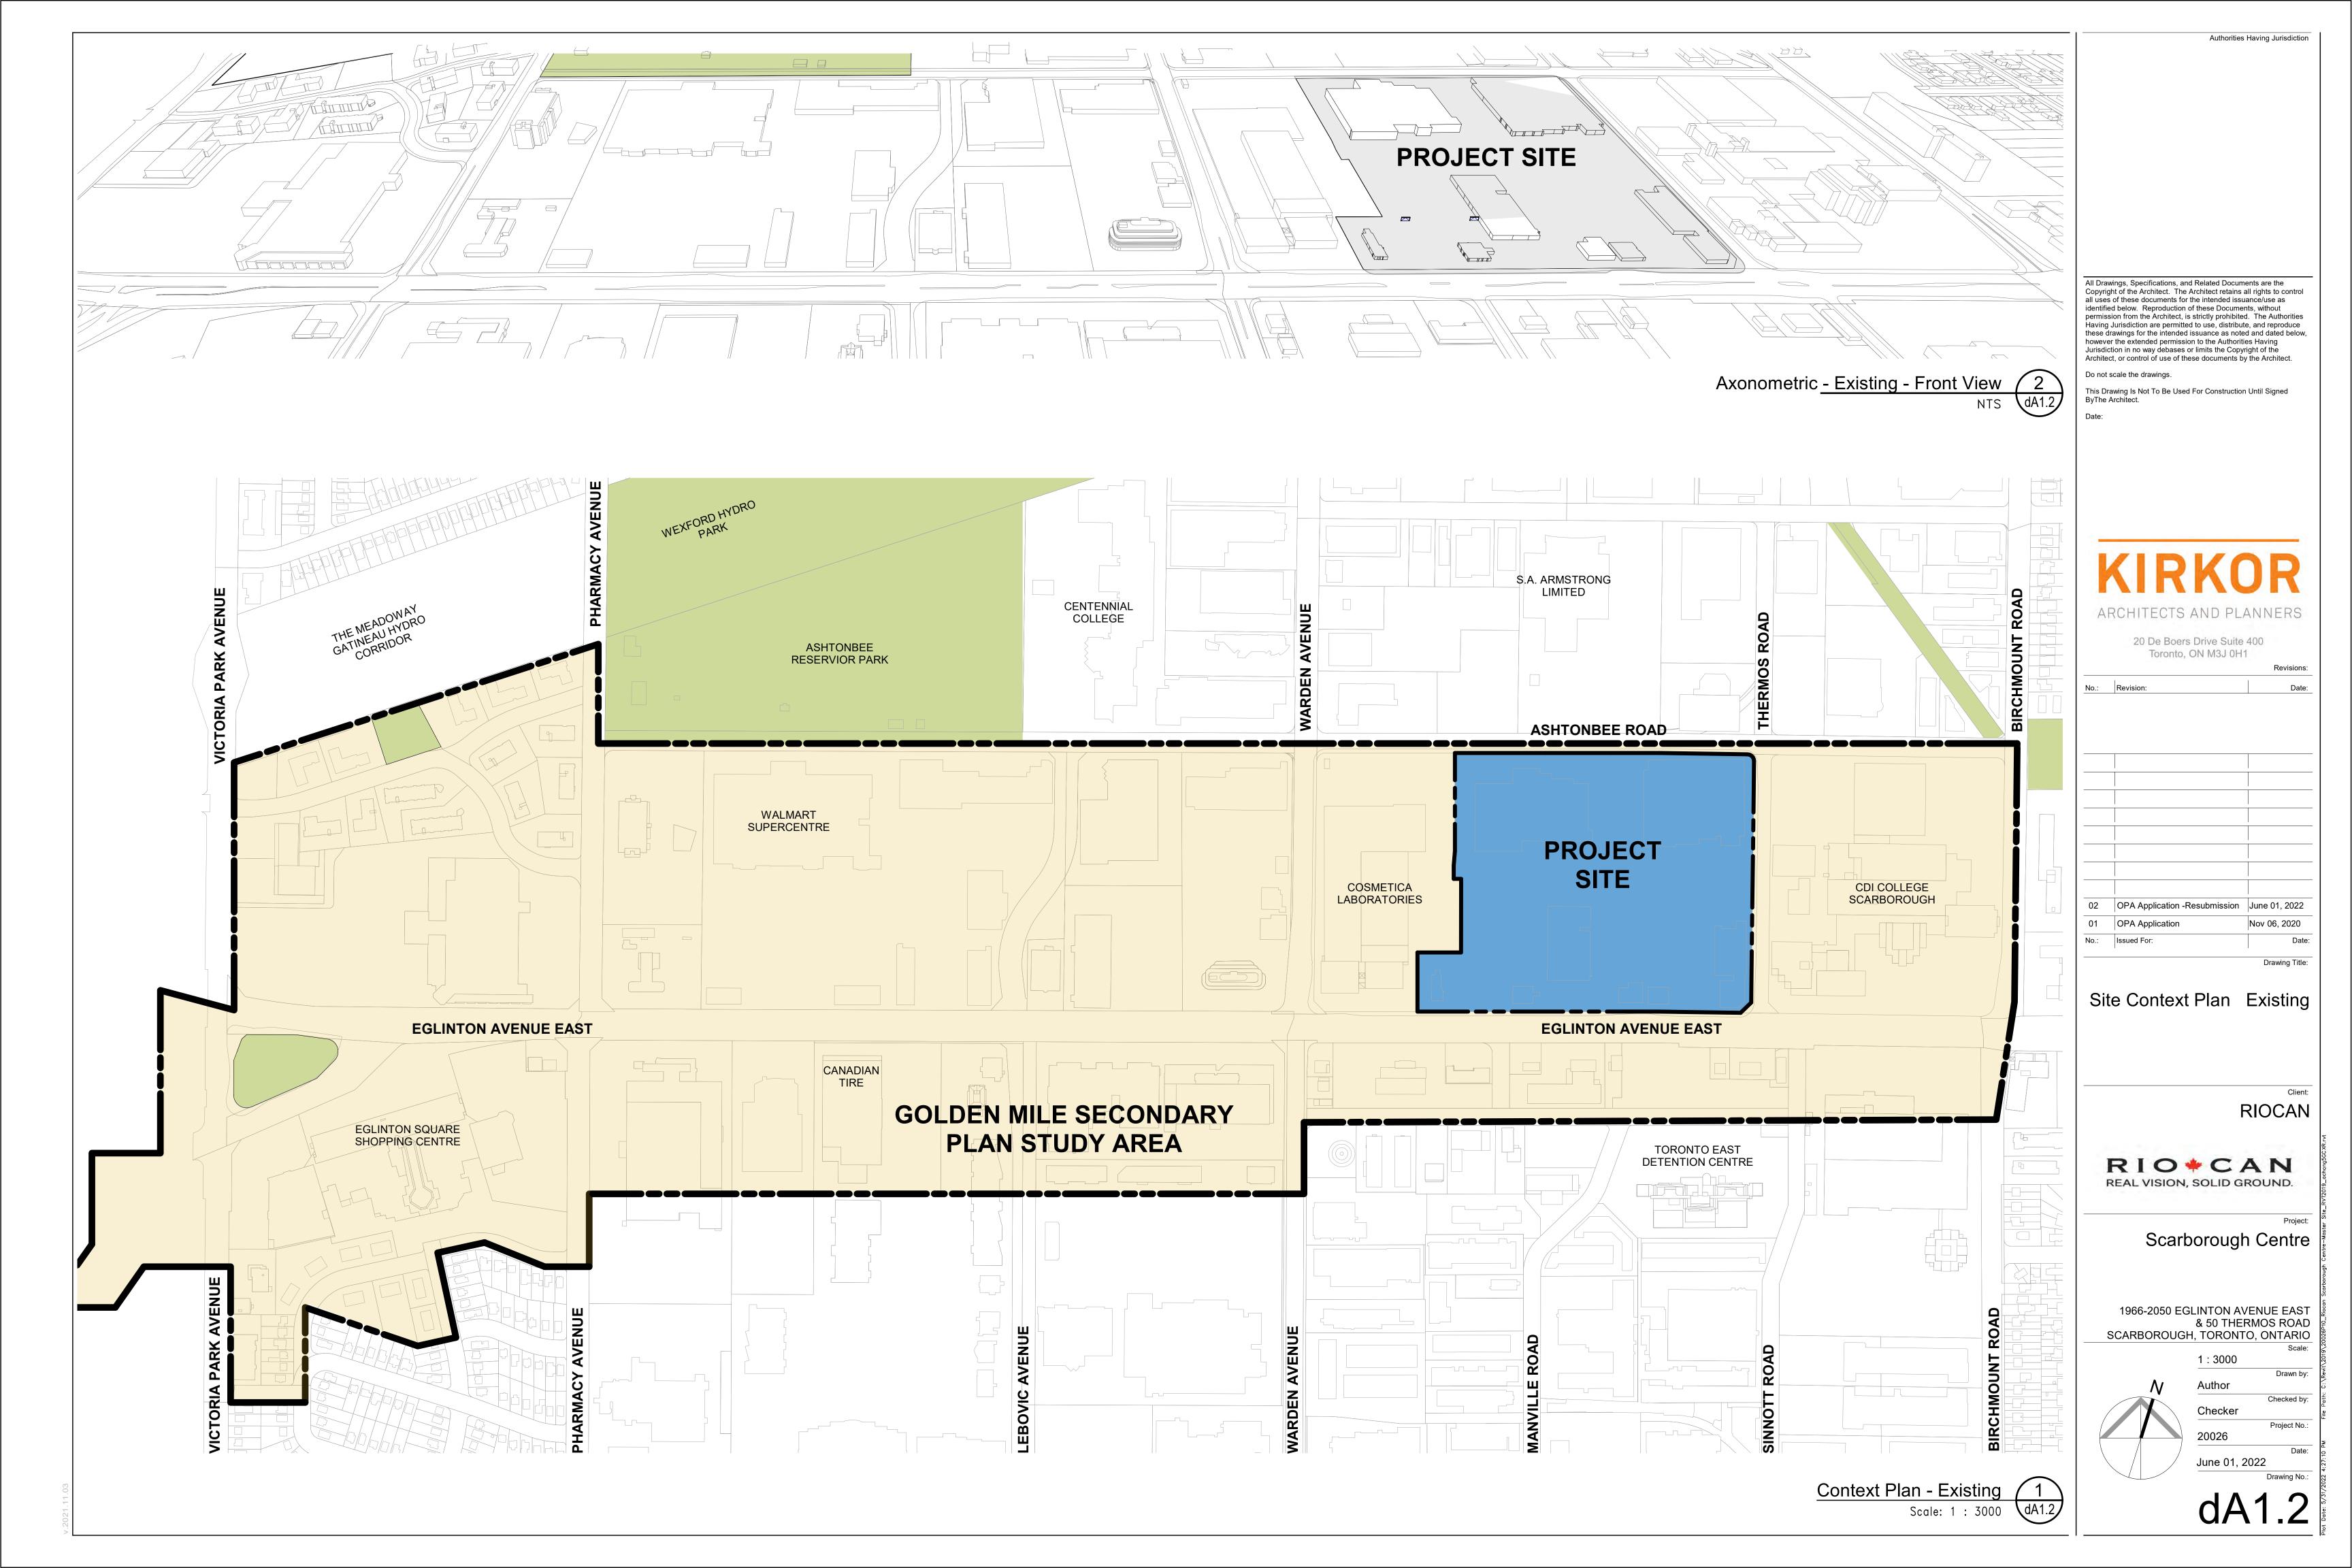

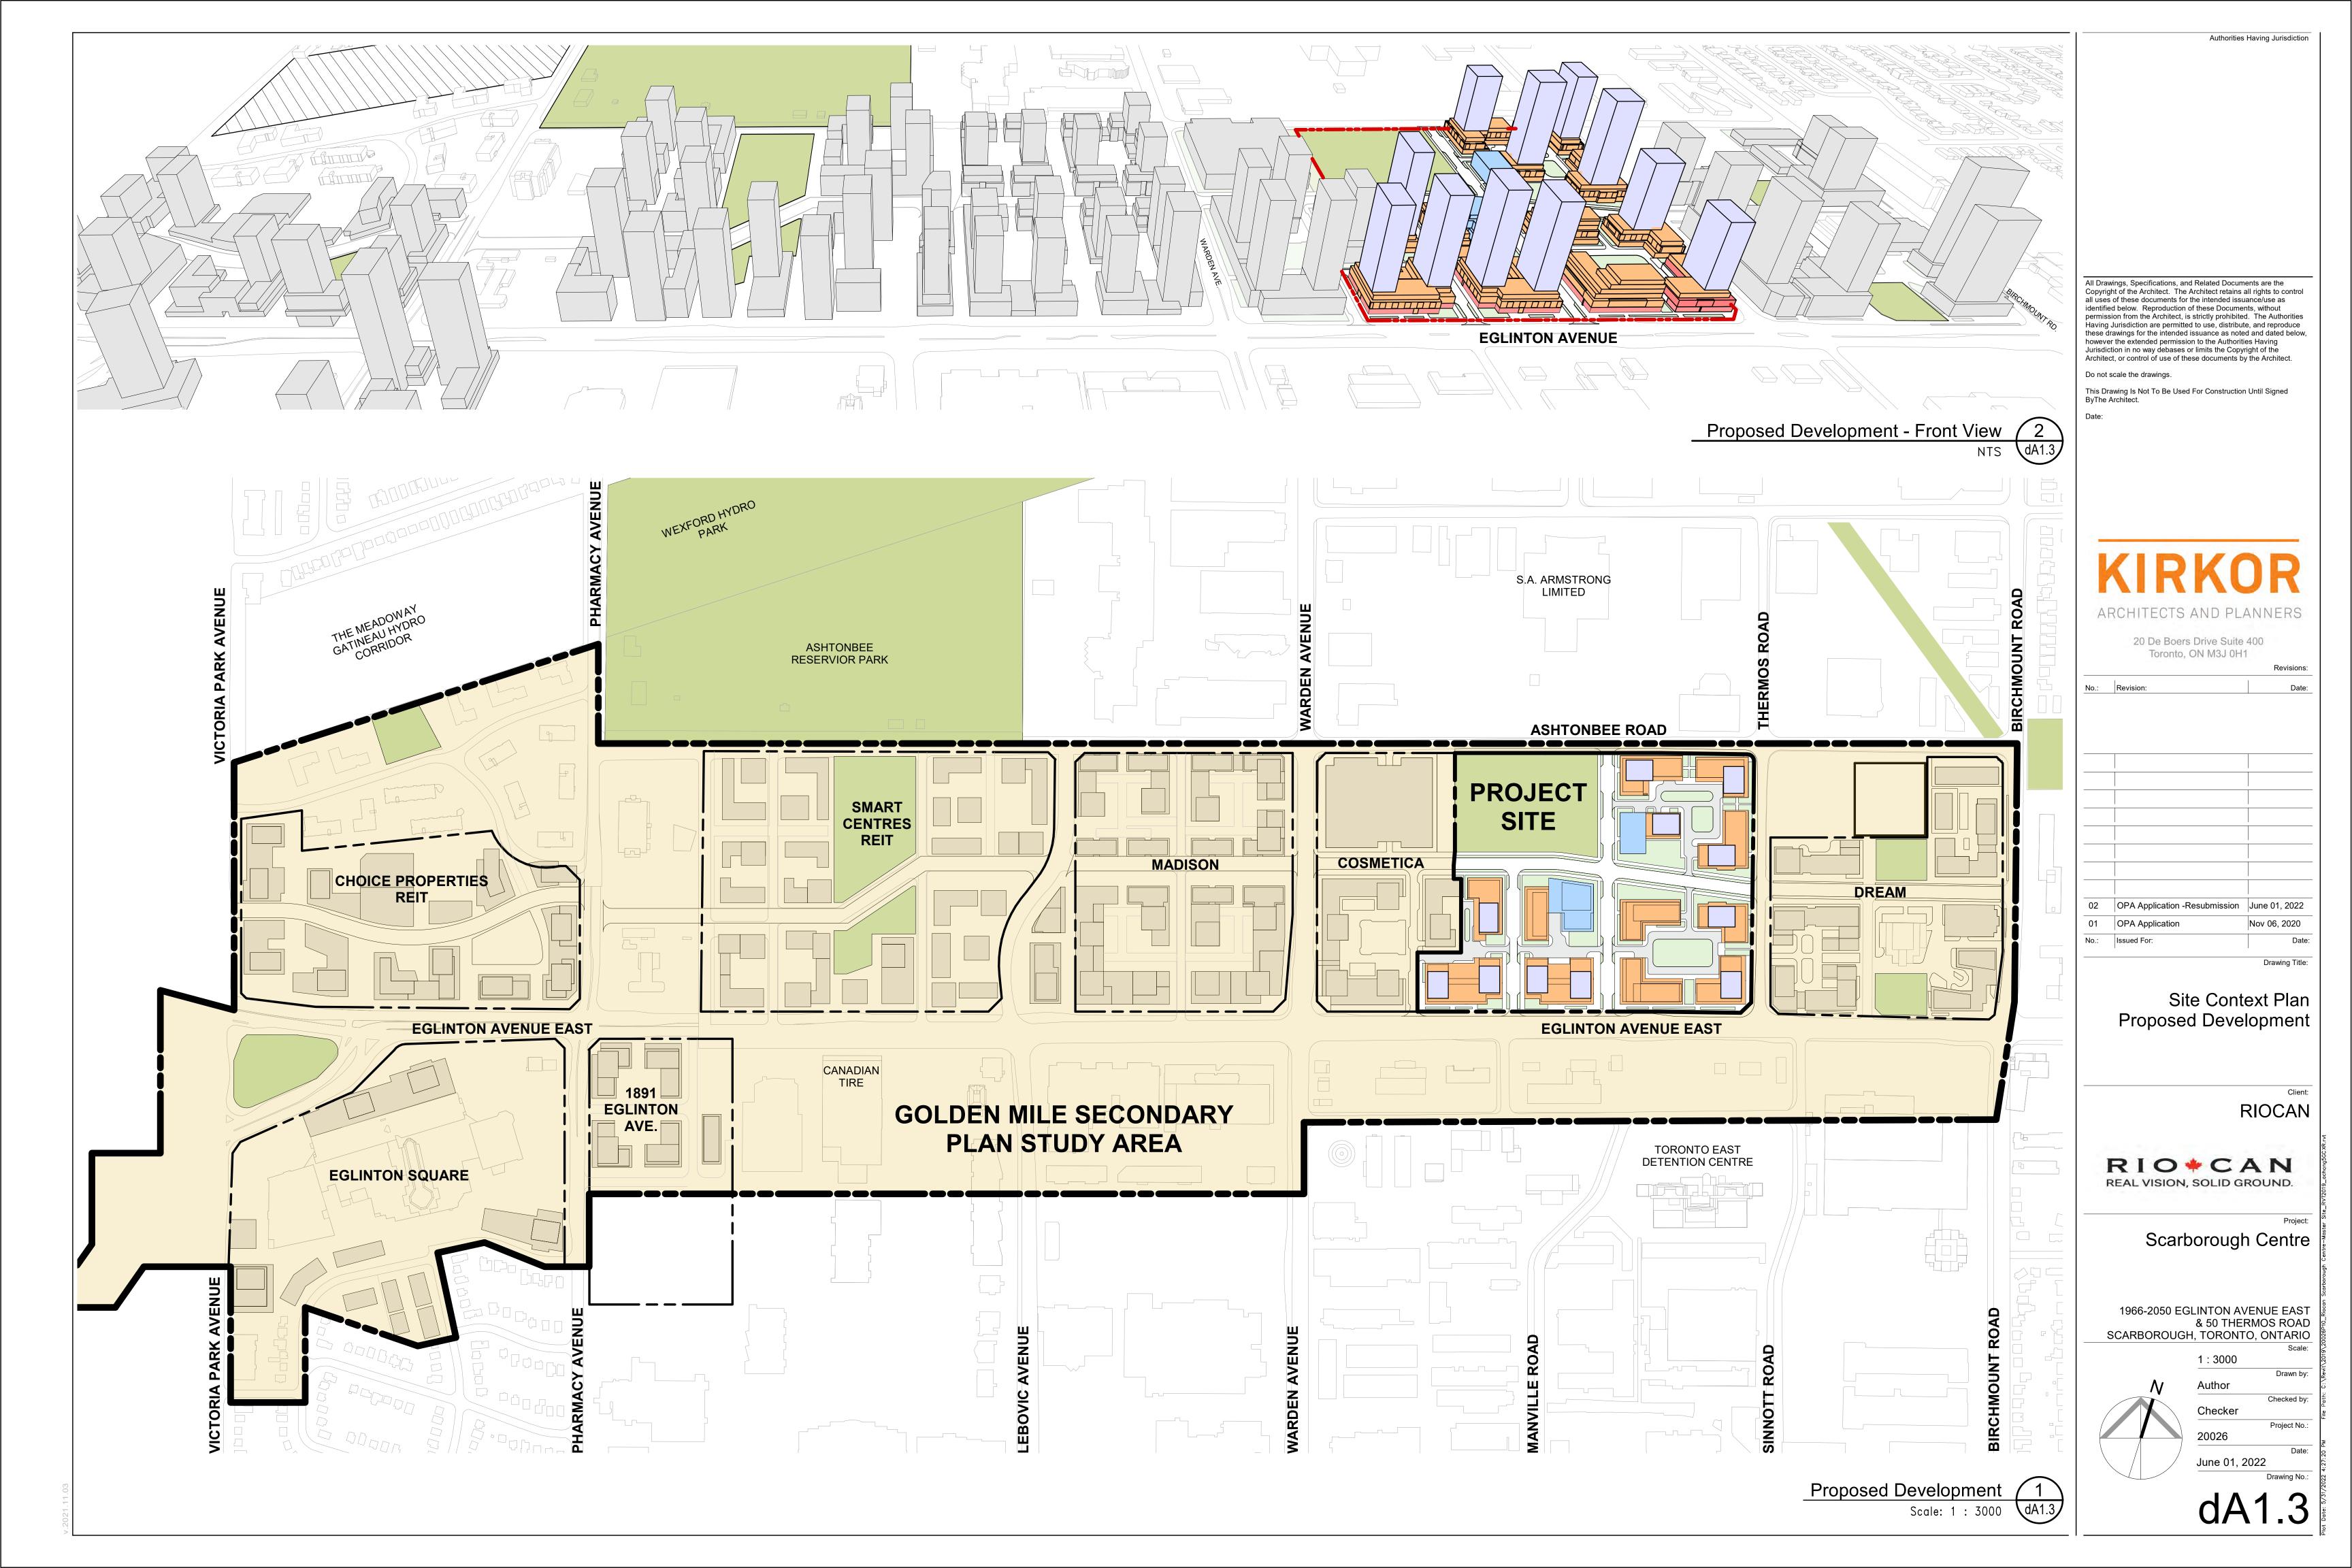



All Drawings, Specifications, and Related Documents are the Copyright of the Architect. The Architect retains all rights to control all uses of these documents for the intended issuance/use as identified below. Reproduction of these Documents, without permission from the Architect, is strictly prohibited. The Authorities Having Jurisdiction are permitted to use, distribute, and reproduce these drawings for the intended issuance as noted and dated below, however the extended permission to the Authorities Having Jurisdiction in no way debases or limits the Copyright of the

Authorities Having Jurisdiction

Do not scale the drawings. This Drawing Is Not To Be Used For Construction Until Signed

ByThe Architect.

ARCHITECTS AND PLANNERS

20 De Boers Drive Suite 400 Toronto, ON M3J 0H1

02 OPA Application -Resubmission June 01, 2022 OPA Application Nov 06, 2020 No.: Issued For:

> Block Structure & Project Statistics

> > RIOCAN

Drawing Title:


Revisions:

RIO+CAN


REAL VISION, SOLID GROUND.


Scarborough Centre

1966-2050 EGLINTON AVENUE EAST & 50 THERMOS ROAD SCARBOROUGH, TORONTO, ONTARIO

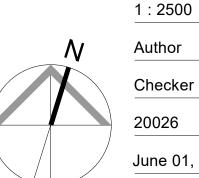


Drawn by: Author Checked by: Checker Project No. 20026 June 01, 2022

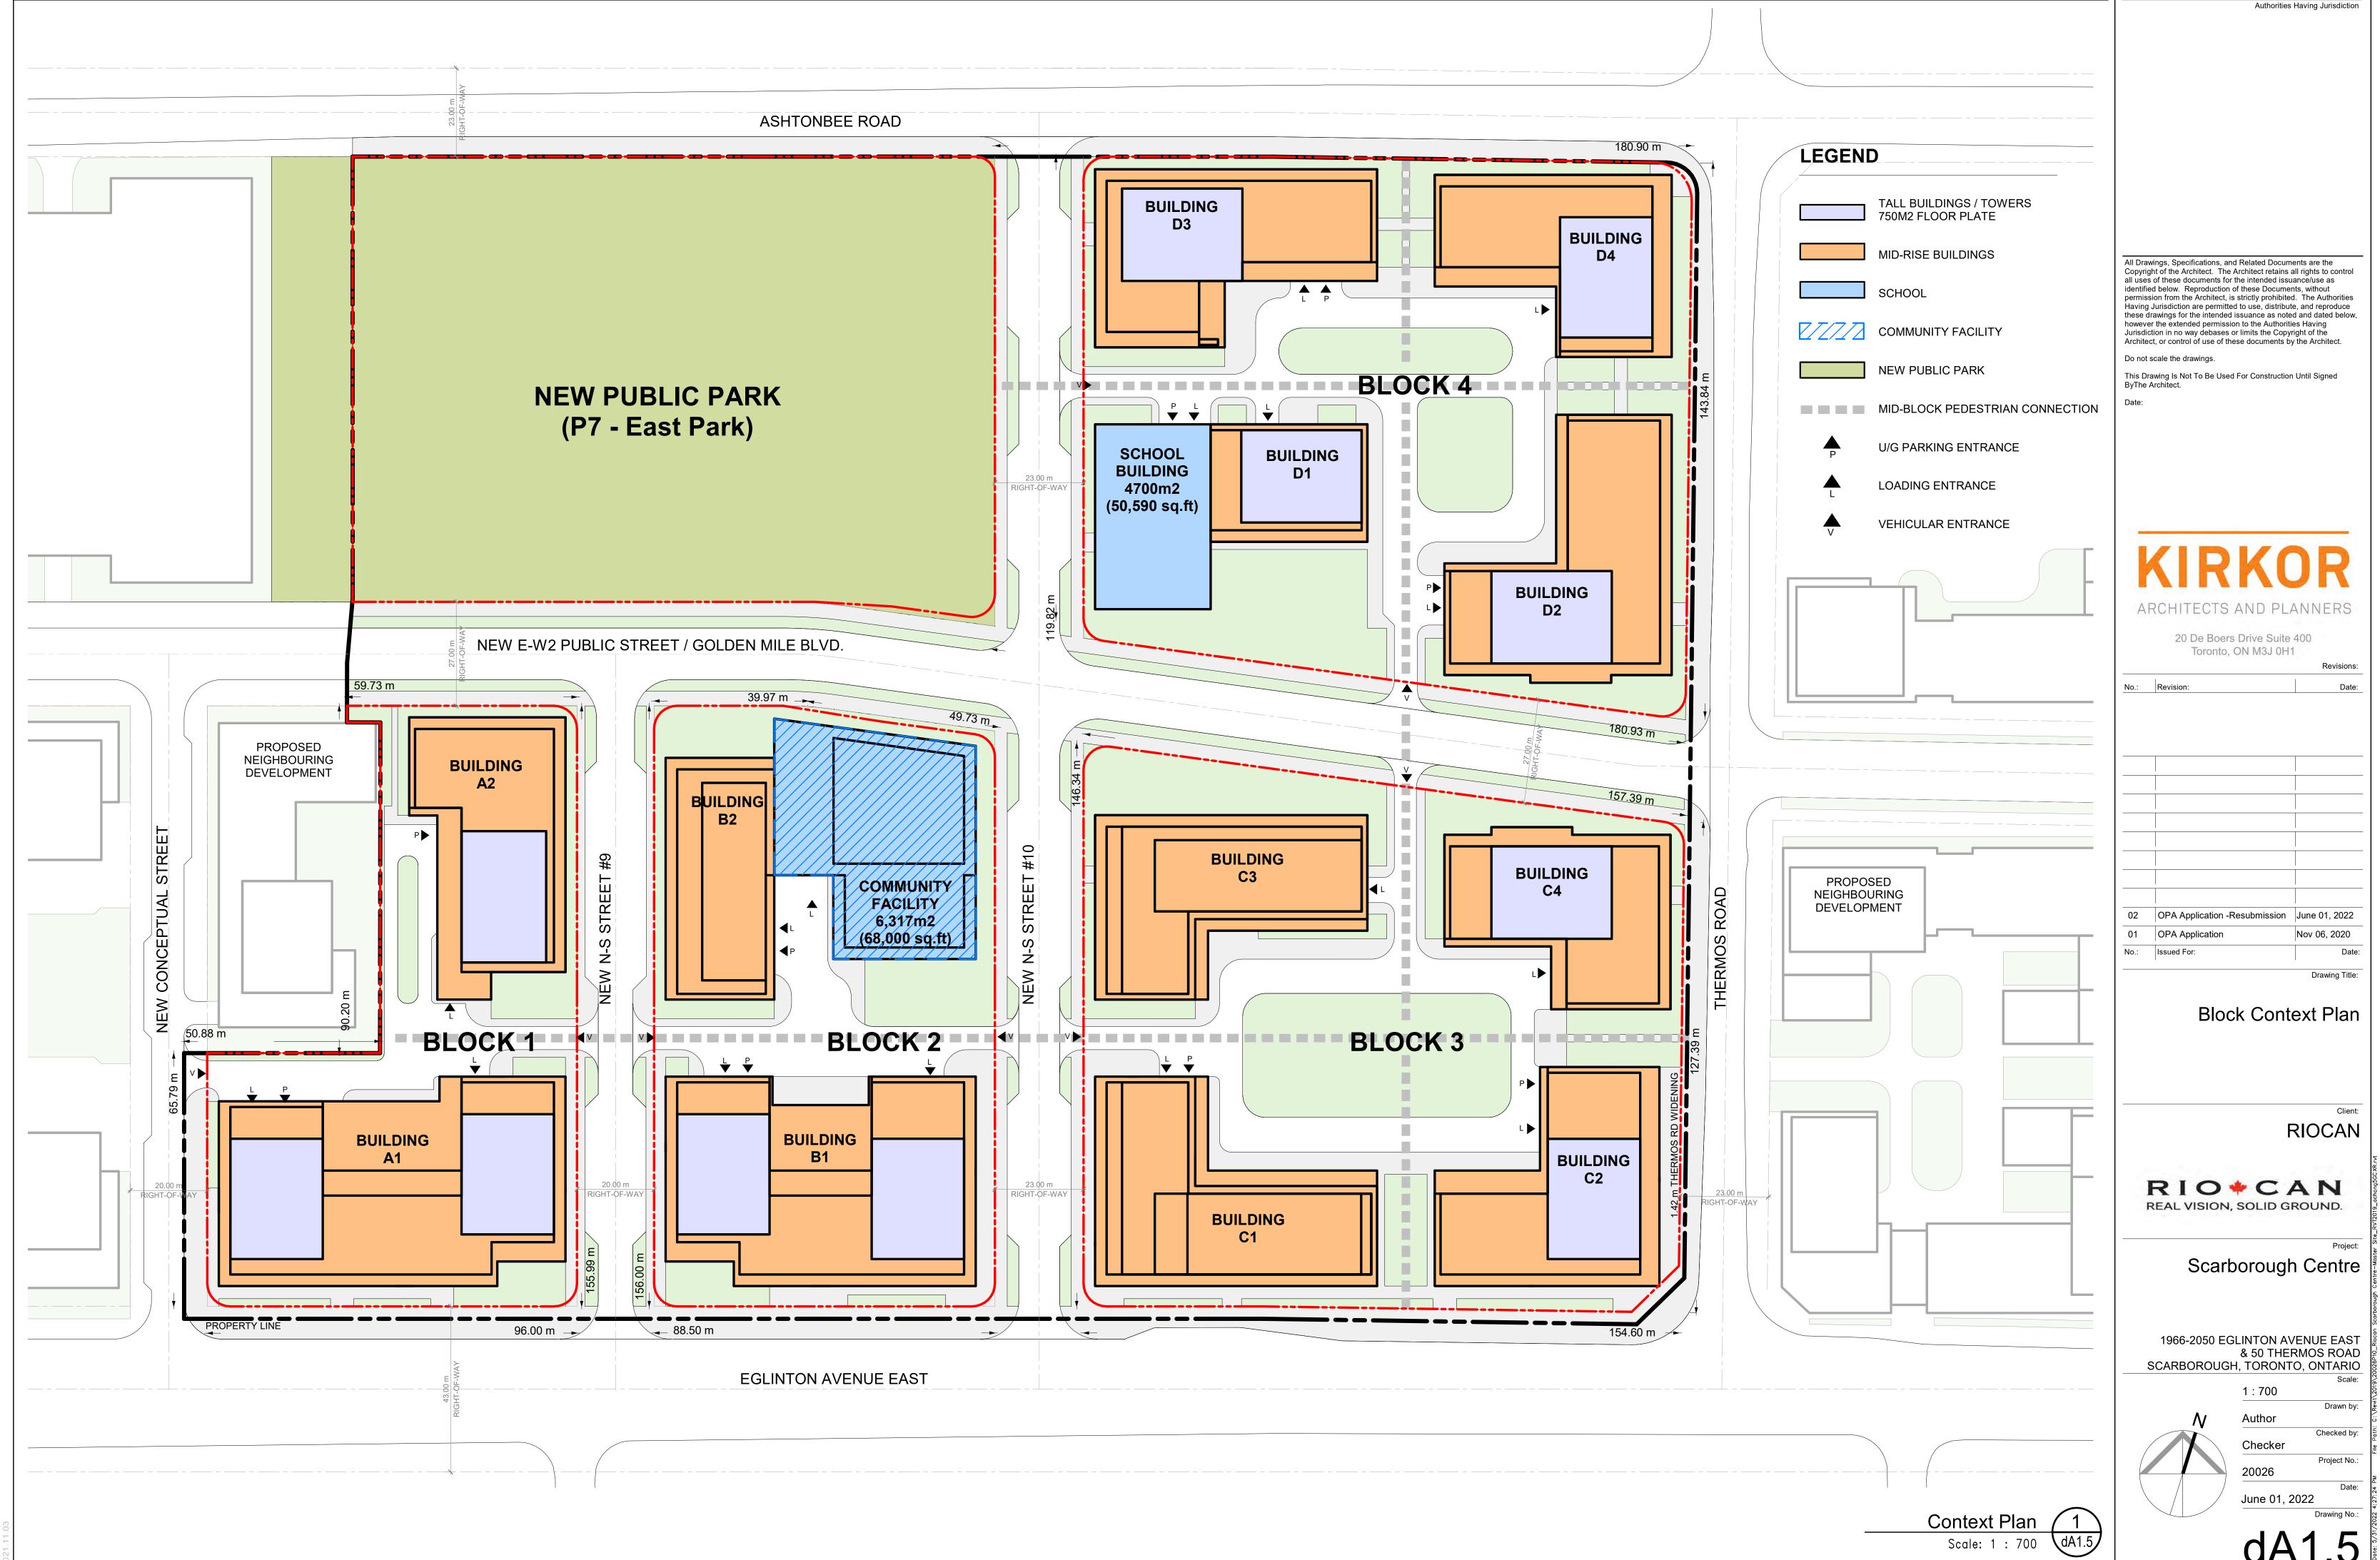

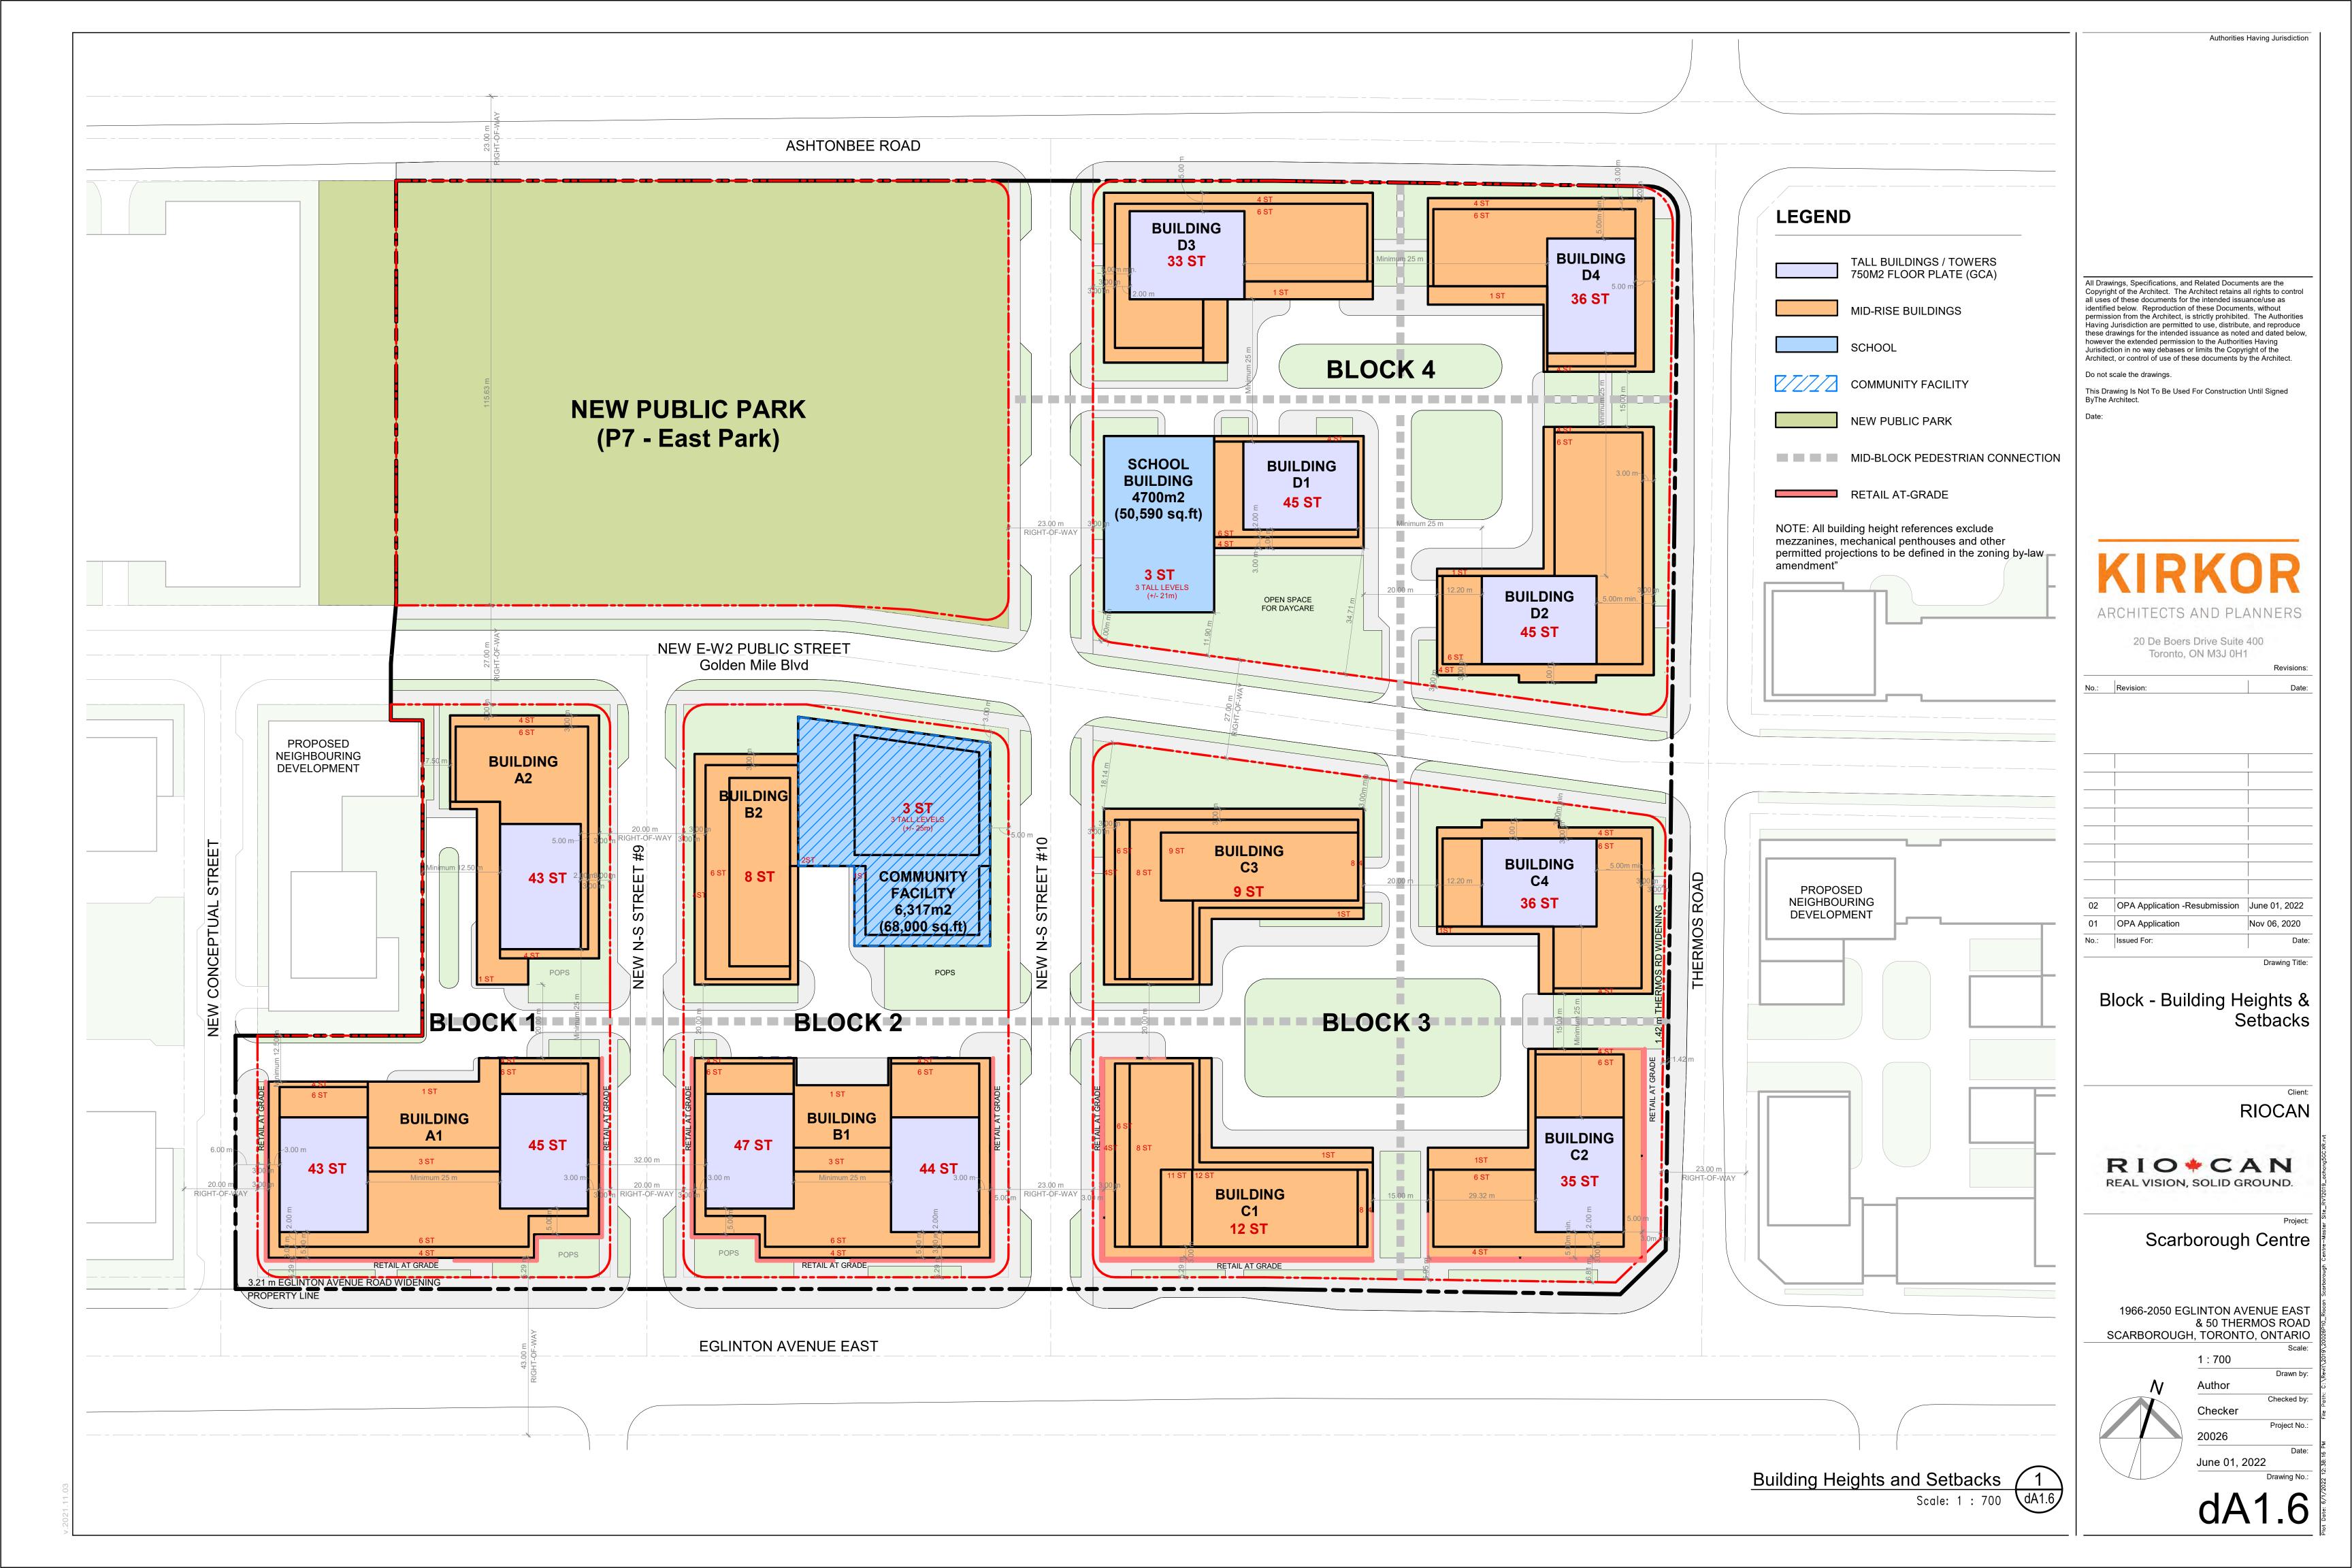

Authorities Having Jurisdiction

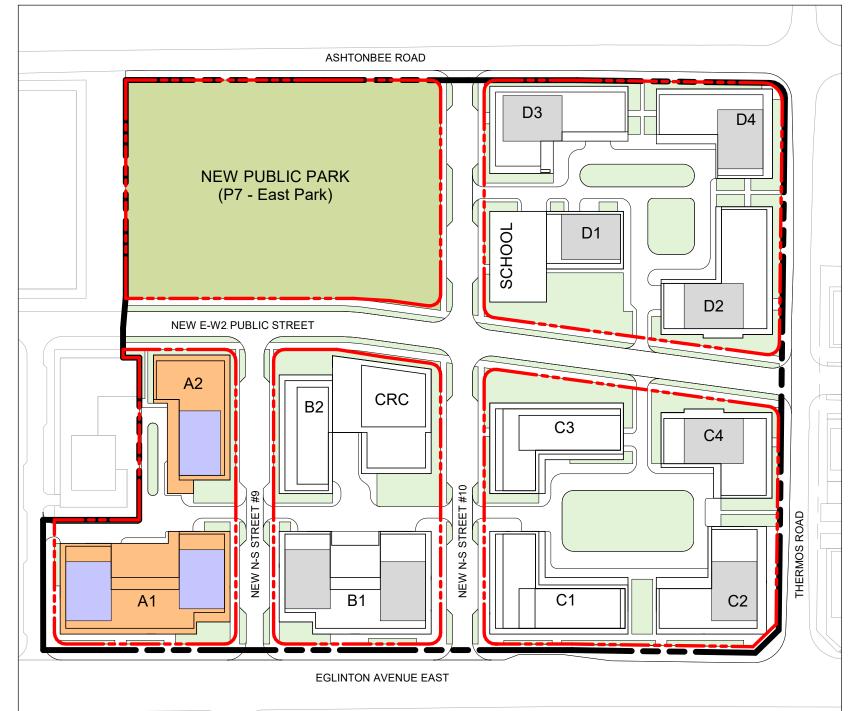

Key Plan 1
Scale: 1: 2000 dA2.2

10,940 m² 105,550 m²

1,971 m² 107,521 m²

9.82

1,379

TOWER MID-RISE PODIUM BASE BUILDING NON-RESIDENTIAL

NUMBER OF STOREY DO NOT INCLUDE MECHANICAL PENTHOUSE

All Drawings, Specifications, and Related Documents are the Copyright of the Architect. The Architect retains all rights to control all uses of these documents for the intended issuance/use as all uses of these documents for the intended issuance/use as identified below. Reproduction of these Documents, without permission from the Architect, is strictly prohibited. The Authorities Having Jurisdiction are permitted to use, distribute, and reproduce these drawings for the intended issuance as noted and dated below, however the extended permission to the Authorities Having Jurisdiction in no way debases or limits the Copyright of the Architect, or control of use of these documents by the Architect.

Authorities Having Jurisdiction

Do not scale the drawings.

This Drawing Is Not To Be Used For Construction Until Signed ByThe Architect.

ARCHITECTS AND PLANNERS

20 De Boers Drive Suite 400 Toronto, ON M3J 0H1

02 OPA Application -Resubmission June 01, 2022 01 OPA Application Nov 06, 2020

Axonometric - Block 1


RIOCAN

Drawing Title:

RIO+CAN REAL VISION, SOLID GROUND.

Scarborough Centre

1966-2050 EGLINTON AVENUE EAST & 50 THERMOS ROAD SCARBOROUGH, TORONTO, ONTARIO

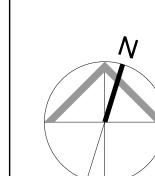

No.: Issued For:

As indicated Author Checked by: Checker 20026

All Drawings, Specifications, and Related Documents are the Copyright of the Architect. The Architect retains all rights to control all uses of these documents for the intended issuance/use as identified below. Reproduction of these Documents, without permission from the Architect, is strictly prohibited. The Authorities Having Jurisdiction are permitted to use, distribute, and reproduce these drawings for the intended issuance as noted and dated below, however the extended permission to the Authorities Having Jurisdiction in no way debases or limits the Copyright of the Architect, or control of use of these documents by the Architect.

Authorities Having Jurisdiction

Do not scale the drawings. This Drawing Is Not To Be Used For Construction Until Signed ByThe Architect.

ARCHITECTS AND PLANNERS

20 De Boers Drive Suite 400 Toronto, ON M3J 0H1

02 OPA Application -Resubmission June 01, 2022 01 OPA Application Nov 06, 2020 No.: Issued For:

Axonometric - Block 2


RIOCAN

Drawing Title:

RIO+CAN REAL VISION, SOLID GROUND.


Scarborough Centre

1966-2050 EGLINTON AVENUE EAST & 50 THERMOS ROAD SCARBOROUGH, TORONTO, ONTARIO As indicated

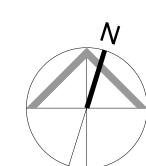

NUMBER OF STOREY DO NOT INCLUDE MECHANICAL PENTHOUSE

Author Checked by: Checker 20026

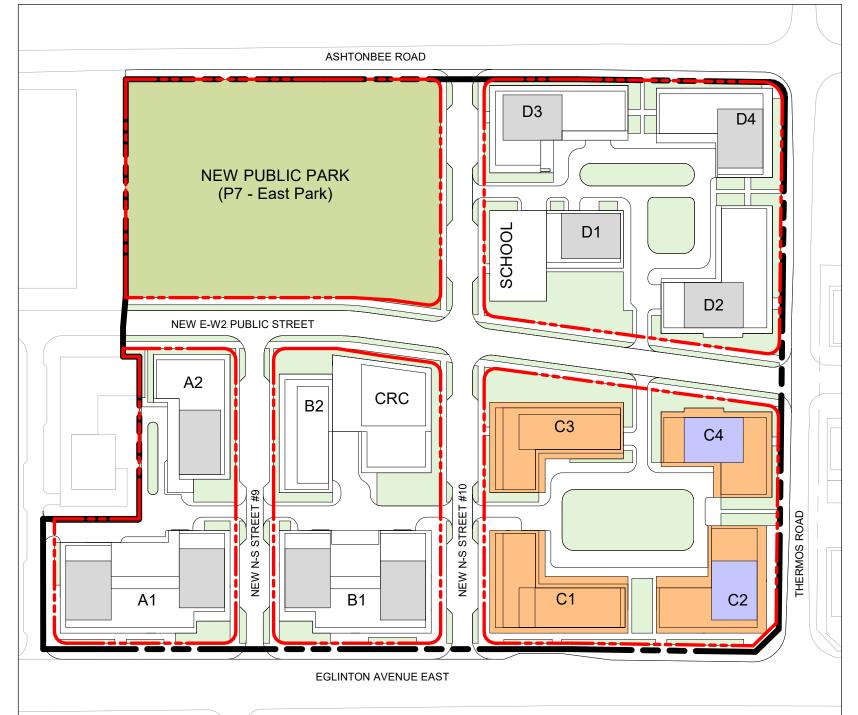

BLOCK-3

STATISTICS

21,087 m² 1. SITE AREA

2. RESIDENTIAL GFA 79,267 m² COMMERCIAL GFA 10,954 m² TOTAL BUILDING GFA 90,221 m²

3. FSI 4.28

1,206 4. UNIT COUNT

LEGEND

TOWER MID-RISE PODIUM BASE BUILDING NON-RESIDENTIAL

NOTE

NUMBER OF STOREY DO NOT INCLUDE MECHANICAL PENTHOUSE

All Drawings, Specifications, and Related Documents are the Copyright of the Architect. The Architect retains all rights to control all uses of these documents for the intended issuance/use as identified below. Reproduction of these Documents, without permission from the Architect, is strictly prohibited. The Authorities Having Jurisdiction are permitted to use, distribute, and reproduce these drawings for the intended issuance as noted and dated below, however the extended permission to the Authorities Having Jurisdiction in no way debases or limits the Copyright of the Architect, or control of use of these documents by the Architect.

Authorities Having Jurisdiction

Do not scale the drawings.

This Drawing Is Not To Be Used For Construction Until Signed ByThe Architect.

ARCHITECTS AND PLANNERS

20 De Boers Drive Suite 400 Toronto, ON M3J 0H1

02 OPA Application -Resubmission June 01, 2022

01 OPA Application

No.: Issued For:

Axonometric - Block 3

RIOCAN

Nov 06, 2020


Drawing Title:

RIO+CAN REAL VISION, SOLID GROUND.

Scarborough Centre

1966-2050 EGLINTON AVENUE EAST & 50 THERMOS ROAD SCARBOROUGH, TORONTO, ONTARIO

As indicated Author Checked by: Checker 20026

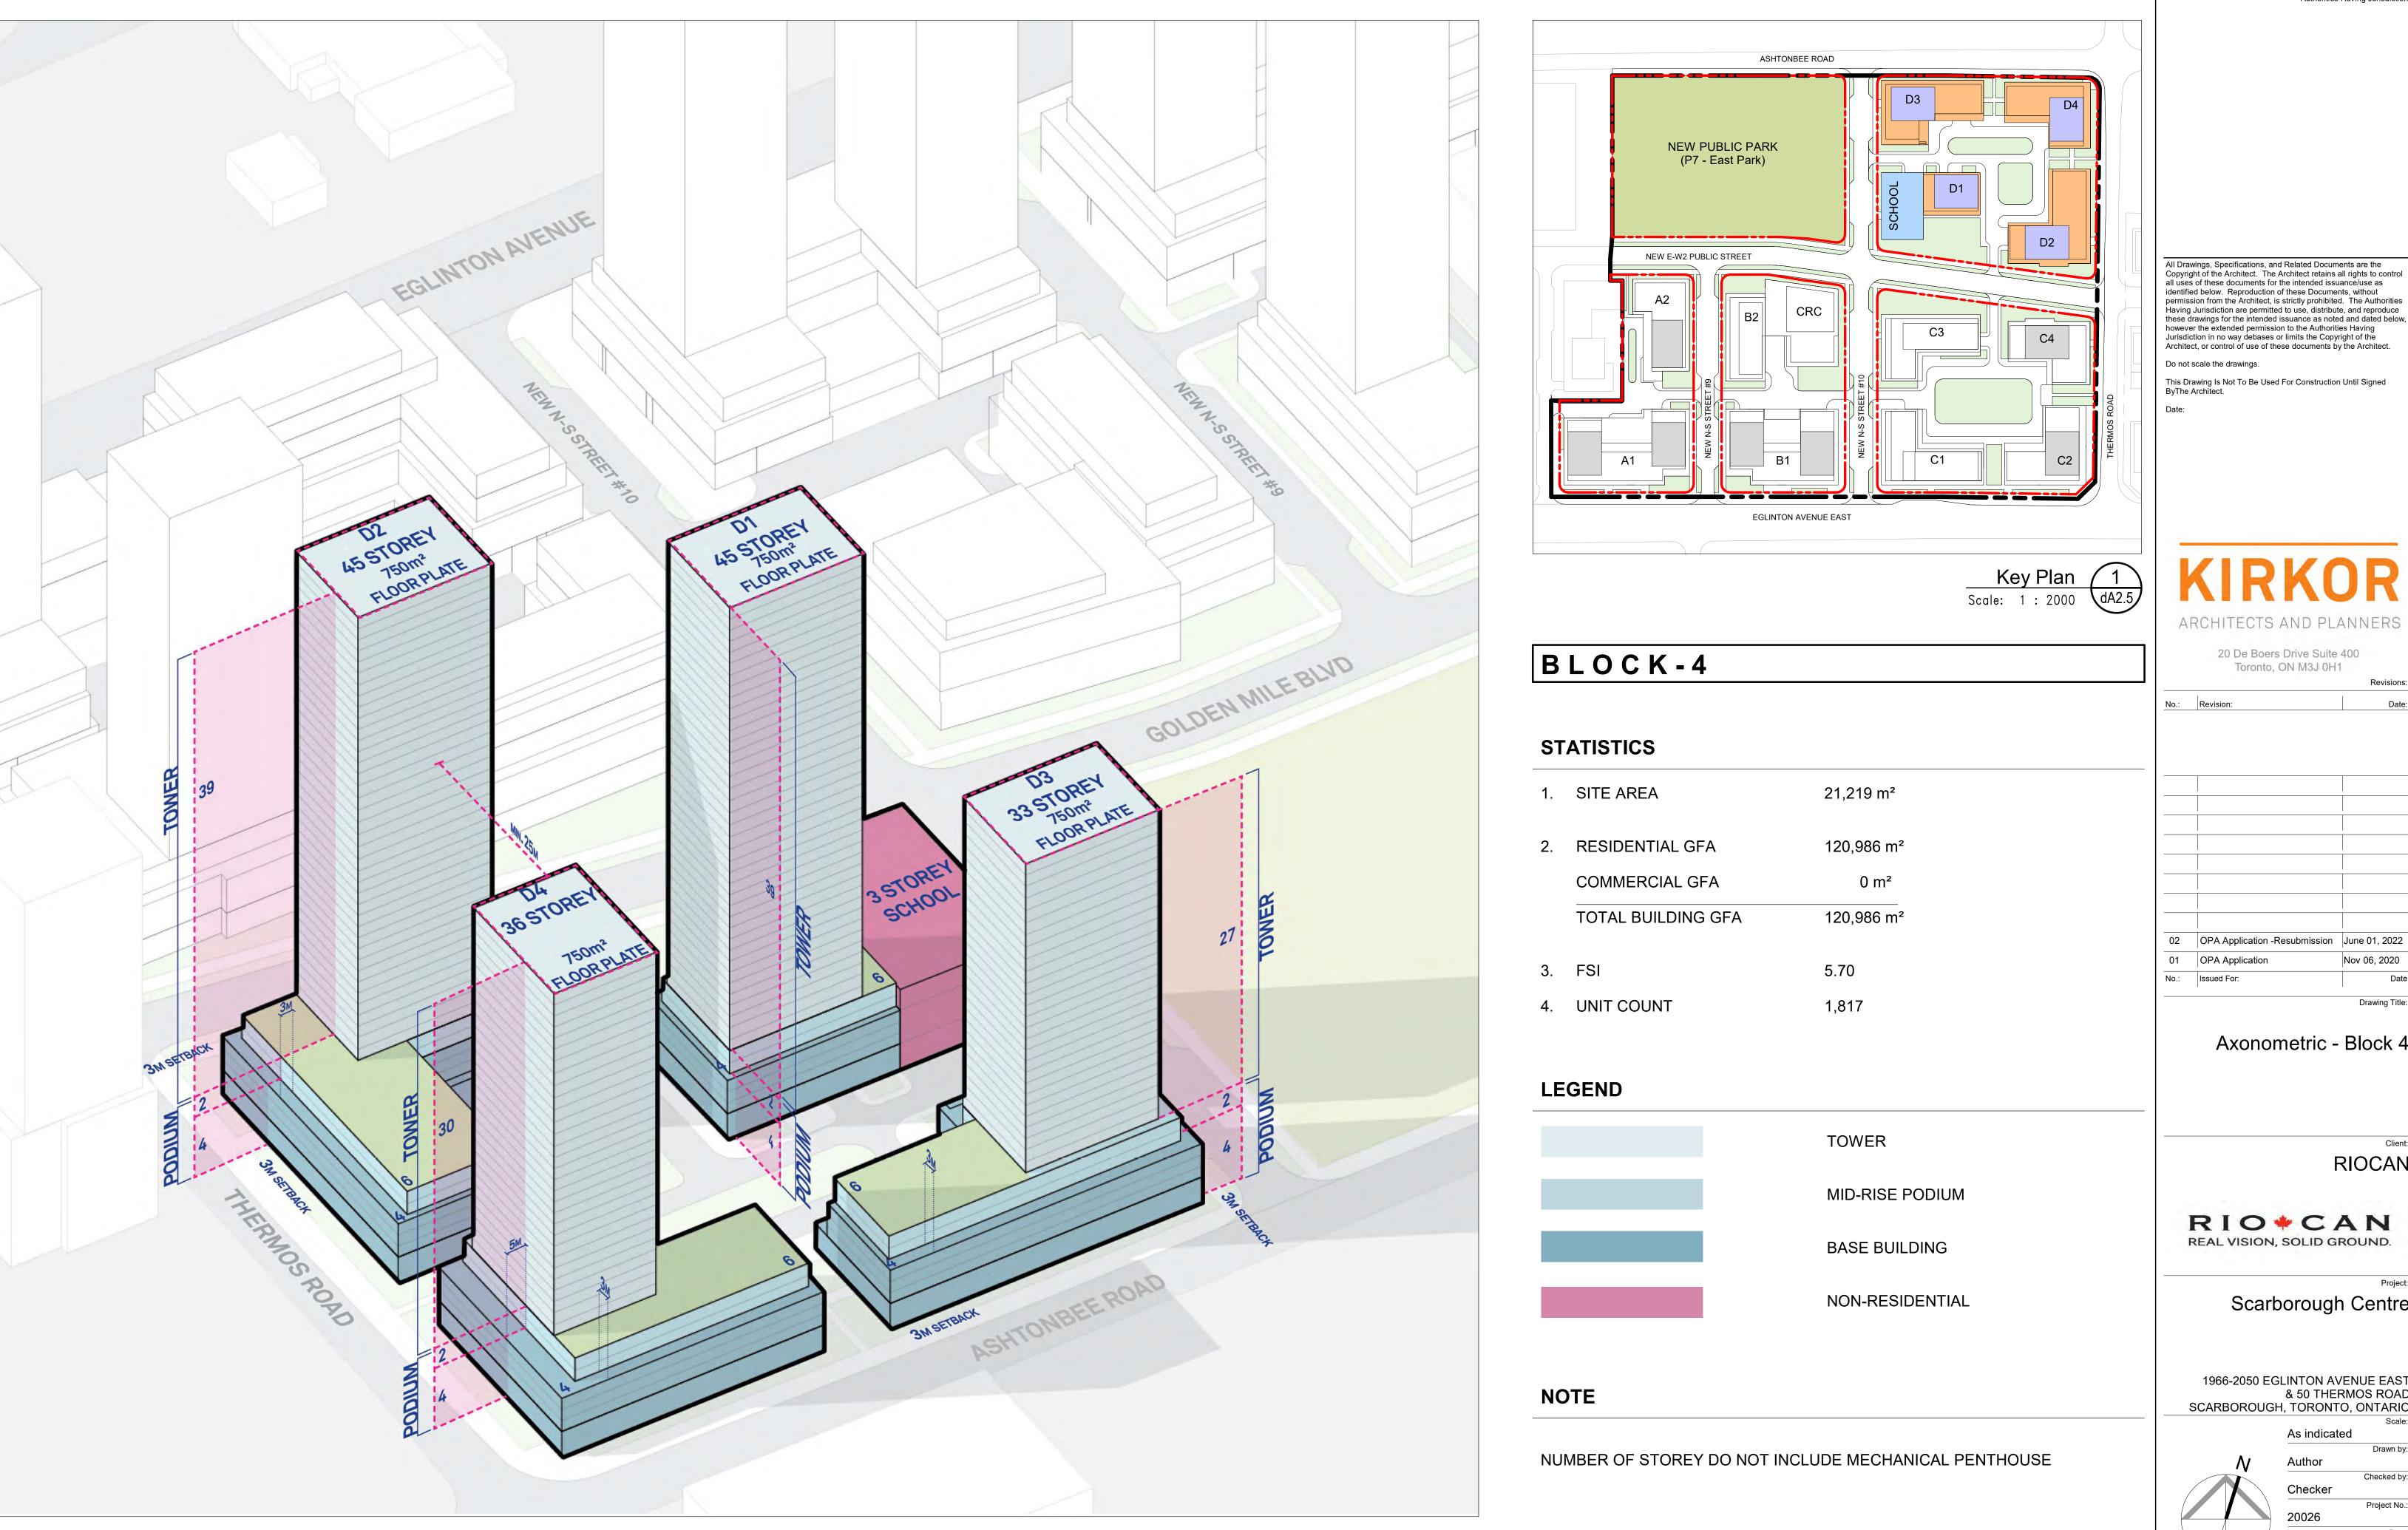

All Drawings, Specifications, and Related Documents are the Copyright of the Architect. The Architect retains all rights to control all uses of these documents for the intended issuance/use as identified below. Reproduction of these Documents, without permission from the Architect, is strictly prohibited. The Authorities Having Jurisdiction are permitted to use, distribute, and reproduce these drawings for the intended issuance as noted and dated below, however the extended permission to the Authorities Having Jurisdiction in no way debases or limits the Copyright of the Architect, or control of use of these documents by the Architect.

Authorities Having Jurisdiction

Do not scale the drawings.

This Drawing Is Not To Be Used For Construction Until Signed ByThe Architect.

20 De Boers Drive Suite 400 Toronto, ON M3J 0H1

Drawing Title:

Axonometric - Block 4

RIOCAN

Nov 06, 2020


RIO+CAN


REAL VISION, SOLID GROUND.


Scarborough Centre

1966-2050 EGLINTON AVENUE EAST & 50 THERMOS ROAD SCARBOROUGH, TORONTO, ONTARIO

As indicated Author Checked by: Checker 20026

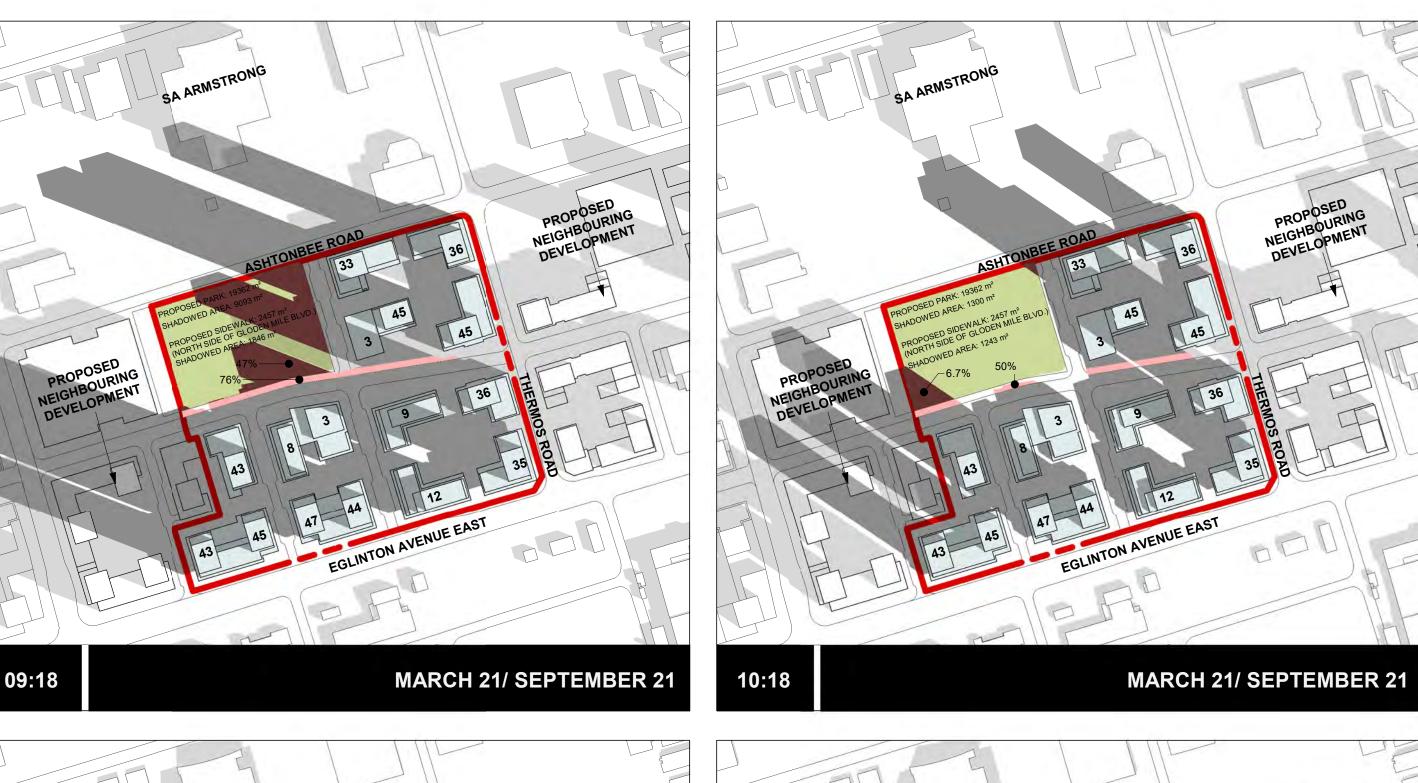

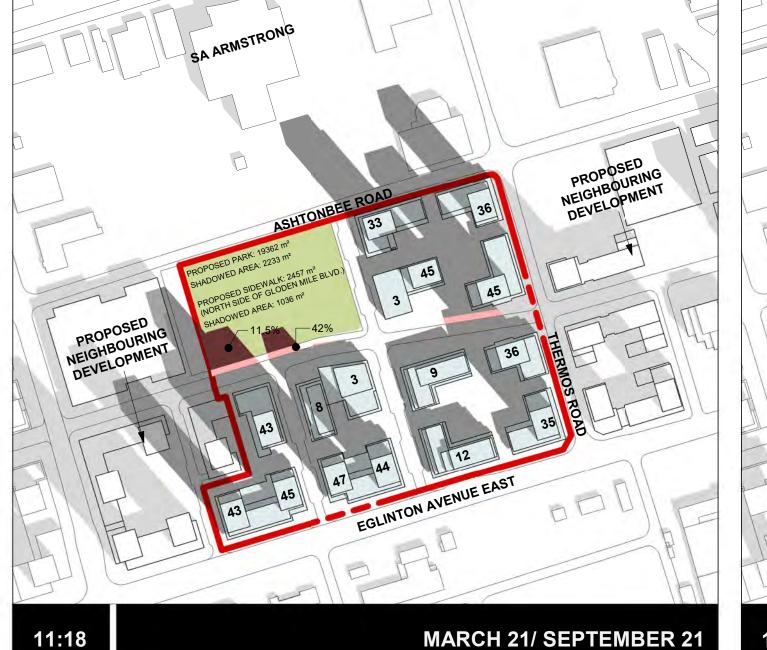

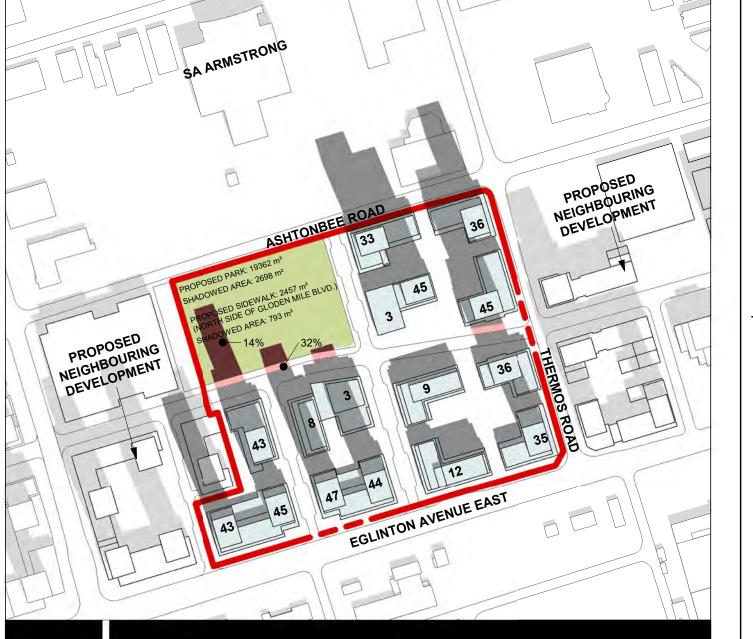


MARCH 21/ SEPTEMBER 21

All Drawings, Specifications, and Related Documents are the Copyright of the Architect. The Architect retains all rights to control all uses of these documents for the intended issuance/use as identified below. Reproduction of these Documents, without permission from the Architect, is strictly prohibited. The Authorities Having Jurisdiction are permitted to use, distribute, and reproduce these drawings for the intended issuance as noted and dated below, however the extended permission to the Authorities Having Jurisdiction in no way debases or limits the Copyright of the Architect, or control of use of these documents by the Architect.

This Drawing Is Not To Be Used For Construction Until Signed ByThe Architect.

ARCHITECTS AND PLANNERS


20 De Boers Drive Suite 400 Toronto, ON M3J 0H1

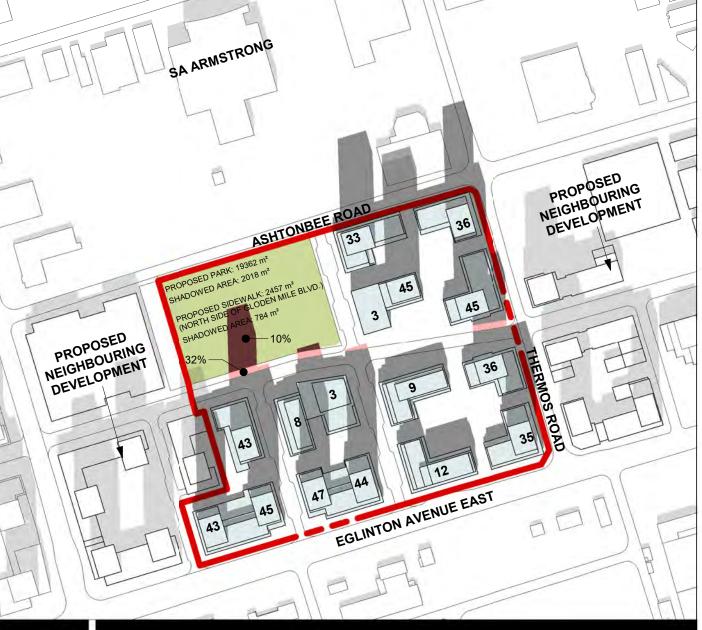


MARCH 21/ SEPTEMBER 21

MARCH 21/ SEPTEMBER 21

PROPOSED NAME, 1982 PARAMENTONE PROPOSED NEIGHBOURING NEI

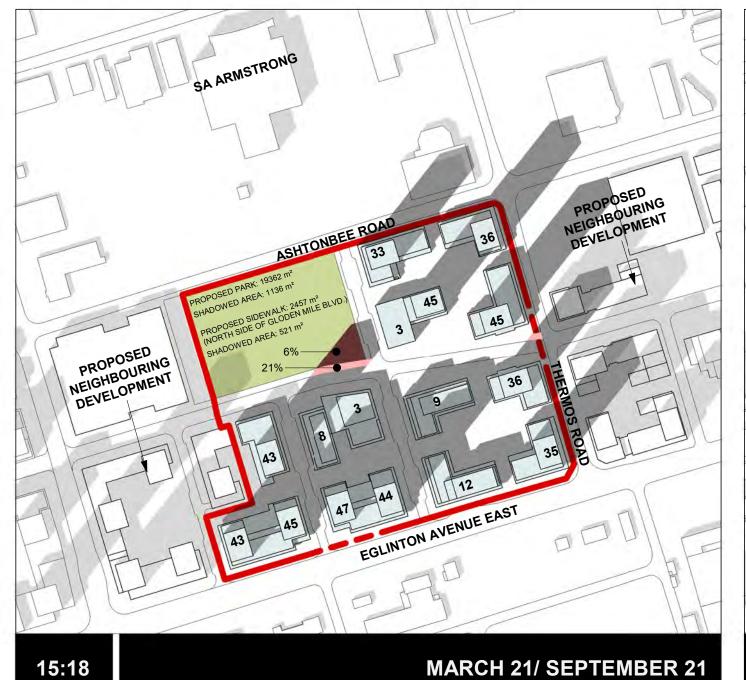

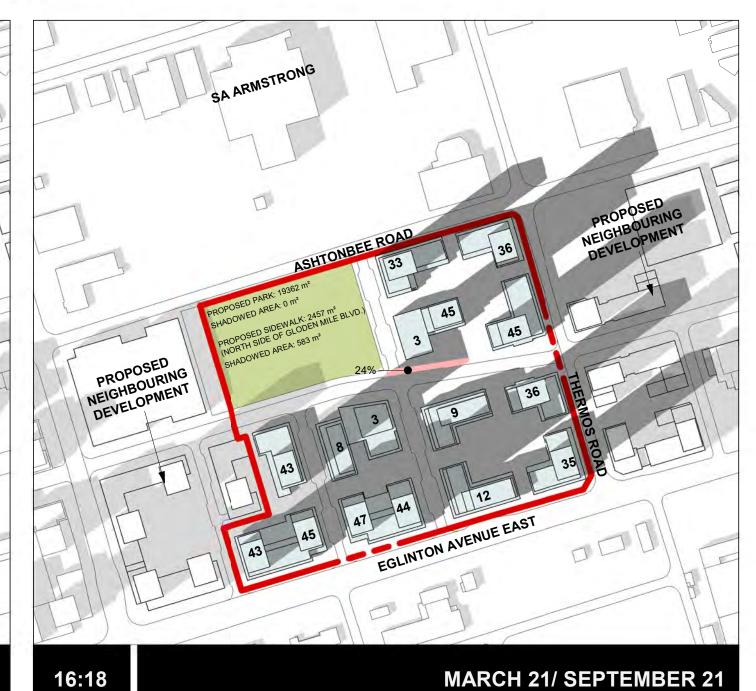

Block - Sun Shadow Study (March / September)

02 OPA Application -Resubmission June 01, 2022

No.: Issued For:

Nov 06, 2020

RIOCAN

Drawing Title:

RIO * CAN
REAL VISION, SOLID GROUND.

Scarborough Centre

1966-2050 EGLINTON AVENUE EAST & 50 THERMOS ROAD SCARBOROUGH, TORONTO, ONTARIO

As indicated

N

Author

Checked by

Checker


Project No.

20026

Date

June 01, 2022

dA3.

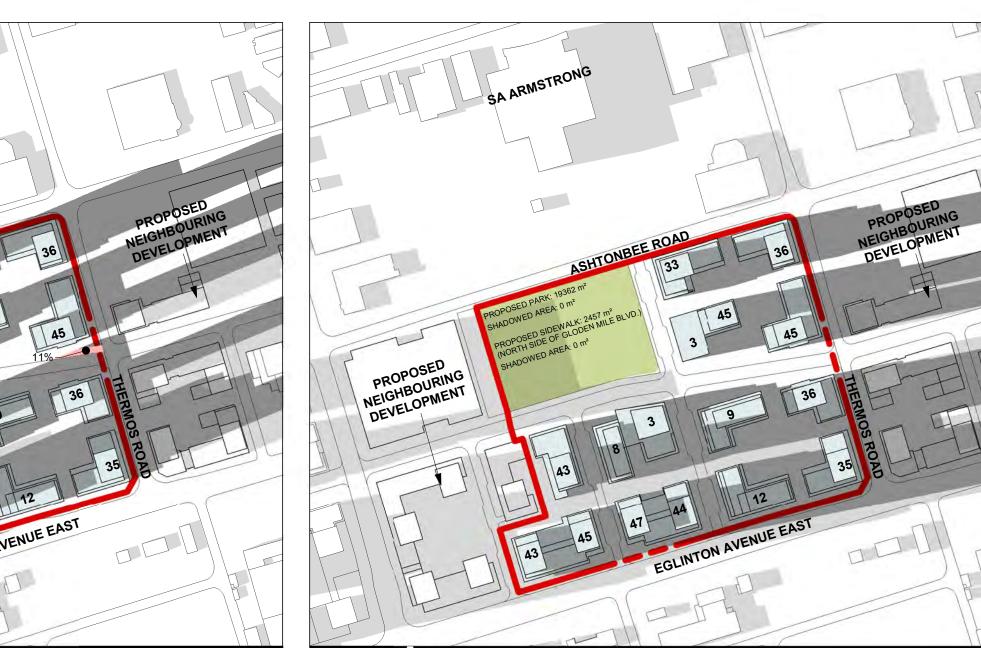

18:18

NOTES

MARCH 21/ SEPTEMBER 21

REQUIRED: PROPOSED DEVELOPMENT TO ACHIEVE A MINIMUM OF 5 CONSECUTIVE HOURS OF SUNLIGHT BETWEEN 9:18 A.M. TO 4:18 P.M. ON A MINIMUM 75% OF PROPOSED NEW PARK AREA BETWEEN MARCH 21ST AND SEPTEMBER 21ST.

▼ PROPOSED DEVELOPMENT ACHIEVES
REQUIRED CONSECUTIVE HOURS OF SUNLIGHT
BETWEEN 9:18 A.M TO 4:18 P.M.ON A MINIMUM
OF 75% OF PROPOSED NEW PARK AREA

REQUIRED: PROPOSED DEVELOPMENT TO ACHIEVE A MINIMUM OF 5-7 CONSECUTIVE HOURS OF SUNLIGHT BETWEEN 9:18 A.M. TO 4:18 P.M. ON A MINIMUM 50% OF THE SIDEWALK ON THE NORTH SIDE OF EASTWEST STREET #2 (GOLDEN MILE BLVD) BETWEEN MARCH 21ST AND SEPTEMBER 21ST.

✔ PROPOSED DEVELOPMENT ACHIEVES REQUIRED CONSECUTIVE HOURS OF SUNLIGHT BETWEEN 9:18 A.M. TO 4:18 P.M. ON A MINIMUM 50% OF THE SIDEWALK ON THE NORTH SIDE OF EAST-WEST STREET #2 (GOLDEN MILE BLVD)

LEGEND

PROPOSED SHADOW ON PARK

PROPOSED SHADOW ON SIDEWALK
(SIDEWALK ON NORTH SIDE OF EW ST. #2/GOLDEN MILE BLVD.)

BUILDING

PROPOSED PARK

RIOCAN SITE

JUNE 21 JUNE 21

> **REQUIRED:** PROPOSED DEVELOPMENT TO ACHIEVE A MINIMUM OF 5 CONSECUTIVE HOURS OF SUNLIGHT BETWEEN 9:18 A.M. TO 4:18 P.M. ON A MINIMUM 75% OF PROPOSED NEW PARK AREA BETWEEN MARCH

✓ PROPOSED DEVELOPMENT ACHIEVES REQUIRED CONSECUTIVE HOURS OF SUNLIGHT BETWEEN 9:18 A.M TO 4:18 P.M.ON A MINIMUM OF 75% OF PROPOSED NEW PARK AREA

A MINIMUM OF 5-7 CONSECUTIVE HOURS OF SUNLIGHT BETWEEN 9:18 A.M. TO 4:18 P.M. ON A MINIMUM 50% OF THE SIDEWALK ON THE NORTH SIDE OF EAST-WEST STREET #2 (GOLDEN MILE BLVD) BETWEEN MARCH 21ST AND SEPTEMBER 21ST.

EAST-WEST STREET #2 (GOLDEN MILE BLVD)

CONTEXT SHADOW PROPOSED SHADOW PROPOSED SHADOW ON PARK PROPOSED SHADOW ON SIDEWALK (SIDEWALK ON NORTH SIDE OF EW ST. #2/GOLDEN MILE BLVD.) BUILDING PROPOSED PARK

RIOCAN SITE

RIOCAN

RIO+CAN REAL VISION, SOLID GROUND.

Scarborough Centre

As indicated

1966-2050 EGLINTON AVENUE EAST & 50 THERMOS ROAD SCARBOROUGH, TORONTO, ONTARIO

Author Checker 20026 June 01, 2022




JUNE 21

JUNE 21

21ST AND SEPTEMBER 21ST.

REQUIRED: PROPOSED DEVELOPMENT TO ACHIEVE

✔ PROPOSED DEVELOPMENT ACHIEVES REQUIRED CONSECUTIVE HOURS OF SUNLIGHT BETWEEN 9:18 A.M. TO 4:18 P.M. ON A MINIMUM 50% OF THE SIDEWALK ON THE NORTH SIDE OF

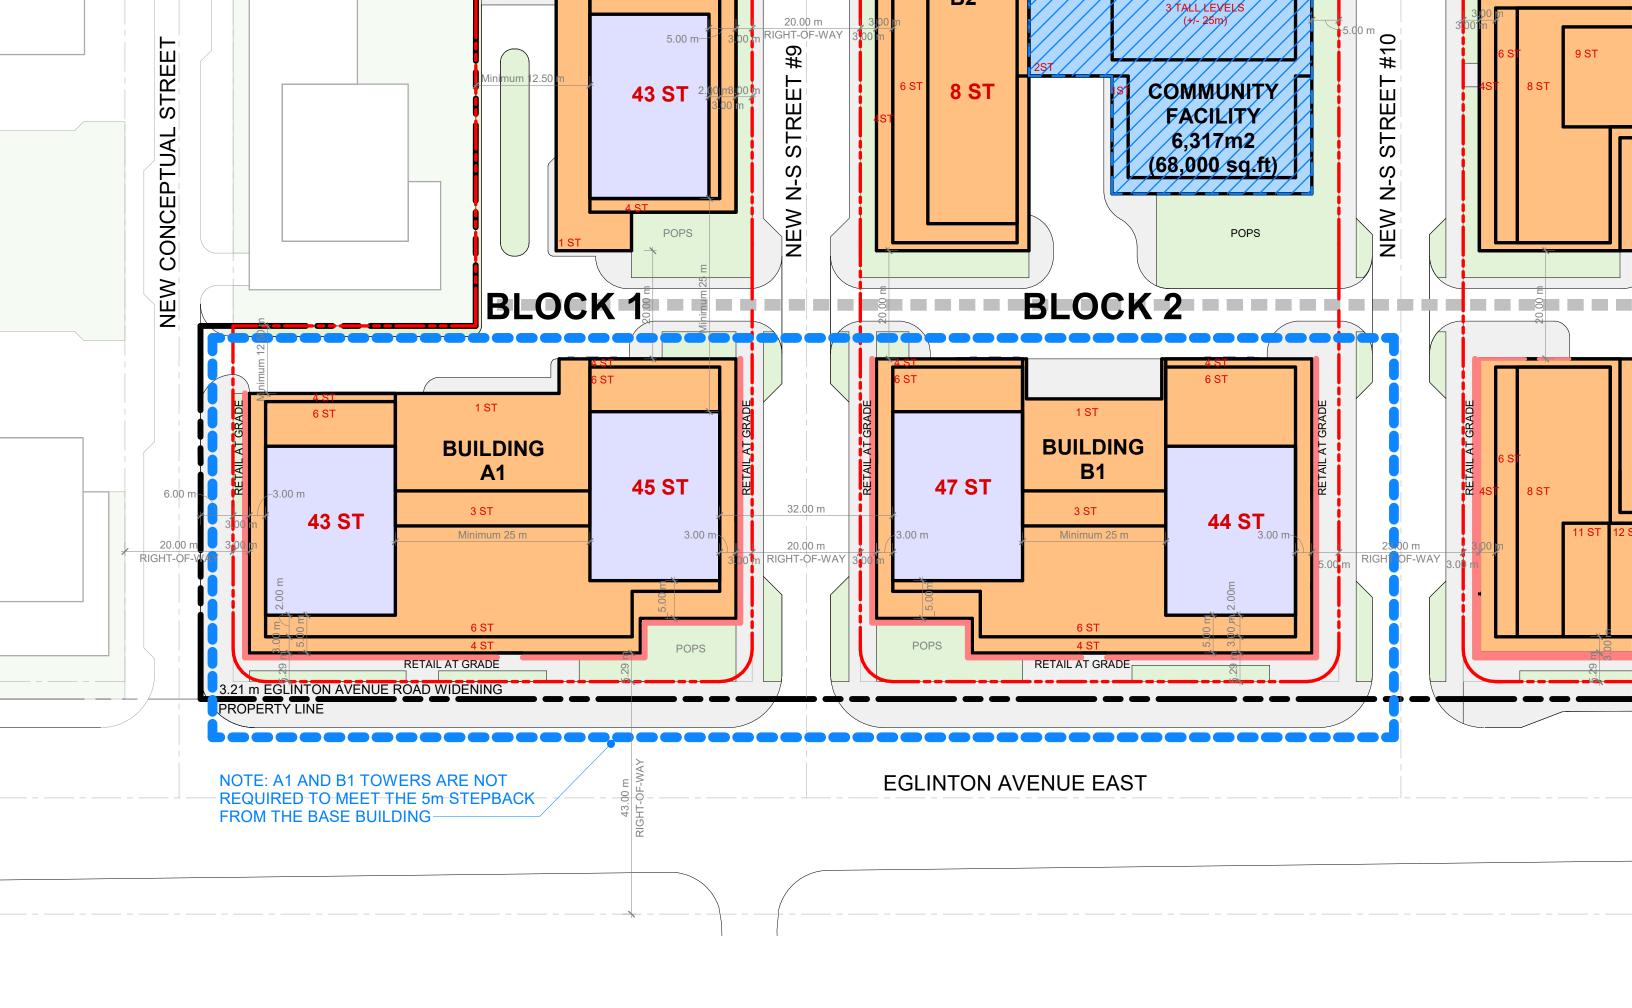



June 1, 2022

Dan Fama
Director, Development
RioCan Management Inc.
2300 Yonge Street, Suite 500
Toronto, ON M4P 1E4

Fax: (416) 866-3020

RE: 1980 Eglinton Avenue East – Phase 1 Transportation Demand Management Measures

Dear Mr. Fama:

BA Group was retained by 2076031 Ontario Limited (RioCan) to provide transportation consulting services to the proposed redevelopment of the lands municipally known as 1966-1980 Eglinton Avenue East in the City of Toronto (herein referred to as "the site"), located midblock between Warden Avenue and Thermos Road, and bounded by Ashtonbee Road and Eglinton Avenue East. The lands represent Phase 1 of the redevelopment of the broader RioCan lands at this location.

An Official Plan Amendment (OPA) application was made to the City in November 2015 for the broader RioCan lands located west of Thermos Road, between Ashtonbee Road and Eglinton Avenue East. A revised OPA application was submitted in November 2020. A Zoning By-law Amendment (ZBA) application was submitted specifically for the Phase 1 lands in July 2021.

Since the July 2021 ZBA submission for the Phase 1 lands, it is our understanding that there is a desire to further elaborate on the Transportation Demand Management (TDM) strategy proposed for the site in the July 2021 submission.

This letter provides additional details for the proposed TDM measures for the site.

1.0 PROPOSED DEVELOPMENT (JULY 2021 SUBMISSION)

The proposed development as per the July 2021 submission, includes the demolition of the existing retail buildings and related surface parking, and the construction of 4 new buildings with 2,434 residential units and 3,658 m² GFA of retail.

The development proposal also includes a new public park located on the north portion of the site and bordered by Golden Mile Boulevard, NS8, Ashtonbee Road and NS10. Vehicle parking for the 4 new buildings will be provided in below-grade parking facilities, which will be accessed from the internal driveways connected to the proposed new streets.

2.0 TRANSPORTATION DEMAND MANAGEMENT (TDM) PLAN

TDM measures and design elements will be incorporated into all aspects of the development proposal for the site to minimize the need for automobile travel, while encouraging and facilitating the use of non-automobile travel modes on a day-to-day basis.

The strategies included within the TDM Plan build upon the broader mobility planning inherent within the GMSP transportation plans, and include physical infrastructure based components and operational level initiatives that promote the use of sustainable non-auto modes of transportation, and are tailored to the mobility needs of the future residents, employees and retail patrons in the area.

The implementation of the strategies within the TDM Plan will be critical to managing the travel demands expected to be generated by the site.

The TDM Plan seeks to:

- Mitigate the impact of the site travel demand on the area transportation network;
- Reduce car ownership and single-occupant vehicle usage by site residents, employees and visitors;
- Manage and reduce the vehicle parking supply;
- Encourage transit use;
- Encourage bicycle use;
- Enhance pedestrian access and walkability;
- Reduce the need for off-site trips through the planned land uses and building infrastructure; and
- Raise awareness regarding the alternative travel mode options in the area.

The proposed TDM measures extend across the built environment being delivered, as part of the development proposal and operational practices adopted and include:

- Urbanization of the existing large-format uses that currently occupy the site and establishment of a
 quality public and pedestrian realm within the property;
- Improved pedestrian connections to transit including new street infrastructure, mid-block connections and new signalized crossings over collector and local streets (existing and planned);
- Provision of new cycling infrastructure across the site, bicycle parking facilities and trip-end infrastructure within the proposed buildings;
- A reduced parking supply provided on-site that responds to the availability of alternate forms of transportation across the Golden Mile Area;
- The establishment of *Shared Mobility Hubs* facilities in locations identified within the GMSP with the provision of car-share and bike-share facilities; and
- A program to increase awareness of the area's existing and future transportation services and
 mobility options among building residents, office employees and visitors to support and encourage
 the use of non-automobile modes of transportation.

These TDM measures would play a role in supporting non-automobile dependent travel and to assist in minimizing the need for reliance on the car for a range of travel needs, be they local or over some distance.

The series of proposed TDM measures are described in detail below, and are based on discussions with City Transportation Planning staff, and reflect the outcome of those discussions, including the consideration for the additional density being sought as part of the development proposal.

2.1 TDM: VEHICLE MANAGEMENT

Proposed Reduced Parking Supply

The provision of convenient and inexpensive parking encourages automobile trips, and as such has a significant impact on travel mode choices.

The architectural plans illustrate a total parking supply of 1,913 parking spaces. It is proposed that a minimum of 1,629 parking spaces be provided for residents (0.55 spaces per unit) and 284 parking spaces be provided for non-residential uses (0.10 spaces per unit for residential-visitors and 1 space 100 m² GFA for retail).

Parking standards outlined in Zoning By-law 569-2013 are considered to overstate the parking needs of developments along transit-accessible corridors. This has been recognized by a number of City Council, Minor Variance approvals and Ontario Municipal Board decisions that have adopted lower standards. It has also been recognized by higher-level government policy. The approval of a reduced parking standard is considered appropriate based upon the following considerations:

- A review of provincial and local policy directives;
- The area transportation context;
- Observed decline in residential parking demand over time;
- Recently reduced parking supply ratio approvals for residential and office buildings in similar context;
- Observed parking demand at residential and office buildings in similar context; and
- The local nature of the proposed retail uses.

A reduced parking supply also aligns with the vision of the following policy documents:

- Golden Mile Secondary Transportation Master Plan
- A Place to Grow: Growth Plan for the Greater Golden Horseshoe
- MTO Transit-Supportive Guidelines
- 2041 Regional Transportation Plan (RTP)
- Toronto Official Plan
- Eglinton Connects Planning Study, Volume 2: Recommendations and Implementation Strategies

With the current and planned transportation context of the site, such as the Eglinton Crosstown LRT and active transportation improvements, future users of the site will have a variety of options that allow them to live, work and travel without a car. Thus, a reduced parking supply is considered appropriate and is a key TDM strategy to address travel demand for the site in a sustainable manner.

Car Share

The GMSP and TMP include plans for new EcoMobility Hubs that act as a one-stop service points for multi-modal systems, including bike or scooter stations, car-share vehicle or ride-sharing pick-up / drop-off areas.

With the development proposal, 7 car-share spaces will be provided throughout Phase 1 of the RioCan lands, at a rate of 1 car share space per 350 units. These car share spaces will provide for occasional, on-demand car use without the need to own a vehicle.

As part of the development proposal, the applicant will continue to work with the City to provide facilities in locations that support the Shared Mobility Hub at the southeast corner of the proposed parkland. The City will also focus similar publicly provided facilities at these locations to establish the Shared Mobility Hubs. Further details regarding the shared mobility hubs will be provided by the applicant at Site Plan Approval.

Dedicated Shared Vehicle Zones

In order to discourage automobile ownership, convenient access for shared and accessible vehicle use will be provide at-grade, as part of the development proposal. These areas will be located on site in proximity to the main building entrances. The details related to the design and signage of these facilities will be confirmed at Site Plan Approval. The proposed passenger pick-up / drop-off areas include:

- Building A1 / A2 Drive court between Buildings A1 and A2 to accommodate PUDO activity, and can be accessed via NS8 and NS9
- Building B1 PUDO activity proposed along the north side of the building via the east-west driveway, accessed via NS9 and NS10
- Building B2 Drive court proposed south of Building B2 to accommodate PUDO activity, accessed via NS9 and NS10

Shared Mobility Hubs

The GMSP and TMP include plans for new EcoMobility Hubs that act as a one-stop service points for multi-modal systems, including bike or scooter stations, car-share vehicle or ride-sharing pick-up / drop-off areas. The purpose of these hubs are to be the first and last mile solutions in order to encourage transit use. Large scale mobility hubs are focused near high order transit stops. As such, the TMP identifies the Warden Avenue / Eglinton Avenue East and Birchmount Road / Eglinton Avenue East intersections as the locations of future large scale EcoMobility Hubs, which are near to, but not adjacent to the site. A medium scale mobility hub is proposed at the southeast corner of the proposed parkland.

The development proposal considers Shared Mobility Hubs that support the identified Mobility Hub initiatives outlined in the Golden Mile Secondary Plan. The applicant will work with the City to focus developer provided facilities in locations that support the Shared Mobility Hubs at the southeast corner of the proposed parkland. The City will also focus similar publicly provided facilities at these locations to establish the Shared Mobility Hubs. Further details about the Shared Mobility Hubs will be confirmed at Site Plan Approval.

2.2 TDM: CYCLING

Bike Share Facilities

As a TDM initiative, a contribution for 7 bike share stations will be provided by the applicant as part of the development proposal, at a rate of 1 Bike Share Station per 350 units. These bike share facilities will be located at the discretion of the City and Toronto Bike Share. The location of bike share facilities will be determined during Site Plan Approval and during further discussions with the City. The cost to provide these Bike Share Stations is assumed to be at \$50,000 each, for a total of \$350,000

The applicant will continue to work with the City to provide facilities in locations that support the Shared Mobility Hubs at the southeast corner of the proposed parkland. Further details regarding the shared mobility hubs will be provided by the applicant at Site Plan Approval.

Bike Share Memberships

To promote the use of Bike Share facilities, particularly for "first and last mile" travel across the Golden Mile Secondary Area, the developer will provide funding for up to 100 Bike Share memberships for a one-year period to occupants of affordable units.

Bike Repair Stations

To further encourage cycling as a desirable travel mode, 1 bike repair station will be provided at each residential tower for a total of 4 stations. The locations of the bicycle repair stations will be confirmed at Site Plan Approval.

2.3 TDM: TRANSIT

Transit Screens – Resident Information

To encourage transit use, screens that include information about nearby transit service will be provided in the shared or separate lobby of each building. Further details regarding the information screens will be provided at Site Plan Approval.

Contributions to Transit Studies

As transit service improvements are a key TDM measure for this area, as part of the development proposal, the developer will provide funds (\$150,000 lump sum) that could be used to study future transit improvements along the Warden Avenue. A contribution – or part thereof – could be allocated to bicycle studies on Birchmount Road or other initiatives as appropriate.

Provision of Presto Passes

To encourage transit usage and to assist new residential unit owners of affordable housing units, the developer will provide up to 100 pre-loaded Presto passes for one year to affordable units. As a TDM measure, these transit passes would provide access to a wide variety of travel options in the Golden Mile Area and throughout the GTA. It is expected that these passes would provide an incentive for residents to become familiar with the transit options available and increase the likelihood that future travel by transit would be the preferred travel choice.

2.4 TDM: MONITORING

Since the GMSP requires that the implemented TDM measures be monitored and reported, and to assist the City in the ongoing monitoring of travel patterns and needs in the Golden Mile Area, the developer will contribute a lump sum of \$30,000 to the City for their monitoring efforts.

2.5 SUMMARY OF TDM MEASURES

The proposed TDM measures are summarized in Table 1 and include measures related to vehicle management, cycling and transit initiatives and monitoring.

TABLE 1 Proposed Transportation Demand Management Measures

TDM Measure	Measure Intent	Detail	Comment				
Vehicle Management							
Reduced Parking	To reduce car usage	Reduced Residential at 0.55 spaces / unit	Residential visitor / non- residential parking may be provided on a non-exclusive basis and charged for.				
		Res-vis at 0.10 spaces / unit (PA3 of ZBL 569-2013)					
		Non-res at 1.0 spaces / 100m² (PA3 of ZBL 569- 2013)					
Car Share Spaces	To provide for occasional, on- demand car use without the need to own a vehicle	Based on 1 per 350 units ¹	Site will be providing 7 spaces across the 4 buildings				
		7 car-share spaces to be provided					
Dedicated Shared Vehicle Zones	To provide convenient access for shared and accessible vehicle use	At-grade facilities to be located on site in proximity to key building entrances	Details – including design arrangements and related signage - to be reviewed and finalized at Site Plan Approval				
Shared Mobility Hub Treatments	To support the identified Mobility Hub initiatives outlined in the Golden Mile Secondary Plan	As per Secondary Plan locations, medium scale mobility hub at SE corner of proposed parkland on site	The applicant will work with the City to focus developer provided facilities in locations that support the Shared Mobility Hubs at the southeast corner of the				

TDM Measure	Measure Intent	Detail	Comment					
		Future large scale mobility hub at Warden / Eglinton and Birchmount / Eglinton	proposed parkland. The City will also focus similar publicly provided facilities at these locations to establish the Shared Mobility Hubs.					
			Details to be finalized at Site Plan Approval.					
	Cycling							
Bike Share Facilities	A contribution to the establishment of the broader Bike Share Toronto network across the Golden Mile Area	Provided at 1 / 350 units in ZBA phase 1 area ¹ Provision of 7 stations @ \$50,000 per station = \$350,000 contribution	Bike Share facilities maybe located at the discretion of the City and Toronto Bike Share. Location of facilities to be provided on-site will be determined at Site Plan Approval and in discussion with the City.					
Bike Share Membership	To promote the usage of the Bike Share systems particularly for "first – last mile" travel across the Golden Mile Secondary Plan area	Up to 100 memberships for 1-year @ \$100 year = \$10,000 ²						
Bike Repair Stations	To encourage cycling as a travel mode working in the context of the evolving cycling networks	1 station in each building, 4 on site	Letter of credit to be provided to City. Locations to be finalized at Site Plan Approval.					
	Ti	ransit						
Transit Screens	To encourage transit use	1 screen per lobby	Details to be provided at Site Plan Approval					
Transit Study Contribution	To assist the City in undertaking studies to improve transit services on the Victoria Park Avenue and Warden Avenue corridors.	\$150,000 lump sum ³	Provided in conjunction of Presto passes to affordable units. Note: contribution – or part thereof - could be allocated					
			to bicycle related or other studies / infrastructure as appropriate.					
Presto Passes	To encourage transit usage and to assist new residential unit owners of affordable housing units	Proved up to 100 "loaded" Presto pass for 1 year for each affordable housing unit provided	Approximate cost: Up to 100 units x \$157 / month x 12 months = \$188,400					
	Мог	nitoring						
Contribution to City Monitoring Process	To assist the City in ongoing monitoring of travel patterns	\$30,000 lump sum ³	Travel demand behavior also reviewed as					

TDM Measure	Measure Intent	Detail	Comment
	and needs in the Golden Mile area		development applications proceed using – as City monitoring progresses – information derived from City review.

Notes:

- 1 per 350 units adopted as base supply parameter in other TDM packages across Golden Mile
 Provision of 100 memberships based on conservative estimate of affordable units.
 Based upon comparable contributions for other developments and factored to reflect relative number of units approved as part of the Phase 1 development compared to other developments

Sincerely,

BA Consulting Group Ltd.

Alun Lloyd, P.Eng.

Principal

CC.

Deanna Green, BA Group Natali Tsui, BA Group