
PUBLIC ATTACHMENT 1

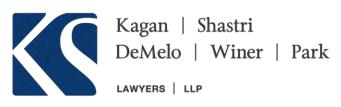

JASON PARK Direct: 416.645.4572 <u>ipark@ksllp.ca</u>

File No. 23052

May 29, 2023

WITH PREJUDICE

VIA EMAIL: jessica.braun@toronto.ca; colin.dougherty@toronto.ca

Jessica Braun and Colin Dougherty City of Toronto Legal Services Planning & Administrative Tribunal Law Metro Hall, 26th Floor 55 John Street Toronto, ON M5V 3C6

Dear Sirs/Mesdames:

Re: 100 Davenport Road, City of Toronto

Planning Application Nos.: 21 231497 STE 11 OZ and 21 231498 STE 11 SA Appeals to OLT of Zoning By-law Amendment and Site Plan Approval

Applications

OLT Lead Case No. OLT-22-004195

WITH PREJUDICE SETTLEMENT OFFER

As you know, we are the solicitors for 100 Davenport GP Inc. c/o 100 Davenport Limited Partnership (the "Applicant"), the owners of the lands known municipally as 100 Davenport Road in the City of Toronto, and the appellant with respect to the abovenoted appeals.

Further to our settlement discussions with respect to the above-noted appeals, we are pleased to provide the following settlement offer on a with prejudice basis in full settlement of these appeals:

(1) Our client would agree to formally revise its development proposal that is the subject of the above noted appeals before the OLT as shown on the attached plans prepared by Scott Shields Architects Inc. dated April 12, 2023 (the "Proposed Development"). The main revisions from the proposal that is currently before the Tribunal are as follows:

- a. providing a minimum setback of 6.0 metres from curb to building face along Davenport Road as requested by City staff;
- b. the podium has been revised to create a more defined three storey base that relates to the existing 3 storey street wall along Davenport Road. Above the 3 storey base, the building steps back over 4m at the north end of the site, with step backs varying from 1.2m 2m being provided along Davenport Road. Further step backs varying from 1.2m 2m are provided at level 8. The overall setback from the tower portion of the building (levels 9 19) to the base podium, therefore, meets the requested 3m setback by City staff;
- c. the northerly portion of the 19th floor has been cut back by 2.5 metres and the massing at the top of the building has been reversed, with terraces now located on the north side of the building which creates a stepping down of the building to the north which reduces shadow further;
- d. the ground floor entrance has been redesigned and now incorporates a pet wash area as per the City's Pet Friendly Guidelines; and
- e. a new pick up and drop off area accessed from Blackmore Street has been added.
- (2) In terms of the site plan application, our client agrees to work with City staff to resolve the remaining site plan issues in order to finalize a NOAC following the approval by the OLT of the necessary zoning by-law amendment for the Proposed Development.

With respect to the issuance of the final Order for the Zoning By-law Amendment for the Proposed Development, our client is agreeable to the final Order being withheld subject to the following conditions being satisfied:

- (1) The OLT has been advised by the City Solicitor that the proposed Zoning Bylaw Amendment's form and content is satisfactory to the City;
- (2) The owner has resubmitted the Functional Servicing and Stormwater Management Report and Hydrogeological Report, to the satisfaction of the Chief Engineer and Executive Director, Engineering and Construction Services; and
- (3) The owner has entered into an agreement or agreements or otherwise secured the design, construction, and the provision of financial securities for any required upgrades or improvements to the existing municipal infrastructure should it be determined that improvements or upgrades are required to support the development as may be identified in the accepted Functional Servicing and Stormwater Management Report, all to the satisfaction of the

00347245-4 Page 2

Services. Chief Engineer and Executive Director, Engineering and Construction

In support of the settlement offer, please find attached the following via a Dropbox link:

(1)the site from the Bay and Davenport intersection as requested by City staff. which includes a 3D view showing the clock tower view terminus to the North of Architectural Plans dated May 12, 2023 prepared by Scott Shields Architects Inc.

416.645.4572 or via email at jpark@ksllp.ca. If you have any questions regarding the above, please do not hesitate to contact me at

Yours truly,

KAGAN SHASTRI DeMELO WINER PARK LLP

Jason Park JIP/ss

Please reply to the: Downtown Office

cc: 100 Davenport GP Inc. c/o 100 Davenport Limited Partnership

00347245-4 Page 3

100 DAVENPORT ROAD

100 Davenport Road, Toronto, Ontario Project Number: 21302

<u> </u>		Issued for
Sheet Number	Sheet Name	Settlement
A 0.00	COVER SHEET	2023-05-12
A 0.01	PROJECT SUMMARY	2023-05-12
A 1.01	PERSPECTIVE VIEW	2023-05-12
A 1.02	PERSPECTIVE VIEWS AND MATERIAL BOARD	2023-05-12
A 1.07	SITE SURVEY	2023-05-12
A 1.08	SITE PLAN	2023-05-12
A 1.09	VEHICLE MANEUVERING	2023-05-12
A 1.10	CONTEXT PLAN & 3D VIEW	2023-05-12
A 1.11	TOP OF TOWER MASSING	2023-05-10
A 2.01	P4 PLAN	2023-05-12
A 2.02	P2 - P3 PLAN	2023-05-12
A 2.03	P1 PLAN	2023-05-12
A 4.01	GROUND FLOOR PLAN	2023-05-12
A 4.02a	2ND FLOOR PLAN COMMERCIAL OPTION	2023-05-12
A 4.02b	2ND FLOOR PLAN RESIDENTIAL OPTION	2023-05-12
A 4.03	3RD FLOOR PLAN	2023-05-12
A 4.04	4TH FLOOR PLAN	2023-05-12
A 4.06	5TH - 7TH FLOOR PLAN	2023-05-12
A 4.08	8TH FLOOR PLAN	2023-05-12
A 4.09	9TH - 17TH FLOOR PLAN	2023-05-12
A 4.10	18TH FLOOR PLAN	2023-05-12
A 4.11	19TH FLOOR PLAN	2023-05-12
A 4.12	MPH ROOFTOP PLAN	2023-05-12
A 5.01	EAST ELEVATION	2023-05-12
A 5.01.a	ENLARGED EAST ELEVATION	2023-05-12
A 5.01.b	ENLARGED EAST ELEVATION	2023-05-12
A 5.02	SOUTH ELEVATION	2023-05-12
A 5.02.a	ENLARGED SOUTH ELEVATION	2023-05-12
A 5.03	WEST ELEVATION	2023-05-12
A 5.03.a	ENLARGED WEST ELEVATION	2023-05-12
A 5.03.b	ENLARGED WEST ELEVATION	2023-05-12
A 5.04	NORTH ELEVATION	2023-05-12
A 5.04.a	ENLARGED NORTH ELEVATION	2023-05-12
A 5.05	BAY STREET ELEVATION	2023-05-12
A 5.06	MCALPINE AND DAVENPORT STREET ELEVATIONS	2023-05-12
A 6.01	NORTH-SOUTH SECTION	2023-05-12
A 6.02	ANGULAR PLANE SECTION A	2023-05-12
A 6.03	ANGULAR PLANE SECTION B	2023-05-12
A 10.01	SPRING / FALL 3D SOLSTICE SHADOW STUDY	2023-05-12
A 10.02	SPRING / FALL SOLSTICE SHADOW STUDY	2023-05-12
A 10.03	SUMMER SOLSTICE SHADOW STUDY	2023-05-12

INTERNATIONAL LANGUAGE **ACADEMY** 3 STOREY TOWNHOMES THE YORKVILLE 31 STOREY RESIDENTIAL BUILDING BELMONT HOUSE LONG TERM CARE FACILITY 48 SCOLLARD 41/STOREY RESIDENTIAL BUILDING COLLEGE OF NURSES
OF ONTARIO JESSE KETCHUM JUNIOR AND SENIOR
PUBLIC SCHOOL Context Plan



THIS SET IS ISSUED FOR:

General Notes

- 1. ALL DIMENSIONS IN MILLIMETRES.
- 2. VERIFY ALL DIMENSIONS. 3. DO NOT SCALE DRAWINGS.
- 4. CHECK DRAWINGS AGAINST SPECIFICATIONS.
- 5. USE THE LATEST REVISED DRAWINGS ONLY. 6. REPORT ANY DISCREPANCIES, DISCOVERED ERRORS, OR OMISSIONS, TO THE ARCHITECT BEFORE PROCEEDING.
- 7. DRAWINGS AND SPECIFICATIONS ARE THE PROPERTY OF THE ARCHITECT, AND MUST BE RETURNED UPON COMPLETION OF WORK.





True North Project North

Issued for Settlement 2023-05-12 1 Issued for Rezoning/Site 2021-09-17 Plan Approval

317 King Street West, Toronto, Ontario M5V 1J5
T +1 416-924-2177 F +1 416-924-7398
scottarch.ca

100 DAVENPORT

4⁄9**@**•Đavenport Road, Toronto, ON.

Drawing

COVER SHEET

Project number	21302
Date	2020-12-22
Drawn by	YB
Checked by	AS

A 0.00

Project Statistics Summary

Maximum Builidng Height per Current Zoning

Landscaped Areas (Hardscape and Softscape Areas)

Proposed Building Height

Building Coverage

Net Site Aea

Proposed Number of Storeys

10. Landscape Open Space

Client: Davenport Developments
Project: 100 Davenport Road

1. Municipal Address & Legal Description

100 DAVENPORT ROAD
LOTS 1, 2 AND 3 REGISTERED PLAN 680E, PART OF LOT A REGISTERED PLAN 364Y,

Level	Floo	r Area		Deductions		GFA	No	n Residentia	GFA In	door Amenity	
	No. of Floors	sq.m.	sq.ft.	sq.m.	sq.ft,	sq.m.	sq.ft.	sq.m.	sq.ft.	sq.m.	sq.f
P4 - P2	3	1200.85		1,153.27	12,414	47.58	512				
P1	1	1200.85		1,184.99	12,755	15.86	171				
Level 1: Ground	1	956.57	10,296	284.78	3,065	229.83	2,474	441.96	4,757		
Level 2	1	808.89	8,707	46.75	503	657.19	7,074		200	104.95	1,13
Level 3	1	851.62	9,167	46.75	503	804.87	8,664				-
Level 4	1	714.92	7,695	46.75	503	668.17	7,192				
Level 5	1	714.92	7,695	46.75	503	668.17	7,192				
Level 6	1	714.92	7,695	46.75	503	668.17	7,192				
Level 7	1	714.92	7,695	46.75	503	668.17	7,192				
Level 8	1	562.68	6,057	46.75	503	515.93	5,553				
Level 9	1	543.38	5,849	46.75	503	496.63	5,346				
Level 10	1	543.38	5,849	46.75	503	496.63	5,346				
Level 11	1	543.38	5,849	46.75	503	496.63	5,346				
Level 12	1	543.38	5,849	46.75	503	496.63	5,346				
Level 13	1	543.38	5,849	46.75	503	496.63	5,346				
Level 14	1	543.38	5,849	46.75	503	496.63	5,346				
Level 15	1	543.38	5,849	46.75	503	496.63	5,346				
Level 16	1	543.38	5,849	46.75	503	496.63	5,346				
Level 17	1	543.38	5,849	46.75	503	496.63	5,346				
Level 18	1	496.03	5,339	46.75	503	449.28	4,836				
Level 19	1	461.31	4,965	46.75	503	414.56	4,462				
Total			127,952.76			10,277.46	110,626	441.96	4,757	104.95	1,13
Total Proposed R	esidential GFA					10,296.40	110,830				
	on Residential GFA					441.96	4,757				
	A (residential plus no	n residential min	us amenity)			10,824.36	116,512				

4. Proposed Density (FSI)								
Proposed Floor Space Index (Total Proposed GFA /	Gross Site Area)							8.38
5. No. of Residential Units + Suite Mix				o				
	Floors	S	1B	1B+D	2B	2B+D	3B	Total
Level 1: Ground	1	0	0	0	0	0	0	0
Level 2	1	1	0	0	1	1	1	3
Level 3	1	0	0	1	2	1	1	5
Level 4 - 7	4	0	0	0	1	0	2	12
Level 8 - 17	10	O	0	0	0	0	2	20
Level 18	1	0	0	0	0	1	1	2
Level 19	1	0	0	0	0	0	1	1
Total number of residential suites	19	0	0	1	7	2	31	43
Total number of guest suites	19	1	0	0	0	0	0	1

6.Vehicular Parking									
6.1 Required Parking (Per by-law 1331-2008)									4
	# of Units		req'd per						Total Req'd (by-law
		u	nit (by-law)						
Туре									
Retail / Commercial			1/100m2						
1B + D	1		0.7						
2B	1 7		1						
2B + D	2		1						
3B	31 43		1.2						3
Visitor	43		0.06						3
Total Required									5
6.2 Provided Parking									
Level	Resident (Standard Parking Space)	Resident	Total	Visitor	Visitor	Total C	ommercial Ca	share	Tota
		(Accessible	Resident	(Standard	(Accessible	Visitor			
		Parking Space)		arking Space)	Parking Space)				
P4	14	1	15	0	0	0	0	0	1
P3	14	1	15	0	0	0	0	0	1
P2	14	1	15	0	0	0	0	0	1
P1	3	0	3	2	1	3	4	1	1
Level 1: Ground	0	0	0	0	0	0	0	0	1
Total Provided:	45	3	48	2	1	3	4	1	5
			- 27	- 7					
7. Bicycle Parking 7.1 Required Bicycle Parking (Per TGS)									

P3	14	1	15	0	0	0	0	0	15
P2	14	1	15	0	0	0	0	0	15
P1	3	0	3	2	1	3	4	1	1:
Level 1: Ground	0	0	0	0	0	0	0	0	(
Total Provided:	45	3	48	2	1	3	4	1	56
7. Bicycle Parking									
7.1 Required Bicycle Parking (Per TGS)									
	# of Units	Req	, Per Unit	Min Reg'd					Total Required
Residents (long term)	43		0.9	39					39
Residents (short term)	43		0.1	5					
Commercial / Retail (long term)	442 sqm	0.	.2/100m2	1					3
Commercial / Retail (Short term)	442 sqm	1+0	.3/100m2	5					
Total				50					50
7.2 Provided Bicycle Parking									
Level			P4	P3	P2	P1	G		Total Provided
Residents (long term)			12	12	12	20	0		56
Residents (short term)			0	0	0		5		
Commercial / Retail (Long term)			0	0	0	1	0		1
Commercial / Retail (short term)			0	0	0	0	5		
Total			12	12	12	21	10		67
8. Amenity Space									
Туре	No. o	f Units	Req. pe	r Unit (sq.m.)	Total Required	(sq.m.)		To	tal Provided. (sq.m.
Indoor		43		2		86.00			104.95
Outdoor		43		2		86.00			97.20
Total Amenity (Indoor + Outdoor)						172.00			202.15

Statistics Template - Toronto Green Standard Version 3.0 Mid to High Rise Residential and all New Non-Residential Development

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The Toronto Green Standard Version 3.0 Statistics Template is submitted with Site Plan Control Applications and stand alone Zoning Bylaw Amendment applications. Complete the table and copy it directly onto the Site Plan submitted as part of the application.

For Zoning Bylaw Amendment applications: complete General Project Description and Section 1.

For Site Plan Control applications: complete General Project Description, Section 1 and Section 2. For further information, please visit www.toronto.ca/greendevelopment

General Project Description	Proposed	
Total Gross Floor Area	10,848.35	
Breakdown of project components (m²)		
Residential	10,322.39	
Retail	441.96	
Commercial		
Industrial		
Institutional/Other		

Section 1: For Stand Alone Zoning Bylaw Amendment Applications and Site Plan Control Applications

Automobile Infrastructure	Required	Proposed	Proposed %
Number of Parking Spaces	55	56	100%
Number of parking spaces dedicated for priority LEV parking	1	1	100%
Number of parking spaces with EVSE	12	12	100%
Cycling Infrastructure	Required	Proposed	Proposed %
Number of long-term bicycle parking spaces (residential)	38	56	
Number of long-term bicycle parking spaces (all other uses)	39	57	
Number of long-term bicycle parking (all uses) located on:			
a) first storey of building		0	
b) second storey of building		0	
c) first level below-ground		21	
d) second level below-ground		12	







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Page 1 of 3

11-0063 2018-05

e) other levels below-ground

Total number of residential units

Statistics Template - Toronto Green Standard Version 3.0 Mid to High Rise Residential and all New Non-Residential Development

Cycling Infrastructure	Required	Proposed	Proposed %
Number of short-term bicycle parking spaces (residential)	5	5	
Number of short-term bicycle parking spaces (all other uses)	5	5	
Number of male shower and change facilities (non-residential)			
Number of female shower and change facilities (non-residential)			
Tree Planting & Soil Volume	Required	Proposed	Proposed %
Total Soil Volume (40% of the site area ÷ 66 m² x 30 m³).	217	217.23m³	100%

Section 2: For Site Plan Control Applications

Available Roof Space provided as Cool Roof (m²)

Available Roof Space provided as Solar Panels (m²)

66.00

75.24%

24.76%

100.00%

sq.m. sq.ft. 956.57 10,296

314.78 3,388

1,271.35 13,685

Cycling Infrastructure	Required	Proposed	Proposed %
Number of short-term bicycle parking spaces (all uses) at-grade or on first level below grade	10	10	
UHI Non-roof Hardscape	Required	Proposed	Proposed %
Total non-roof hardscape area (m²)		65.87m²	
Total non-roof hardscape area treated for Urban Heat Island (minimum 50%) (m²)	32.94m²	65.87m²	100%
Area of non-roof hardscape treated with: (indicate m²)			
a) high-albedo surface material		65.87m²	100%
b) open-grid pavement			
c) shade from tree canopy			
d) shade from high-albedo structures			
e) shade from energy generation structures			
Percentage of required car parking spaces under cover (minimum 75%)(non-residential only)	75%	100%	100%
Green & Cool Roofs	Required	Proposed	Proposed %
Available Roof Space (m²)		536.21	100%
Available Roof Space provided as Green Roof (m²)	268.11	322.87	60.21%

11-0063 2018-05 Page 2 of 3

Statistics Template - Toronto Green Standard Version 3.0 Mid to High Rise Residential and all New Non-Residential Development

Landscaped site area planted with drought-tolerant plants (minimum 50%) (m² and %) (if applicable)	35.1m²	70.1m ²	100%
Tree Planting Areas & Soil Volume	Required	Proposed	Proposed %
Total site area (m²)		1195	
Total Soil Volume (40% of the site area ÷ 66 m²x 30 m³)	217m³	217m³	100%
Total number of planting areas (minimum of 30m³ soil)		4	
Total number of trees planted	7	1	14%
Number of surface parking spaces (if applicable)		0	
Number of shade trees located in surface parking area interior (minimum 1 tree for 5 parking spaces)		N/A	
Native and Pollinator Supportive Species	Required	Proposed	Proposed %
Total number of plants		527	
Total number of native plants and % of total plants (min.50%)	264	527	100%
Bird Friendly Glazing	Required	Proposed	Proposed %
Total area of glazing of all elevations within 16 m above grade (including glass balcony railings)		1167.66	100%

Required Proposed Proposed 9

Bird-Friendly Design Statistics

Total area of treated glazing (minimum 85% of total area

Percentage of glazing within 16m above grade treated with:

of glazing within 16m above grade) (m²)

a) Low reflectance opaque materials

b) Visual markers

c) Shading

Water Efficiency

Total landscaped site area (m²)



1114.01 95.40%

25.61%

51.37%

18.42%

299.10

599.81

215.11

		Elevation First 16m* Above Grade							
	North	South	East	West	Total (m2)	Total (%)			
Glazing Area (m²)					1167.66	100%			
Untreated Area (m²)	25.551	4.62	0.00	23.47	53.64	5%			
Treated Area (m²)					1114.01				
Low-Reflectance Opaque Glass (m²)	56.48	38.37	135.90	68.34	299.10	26%			
Visual Markers (m²)	56.00	86.72	152.37	304.72	599.81	51%			
Shaded (m ²)	48.73	67.95	19.22	79.21	215.11	18%			
*For Site Plan Approval applic	cations received before Jan	uary 1, 2020, 1	reat the first	12m above gr	ade.	-			
	Ele	vation First 4	m Above Roo	ftop Vegetati	on*				
	North (Floor #s)	South (Floor #s)	East (Floor #s)	West (Floor #s)	Total (m2)	Total (%)			
Glazing Area (m²)					351.39	100%			
Untreated Area (m²)			- 0		0				
Treated Area (m²)					351.39				
Low-Reflectance Opaque Glass (m²)	12.78	9.94	50.50	23.015	96.24	33.77%			
Visual Markers (m²)	23.61	27.81	55.12	63.98	170.52	42.01%			
	14.59	18.72	19.22	32.12	84.64	24.22%			
Shaded (m ²)	14.33								

Refer to the Toronto Green Standard Version 3 Ecology section for details on bird collision deterrence treatment options.

4 Issued for Settlement 2023-05-12 1 Issued for Rezoning/Site 2021-09-17 Plan Approval

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OF ARCHITECTS Z



Project

100 DAVENPORT

100 Davenport Road, Toronto, ON.

Drawing

PROJECT SUMMARY

Project number	21302
Date	2020-12-22
Drawn by	DD
Checked by	AS

A 0.01

Scale

ALL DIMENSIONS IN MILLIMETRES.
 VERIFY ALL DIMENSIONS.
 DO NOT SCALE DRAWINGS.

4. CHECK DRAWINGS AGAINST SPECIFICATIONS.

5. USE THE LATEST REVISED DRAWINGS ONLY.

6. REPORT ANY DISCREPANCIES, DISCOVERED ERRORS, OR OMISSIONS, TO THE ARCHITECT


7. DRAWINGS AND SPECIFICATIONS ARE THE


PROPERTY OF THE ARCHITECT, AND MUST

BE RETURNED UPON COMPLETION OF WORK.

BEFORE PROCEEDING.

General Notes

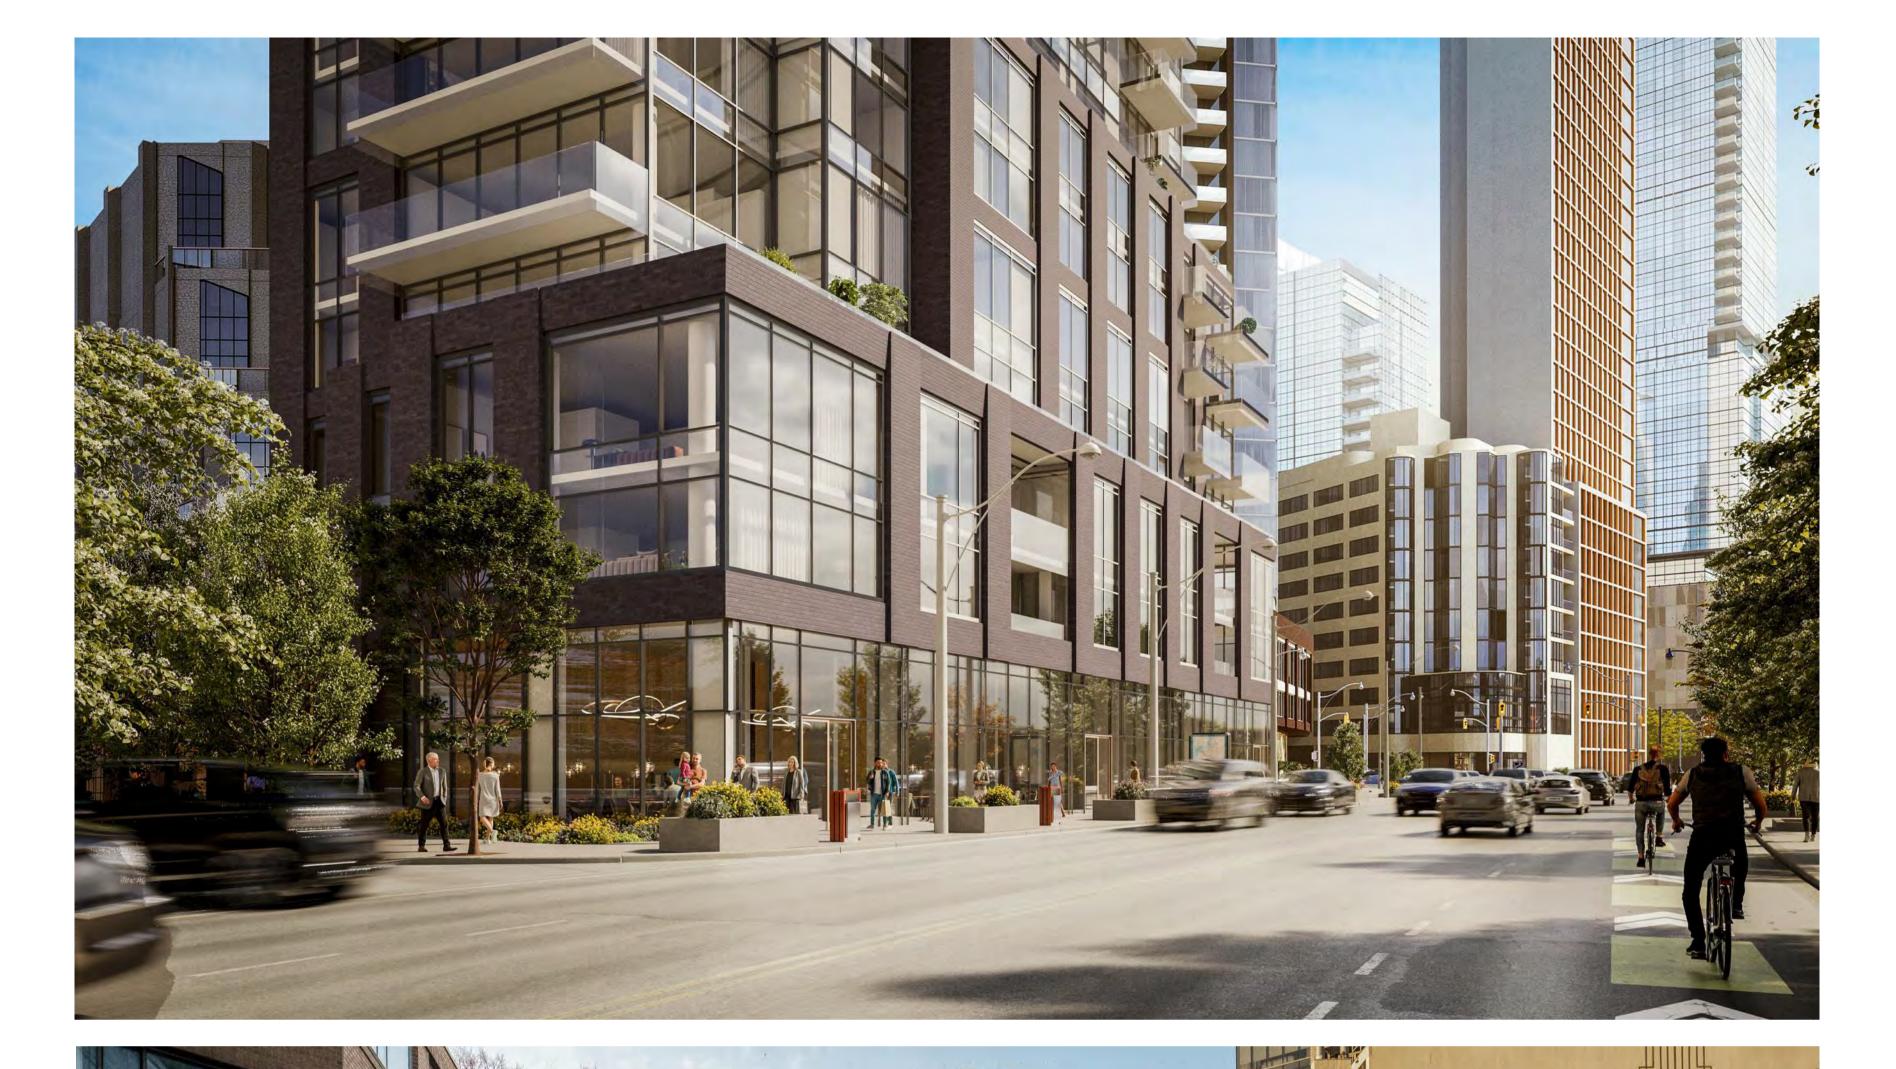

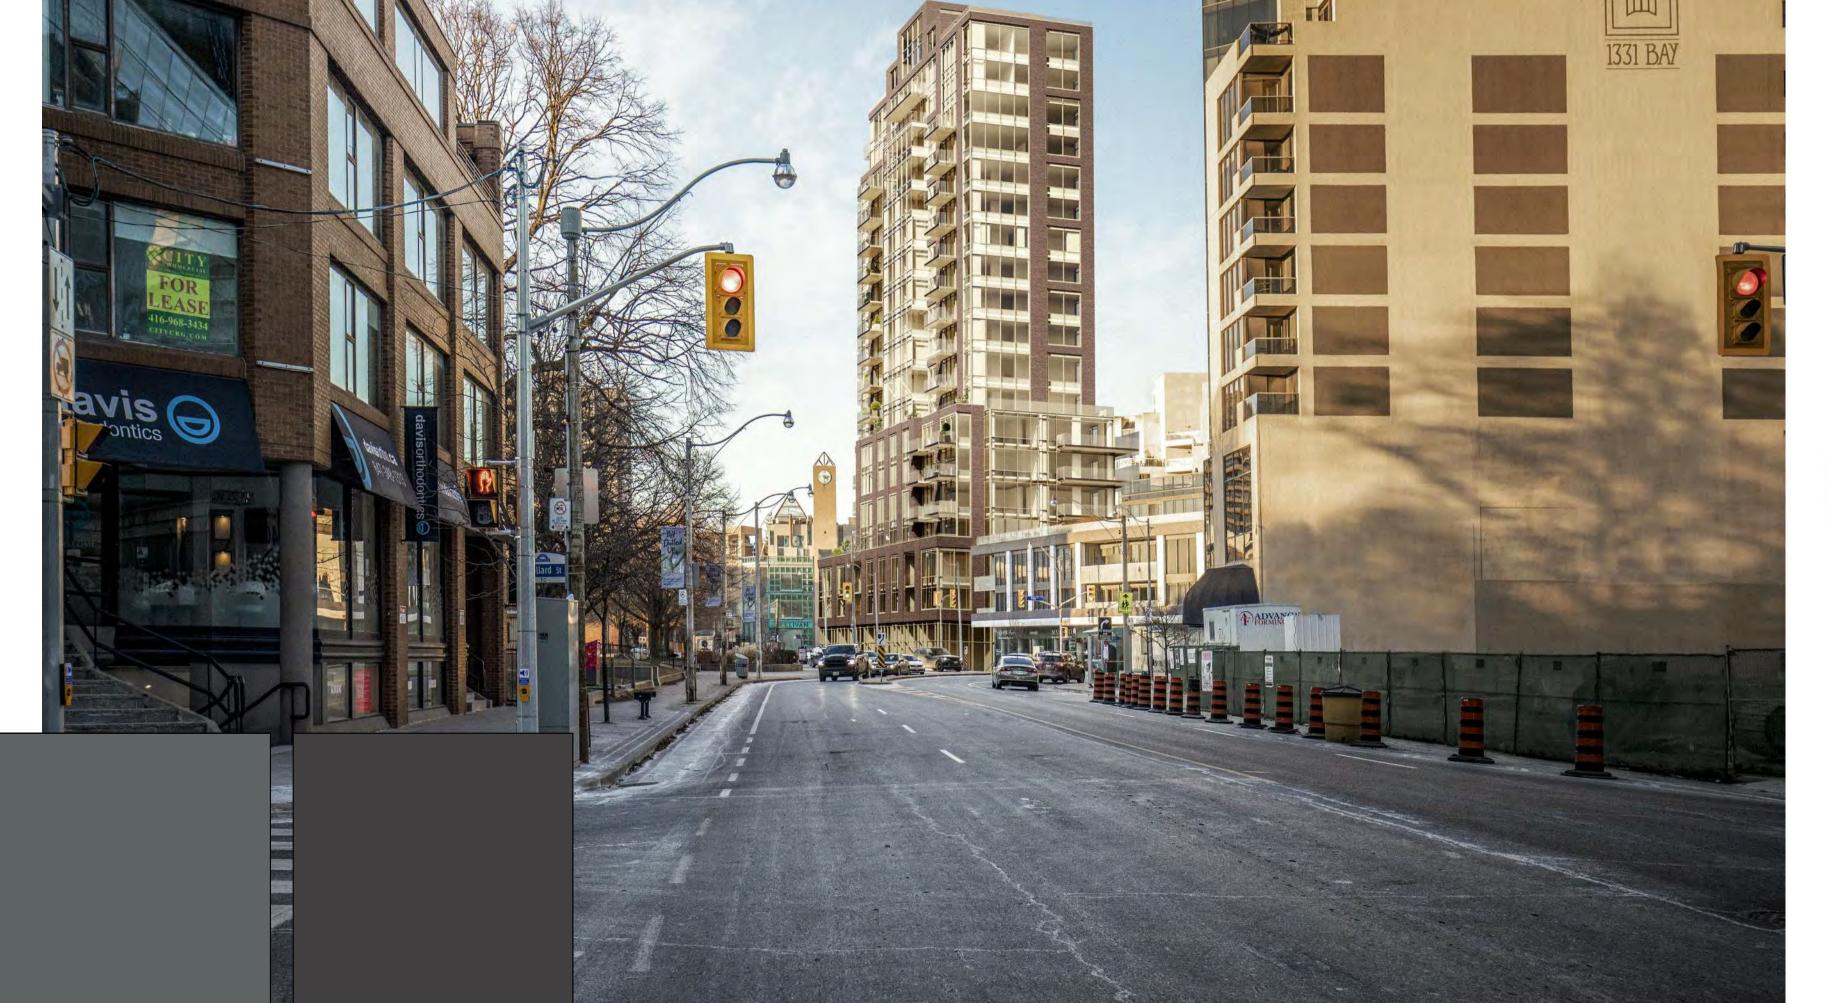



- 1. ALL DIMENSIONS IN MILLIMETRES.
- 2. VERIFY ALL DIMENSIONS. 3. DO NOT SCALE DRAWINGS.
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Scott Shields Architects Inc.
317 King Street West, Toronto, Ontario M5V 1J5
T+1 416-924-2177 F+1 416-924-7398
scottarch.ca

Issued for Settlement 2023-05-12

1 Issued for Rezoning/Site 2021-09-17 Plan Approval


100 DAVENPORT

100 Davenport Road, Toronto, ON.

Drawing PERSPECTIVE VIEWS AND MATERIAL BOARD


Project number	21302
Date	2020-12-22
Drawn by	YB
Checked by	AS

A 1.02

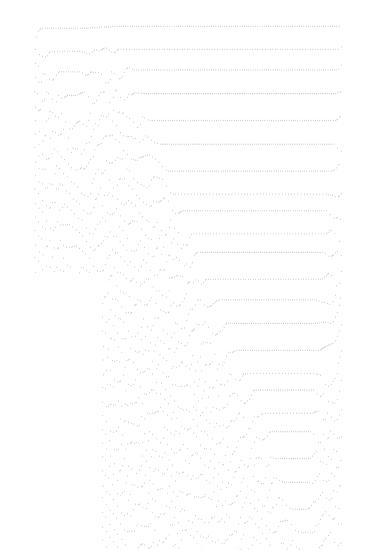






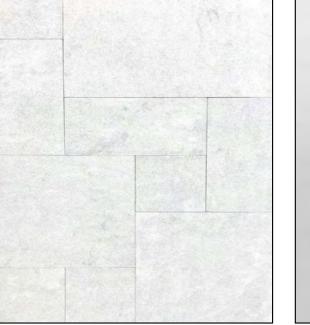


GLAZING CLEAR GLASS INSULATING UNIT

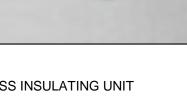

SPANDREL GLASS MEDIUM GREY

WINDOW MULLIONS DARK GREY

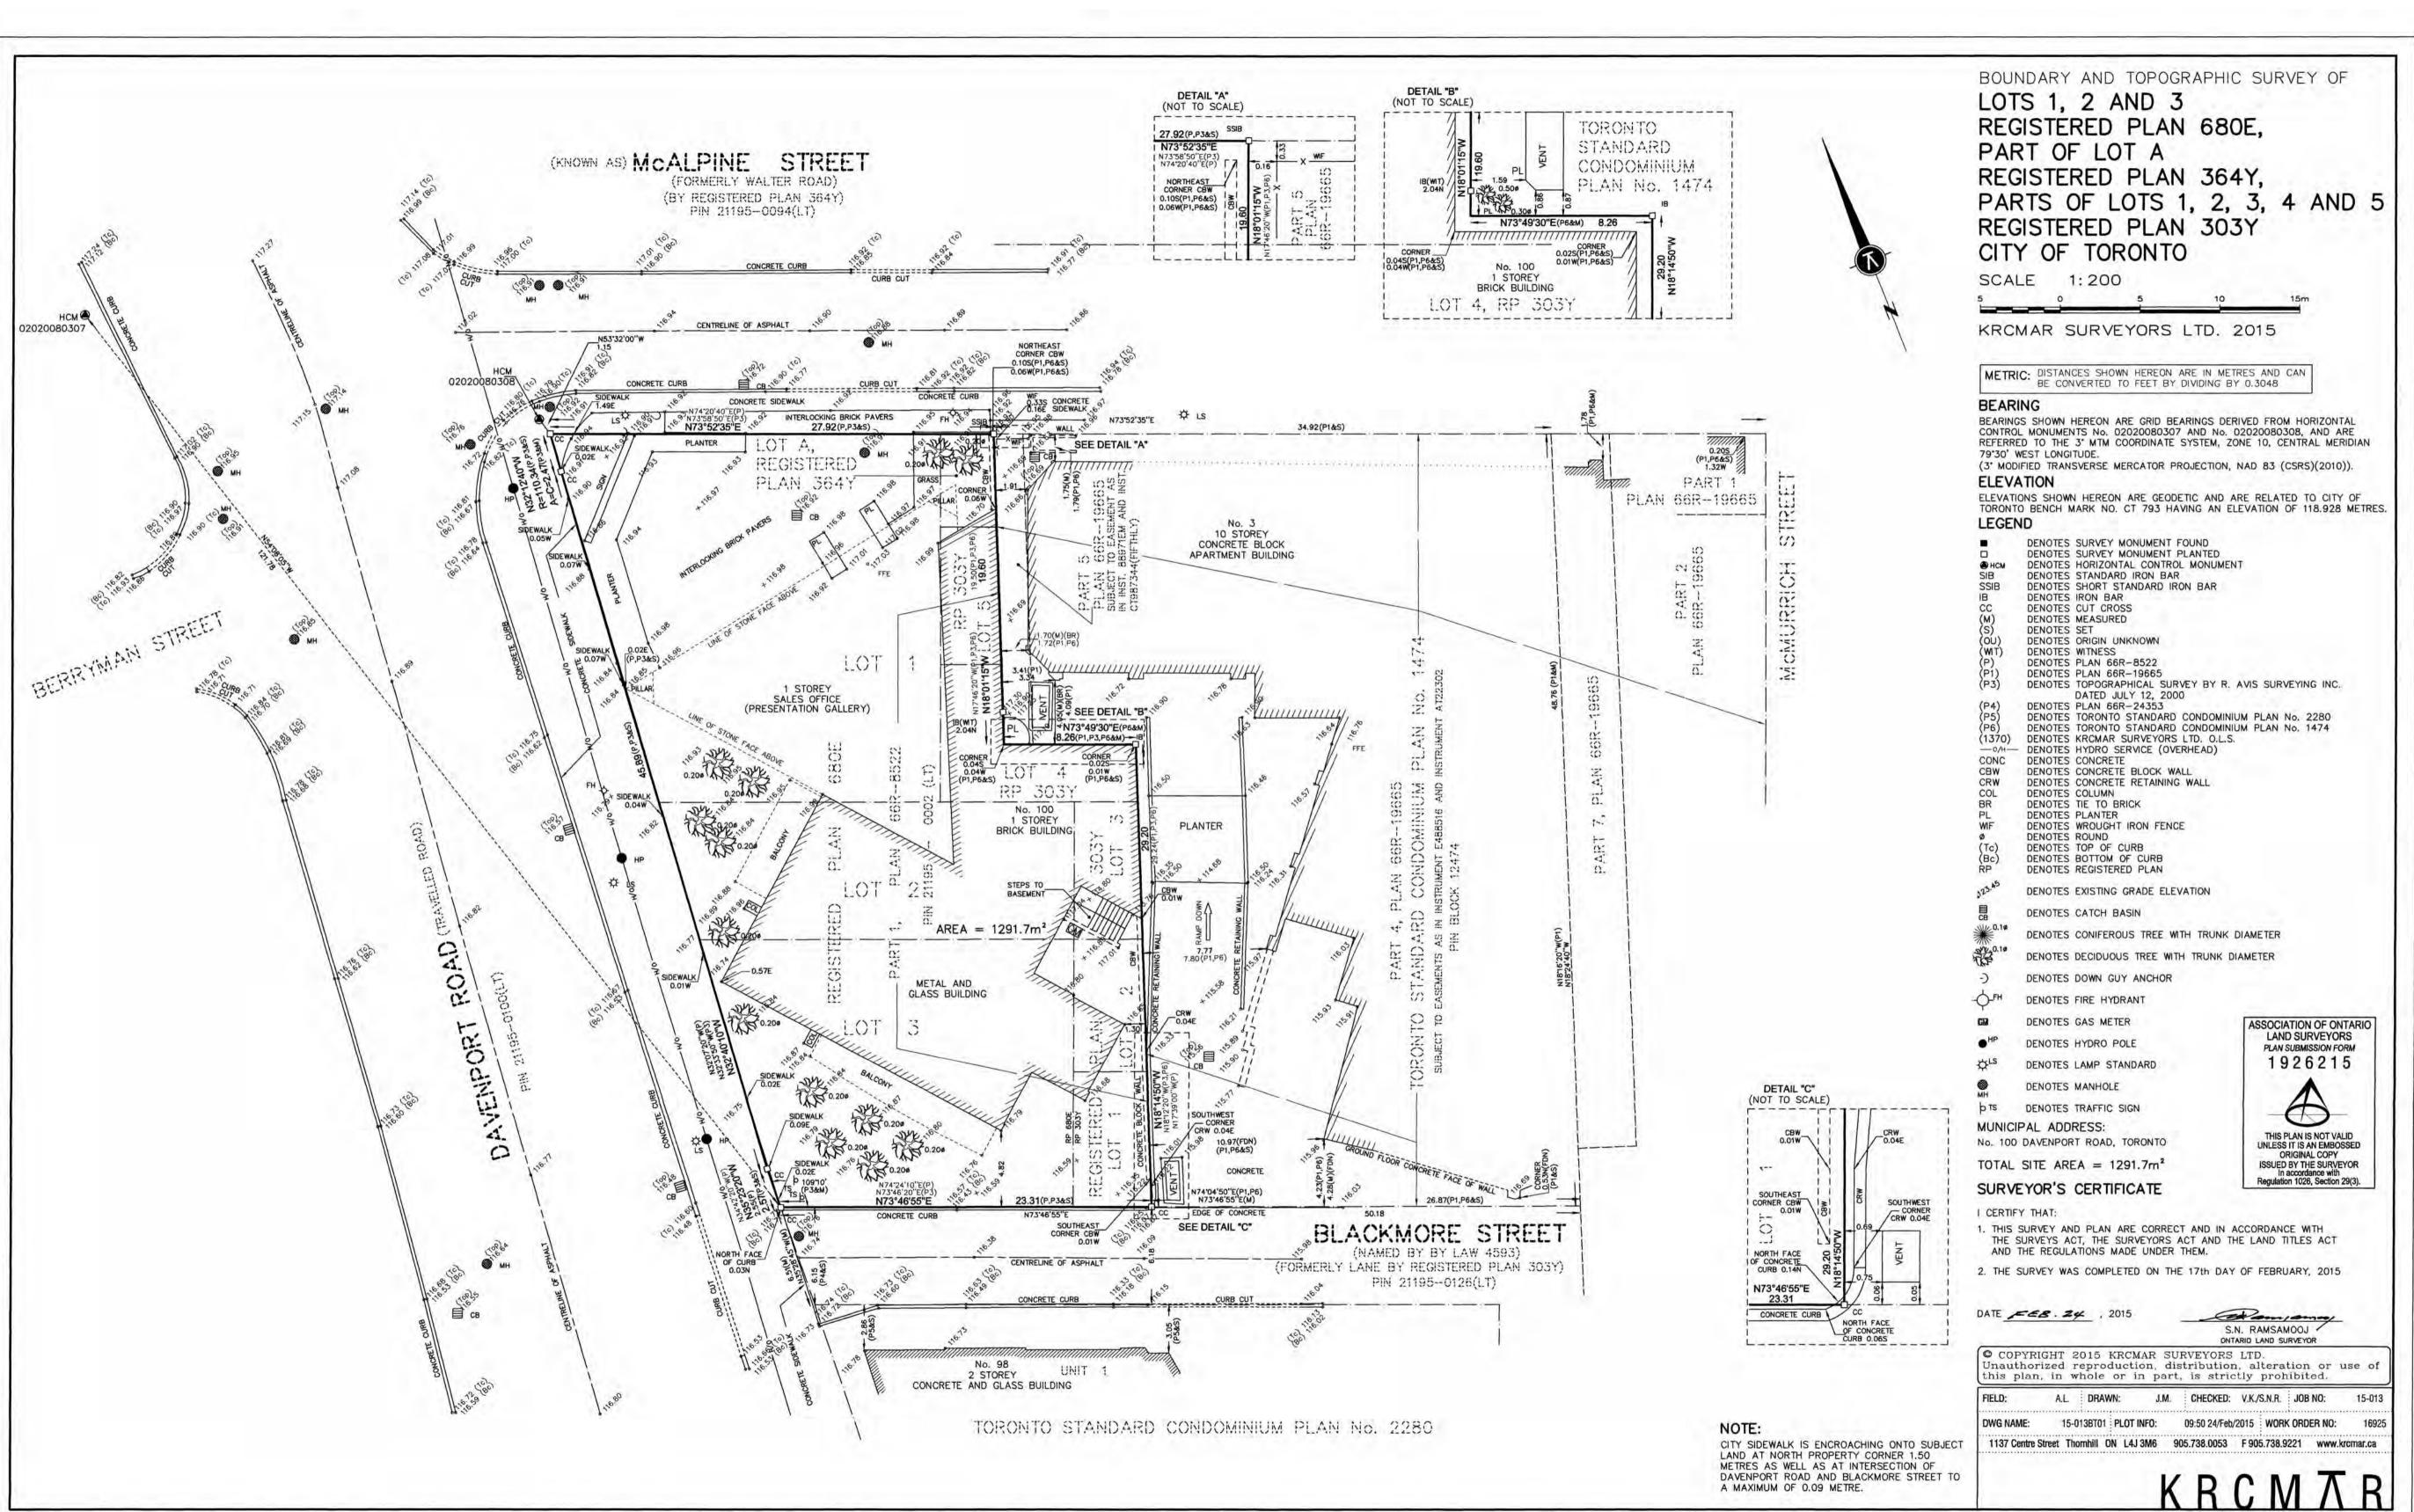

- ALL DIMENSIONS IN MILLIMETRES.
- 2. VERIFY ALL DIMENSIONS.
- 3. DO NOT SCALE DRAWINGS.
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- BEFORE PROCEEDING. 7. DRAWINGS AND SPECIFICATIONS ARE THE PROPERTY OF THE ARCHITECT, AND MUST BE RETURNED UPON COMPLETION OF WORK.

Issued for Settlement 2023-05-12 1 Issued for Rezoning/Site 2021-09-17 Plan Approval

Issue

Scott Shields Architects Inc. 317 King Street West, Toronto, Ontario M5V 1J5 T +1 416-924-2177 F +1 416-924-7398

Project

scottarch.ca

100 DAVENPORT

100 Davenport Road, Toronto, ON.


Drawing

SITE SURVEY

21302 Project number Date 2020-12-22 DD Drawn by Checked by

A 1.07

Scale

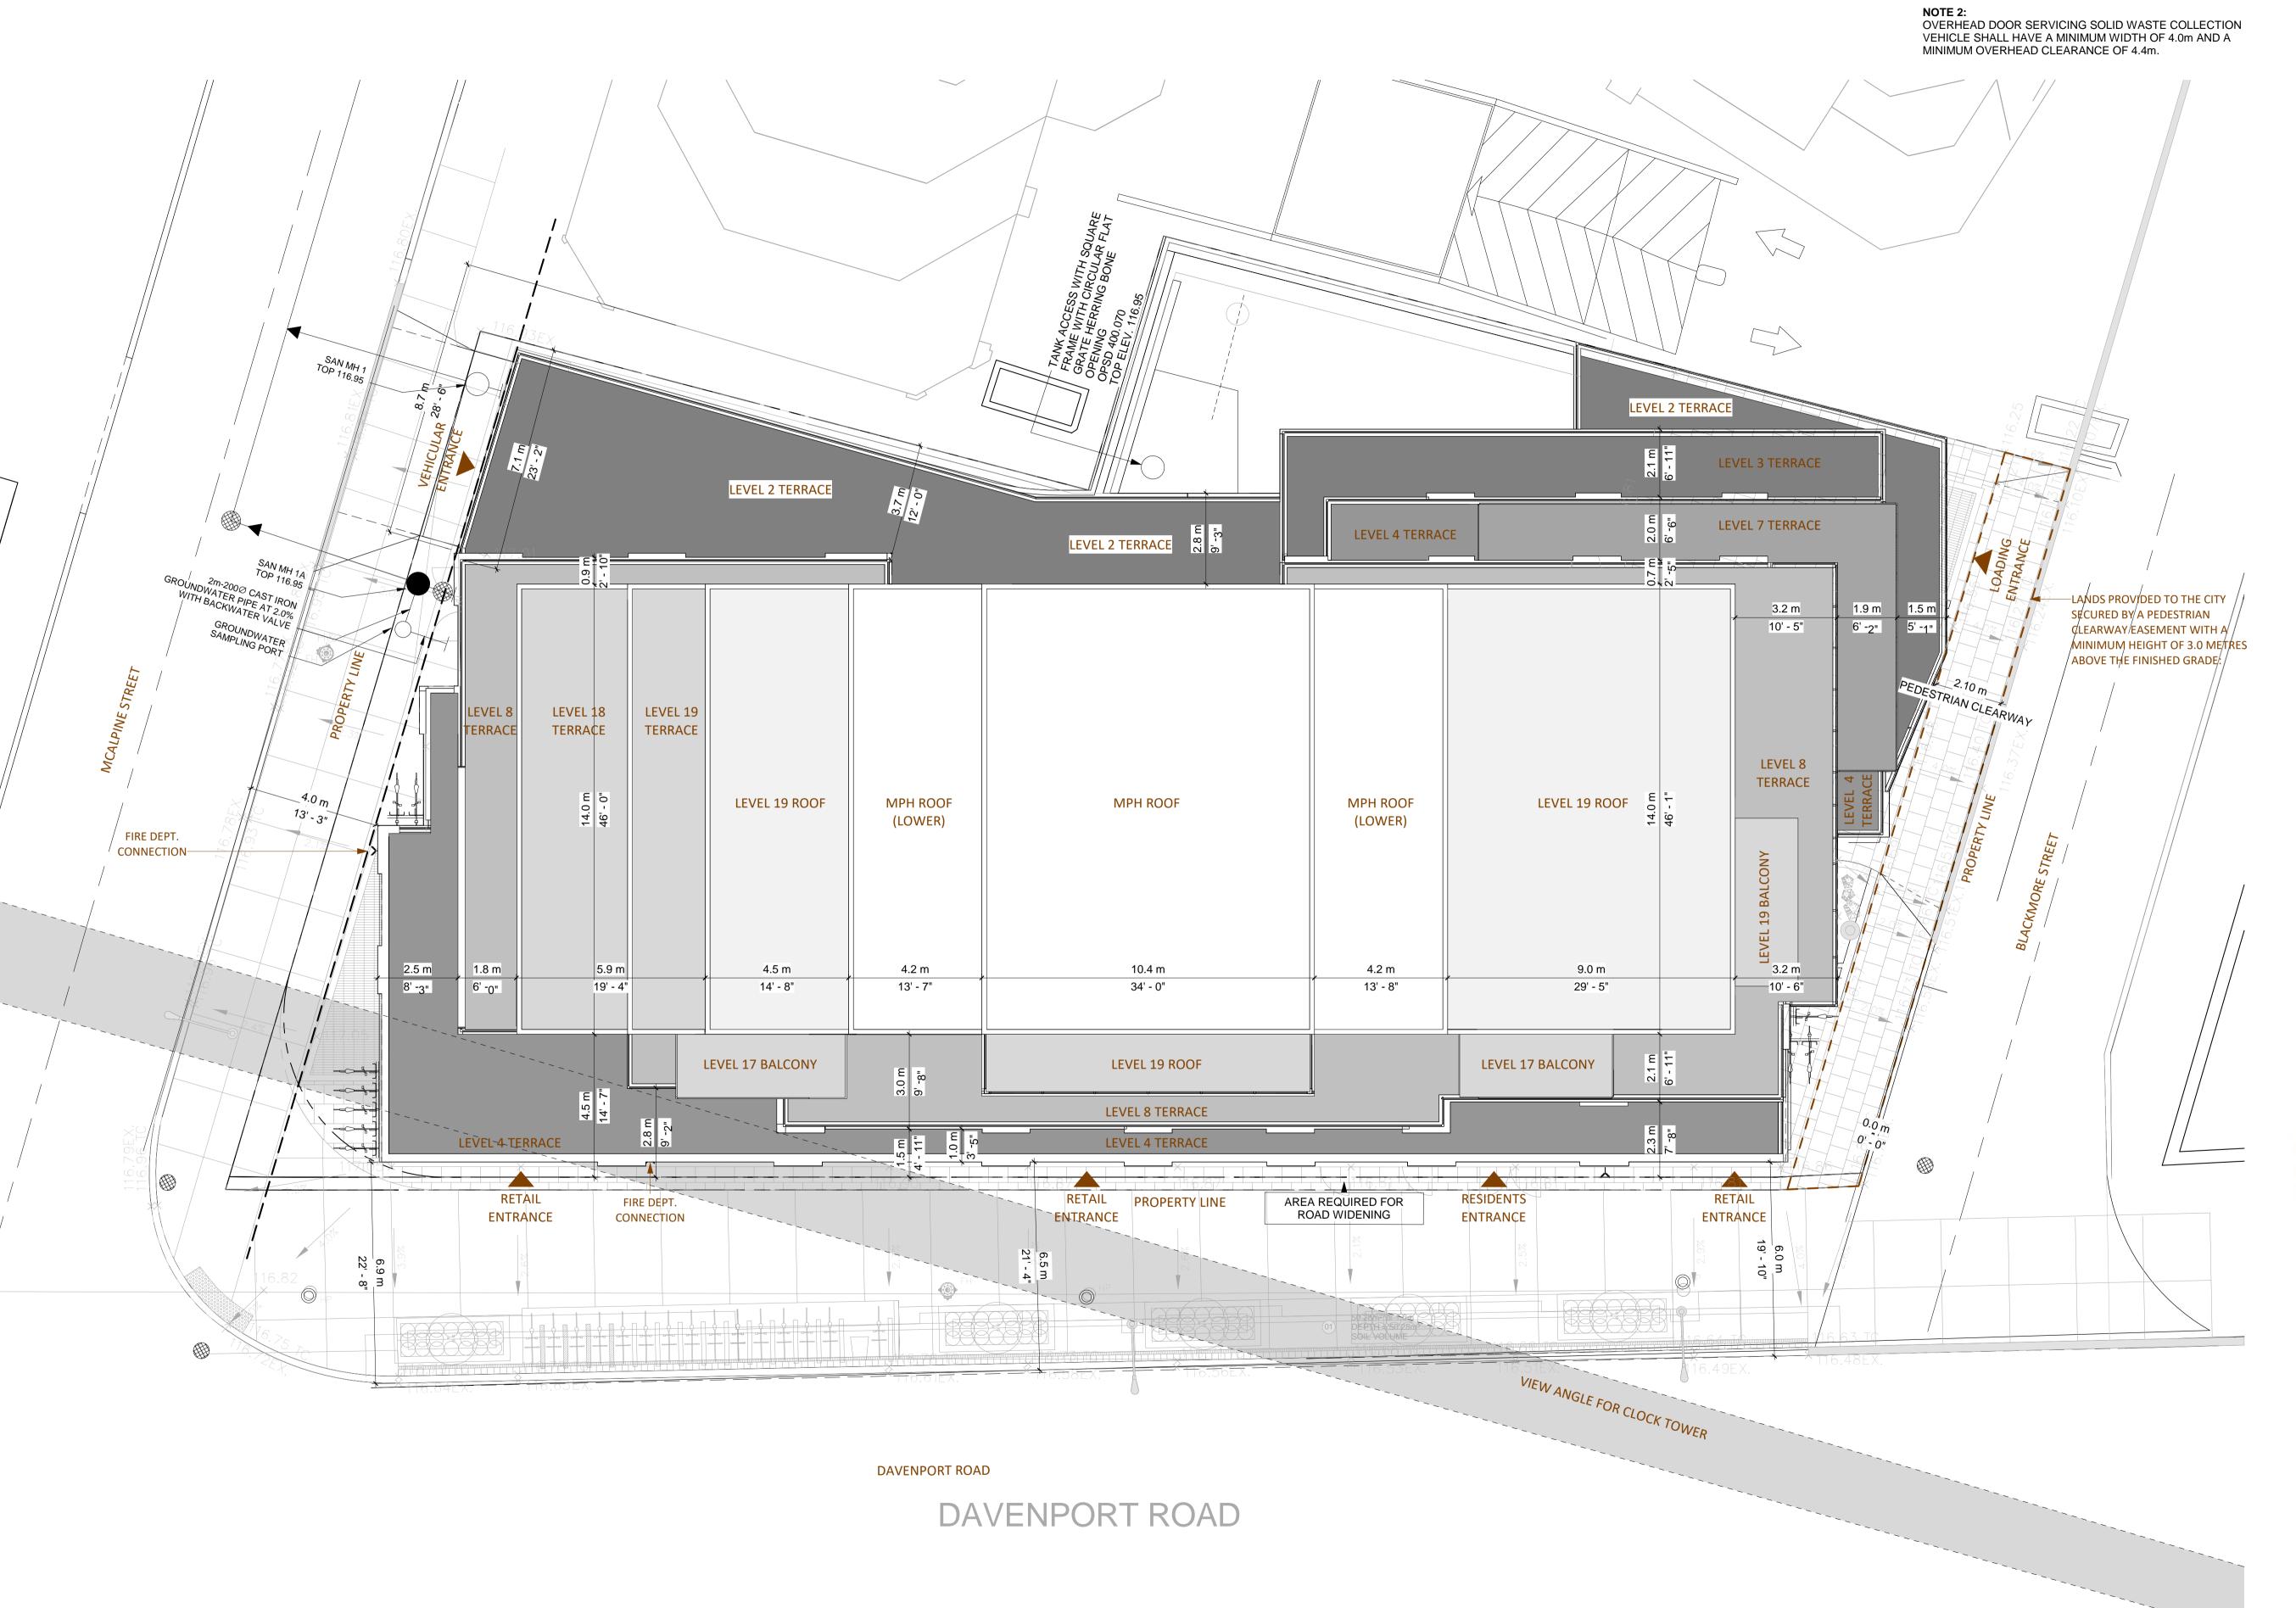

NOTE 1:
ALL ACCESS DRIVEWAYS USED BY SOLID WASTE COLLECTION

VEHICLE TO BE LEVEL (+/- 8%), HAVE A MINIMUM CLEAR HEIGHT OF 4.4m THROUGHOUT, 4.5m CLEAR WIDTH, AND 6.0m INGRESS/EGRESS.

- 1. ALL DIMENSIONS IN MILLIMETRES.
- 2. VERIFY ALL DIMENSIONS.
- 3. DO NOT SCALE DRAWINGS.
- 4. CHECK DRAWINGS AGAINST SPECIFICATIONS. 5. USE THE LATEST REVISED DRAWINGS ONLY. REPORT ANY DISCREPANCIES, DISCOVERED ERRORS, OR OMISSIONS, TO THE ARCHITECT BEFORE PROCEEDING.
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True North Project North

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scottarch.ca

Project

100 DAVENPORT


4⁄9@ Davenport Road, Toronto, ON.

Drawing

SITE PLAN


Project number	21302
Date	2020-12-22
Drawn by	DD
Checked by	AS

A 1.08

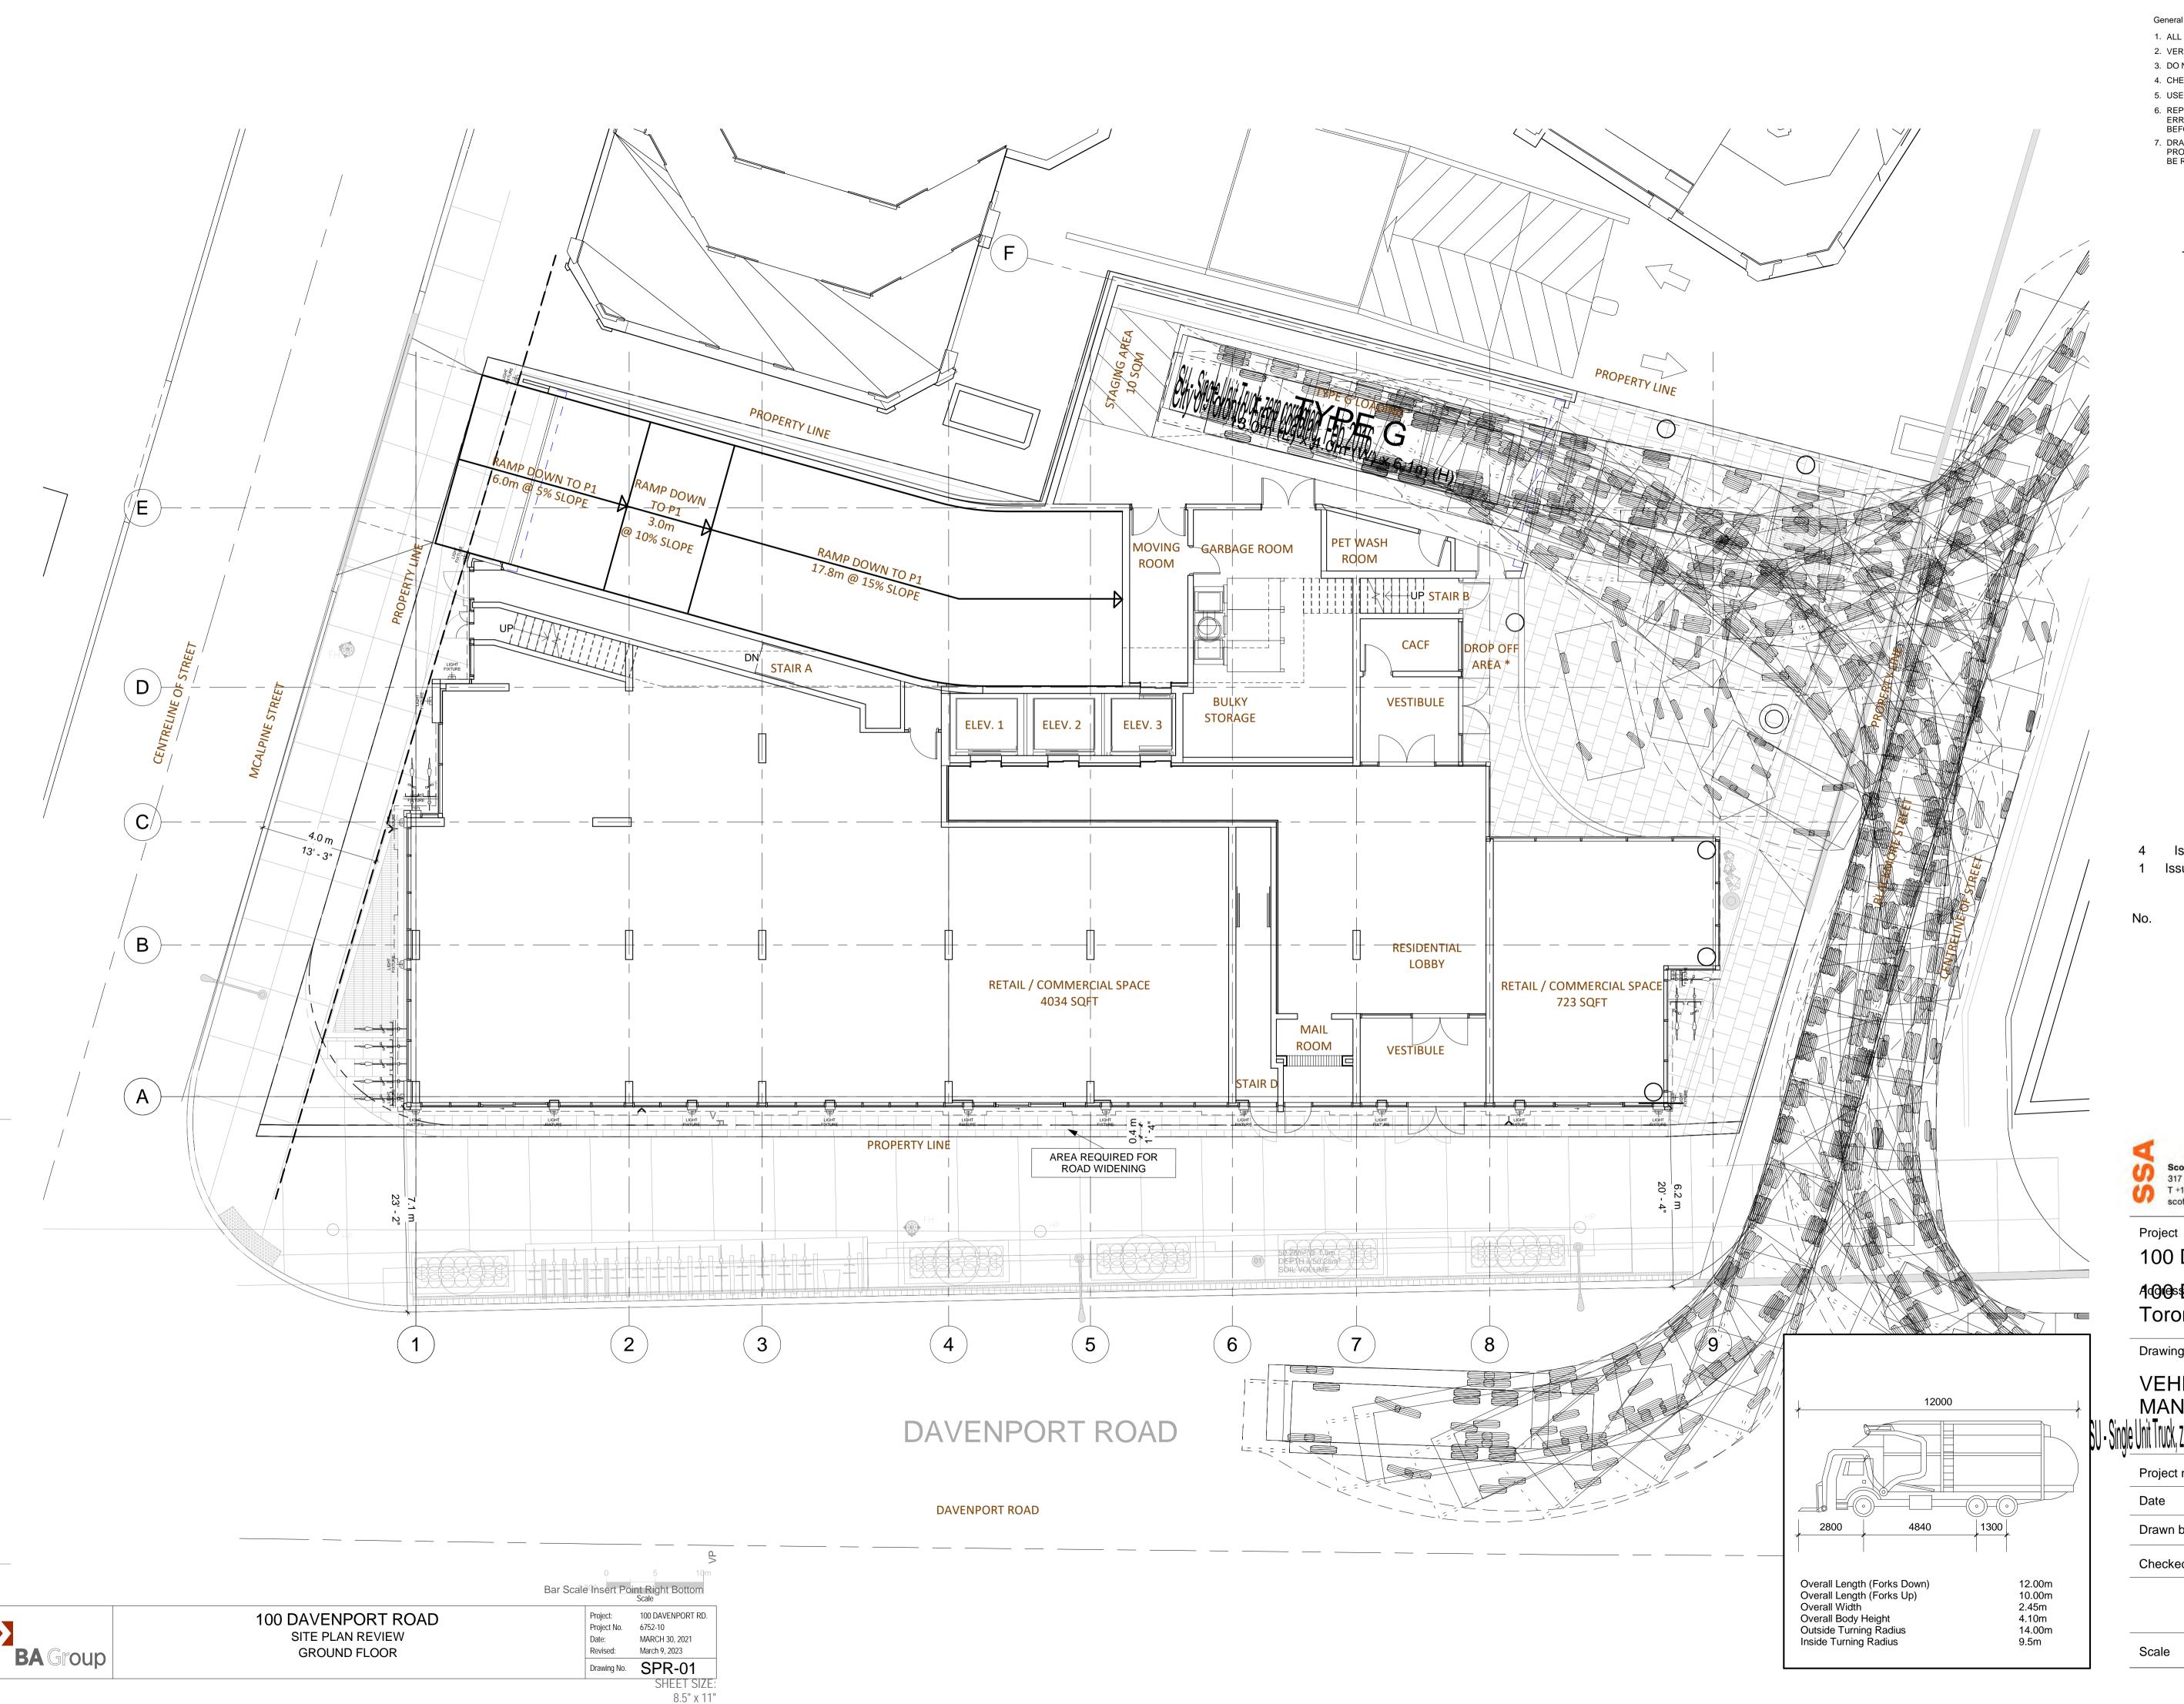

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Drawing

VEHICLE MANEUVERING J-Single Unit Truck, zero correction
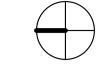
> 21302 Project number 2020-12-22 Drawn by Checked by

A 1.09

As indicated

NOTE 1:

CAR SHARE

TOTAL PER FLOOR

0 11 15 15 15 56

ELECTRIC VEHICLE INFRASTRUCTURE REQUIRED UNDER TGS TO PROVIDE 20% EV CHARGING STATIONS. STATIONS TO HAVE ELECTRIC VEHICLE SUPPLY EQUIPMENT.

STALLS IDENTIFIED FOR ELECTRIC VEHICLE CHARGING ARE LABELED: "EV CHARGING" BRAKEDOWN FOR REQUIRED EV CHARGING STALLS:

56 SPACES x 20% = 11.2 - 12 SPACES (10 RESIDENT SPACES; 1 RESIDENT VISITOR SPACES; 1 COMMERCIAL SPACE;)

NOTE 2:

ROUGH-IN FOR FUTURE ELECTRIC VEHICLE CHARGING TO CONSIST OF EMPTY ELECTRICAL CONDIUT WITH PULL STRINGS, EMBEDDED INTO THE CONCRETE WALL AT THE REAR OF EACH IDENTIFIED PARKING SPACE. CONDUIT LINE IS TO TIE BACK TO THEMAIN ELECTRICAL ROOM AND IS TO BE INSTALLED IN SUCH A WAY AS TO ALLOW FOR THE FUTURE INSTALLATION OF ALL

56 SPACES - 11 SPACES = 45 SPACES

NOTE 3:

DEDICATE PARKING SPACES ABOVE THE MINIMUM REQUIRED FOR LOW EMITTING VEHICLES (LEV)

STALLS LABELED AS: "DEDICATED TO LOW-EMITTING VEHICLES"

56 PROVIDED - 55 REQUIRED = 1 SPACE


General Notes

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Drawing

ACCESSIBLE PARKING

SPACE

TYPICAL

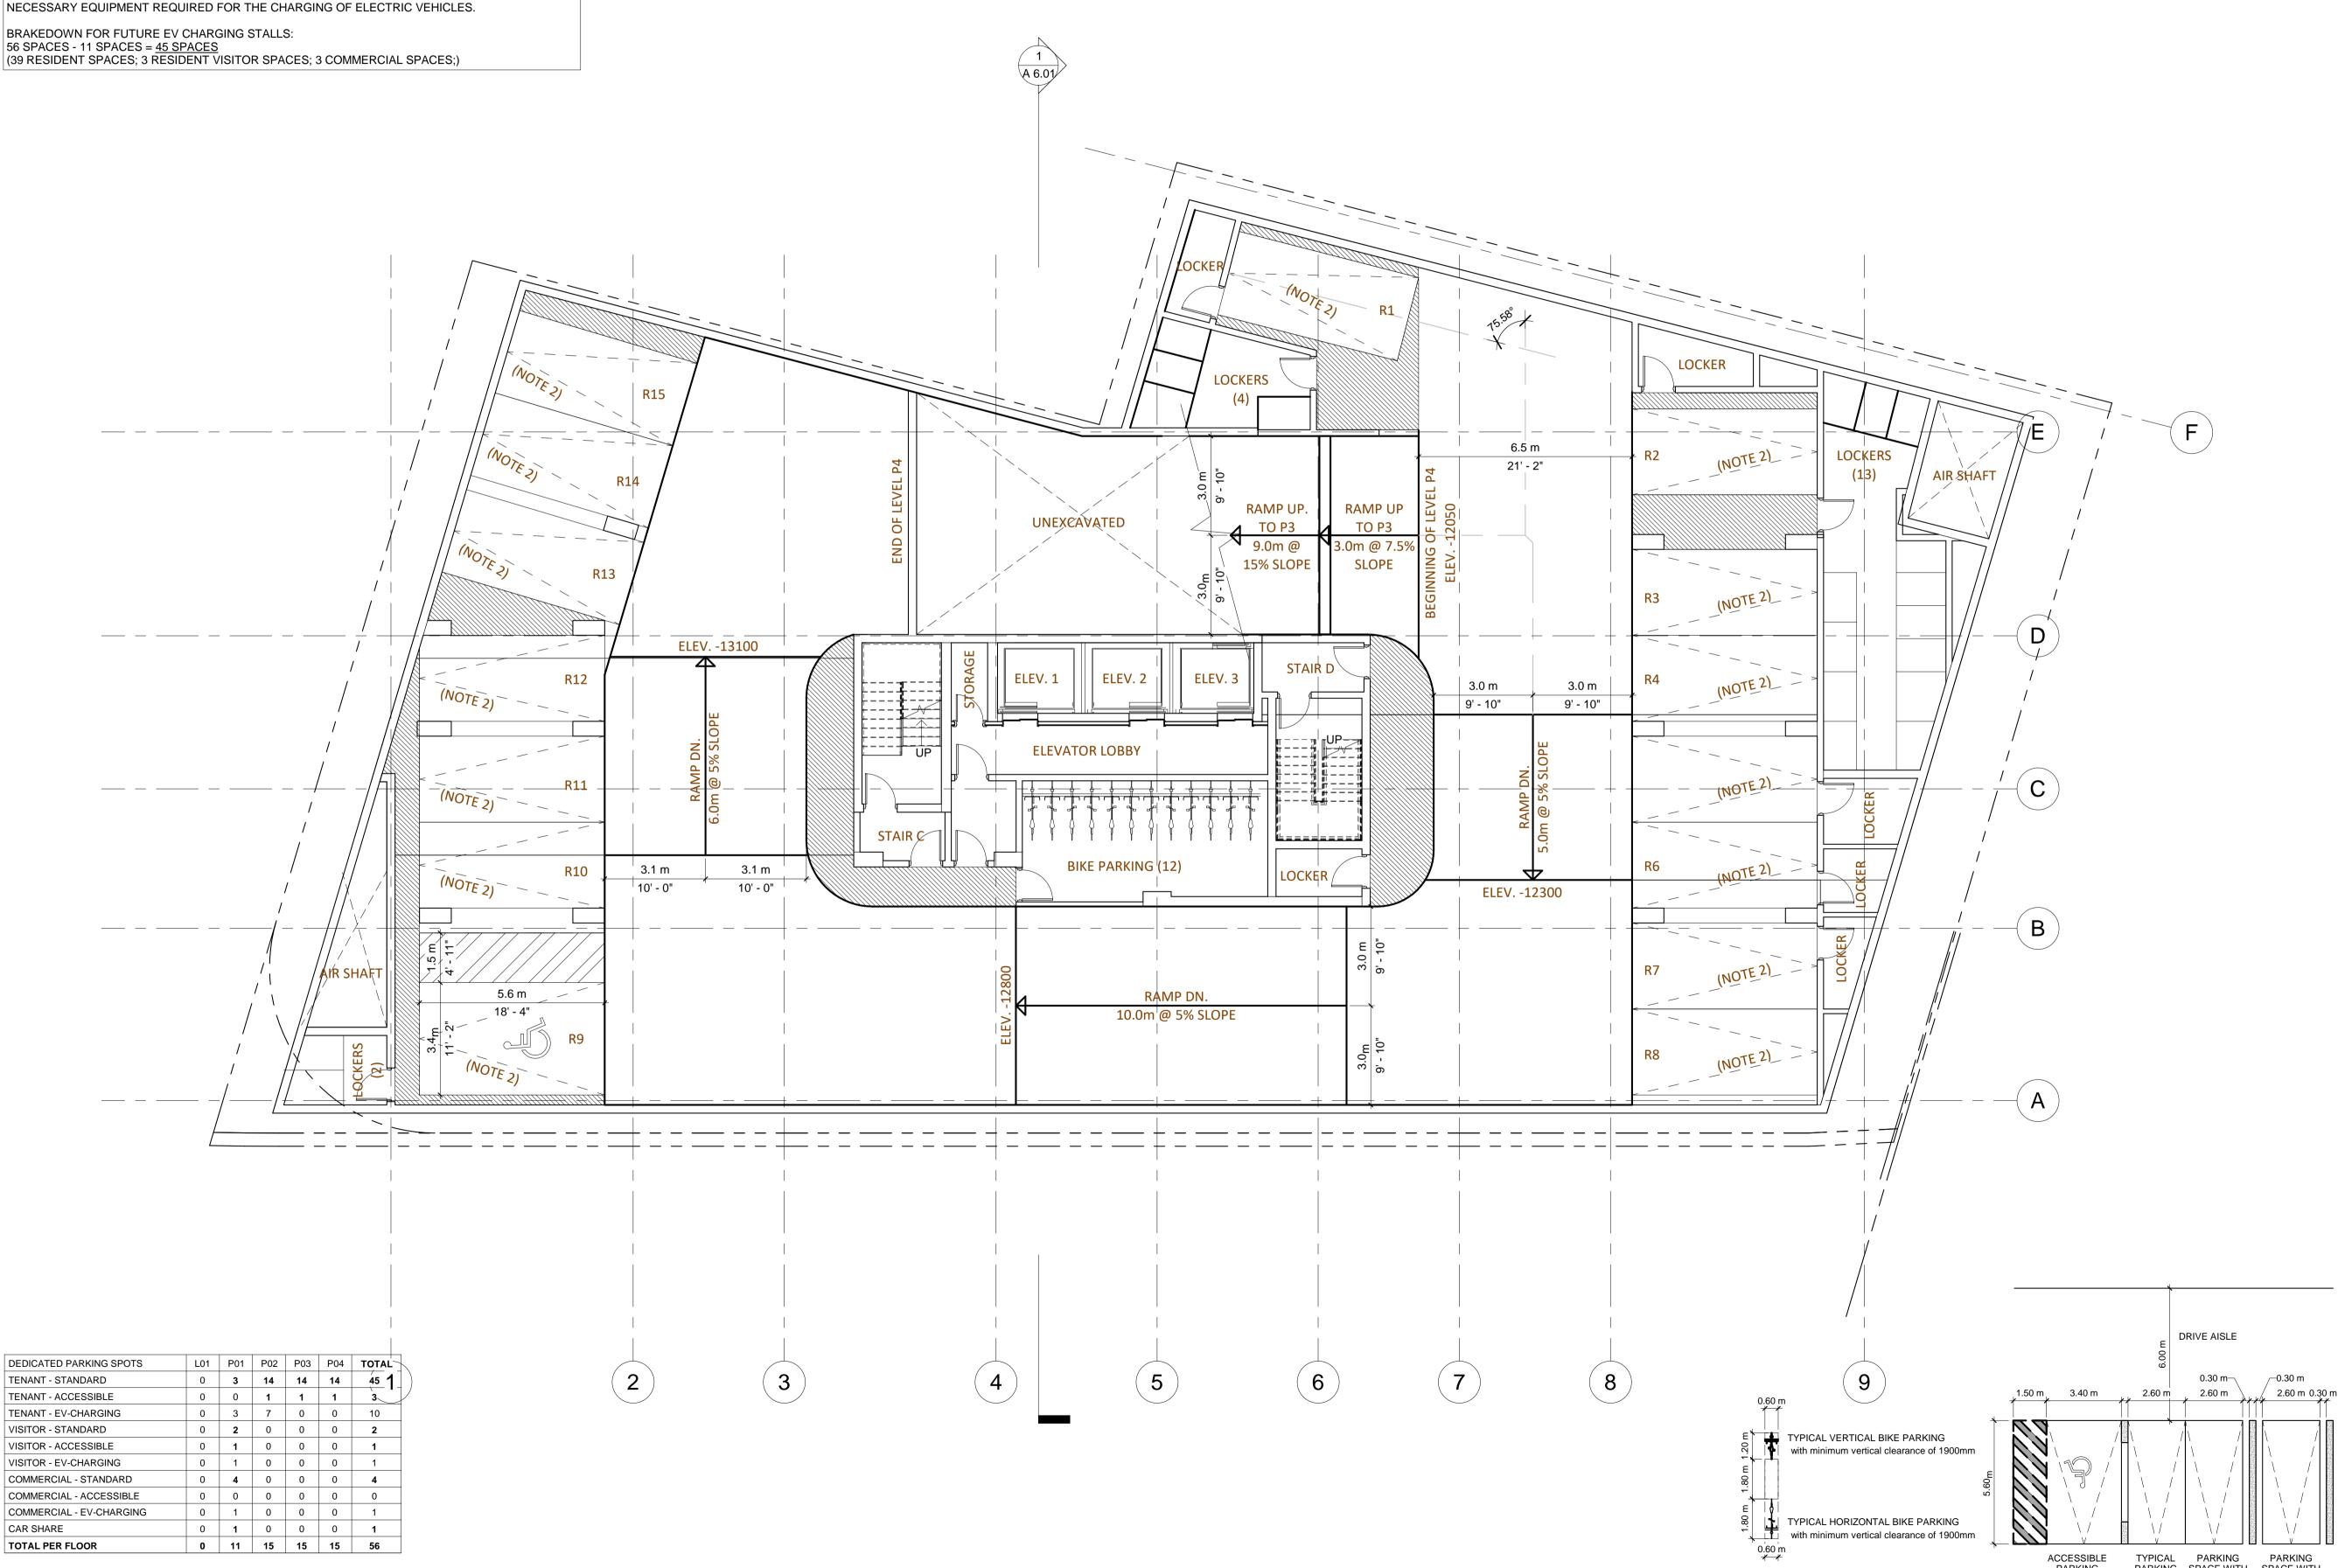PARKING

PARKING SPACE WITH SPACE WITH
SPACE OBSTRUCTIO OBSTRUCTION
N ONE SIDE EACH SIDE

P4 PLAN

Project number	21302
Date	2020-12-22
Drawn by	DD
Checked by	AS

A 2.01

Scale As indicated

DEDICATE PARKING SPACES ABOVE THE MINIMUM REQUIRED FOR LOW EMITTING VEHICLES (LEV) NOTE 3: "EV CHARGING" ELECTRIC VEHICLE INFRASTRUCTURE REQUIRED UNDER TGS TO PROVIDE 20% EV CHARGING STATIONS. STATIONS TO HAVE ELECTRIC VEHICLE SUPPLY EQUIPMENT. STALLS IDENTIFIED FOR ELECTRIC VEHICLE CHARGING ARE LABELED: BRAKEDOWN FOR REQUIRED EV CHARGING STALLS: 56 SPACES x 20% = 11.2 - 12 SPACES (10 RESIDENT SPACES; 1 RESIDENT VISITOR SPACES; 1 COMMERCIAL SPACE;) NOTE 1:

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NOTE 2:

STALLS LABELED AS: "DEDICATED TO LOW-EMITTING VEHICLES" 56 PROVIDED - 55 REQUIRED = 1 SPACE

General Notes

1. ALL DIMENSIONS IN MILLIMETRES.

2. VERIFY ALL DIMENSIONS.

3. DO NOT SCALE DRAWINGS.


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Project North True North



2023-05-12 2021-09-17

Date

21302

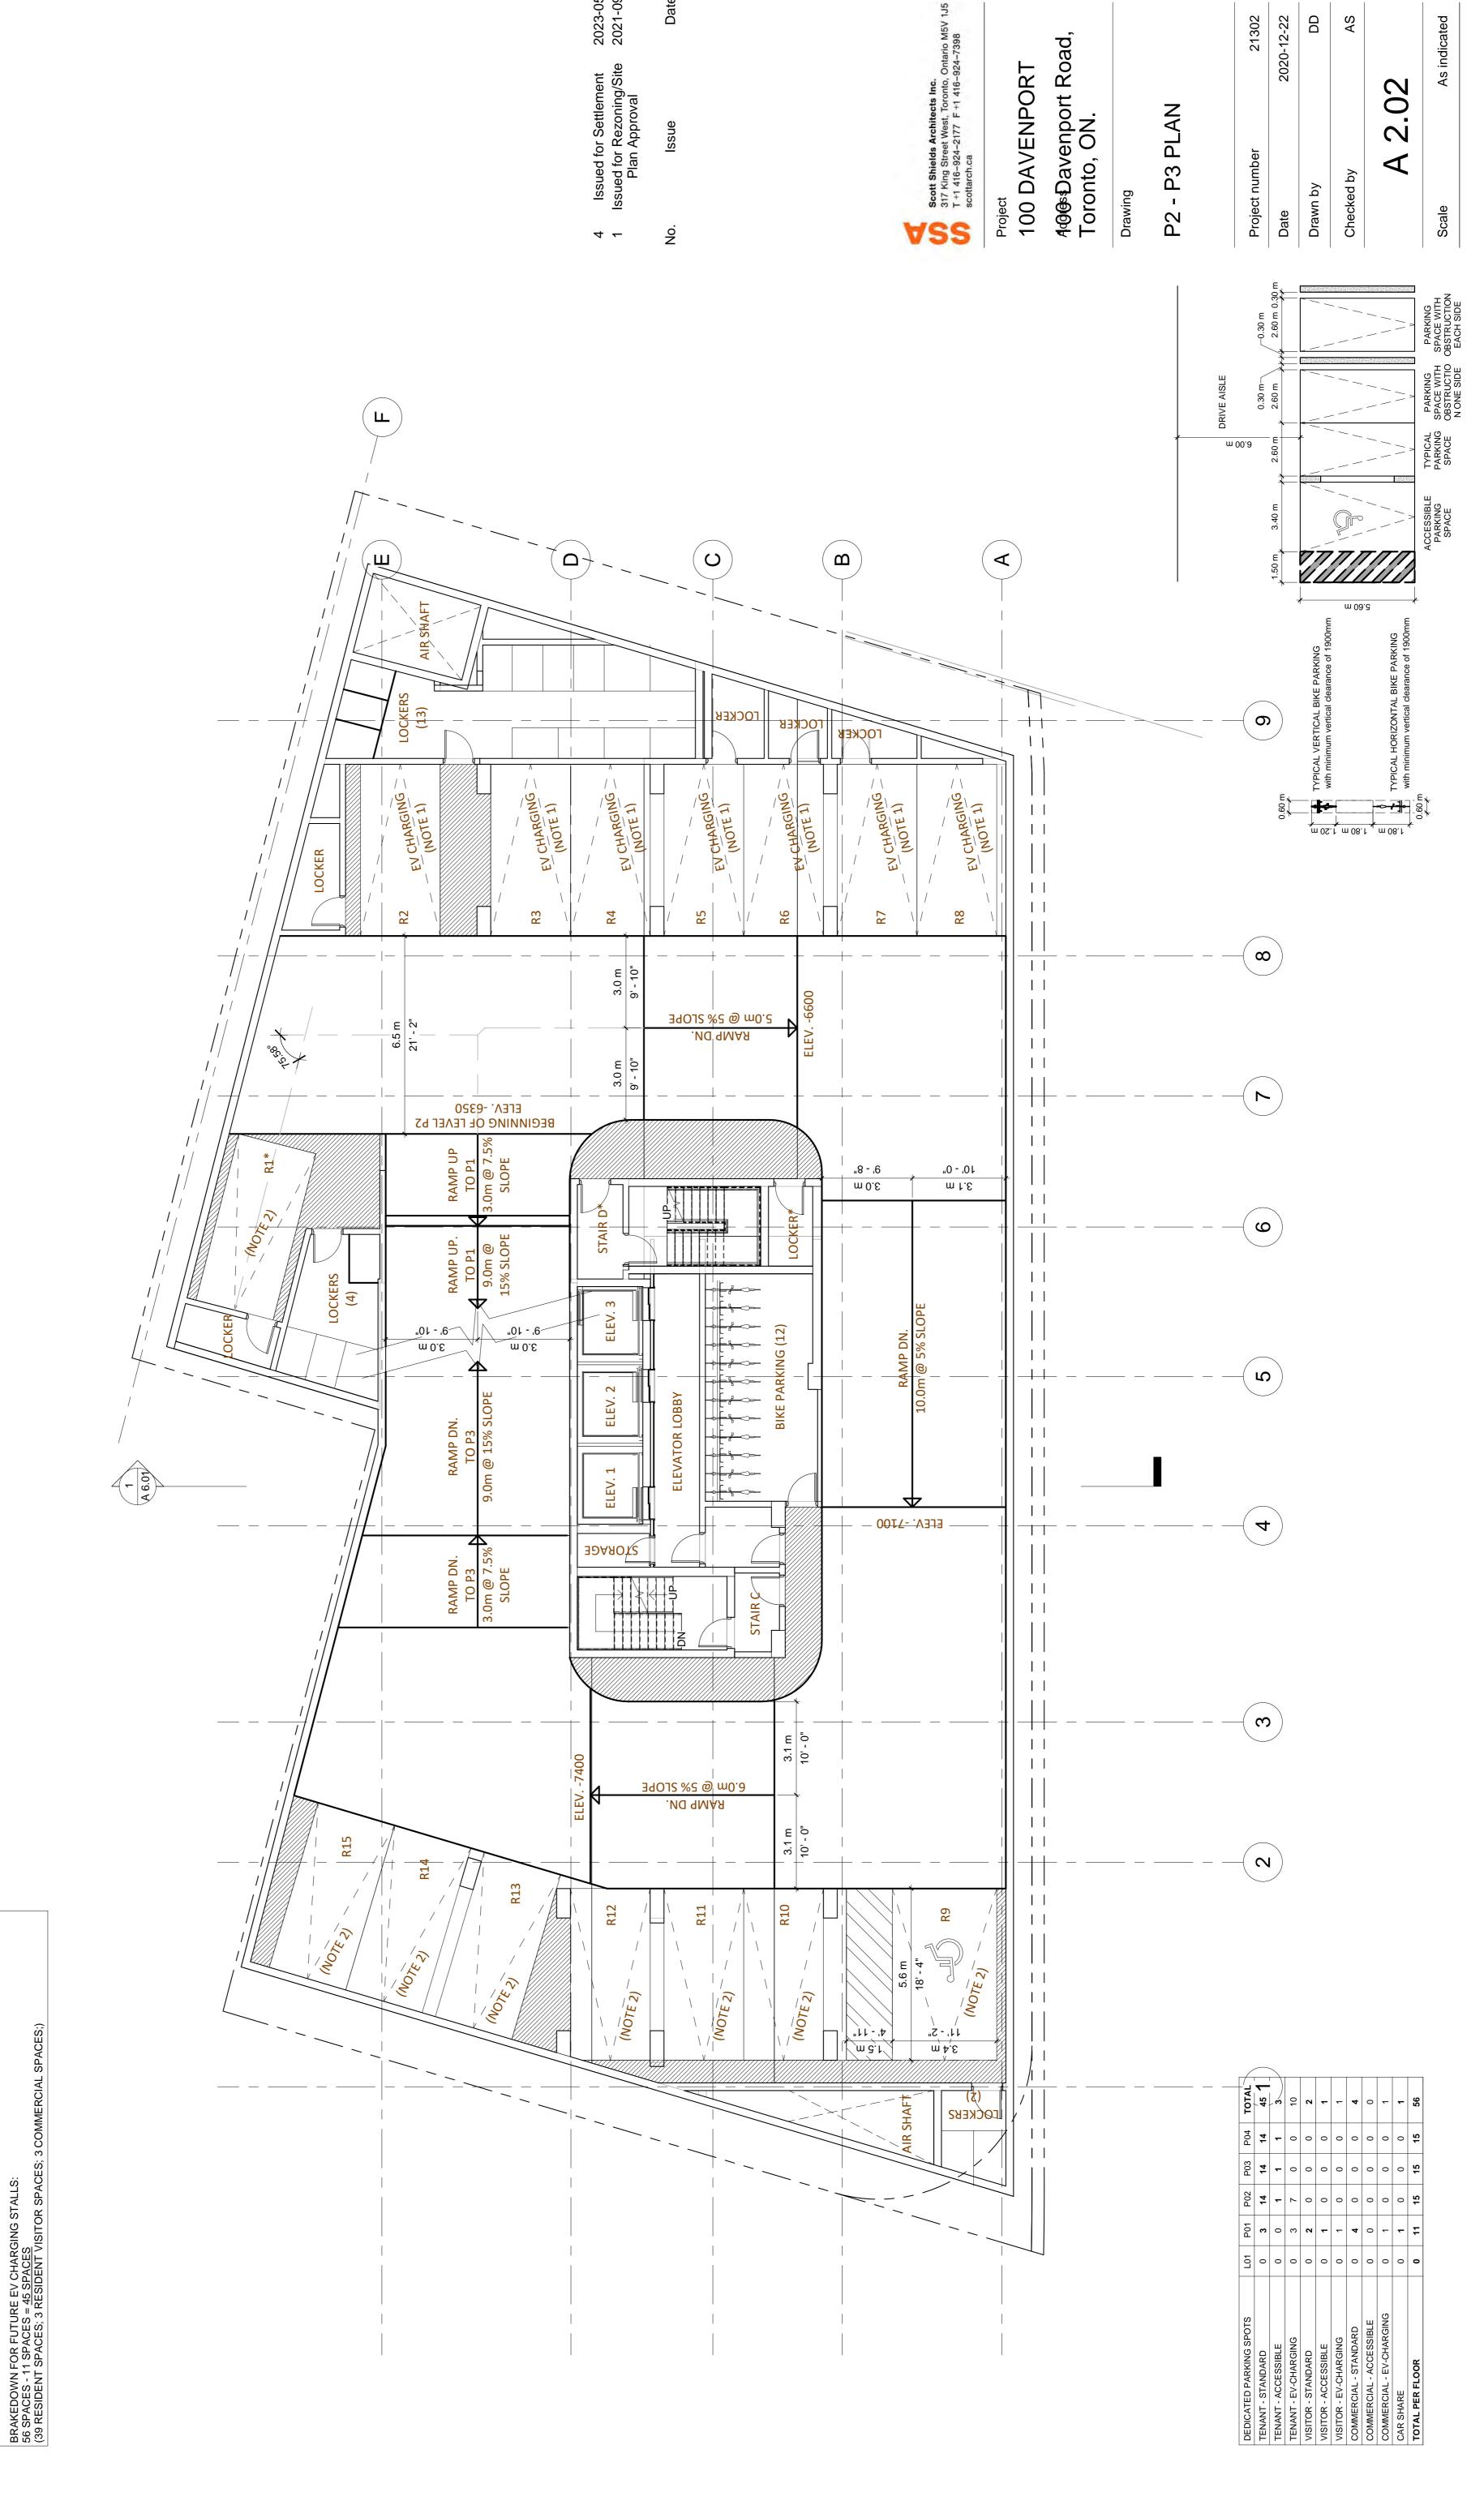DD

AS

"EV CHARGING" ELECTRIC VEHICLE INFRASTRUCTURE REQUIRED UNDER TGS TO PROVIDE 20% EV CHARGING STATIONS. STATIONS TO HAVE ELECTRIC VEHICLE SUPPLY EQUIPMENT. NOTE 1:

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NOTE 2:

BRAKEDOWN FOR FUTURE EV CHARGING STALLS: 56 SPACES - 11 SPACES = 45 SPACES (39 RESIDENT SPACES; 3 RESIDENT VISITOR SPACES; 3 COMMERCIAL SPACES;)

DEDICATE PARKING SPACES ABOVE THE MINIMUM REQUIRED FOR LOW EMITTING VEHICLES (LEV) STALLS LABELED AS: "DEDICATED TO LOW-EMITTING VEHICLES" 56 PROVIDED - 55 REQUIRED = 1 <u>SPACE</u>

General Notes

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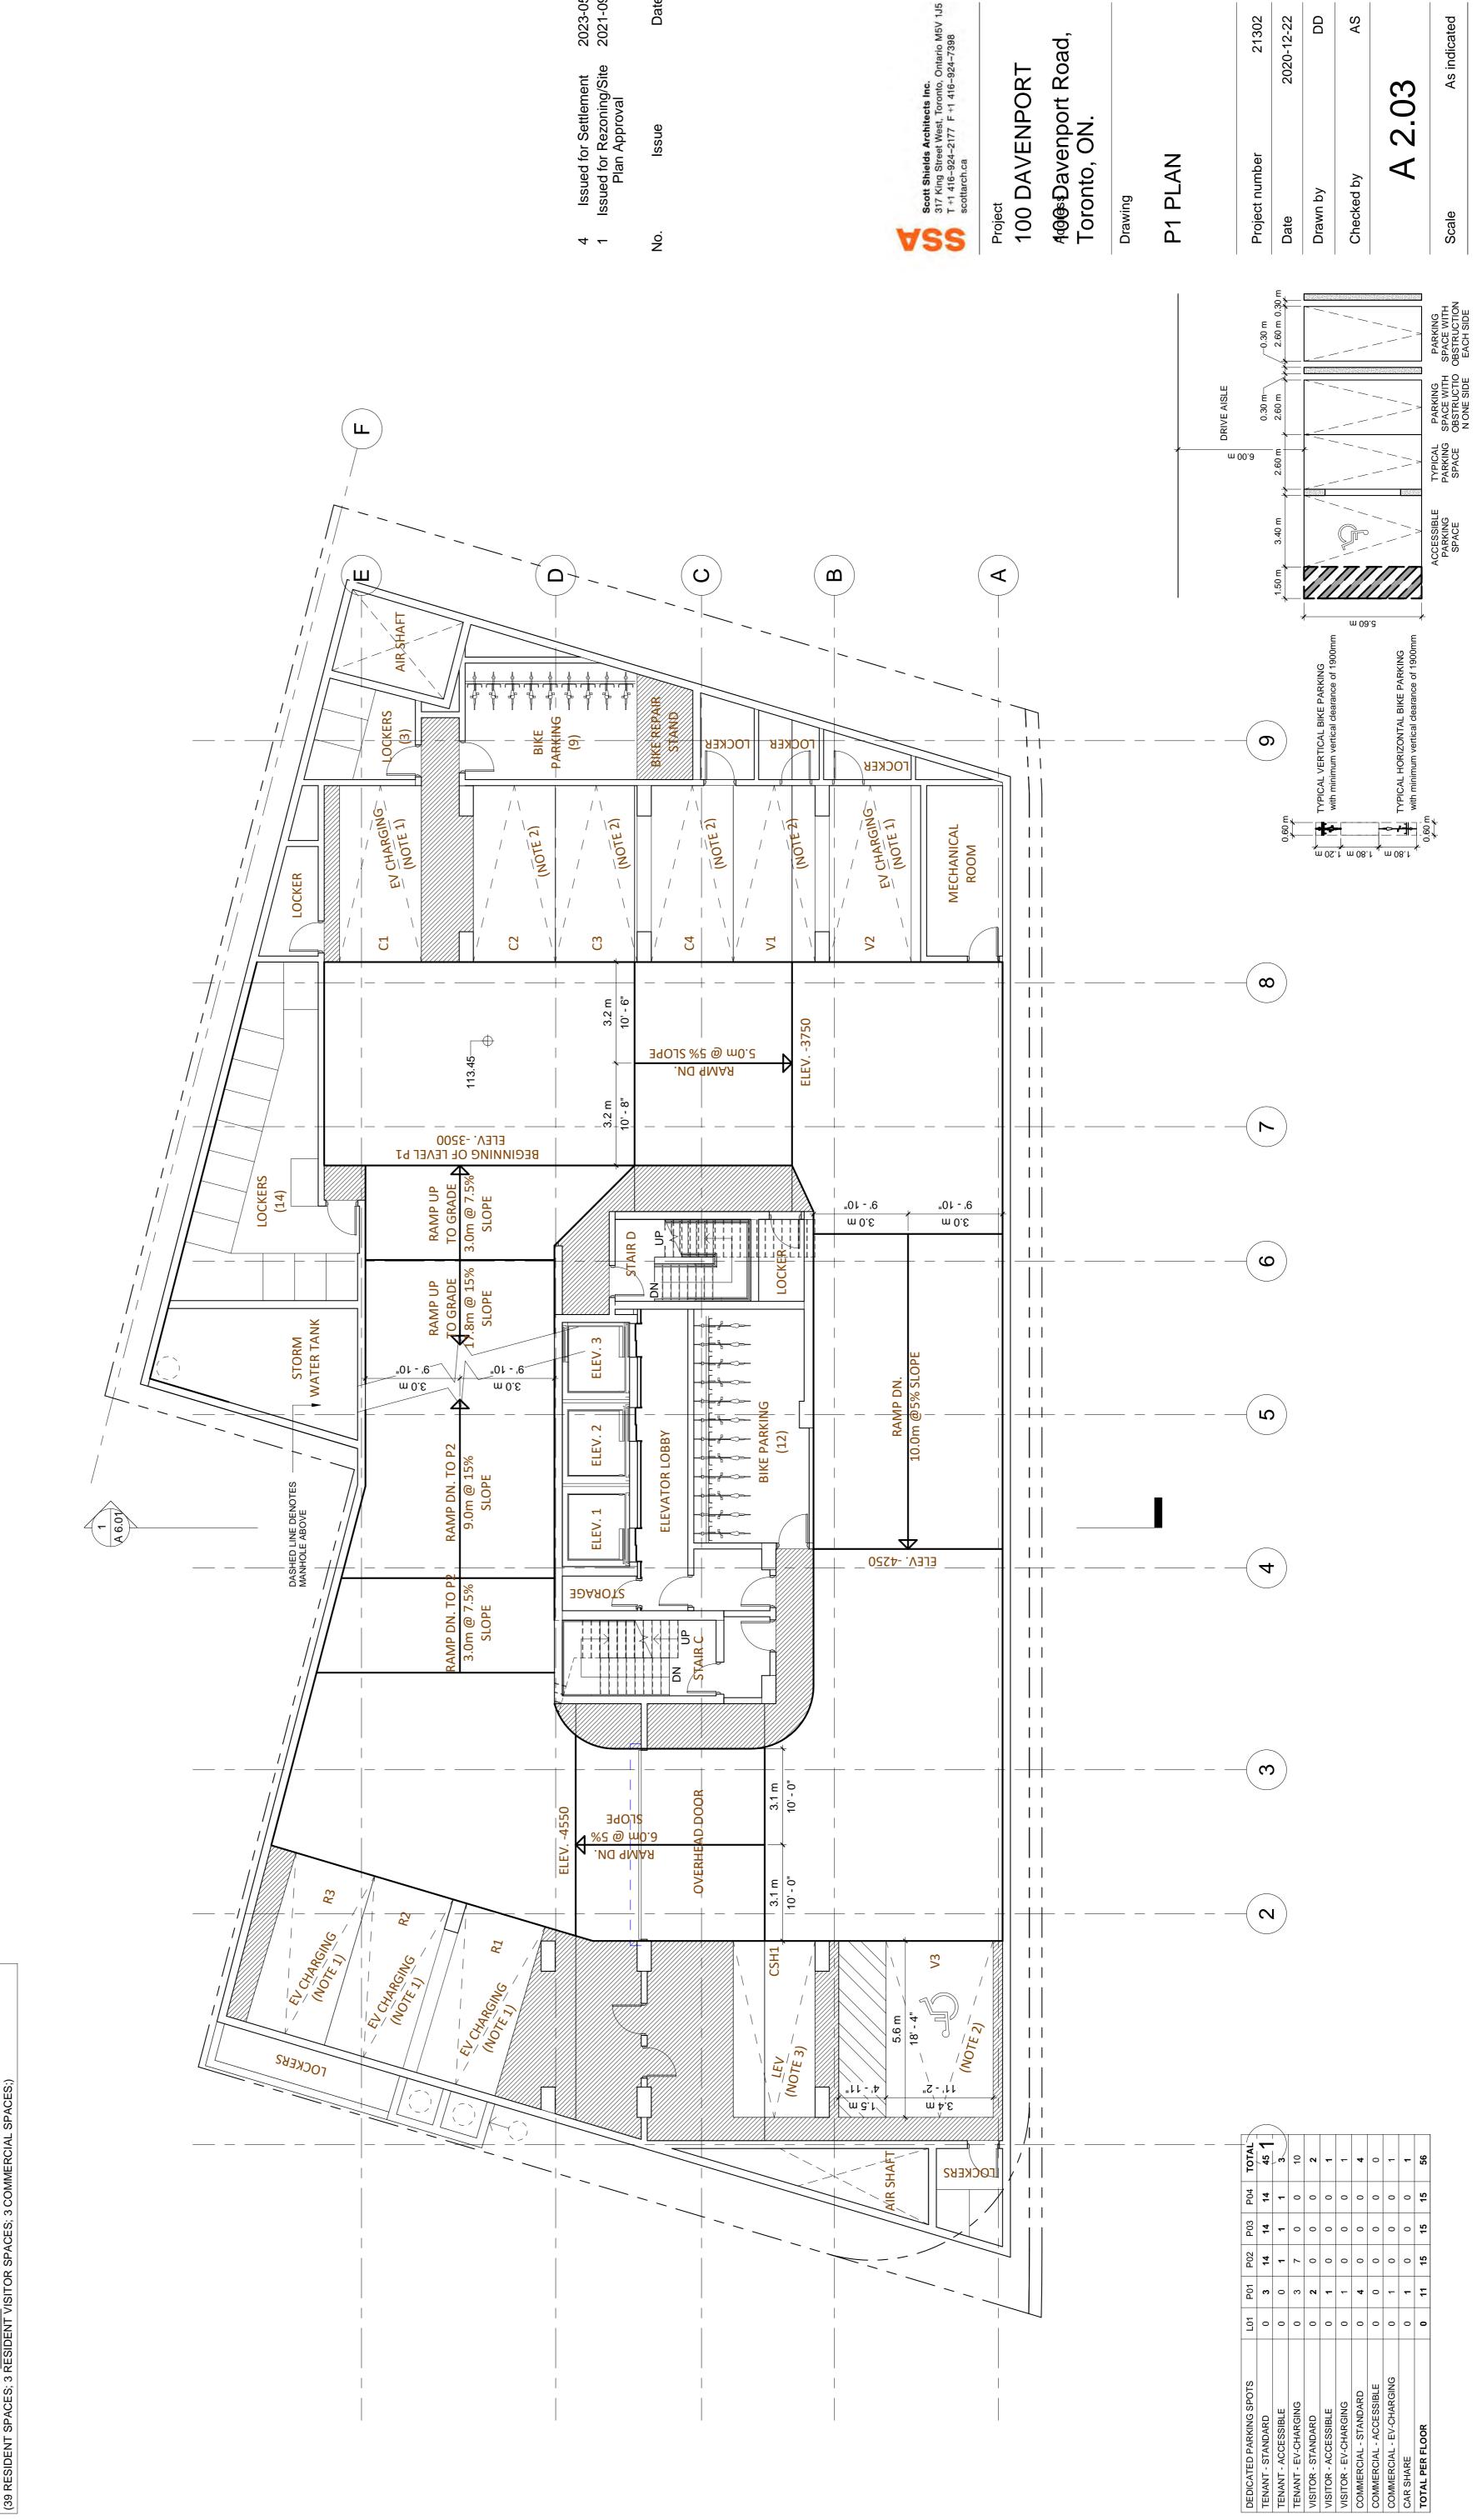
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Project North

True North



2023-05-12 2021-09-17

Date

21302

DD

2020-12-22

AS

As indicated

NOTE 4: BEFORE SOLID WASTE COLLECTION SERVICES ARE TO BEGIN, THE CITY SHALL BE PROVIDED WITH A LETTER CERTIFIED BY A STRUCTURAL ENGINEER THAT. IN ALL CASES WHERE A COLLECTION VEHICLE TO DRIVE OVER A SUPPORTED STRUCTURE (SUGH AS AN UNDERGROUND PARKING GARAGE), IT CAN SAFELY SUPPORT A FULLY LOADED COLLECTION VEHICLE

(35,000kg0 AND CONFORMS TO THE FOLLOWING: (a) DESIGN CODE - ONTARIO BUILDING CODE (b) DESIGN LOAD - CITY BULK LIFT VEHICLE IN ADDITION TO BUILDING CODE REQUIREMENTS (c) IMPACT FACTOR - 5% FOR MAX. VEHICULAR SPEEDS TO 15km/h AND 30% FOR HIGHER SPEEDS.

0 11 15 15 15 56

WILL LEAVE THE SITE AND NOT

COLLECTION DAY.

RETURN UNTIL THE NEXT SCHEDULED

NOTE 5:

ALL ACCESS DRIVEWAYS USED BY SOLID WASTE A TRAINED ON-SITE STAFF MEMBER COLLECTION VEHICLE TO BE LEVEL (+/- 8%), HAVE A WILL BE AVAILABLE TO MANOUVER MINIMUM CLEAR HEIGHT OF 4.4m THROUGHOUT, BINS FOR THE COLLECTION DRIVER AND ALSO ACT AS A FLAGMAN WHEN 4.5m CLEAR WIDTH, AND 6.0m INGRESS/EGRESS. TRUCK IS REVERSING. IN THE EVENT THAT ON-SITE STAFF ARE UNAVAILABLE AT THE TIME THE CITY NOTE 7: COLLECTION VEHICLE ARRIVES AT THE SITE, THE COLLECTION VEHICLE

NOTE 6:

OVERHEAD DOOR SERVICING SOLID WASTE COLLECTION VEHICLE SHALL HAVE A MINIMUM WIDTH OF 4.0m AND A MINIMUM OVERHEAD CLEARANCE OF 4.4m.

NOTE 8:

*CITY OF TORONTO REQUIREMENTS FOR GARBAGE, RECYCLING AND ORGANICS COLLECTION SERVICES FOR NEW DEVELOPMENT AND REDEVELOPMENT.

25sgm FOR THE FIRST 50 units + 13sgm FOR EACH ADDITIONAL 50 units+10sgm FOR **BULKY STORAGE**

REQUIRED: 25.00 sqm + 10.00 sqm = 35.00 sqmPROPOSED: 34.5 sgm + 10.3 sgm = 44.8 sgm

PROPOSED SYSTEM IS SINGLE CHUTE WITH TRI-SORTER. ALL BINS TO BE 3 CUBIC YARD CONTAINERS. BINS DESIGNATION: G=GARBAGE; R=RECYCLING; O=ORGANIC;

NOTE 9:

NON-RESIDENTIAL WASTE COLLECTION WILL BE SCHEDULED ON DIFFERENT DAYS THAN SCHEDULED RESIDENTIAL COLLECTION TO ENSURE THAT "TYPE G" SPACE IS VACANT FOR CITY WASTE COLLECTION.

COMMERCIAL WASTE CONTAINERS/BINS SHALL BE LABELLED "RETAIL WASTE ONLY" AND SHALL NOT SHARE RESIDENTIAL CONTAINERS/BINS.

NOTE 10:

STAGING AREA SIZE WHEN WASTE STORAGE IS REMOTE FROM "TYPE G" SPACE: 0m2 FOR FIRST 50 UNITS + 5m2 FOR EACH ADDITIONAL 50 UNITS

REQUIRED: 0.00 m2

PROVIDED: 0.00 m2

TYPE G LOADING SPACE HAS AN UNENCUMBERED VERTICAL CLEARANCE OF 6.1 METRES, IS LEVEL (+-2%), AND IS CONSTRUCTED OF A MINIMUM OF 200 MM REINFORCED CONCRETE.



General Notes


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BEFORE PROCEEDING.





4. CHECK DRAWINGS AGAINST SPECIFICATIONS.

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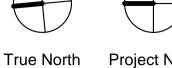
6. REPORT ANY DISCREPANCIES, DISCOVERED

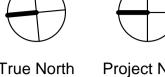
7. DRAWINGS AND SPECIFICATIONS ARE THE

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BE RETURNED UPON COMPLETION OF WORK.

ERRORS, OR OMISSIONS, TO THE ARCHITECT



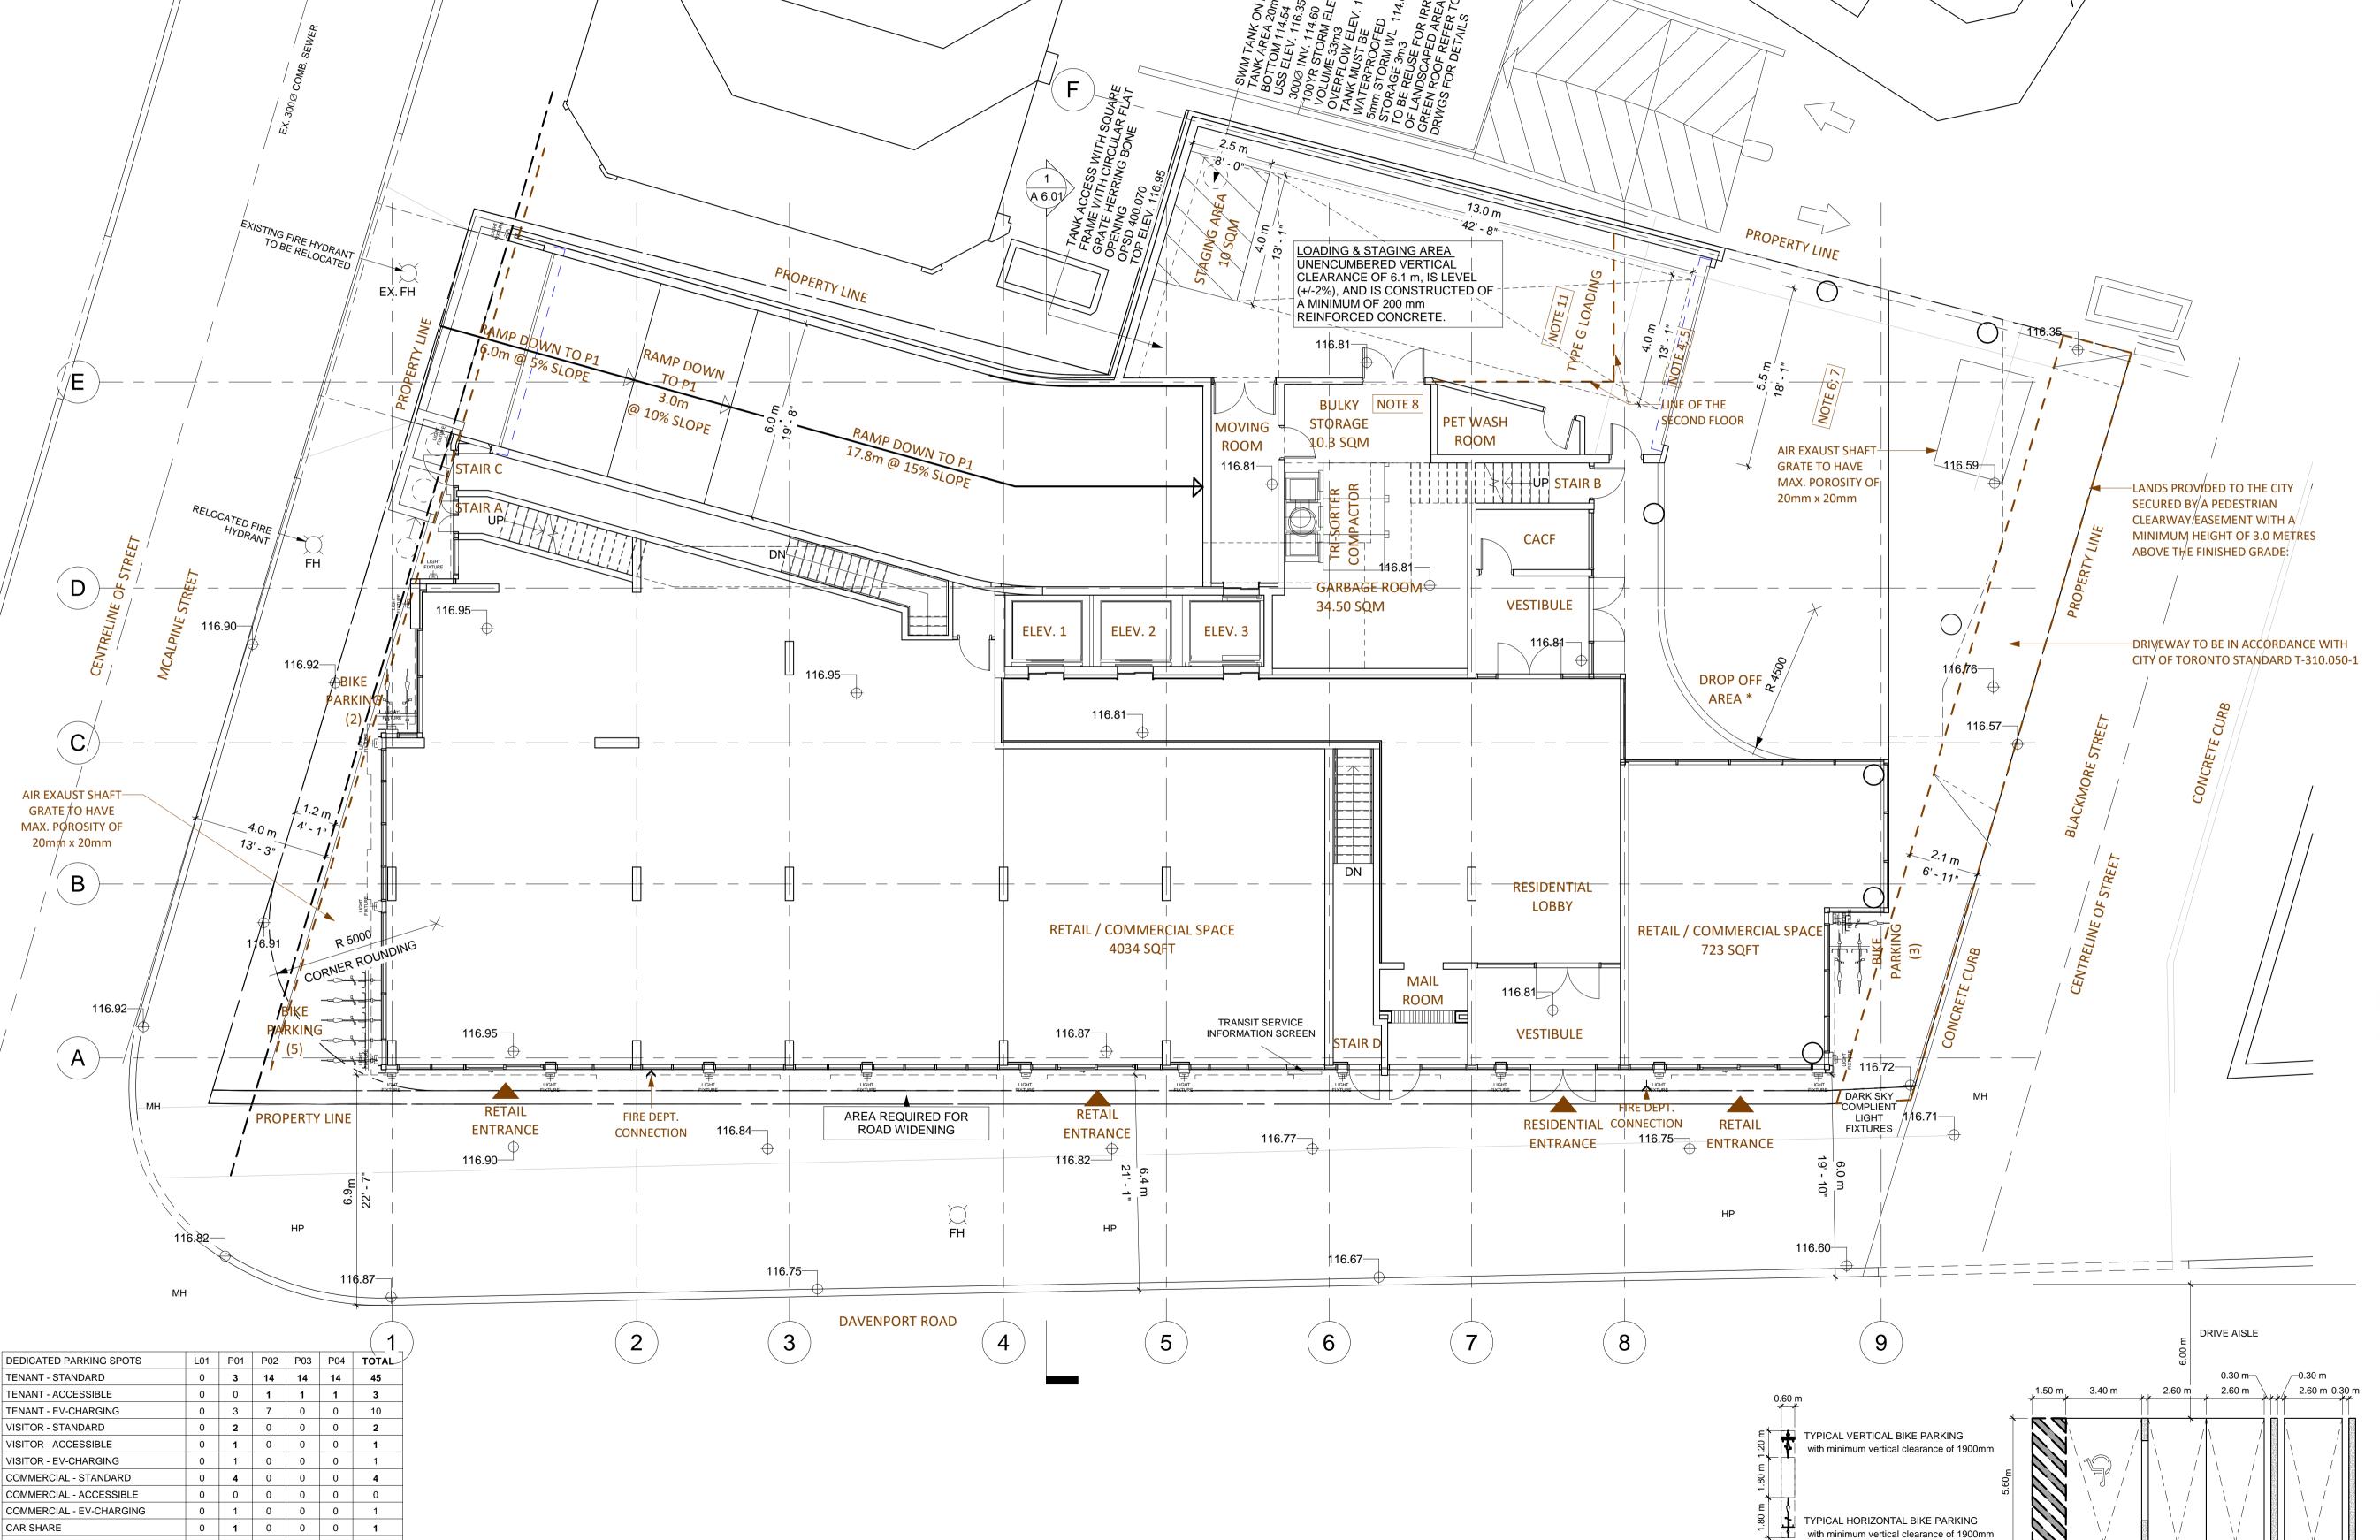

CENTRELINE OF STREET

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100 DAVENPORT

4⁄9@sDavenport Road, Toronto, ON.

Drawing

TYPICAL

SPACE

PARKING PARKING SPACE WITH SPACE WITH SPACE OBSTRUCTION

GROUND FLOOR PLAN

Project number	21302
Date	2020-12-22
Drawn by	DD
Checked by	AS

A 4.01

As indicated

Green Roof Statistics

The Green Roof Statistics Template is required to be submitted for Site Plan Control Applications where a green roof is required under the Toronto Municipal Code Chapter 492, Green Roofs. Complete the table below and copy it directly onto the Roof Plan submitted as part of any Site Plan Control Application requiring a green roof in accordance with the Bylaw. Refer to Section § 492-1 of the Municipal Code for a complete list of defined terms, and greater clarity and certainty regarding the intent and application of the terms included in the template. The Toronto Municipal Code Chapter 492, Green Roofs can be found online at: http://www.toronto.ca/legdocs/municode/1184_492.pdf

Green Roof Statistics



DAVENPORT ROAD

CENTRELINE OF STREET

General Notes

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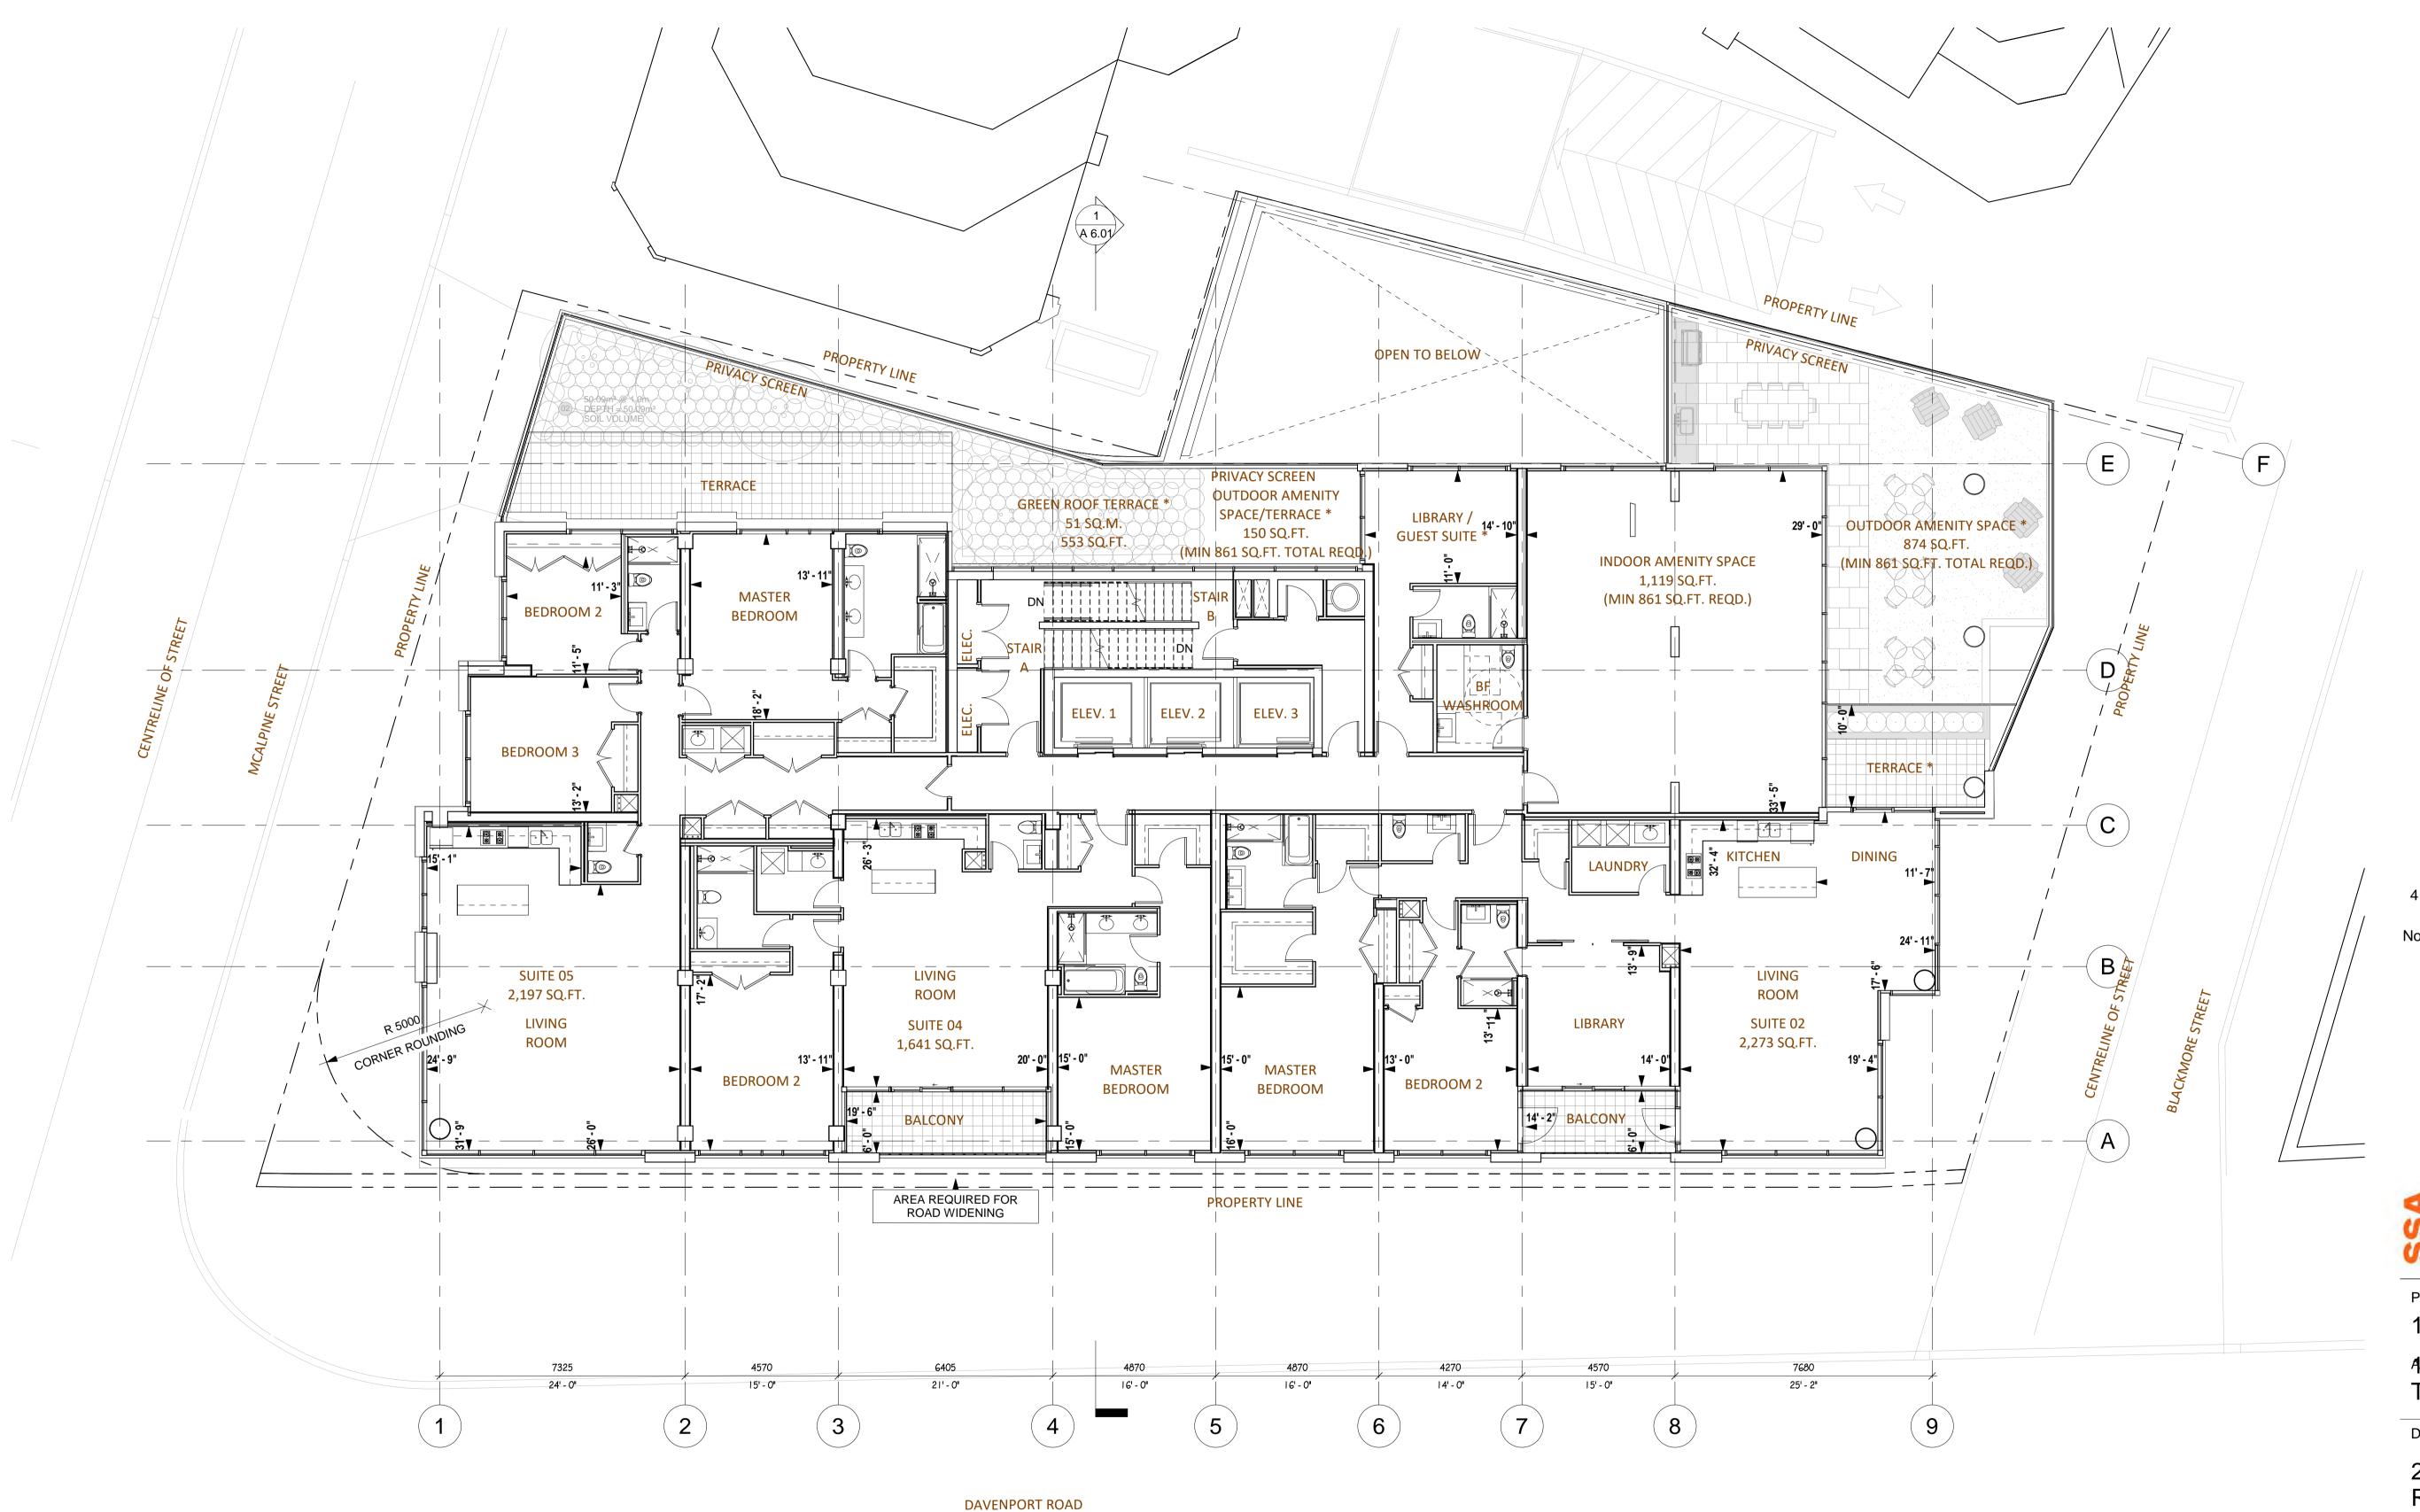
4⁄9**@**Davenport Road, Toronto, ON.

Drawing

2ND FLOOR PLAN COMMERCIAL OPTION

Projec	ct number	21302
Date		2020-12-22
Drawr	n by	YB
Check	ked by	AS

A 4.02a




CENTRELINE OF STREET

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BEFORE PROCEEDING.



True North Project North

4 Issued for Settlement 2023-05-12

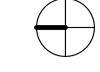No. Issue

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Project

100 DAVENPORT

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Drawing

2ND FLOOR PLAN RESIDENTIAL OPTION

Project number 21302

Date 2020-12-22

Drawn by Author

Checked by Checker

A 4.02b

Scale 1:100

Green Roof Statistics

The Green Roof Statistics Template is required to be submitted for Site Plan Control Applications where a green roof is required under the Toronto Municipal Code Chapter 492, Green Roofs. Complete the table below and copy it directly onto the Roof Plan submitted as part of any Site Plan Control Application requiring a green roof in accordance with the Bylaw. Refer to Section § 492-1 of the Municipal Code for a complete list of defined terms, and greater clarity and certainty regarding the intent and application of the terms included in the template. The Toronto Municipal Code Chapter 492, Green Roofs can be found online at: http://www.toronto.ca/legdocs/municode/1184_492.pdf

Green Roof Statistics

Gross Floor Area, as defined in Green Roof Bylaw (m²) Total Roof Area (m²) Area of Residential Private Terraces (m²) Rooftop Outdoor Amenity Space, if in a Residential Building (m²) Area of Renewable Energy Devices (m²) N/A				< , \ \	
Tower (s)Roof Area with floor plate less than 750 m ² Total Available Roof Space (m ²) Green Roof Coverage Coverage of Available Roof Space (m ²) Coverage of Available Roof Space (%) Required 268.11 322.87 Coverage of Available Roof Space (%) 50% 60.21%					
	PROPE			PROPERTY LINE	
	PROPERTY LINE	1 A 6.01	PRIVACY SCREEN	PRIVACY SCREEN F	
			LOGGIA*	LOGGIA*	60'-6" F
				13'-11"	15' - 3"
11'-3" BEDROOM 2	MASTER BEDROOM	STAIR B	BEDROOM 2 BEDROOM 2	BEDROOM V	
		STAIR A		SUITE 01 1,948 SQ.FT	
BEDROOM 3		ELEV. 1 ELEV. 2 ELEV. 3			
					- / C
	STUDY/LIBRARY 13'-11"	7'-5"	LAUN	DINING 11'-	
SUITE 04 2,192 SQ.FT.	LIVING		LIBRARY	LIVING ROOM	B
CORNER ROUNDING LIVING ROOM	SUITE 03 1,630 SQ.FT.	MASTER MASTER	BEDROOM 2	SUITE 02 2,261.99 SQ.FT. 19'-4"	
	13'-11" BALCONY	BEDROOM 15'-0" BEDROOM	15' - 0" 13' - 1" 14' - 10" BALCONY		
	AREA REQUIRED F ROAD WIDENING	FOR PROPERTY LINE			
1	2 3	4	6 7	8	9

- General Notes 1. ALL DIMENSIONS IN MILLIMETRES.
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Project

100 DAVENPORT

4⁄9**@**•Davenport Road, Toronto, ON.

Drawing

3RD FLOOR PLAN

Project number	21302
Date	2020-12-22
Drawn by	YB
Checked by	AS

A 4.03

The Green Roof Statistics Template is required to be submitted for Site Plan Control Applications where a green roof is required under the Toronto Municipal Code Chapter 492, Green Roofs. Complete the table below and copy it directly onto the Roof Plan submitted as part of any Site Plan Control Application requiring a green roof in accordance with the Bylaw. Refer to Section § 4921 of the Municipal Code for a complete list of defined terms, and greater clarity and certainty regarding the intent and application of
the terms included in the template. The Toronto Municipal Code Chapter 492, Green Roofs can be found online at: http://www.toronto.ca/legdocs/municode/1184_492.pdf


Green Roof Statistics

Gross Floor Area, as defined in Green Roof Bylaw (m²) Total Roof Area (m²) Area of Residential Private Terraces (m²) Rooftop Outdoor Amenity Space, if in a Residential Building (m²) Proposi 10.684.2 1.138.0 504.66							
Area of Renewable Energy Devices (m²) N/A Tower (s)Roof Area with floor plate less than 750 m² 470.90 Total Available Roof Space (m²) 536.21 Green Roof Coverage Required Propost Coverage of Available Roof Space (m²) 268.11 322.87	ad						
Coverage of Available Roof Space (%) 50% 60.21%							
	/ «						
					PROPERTY LINE		
		PROPERTY LINE	A 6.01				
		·			PRIVACY SCREEN 54	- E /	F
		÷			LOGGIA		
	BEDROOM 2	13' - 10"	STAIR B	14' - 0" N	14'-0" LIVING ROOM EDROOM	-3"-4'-2"	
	PRO INTERPREDICTION OF THE PROPERTY OF THE PRO	BEDROOM STAIL	RA	3:-0	SUITE 01		
			ELEV. 1 ELEV. 2 ELEV. 3		1 508 SO FT		
	SUITE 03 2,668 SQ.FT.	KITCHEN 14'-2	9' - 0"	LA	KITCHEN 13'-4" 11'		1
	/ TERRACE LIVING ROOM	STUDY			===== ================================	11"	
	- J				LIVING ROOM		
	R 5000	DINING 14'-6" 13'-3" BEDROOM 3	15'-0" MASTER BEDROOM BEDROOM	DOM 2 BEDROOM 3 13'-0" DEN/ STU	SUITE 02 UDY 2523 SQ.FT.		
co	RNER		15 - 9" 44 - 5"				
						+ -/ A	
		AREA REQUIRED FOR ROAD WIDENING	PROPERTY LINE			—	
				VIEWANG			
	1	3	4	VIEW ANGLE FOR CLOCK TO 6	OWER 8	9	
		3	4		0	9	

General Notes

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scottarch.ca

100 DAVENPORT

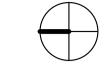4⁄9**0** Davenport Road, Toronto, ON.

Drawing

4TH FLOOR PLAN

Project number	21302
Date	2020-12-22
Drawn by	YE
Checked by	AS

A 4.04

The Green Roof Statistics Template is required to be submitted for Site Plan Control Applications where a green roof is required under the Toronto Municipal Code Chapter 492, Green Roofs. Complete the table below and copy it directly onto the Roof Plan submitted as part of any Site Plan Control Application requiring a green roof in accordance with the Bylaw. Refer to Section § 492-1 of the Municipal Code for a complete list of defined terms, and greater clarity and certainty regarding the intent and application of the terms included in the template. The Toronto Municipal Code Chapter 492, Green Roofs can be found online at: http://www.toronto.ca/legdocs/municode/1184-492.pdf

Green Roof Statistics

Gross Floor Area, as defined in Green Roof Bylaw (m²) Total Roof Area (m²) Area of Residential Private Terraces (m²) Rooftop Outdoor Amenity Space, if in a Residential Building (m²) Area of Renewable Energy Devices (m²) Tower (s)Roof Area with floor plate less than 750 m² Total Available Roof Space (m²) Green Roof Coverage Coverage of Available Roof Space (m²) Required Required Proposed Coverage of Available Roof Space (%) 50% 60.21%		
	PROPERTY LINE	PROPERTY LINE
PROPERTYLINE	BEDROOM 2 MASTER BEDROOM STAIR B BEDROOM BEDROOM	PRIVACY SCREEN LOGGIA BEDROOM LIVING ROOM D LIVING ROOM
	SUITE 03. 2,668 SQ.FT. LIVING ROOM LIVING ROOM	SUITE 01 1,508 SQ.FT. C LAUNDRY DINING 24'-11
CORNER ROUNE	DINING 13'-11 13'-3" BEDROOM 3 BEDROOM 2 15'-0" BEDROOM 2 15'-0" BEDROOM 3	LIVING ROOM SUITE 02
	AREA REQUIRED FOR ROAD WIDENING VIEW AI 2 3	VGLE FOR CLOCK TOWER 7

General Notes

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100 DAVENPORT

4⁄9**0** Davenport Road, Toronto, ON.

Drawing

5TH - 7TH FLOOR PLAN

Project number	21302
Date	2020-12-22
Drawn by	YE
Checked by	AS

A 4.06

Scale 1:100

The Green Roof Statistics Template is required to be submitted for Site Plan Control Applications where a green roof is required under the Toronto Municipal Code Chapter 492, Green Roofs. Complete the table below and copy it directly onto the Roof Plan submitted as part of any Site Plan Control Application requiring a green roof in accordance with the Bylaw. Refer to Section § 492-1 of the Municipal Code for a complete list of defined terms, and greater clarity and certainty regarding the intent and application of the terms included in the template. The Toronto Municipal Code Chapter 492, Green Roofs can be found online at: http://www.toronto.ca/legdocs/municode/1184_492.pdf

Green Roof Statistics

Gross Floor Area, as defined in Green Roof Bylaw (m²) Total Roof Area (m²) Area of Residential Private Terraces (m²) Area of Residential Private Terraces (m²) Area of Renewable Energy Devices (m²) Tower (s)Roof Area with floor plate less than 750 m² Total Available Roof Space (m²) Green Roof Coverage Coverage of Available Roof Space (m²) Coverage of Available Roof Space (%) Coverage of Available Roof Space (%)		PROPERTY LINE			PROPERTY LINE	——————————————————————————————————————
R 5000 CORNER ROUNDING	BEDROOM 3 MASTER BEDROOM TERRACE DINING/ LIVING ROOM SUITE 02 2,525 SQ.FT.	WINE ROOM/ PANTRY KITCHEN	BE STAIR BE	DROOM 3 KITCHEN DINING ROOM 12'-7" TERRACE	SUITE 01 2,600 SQ.FT. TERRACE LIVING ROOM	
		AREA REQUIRED FOR ROAD WIDENING	PROPERTY LINE		3	$\frac{1}{2}$

General Notes

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Drawing

8TH FLOOR PLAN

Project number	21302
Date	2020-12-22
Drawn by	YB
Checked by	AS

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Green Roof Statistics

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	PROPERTY LINE	PROPERTY LINE E F
B LIVING	MASTER STAIR A BEDROOM 3 BEDROOM 3 BELEV. 1 ELEV. 2 ELEV. 3 KITCHEN	MASTER BEDROOM SUITE 01 2,496 SQ.FT.
	SUITE 02 425 SQ.FT. WINE ROOM/ PANTRY BEDROOM 2 BEDROOM 2 BEDROOM 2 PROPERTY LINE ROAD WIDENING	BALCONY 13'-9"
	3	

General Notes

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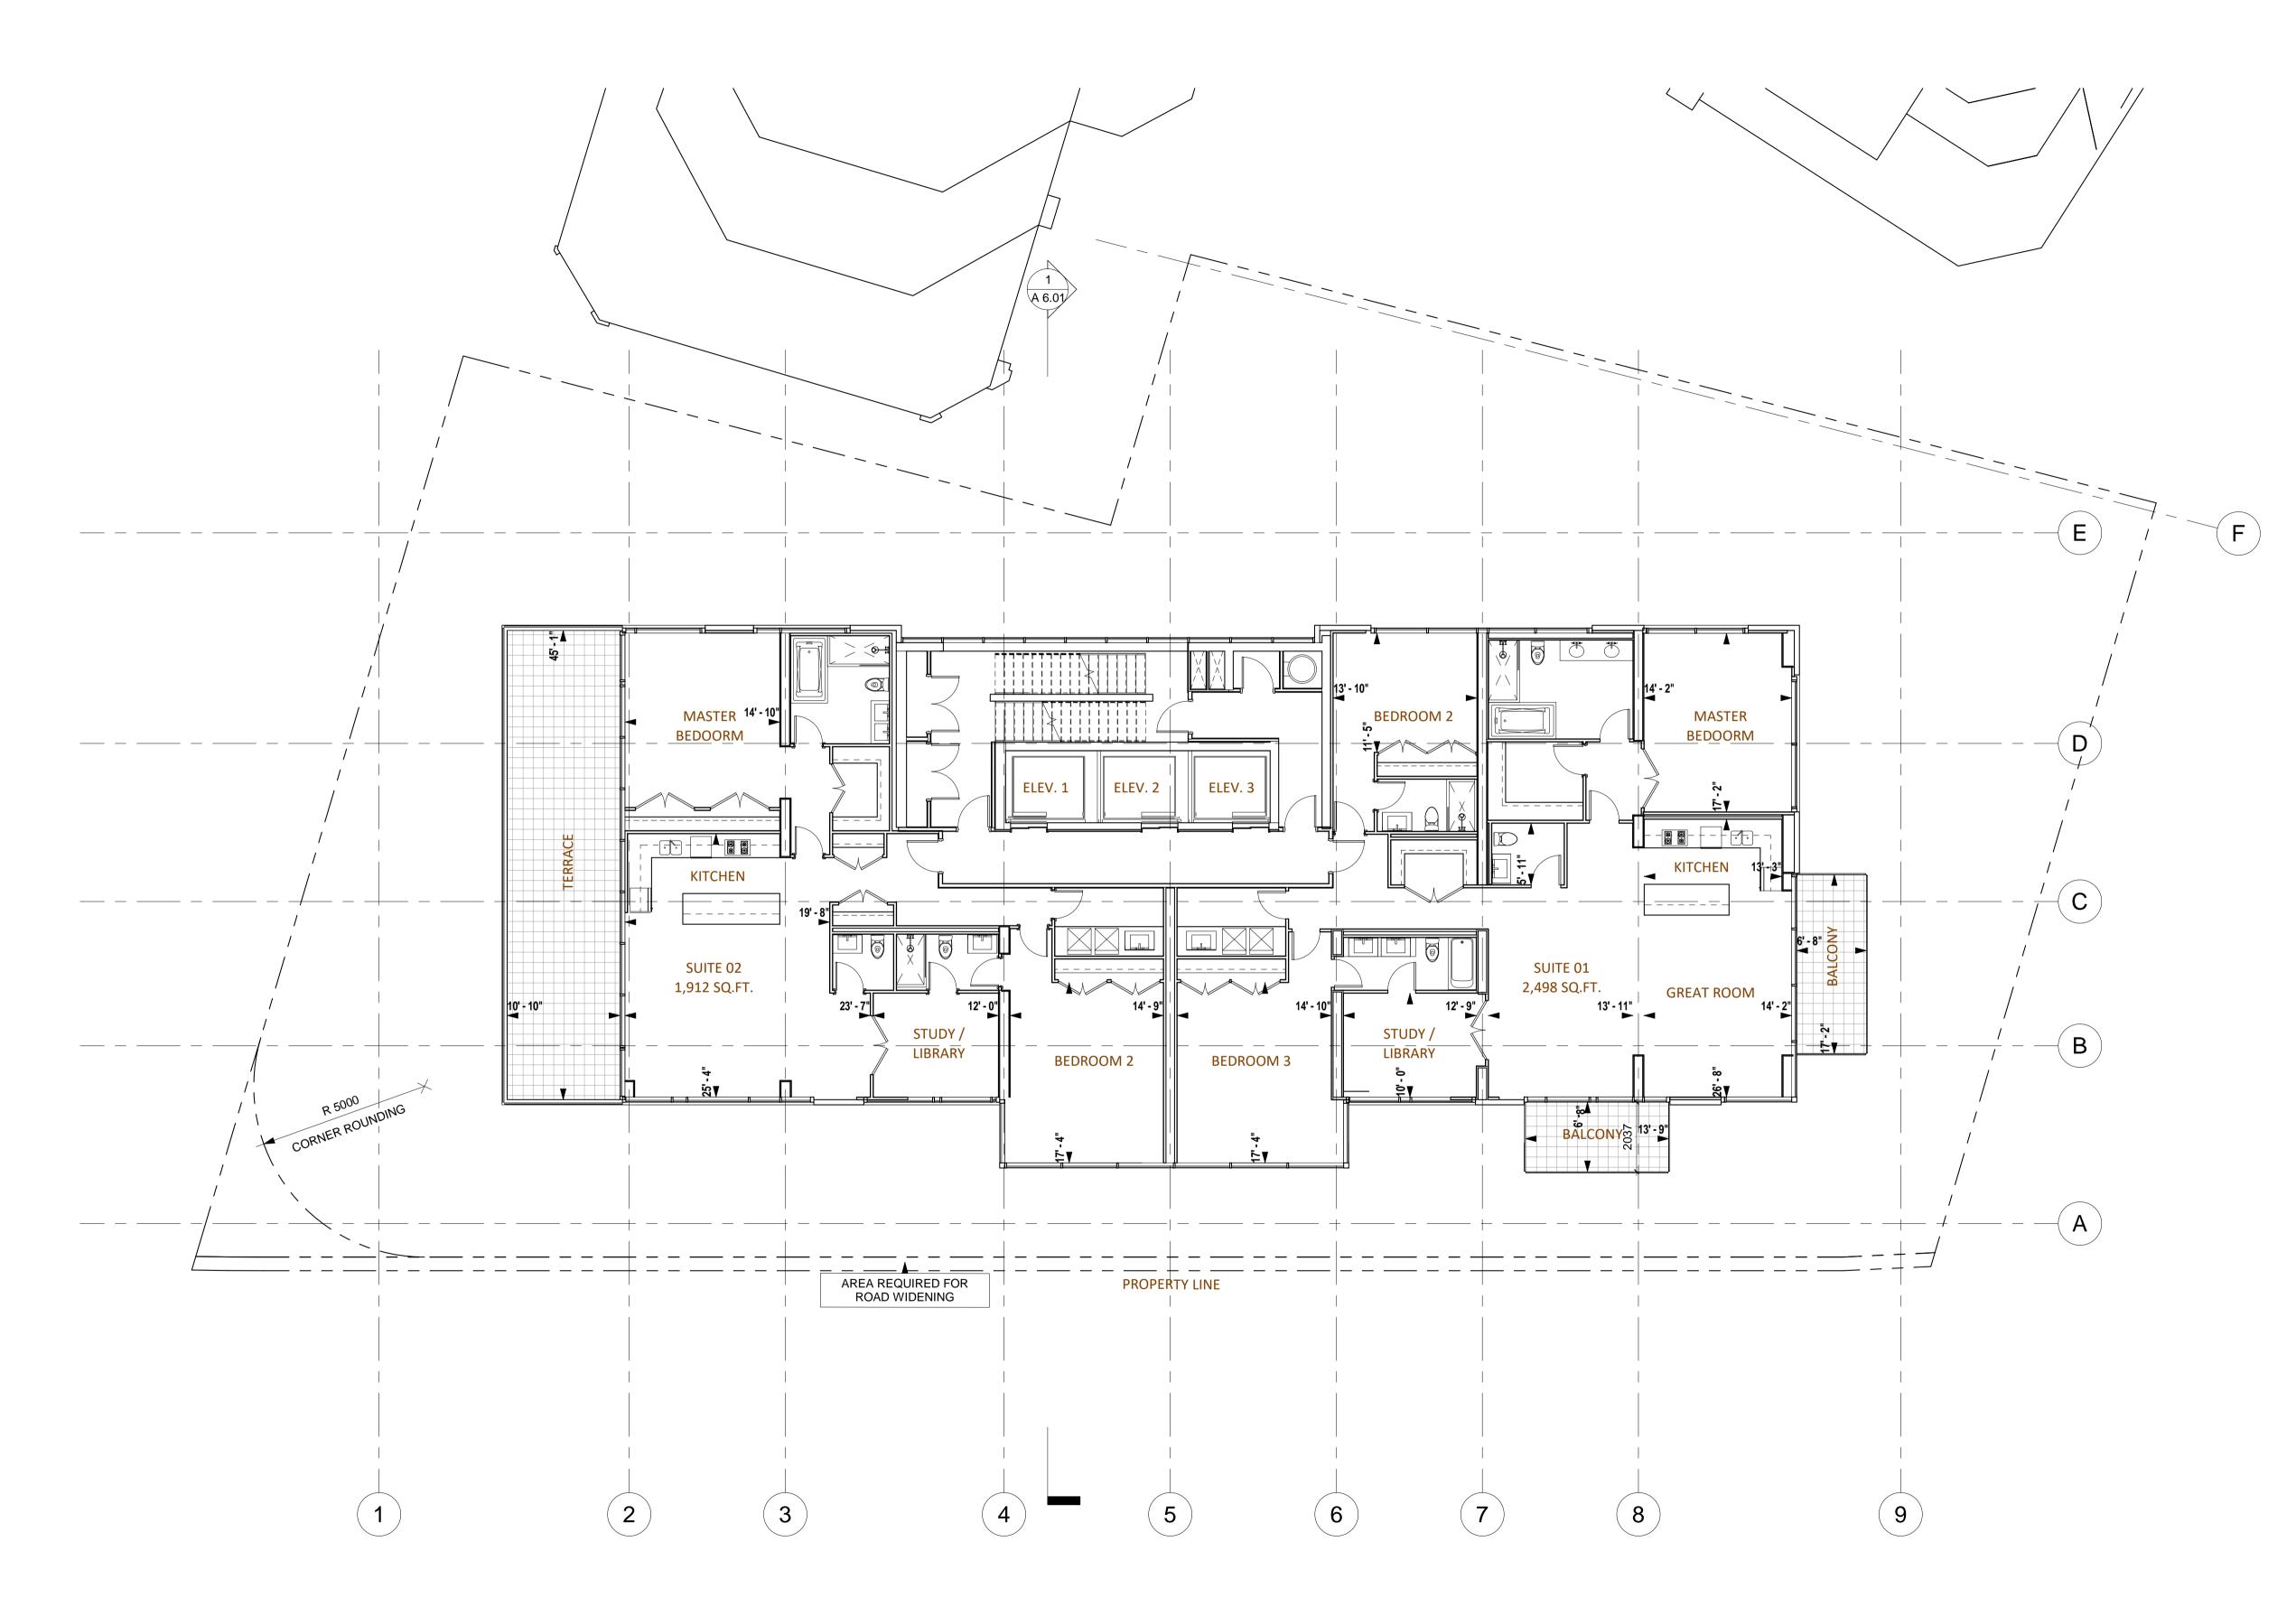
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9TH - 17TH FLOOR PLAN

Project number	21302
Date	2020-12-22
Drawn by	YB
Checked by	AS

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ANDREW SHIELDS

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7679



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Drawing

18TH FLOOR PLAN

21302
2020-12-22
Author
Checker

A 4.10

Scale

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Green Roof Statistics

Gross Floor Area, as defined in Green Roof Bylaw (m²) Total Roof Area (m²) Area of Residential Private Terraces (m²) Rooftop Outdoor Amenity Space, if in a Residential Building (m²) Area of Renewable Energy Devices (m²) Tower (s)Roof Area with floor plate less than 750 m² Total Available Roof Space (m²) Green Roof Coverage Coverage of Available Roof Space (m²) Coverage of Available Roof Space (%) Required Froposed Coverage of Available Roof Space (%) Food of Space (%) Food of Space (%) Required Froposed Coverage of Available Roof Space (%)					
	PROPERTY LINE			PROPERTY LINE	
OUTLINE OF / 16TH FLOOR	17'-10"	STAIR A ELEV. 1 ELEV. 2 ELEV.		MASTER	
		14' - 0"	14'-11"	BEDROOM 3	
CORNER ROUNDING	AREA REQUENCE ROAD WI	JIRED FOR PROPERTY LINE			
	2	4	6	8	9

General Notes

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19TH FLOOR PLAN

Project number	21302
Date	2020-12-22
Drawn by	YB
Checked by	AS

A 4.11

Gross Floor Area, as defined in Green Roof Bylaw (m2)

Green Roof Statistics

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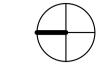
Green Roof Statistics

	MPH MPH ROOF GREEN ROOF 1008 SQ.FT. 94 SQ.M.	MPH ROOF	MPH ROOF LOWER)	MPH — GREEN ROOF — 1284 SQ.FT — 119 SQ.M.	PROPERTY C
/ / / R 5000				 	B
CORNER ROUNDING		BALCONY BELOW			A
	AREA REQUIRED FOR ROAD WIDENING	PROPERTY LINE			

General Notes

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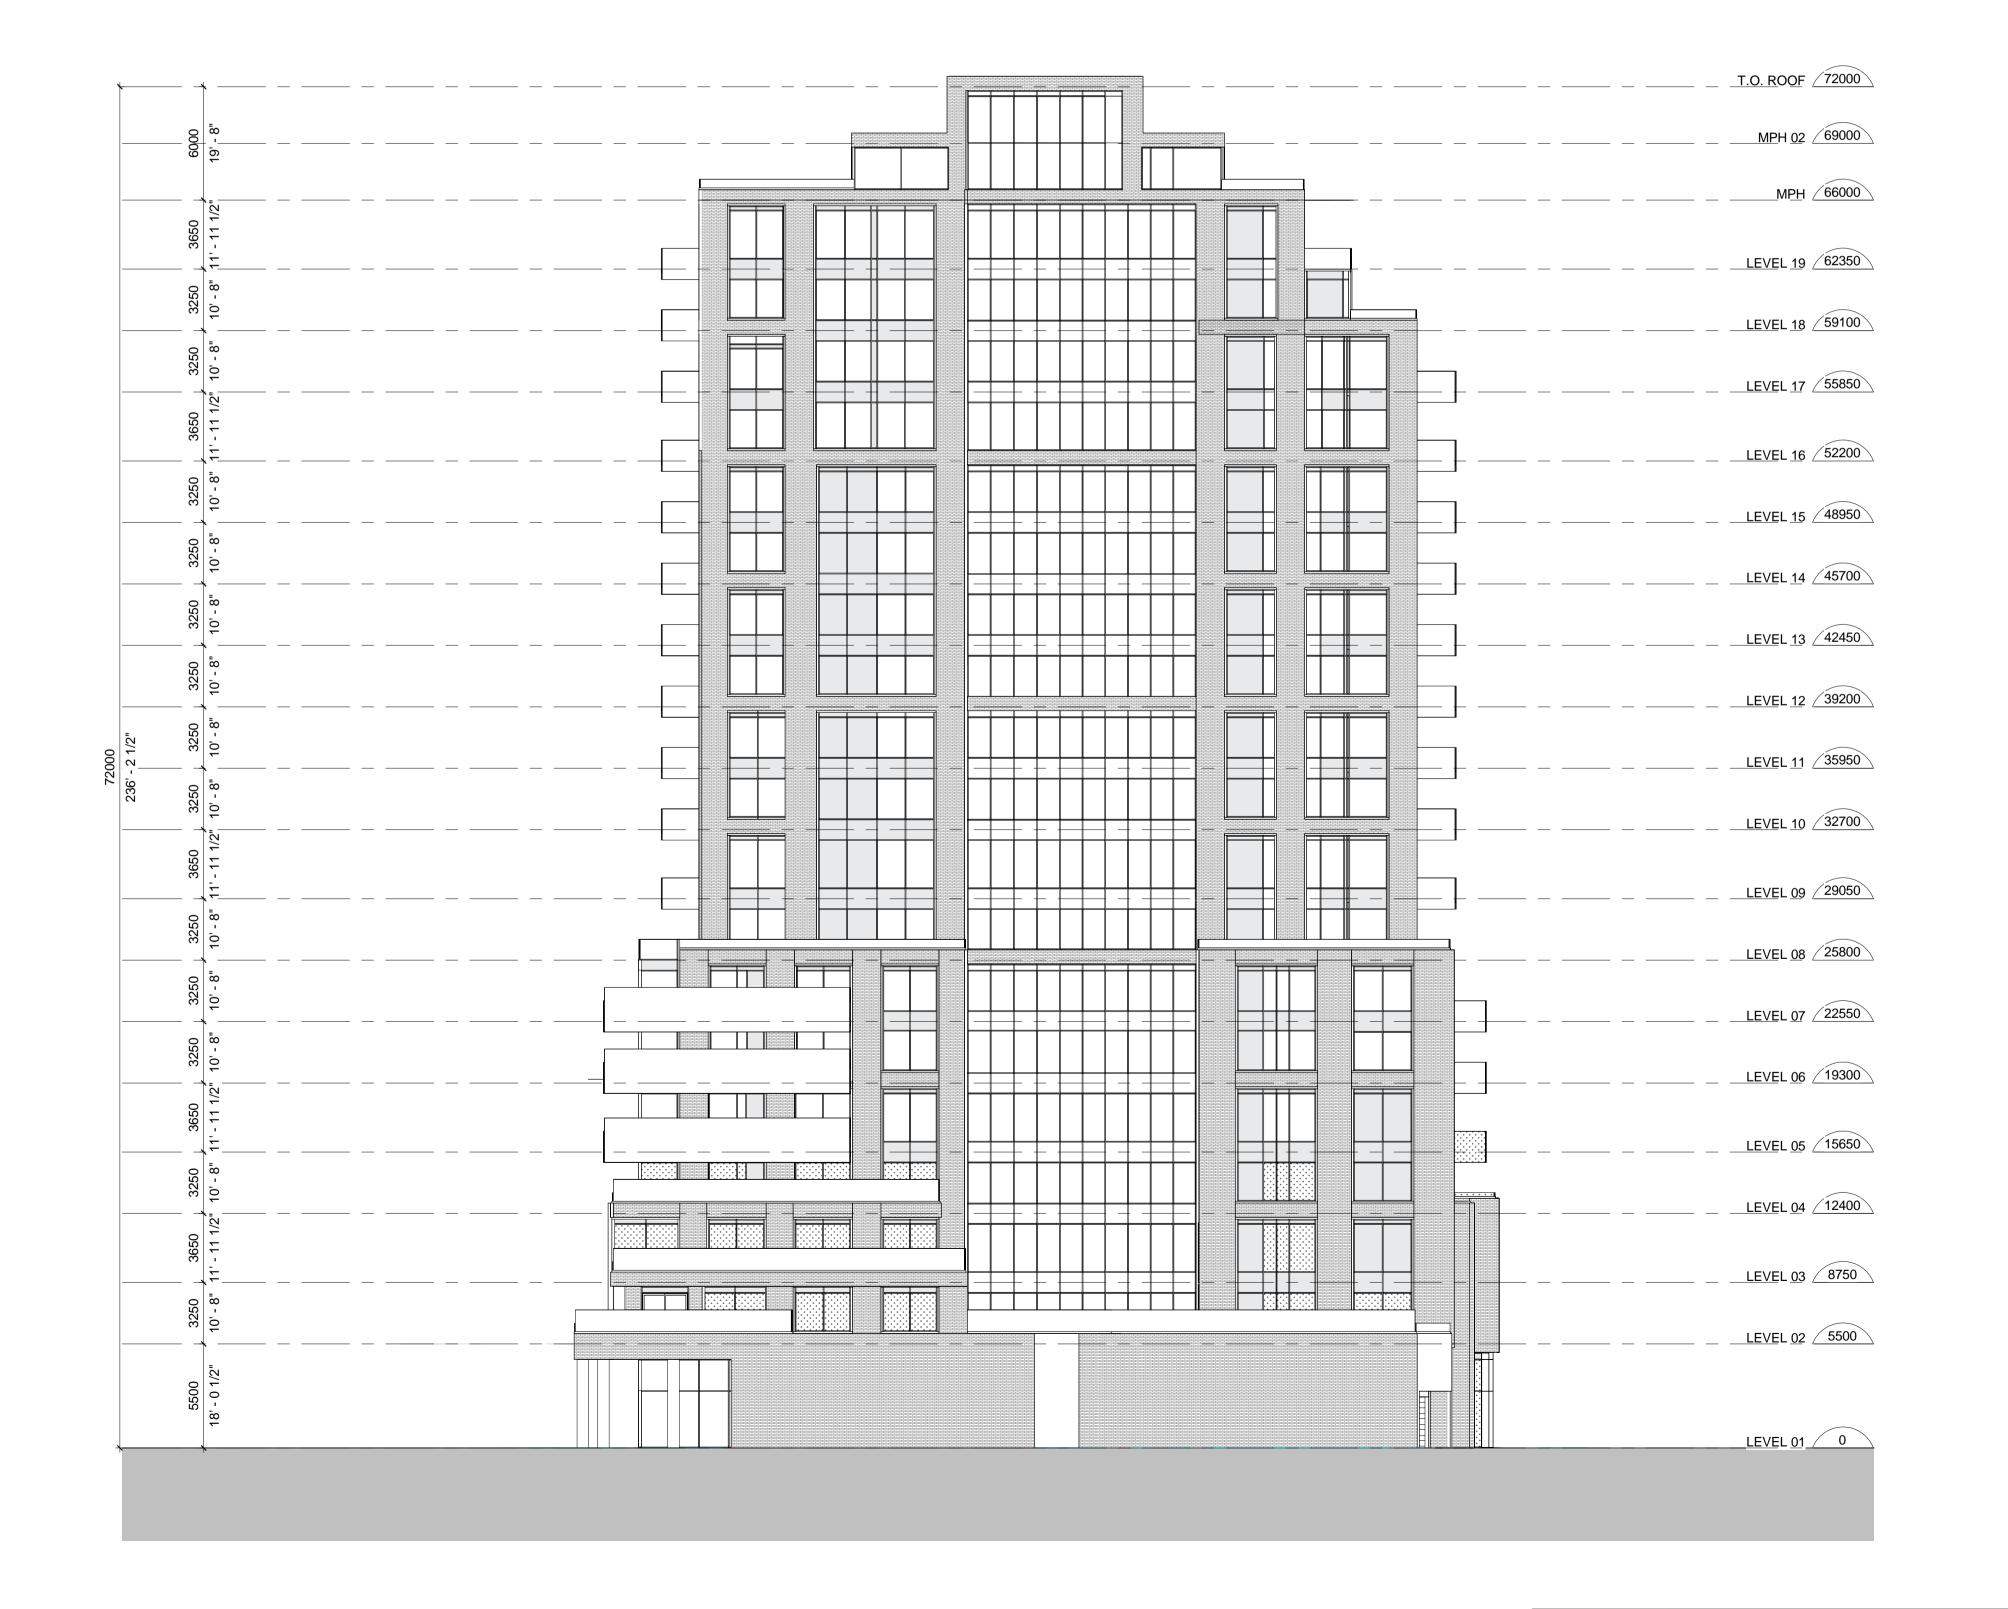
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MPH ROOFTOP PLAN

Project number	21302
Date	2020-12-22
Drawn by	Author
Checked by	Checker

A 4.12



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FOR BIRD-FRIENDLY DESIGN STATISTICS REFER TO SHEET A 0.01 - PROJECT SUMMARY

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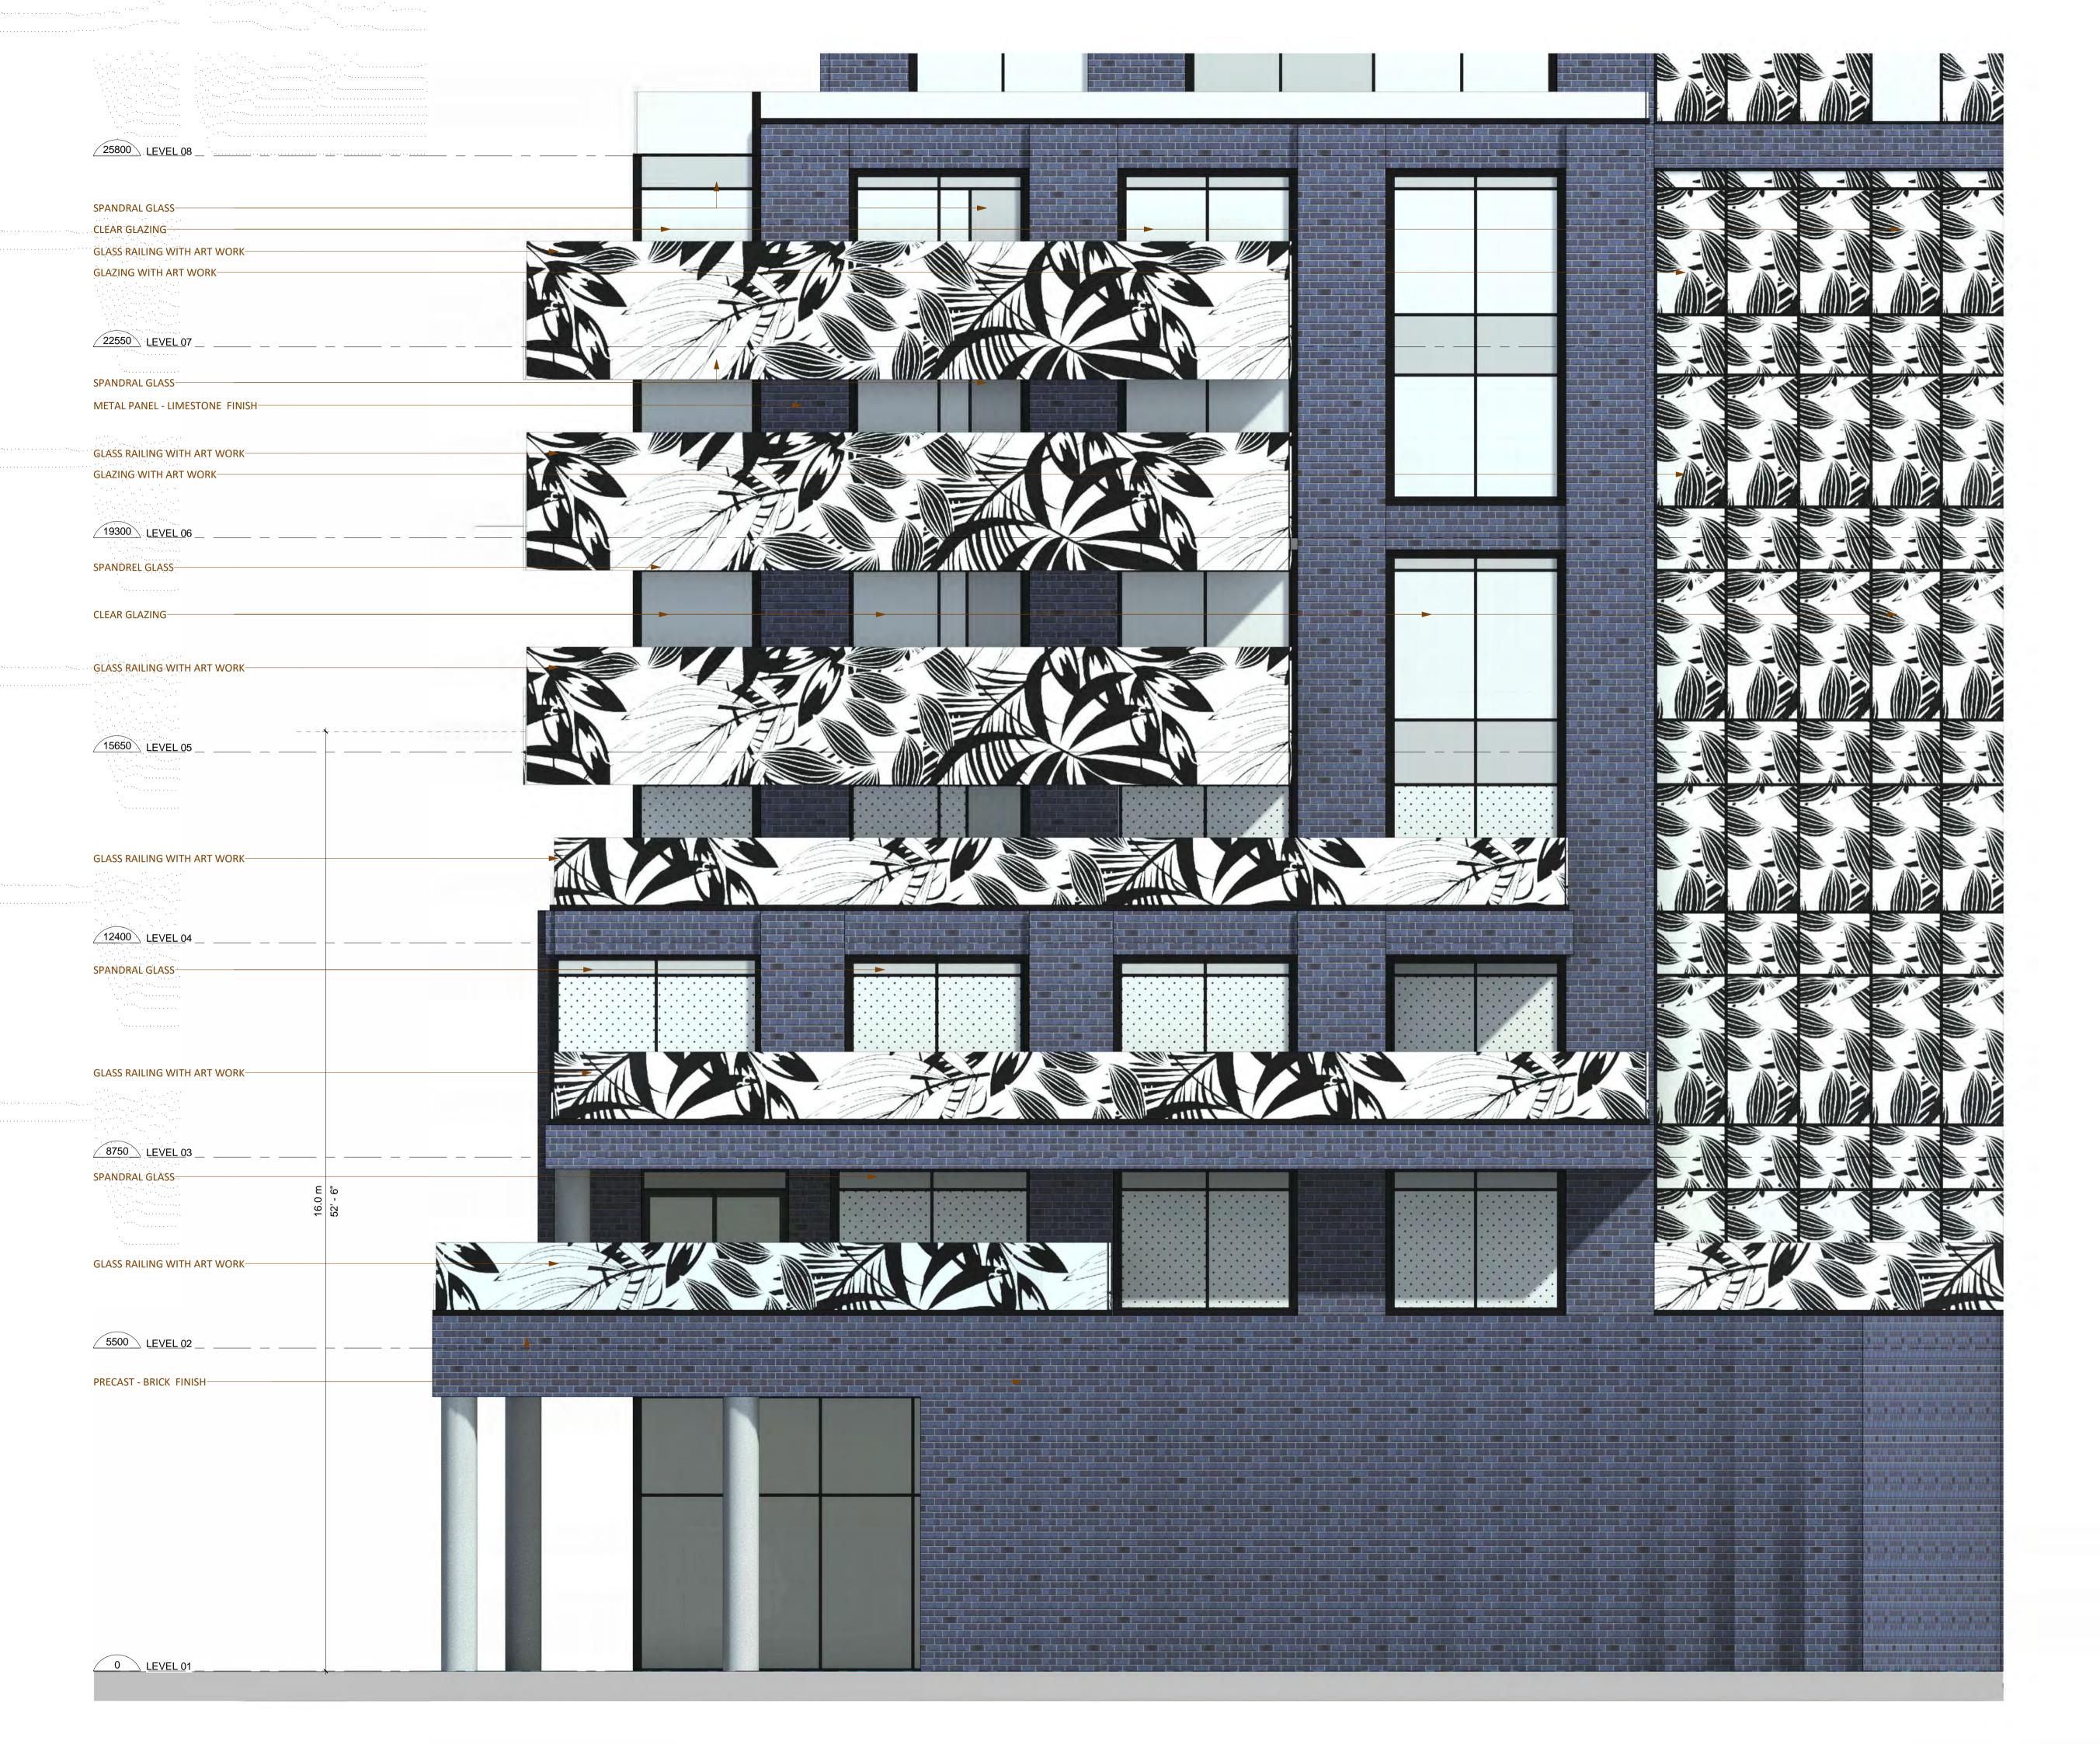
Drawing

EAST ELEVATION

Project number	21302
Date	2020-12-22
Drawn by	DD
Checked by	AS

A 5.01

Scale As indicated



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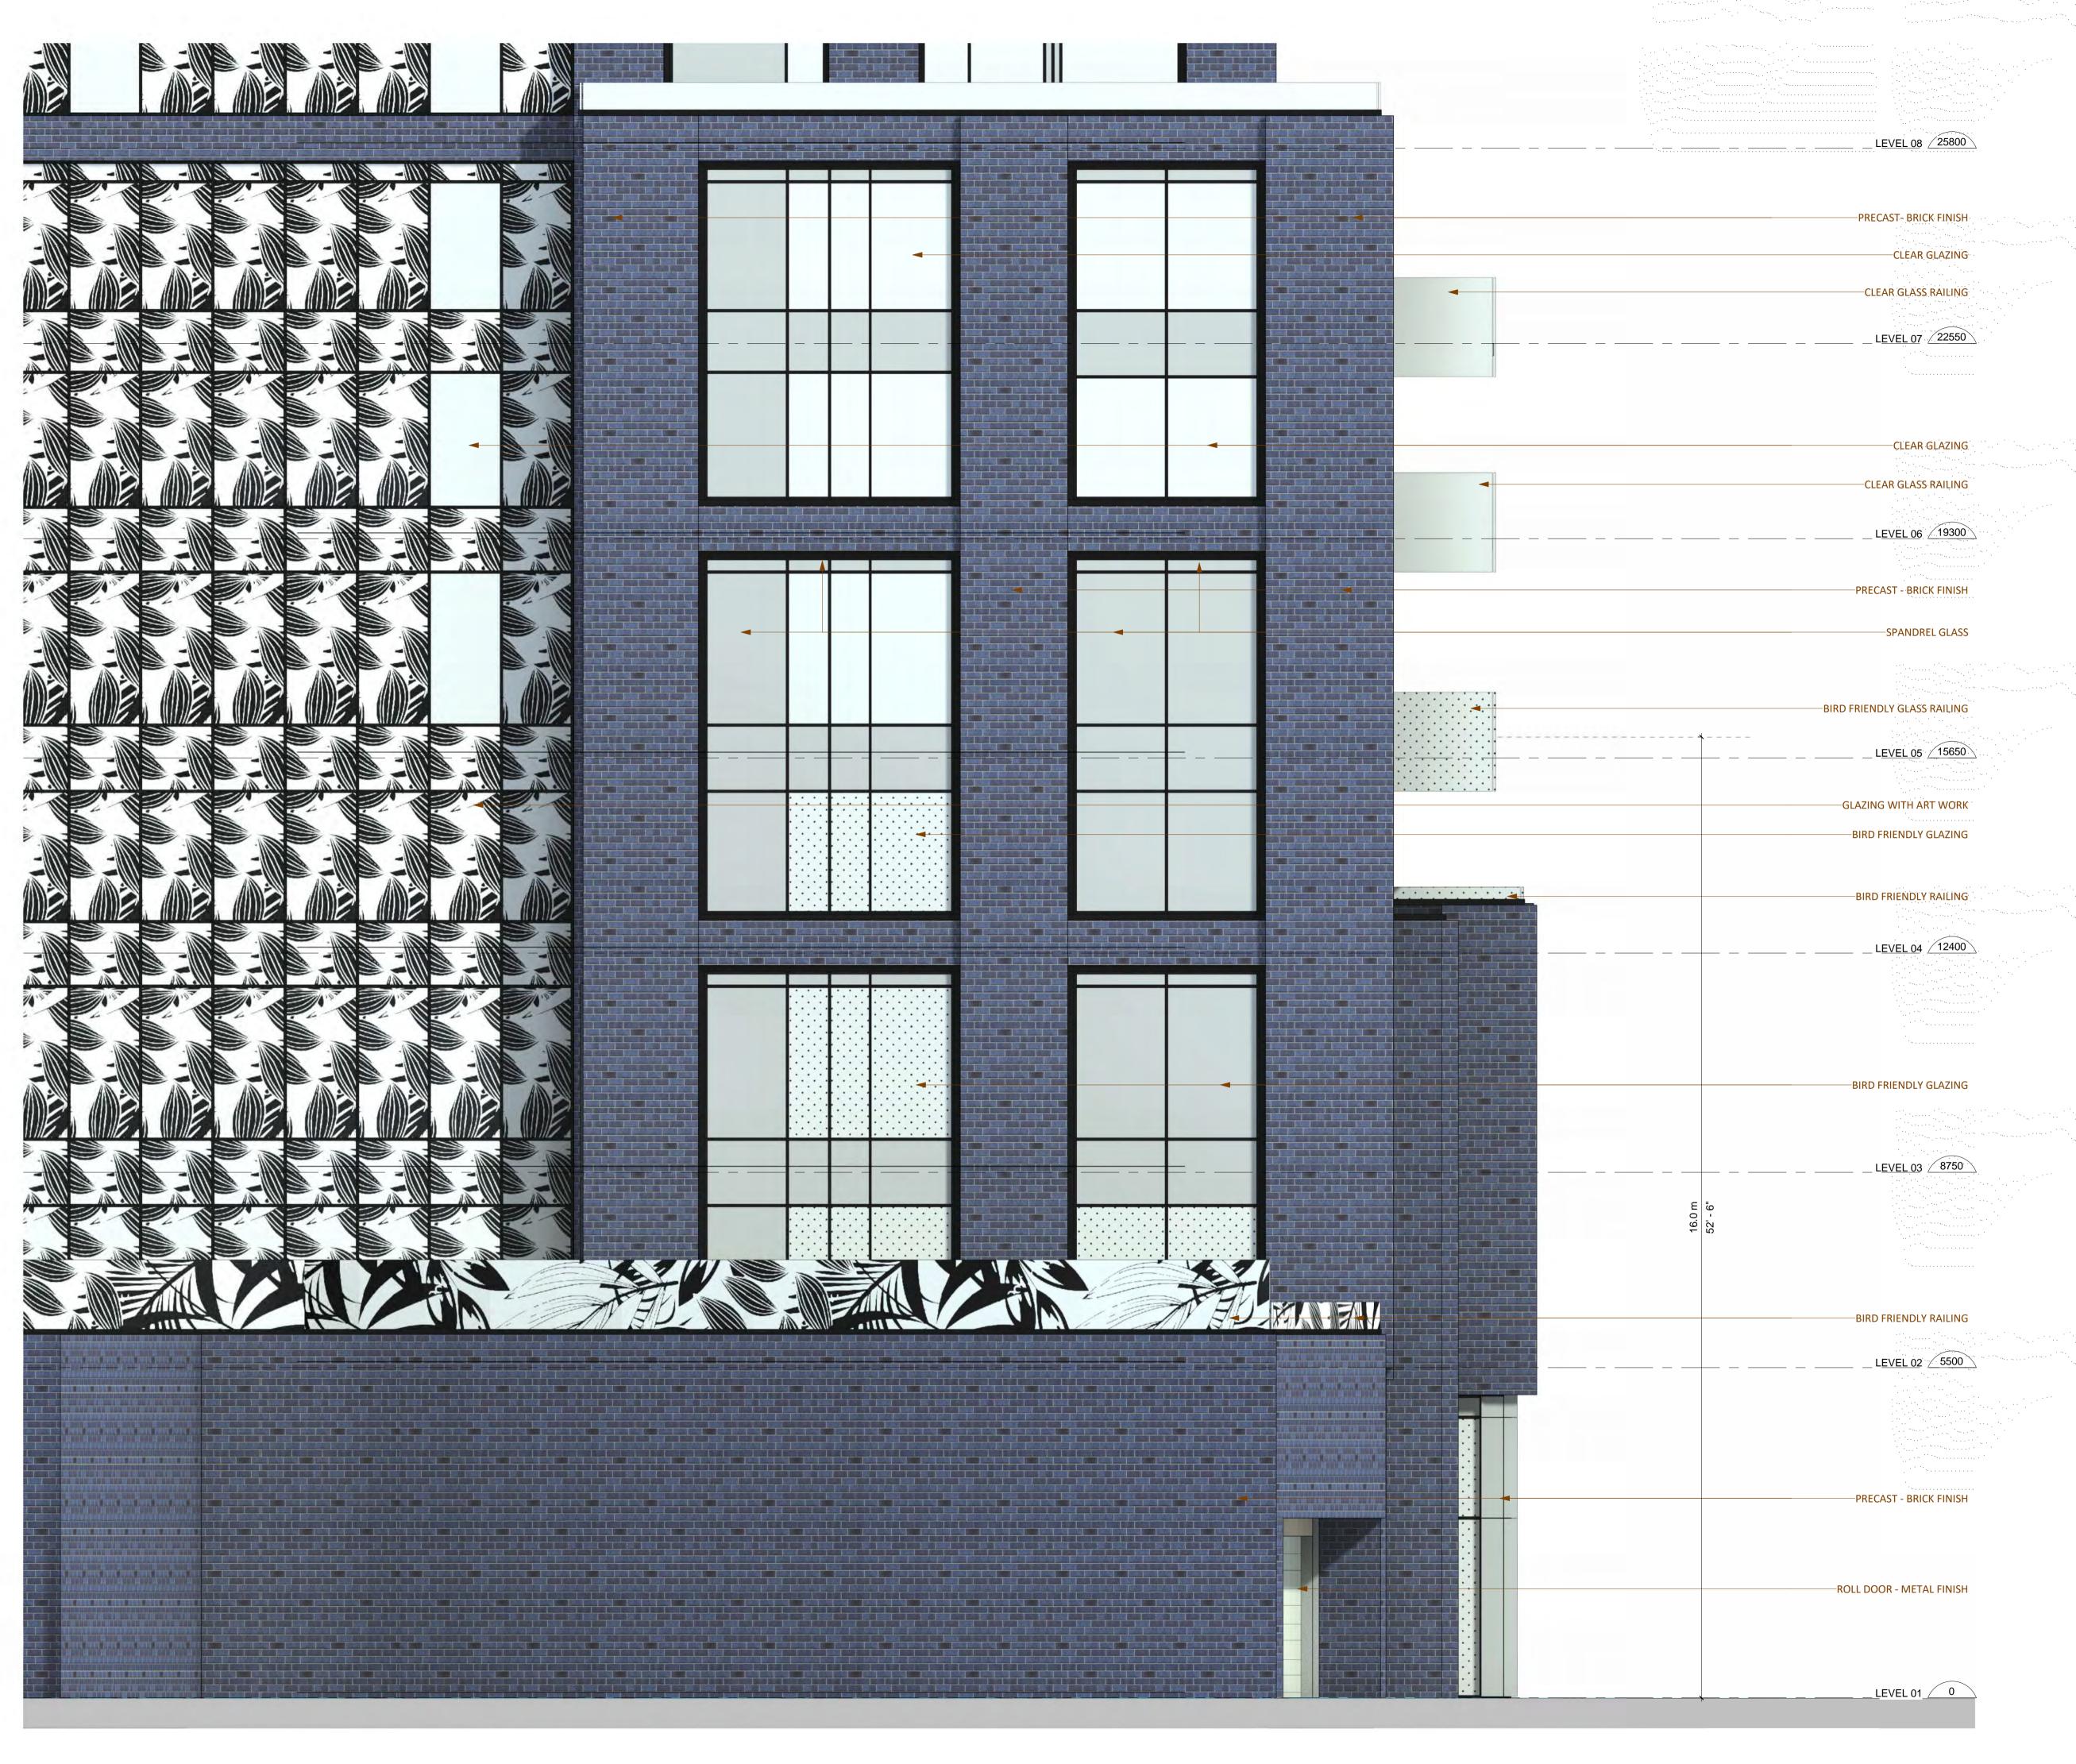
Drawing

ENLARGED EAST ELEVATION

Project number	21302
Date	2020-12-22
Drawn by	DD
Checked by	AS

A 5.01.a

Scale As indicated



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FOR BIRD-FRIENDLY DESIGN STATISTICS REFER TO SHEET A 0.01 - PROJECT SUMMARY

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Project

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Drawing

ENLARGED EAST ELEVATION

Project number 21302


Date 2020-12-22

Drawn by DD

Checked by AS

A 5.01.b

Scale As indicated

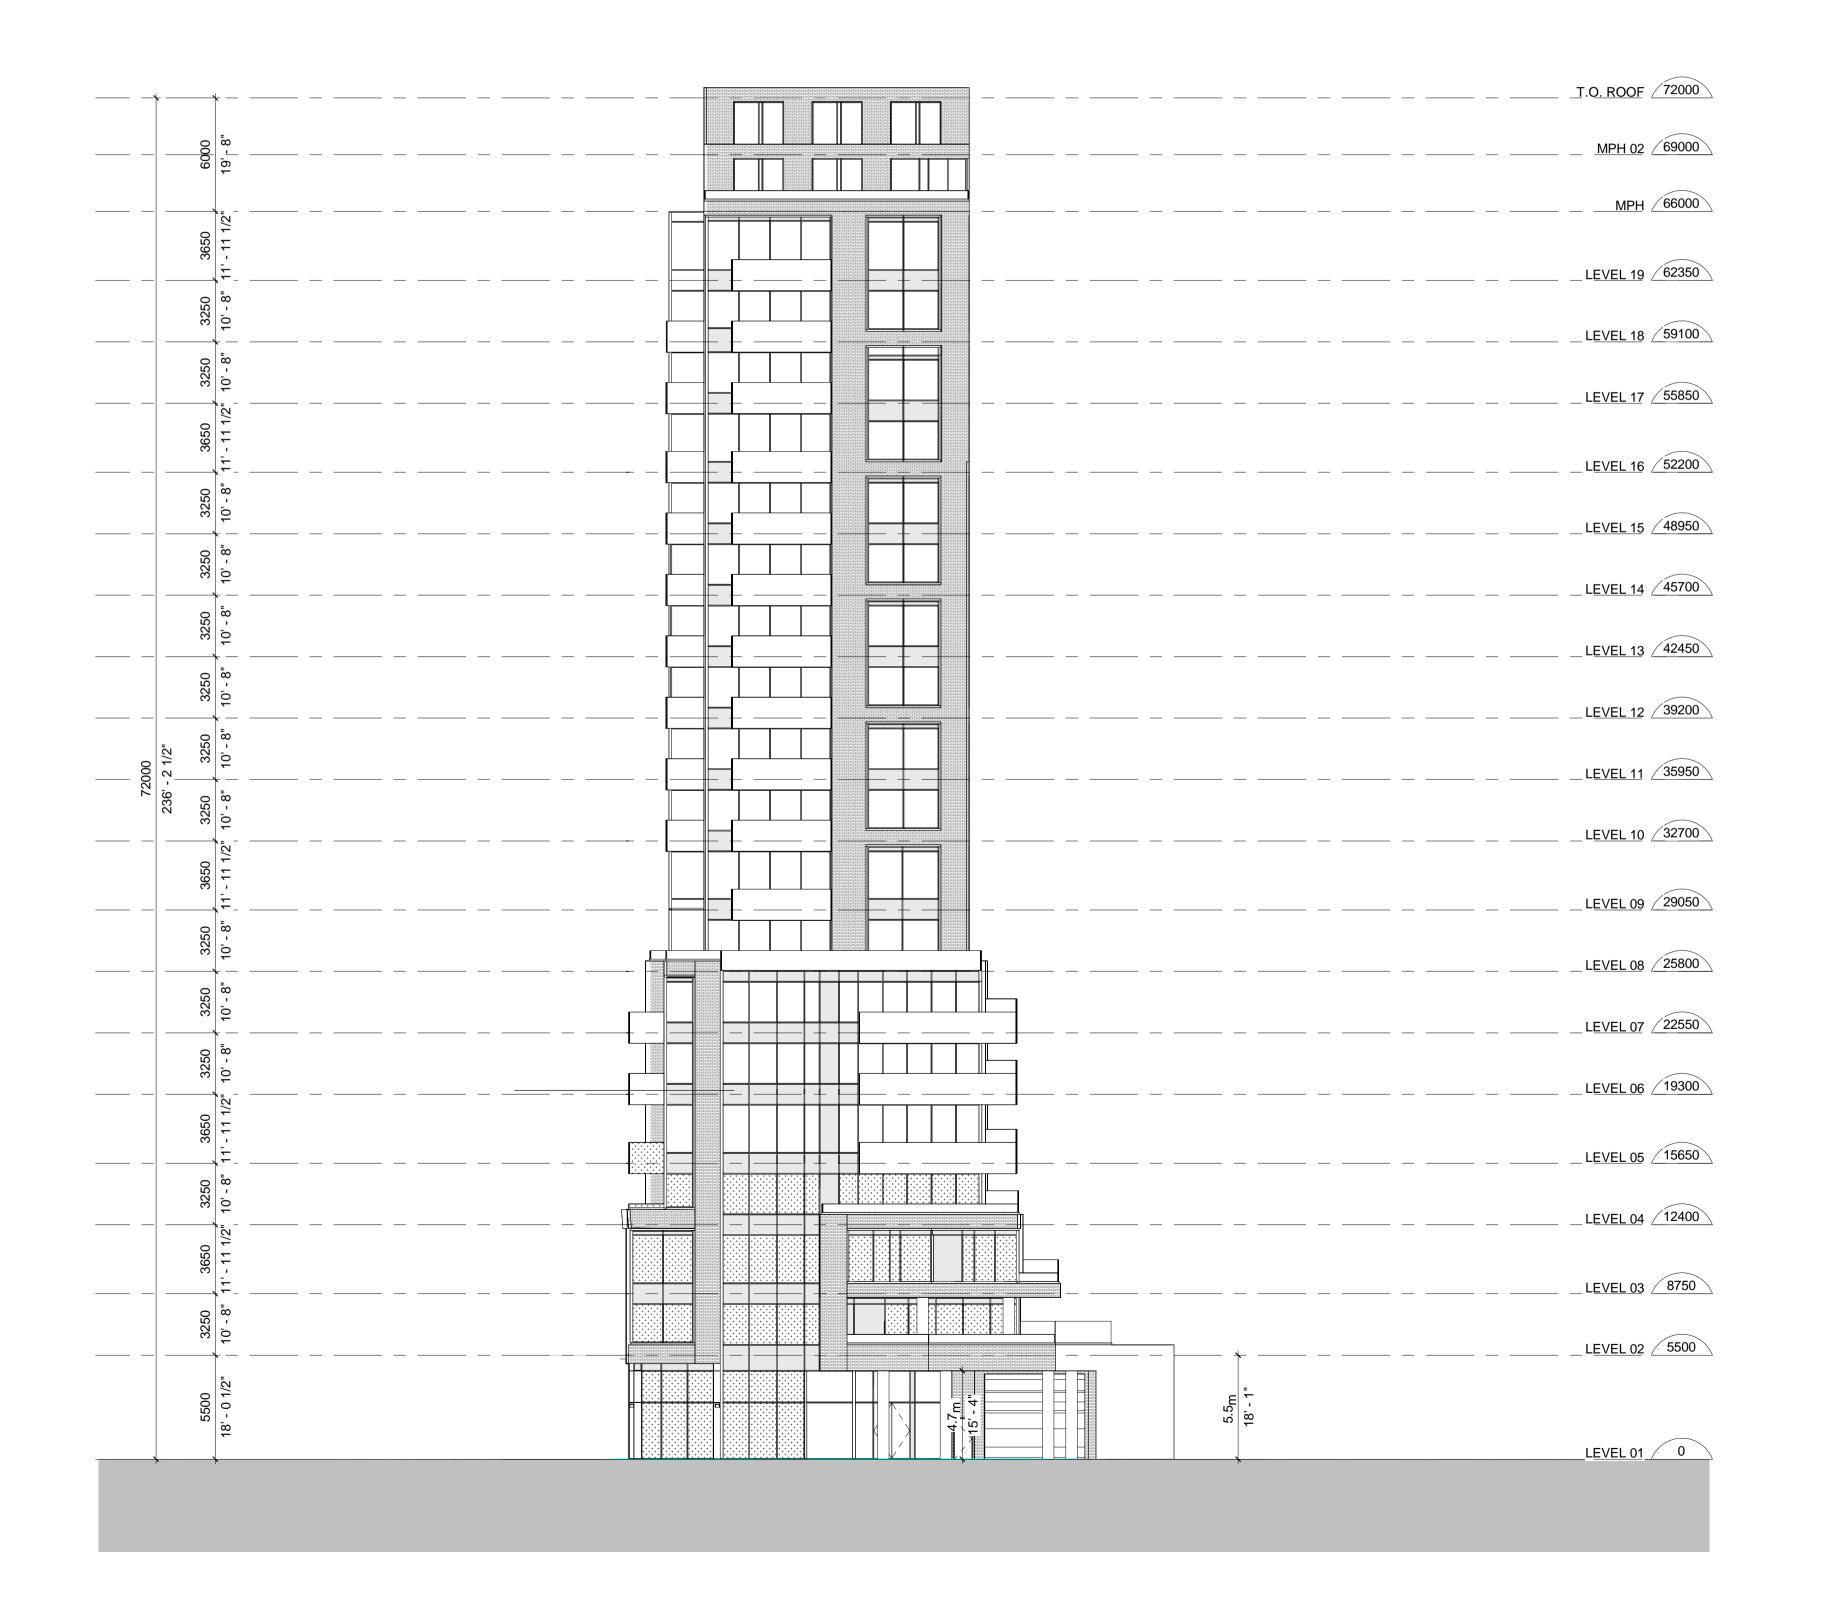

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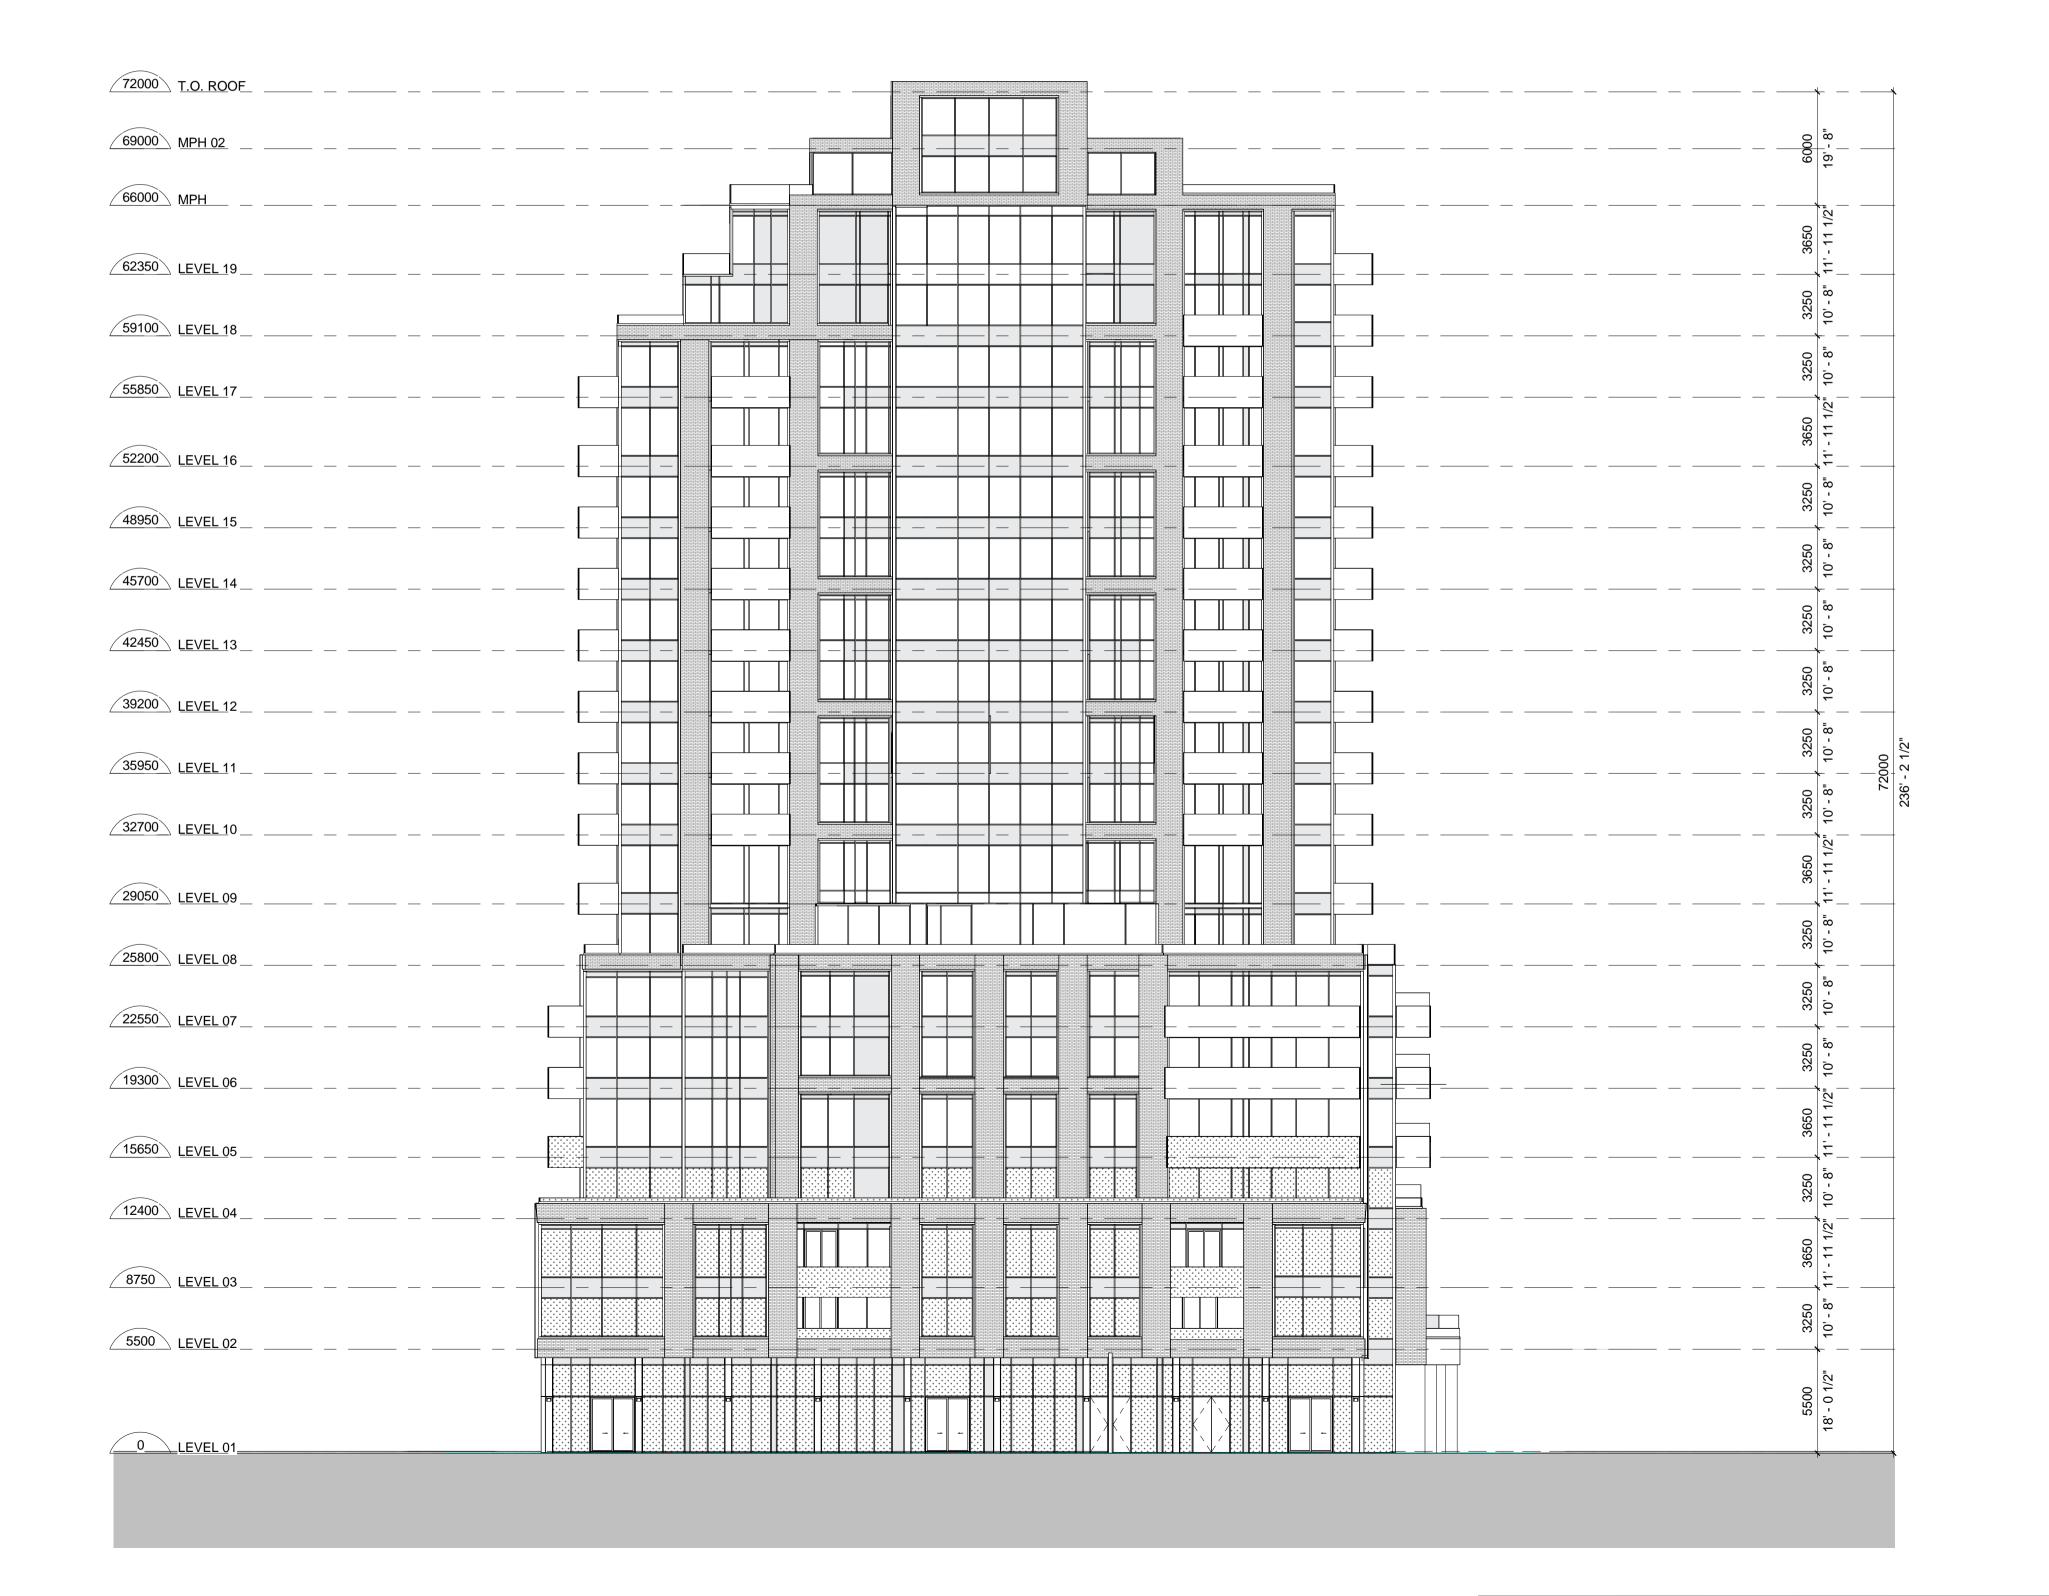
SOUTH ELEVATION

Project number	21302
Date	2020-12-22
Drawn by	DD
Checked by	AS

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As indicated Scale





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WEST ELEVATION

21302 Project number 2020-12-22 Drawn by Checked by

A 5.03

As indicated Scale