
383-387 SHERBOURNE STREET

ZONING BY-LAW AMENDMENT APPLICATION

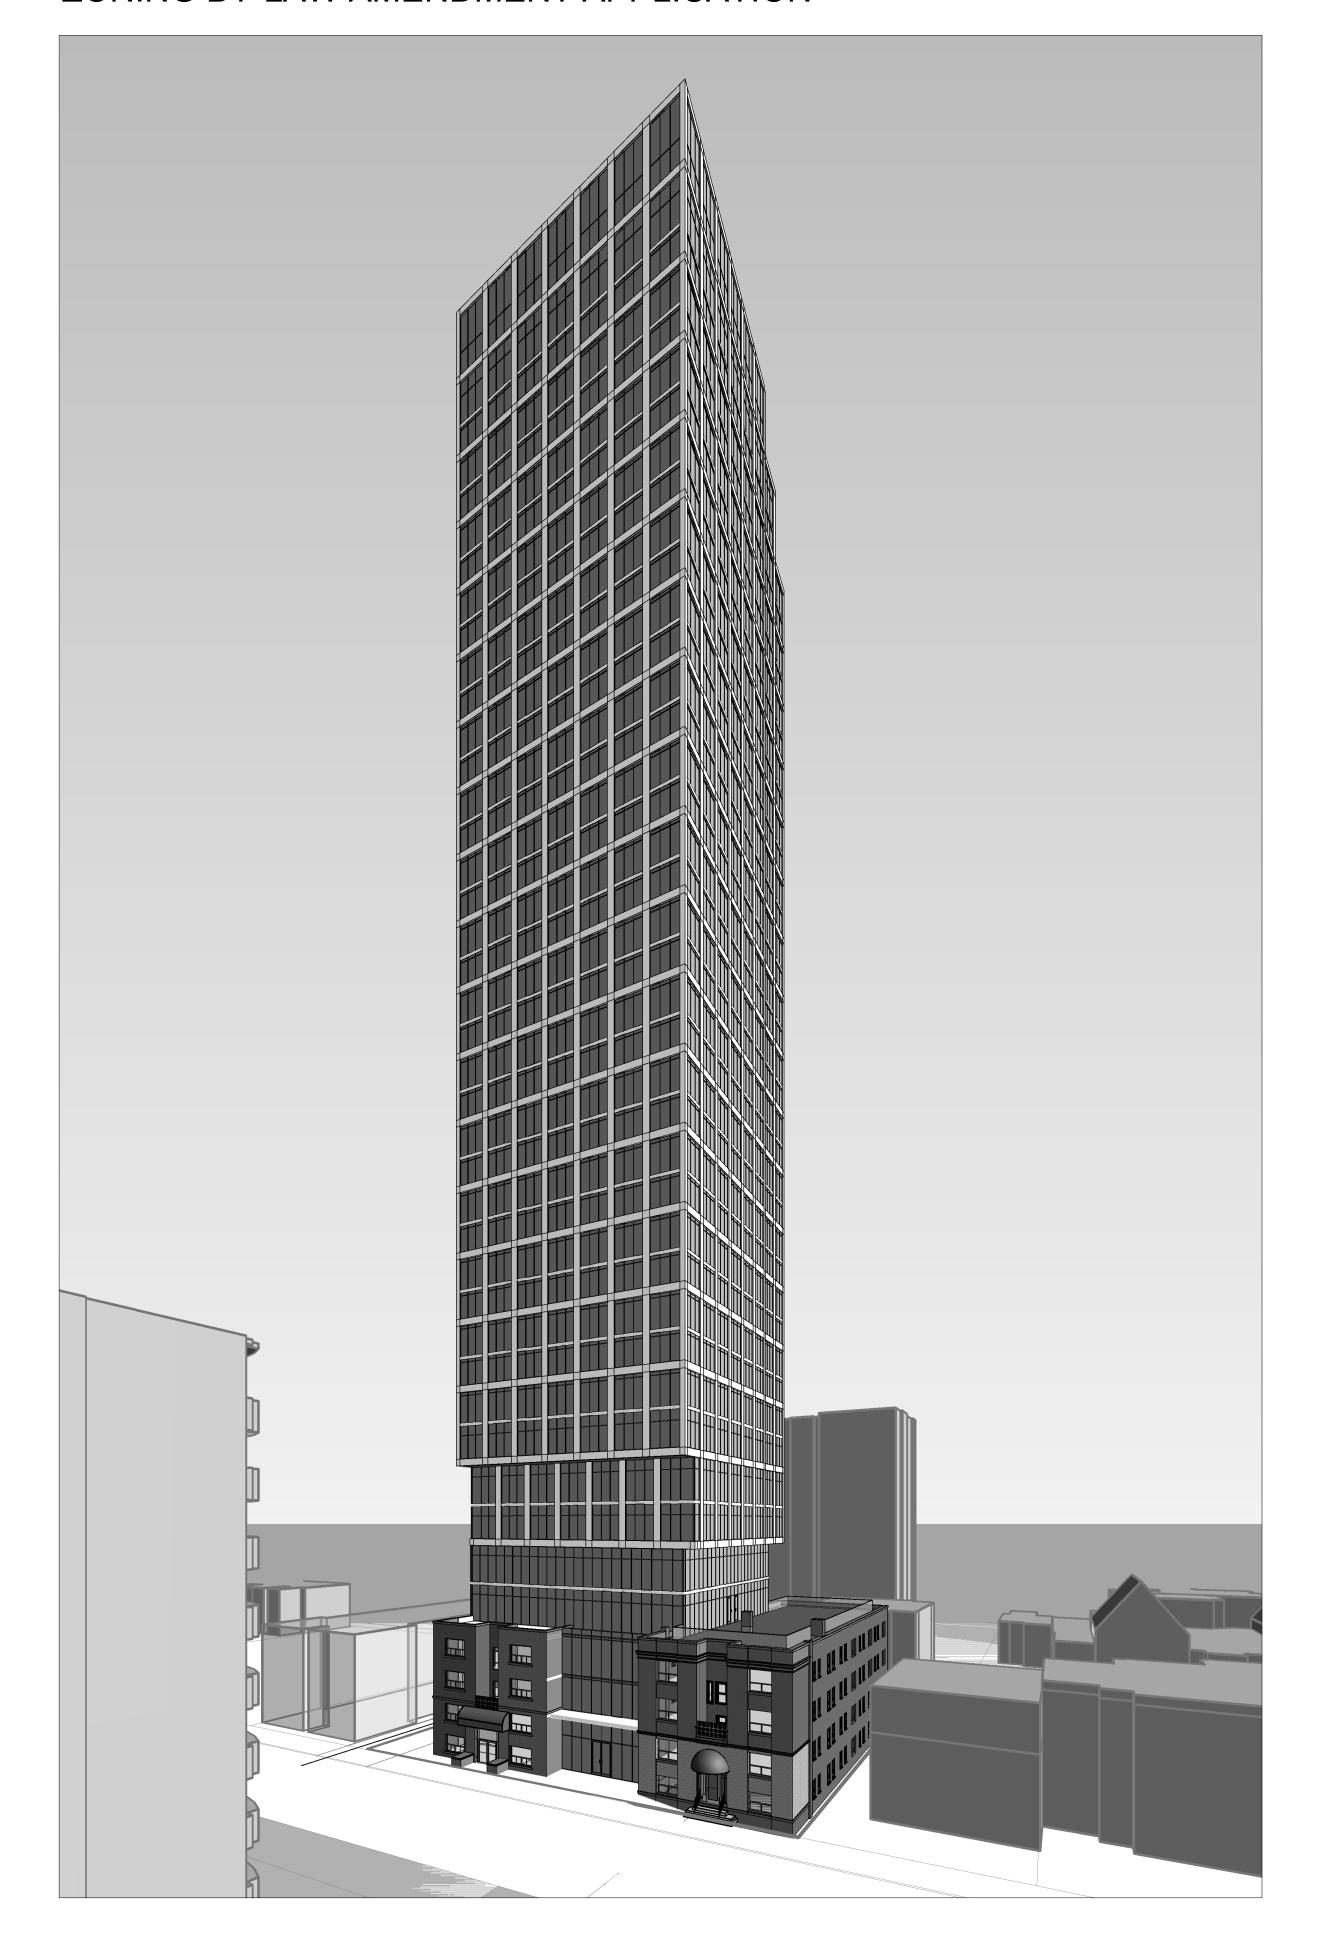

CLIENT

NJS SHERBOURNE INC.

ISSUED

No. DATE DESCRIPTION

1 2021-06-28 ISSUED FOR ZBA SUBMISSION
2 2023-05-12 ISSUED FOR ZBA 2ND SUBMISSION

ARCHITECTURAL DRAWING LIST

SITE & STATISTICS

A000 COVER PAGE
A001 CONTEXT PLAN & STATISTICS

FLOOR PLANS

A100 SITE PLAN A101 P1 TO P2 FLOOR PLANS

A102 GROUND FLOOR PLAN

A104 2ND FLOOR & 3RD FLOOR PLANS A105 4TH FLOOR & 5TH FLOOR PLANS

A106 6TH-7TH FLOOR & 8TH FLOOR

A107 TOWER FLOOR PLANS

A201 WEST & NORTH ELEVATIONS
A202 SOUTH & EAST ELEVATIONS

CECTIONS

A301 BUILDING SECTIONS

PERSPECTIVE


A401 AERIAL VIEWS

No. DATE DESCRIPTION	No.	DATE	DESCRIPTION

ALL DIMENSIONS ARE TO BE CHECKED ON SITE BY THE CONTRACTOR. ANY DISCREPANCIES ARE TO BE REPORTED TO THE ARCHITECT BEFORE PROCEEDING WITH THE WORK. DRAWINGS ARE NOT TO BE SCALED.

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PROJECT 383-387 SHERBOURNE

383-387 Sherbourne St. Toronto, ON Canada

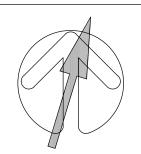SHEET TITLE
COVER PAGE

	117733		A 00
PROJECT NO	:	DWG NO.	
Author	Checker	APR 2023	
DRAWN BY:	CHKD' BY:	DATE:	SCALE

DEVELOPMENT STATISTICS

m - Denotes Meters min - Denotes Minimum sqm - Denotes Square Meters max - Denotes Maximum

PROJECT DATA	
Municipal Address of Subject Lands:	383-387 Sherbourne St
	Toronto, ON

Zoning: By-Law No. 569-2013

Existing Use :	RA	Proposed Use :	RA
Permitted F.S.I.:	N/A	Proposed F.S.I.:	12.53
Permitted Lot Coverage:	N/A	Proposed Lot Coverage:	69%
l			

Lot Area: 1497.00 sqm

Lot Area: 1497.00 sqm

Lot Frontage: 38.30 m No of Frontages:

Lot Depth: 37.80 m

Established Grade: 101.30 m CDG (Canadian Geodatic Datum)

Canada

BUILDING SETBACKS				
No. of Storeys Permitted:	N/A		No. of Storeys Proposed:	39
and parapet walls, and is measured from the est	ablished grade.			
		y ve	ents, skylights, antennae, elevator machine rooms	
Note:				
			Height to Top of MPH Roof	129.04
Height to Top of Residential Roof	30.00		Height to Top of Residential Roof	123.04
PERMITTED	m		PROPOSED	m

BUILDING HEIGHT

			BUILDING	SETBACKS	
EXISTING	m	PROPOSED		m	
Front Yard Setback (West)	1.90	Front Yard Setback (West)		1.90	
Side Yard Setback (North)	5.90	Side Yard Setback (North)		5.90	
Side Yard Setback (South)	1.00	Side Yard Setback (South)		1.00	
Rear Yard Setback (East)	0.00	Rear Yard Setback (East)		0.00	
Easement	0.00	Easement		0.00	
PROPOSED AREAS					


		I NOI OCED	AI 1 LA 0
	sqm		
Residential GFA****	18,759.00	**** GFA as defined by Zoning By-law	
Non-Residential GFA****	0.00		
Total GFA	18,759.00		
At Grade Condition:			
Ground Floor Area*	1,029.00	* Building Footprint	
Landscaped Open Space**	0.00	** Soft Landscaping + Hard Landscaping areas	
Paved Surface Area***	0.00	*** Driveway, Parking lots and loading areas	

		RES	IDENTIAL UNITS
Total Number of Existing Units:	76	Total Number of Proposed Units:	378
		Existing Units at 383 Sherbourne	32
		Rental Replacement Units:	44
		New Residential Units:	302

BREAKDOWN OF PROJECT DATA BY CO	JIIII CIALIATO		RESIDENTIA	AL LINIT MIX
Unit Type	Unit Count	Typical Unit Size	KLSIDLIVIIA	Percent
Bachelor	116	29.6sqm		38%
1 Bedroom	109	54.1sqm		36%
2 Bedroom	46	63.2sqm		15%
3 Bedroom	<u>31</u>	82.7sqm		<u>10%</u>
TOTAL:	302		TOTAL:	100%
	-		AN	IENITY
REQUIRED (Excludes 383 Sherbourne)	sqm	PROVIDED		sqm
RESIDENTIAL (Dwelling Unit in an Apartme	nt Building)			
Indoor Amenity Required (2sqm/unit):	692.00	Indoor Amenity Provided:		935.00

Outdoor Amenity Required (2sqm/unit):	692.00	Outdoor Amenity Provided:	<u>450.00</u>
TOTAL:	1384.00	TOTAL:	1385.00
		P	ARKING SPACE
REQUIRED	Spaces	PROVIDED	Spaces
Parking Zone A (Minimum)		Total Parking Spaces Provided:	8
		Breakdown of parking space by use alloca	ition:
Barrier-Free	7	Residential	6
Visitor (2.0+0.01 per unit)	5	Residential Visitors	2
		Breakdown of parking space by location:	
		Open Surface Spaces	0
		Above Grade Parking	2
		Below Grade Parking	6
		BICYCLE PA	ARKING SPACE
REQUIRED		PROVIDED	
RESIDENTIAL (Dwelling Unit in an Aparti	ment Building)		
	Spaces		Spaces
Long-term Bicycle Parking Space :	341	Long-term Bicycle Parking Space :	341

		BICYCLE P	ARKING SPACE
REQUIRED		PROVIDED	
RESIDENTIAL (Dwelling Unit in an Apartr	ment Building)		
	Spaces		Spaces
Long-term Bicycle Parking Space :	341	Long-term Bicycle Parking Space :	341
Short-term Bicycle Parking :	76	Short-term Bicycle Parking :	76
<u> </u>		, , , , , , , , , , , , , , , , , , ,	
		L	OADING SPACE
REQUIRED		PROVIDED	
RESIDENTIAL (Dwelling Unit in an Apartr	ment Building)		
Type of Loading Space Required:	1 Type "G"	Type of Loading Space Provided:	1 Type "G"
TOTAL No. of Loading Spaces:	1	TOTAL No. of Loading Spaces	: 1
•			

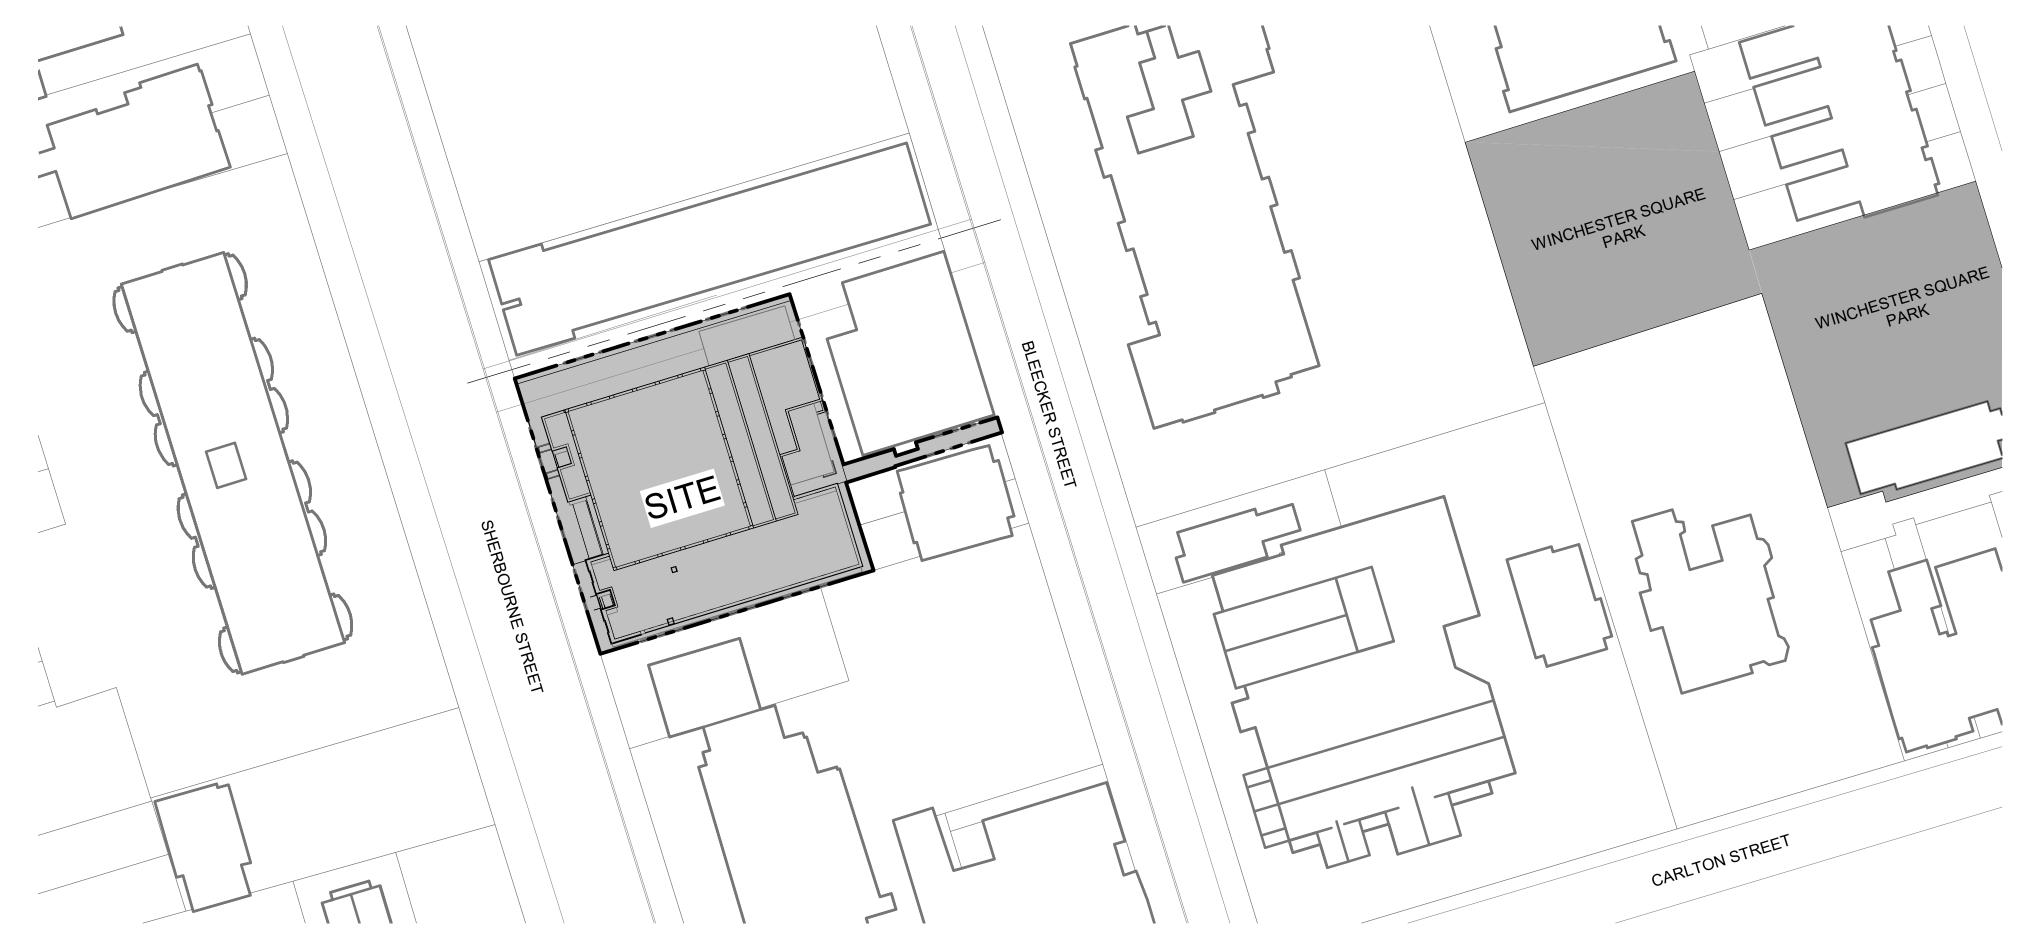

1	CONTEXT PLAN
A001 /	Scale: 1 : 500

GF	FA Construction	1	GFA Dedu	ctions	GFA Resid	dential	GFA Indoor	Amenity	GFA Outdoor	Amenity	383 Sherbou	rne GFA
Level	sqft	sqm	sqft	sqm	sqft	sqm	sqft	sqm	sqft	sqm	sqft	sqm
MPH	4.638 ft²	431 m²	4 000 #2	431 m²	0 ft²	0 m²	0 ft²	0 m²	0 ft²	0 m²	0 ft²	0 2
	,		4,638 ft²					-	-			0 m²
LEVEL 39 LEVEL 38	5,393 ft²	501 m ²	381 ft²	35 m²	5,012 ft²	466 m²	0 ft²	0 m²	0 ft²	0 m²	0 ft²	0 m²
	5,393 ft²	501 m ²	381 ft²	35 m²	5,012 ft²	466 m²	0 ft²	0 m²	0 ft²	0 m²	0 ft²	0 m²
LEVEL 37 LEVEL 36	6,111 ft²	568 m²	381 ft²	35 m²	5,731 ft²	532 m²	0 ft²	0 m²	0 ft²	0 m²	0 ft²	0 m²
	6,111 ft²	568 m²	381 ft²	35 m²	5,731 ft²	532 m²	0 ft²	0 m ²	0 ft²	0 m ²	0 ft²	0 m²
LEVEL 35	6,111 ft²	568 m²	381 ft²	35 m²	5,731 ft²	532 m²	0 ft²	0 m ²	0 ft²	0 m ²	0 ft²	0 m²
LEVEL 34	6,111 ft²	568 m²	381 ft²	35 m²	5,731 ft²	532 m²	0 ft²	0 m²	0 ft²	0 m ²	0 ft²	0 m²
LEVEL 33	6,111 ft²	568 m²	381 ft²	35 m²	5,731 ft²	532 m²	0 ft²	0 m ²	0 ft²	0 m ²	0 ft²	0 m²
LEVEL 32	6,111 ft²	568 m²	381 ft²	35 m²	5,731 ft²	532 m²	0 ft²	0 m²	0 ft²	0 m²	0 ft²	0 m²
LEVEL 31	6,111 ft²	568 m²	381 ft²	35 m²	5,731 ft²	532 m²	0 ft²	0 m²	0 ft²	0 m ²	0 ft²	0 m²
LEVEL 30	6,111 ft²	568 m²	381 ft²	35 m²	5,731 ft ²	532 m²	0 ft²	0 m²	0 ft²	0 m²	0 ft²	0 m²
LEVEL 29	6,111 ft²	568 m²	381 ft²	35 m²	5,731 ft²	532 m²	0 ft²	0 m²	0 ft²	0 m²	0 ft²	0 m²
LEVEL 28	6,111 ft²	568 m²	381 ft²	35 m²	5,731 ft ²	532 m²	0 ft²	0 m²	0 ft²	0 m²	0 ft²	0 m²
LEVEL 27	6,111 ft²	568 m²	381 ft²	35 m²	5,731 ft ²	532 m²	0 ft²	0 m²	0 ft²	0 m ²	0 ft²	0 m²
LEVEL 26	6,111 ft²	568 m²	381 ft²	35 m²	5,731 ft ²	532 m²	0 ft²	0 m²	0 ft²	0 m ²	0 ft²	0 m²
LEVEL 25	6,111 ft²	568 m²	381 ft²	35 m²	5,731 ft²	532 m²	0 ft²	0 m²	0 ft²	0 m ²	0 ft²	0 m²
LEVEL 24	6,111 ft²	568 m²	381 ft²	35 m²	5,731 ft²	532 m²	0 ft²	0 m²	0 ft²	0 m²	0 ft²	0 m²
LEVEL 23	6,111 ft²	568 m²	381 ft²	35 m²	5,731 ft²	532 m²	0 ft²	0 m²	0 ft²	0 m²	0 ft²	0 m²
LEVEL 22	6,111 ft²	568 m²	381 ft²	35 m²	5,731 ft ²	532 m²	0 ft²	0 m²	0 ft²	0 m²	0 ft²	0 m²
LEVEL 21	6,111 ft²	568 m²	381 ft²	35 m²	5,731 ft²	532 m²	0 ft²	0 m²	0 ft²	0 m²	0 ft²	0 m²
LEVEL 20	6,111 ft²	568 m²	381 ft²	35 m²	5,731 ft ²	532 m²	0 ft²	0 m²	0 ft²	0 m²	0 ft²	0 m²
LEVEL 19	6,111 ft²	568 m²	381 ft²	35 m²	5,731 ft ²	532 m²	0 ft²	0 m²	0 ft²	0 m²	0 ft²	0 m²
LEVEL 18	6,111 ft²	568 m²	381 ft²	35 m²	5,731 ft ²	532 m²	0 ft²	0 m²	0 ft²	0 m²	0 ft²	0 m²
LEVEL 17	6,111 ft²	568 m²	381 ft ²	35 m²	5,731 ft ²	532 m²	0 ft ²	0 m²	0 ft²	0 m²	0 ft²	0 m²
LEVEL 16	6,111 ft²	568 m²	381 ft²	35 m²	5,731 ft ²	532 m²	0 ft²	0 m²	0 ft²	0 m²	0 ft²	0 m²
LEVEL 15	6,111 ft²	568 m²	381 ft²	35 m²	5,731 ft ²	532 m²	0 ft²	0 m²	0 ft²	0 m²	0 ft²	0 m²
LEVEL 14	6,111 ft²	568 m²	381 ft²	35 m²	5,731 ft ²	532 m²	0 ft²	0 m²	0 ft²	0 m²	0 ft²	0 m²
LEVEL 13	6,111 ft²	568 m²	381 ft²	35 m²	5,731 ft ²	532 m²	0 ft²	0 m²	0 ft²	0 m²	0 ft²	0 m²
LEVEL 12	6,111 ft²	568 m²	381 ft²	35 m²	5,731 ft ²	532 m²	0 ft²	0 m²	0 ft²	0 m²	0 ft²	0 m²
LEVEL 11	6,111 ft²	568 m²	381 ft²	35 m²	5,731 ft ²	532 m²	0 ft²	0 m²	0 ft²	0 m²	0 ft²	0 m²
LEVEL 10	6,111 ft²	568 m²	381 ft²	35 m²	5,731 ft²	532 m²	0 ft²	0 m²	0 ft²	0 m²	0 ft²	0 m²
LEVEL 09	6,111 ft²	568 m²	381 ft²	35 m²	5,731 ft ²	532 m²	0 ft²	0 m²	0 ft²	0 m²	0 ft²	0 m²
LEVEL 08	6,111 ft²	568 m²	381 ft²	35 m²	154 ft²	14 m²	5,577 ft²	518 m²	0 ft²	0 m²	0 ft²	0 m²
LEVEL 07	5,632 ft ²	523 m²	381 ft²	35 m²	5,251 ft ²	488 m²	0 ft²	0 m²	0 ft²	0 m²	0 ft²	0 m²
LEVEL 06	5,632 ft²	523 m²	381 ft²	35 m²	5,251 ft²	488 m²	0 ft²	0 m²	0 ft²	0 m²	0 ft²	0 m²
LEVEL 05	4,921 ft ²	457 m²	381 ft²	35 m²	2,454 ft ²	228 m²	2,087 ft ²	194 m²	0 ft²	0 m²	0 ft²	0 m²
LEVEL 04	4,599 ft ²	427 m²	906 ft²	84 m²	2,531 ft²	235 m²	1,161 ft²	108 m²	4,846 ft²	450 m²	4,249 ft ²	395 m²
LEVEL 03	6,759 ft²	628 m²	1,978 ft²	184 m²	4,781 ft²	444 m²	0 ft²	0 m ²	0 ft²	0 m²	4,249 ft ²	395 m²
EVEL 02	6,880 ft ²	639 m²	4,010 ft ²	373 m²	2,870 ft ²	267 m²	0 ft²	0 m²	0 ft²	0 m²	4,249 ft ²	395 m²
LEVEL 01	6,925 ft ²	643 m²	3,278 ft ²	304 m²	2,412 ft ²	224 m²	1,235 ft²	115 m²	0 ft ²	0 m ²	4,249 ft ²	395 m²
TOTAL	240,115 ft ²	22,307 m ²	28,134 ft ²	2,614 m ²	201,922 ft²	18,759 m²	10,059 ft ²	935 m²	4,846 ft²	450 m²	16,996 ft²	1,579 m²

GFA Construction U/G		GFA Deductions U/G		GFA Residential U/G		
Level	sqft	sqm	sqft	sqm	sqft	sqm
LEVEL P1	8,662 ft ²	805 m²	8,662 ft ²	805 m²	0 ft²	0 m ²
LEVEL P2	8,662 ft ²	805 m²	8,662 ft ²	805 m²	0 ft²	0 m²
TOTAL	17,323 ft ²	1,609 m²	17,323 ft ²	1,609 m²	0 ft²	0 m ²

TOTAL NO. OF PARKING S	TALLS	RES	VIS	NON-RES	BF
Level	TOTAL No. of Stalls	No. of RESIDENTIAL Stalls	No. of VISITOR Stalls	No. of NON-RES Stalls	No. of BARRIER-FREE Stalls
LEVEL 01	2	0	2	0	1
LEVEL P1	0	0	0	0	0
LEVEL P2	6	6	0	0	4
TOTAL PARKING SPACES	8	6	2	0	5

TOTAL RESIDENTIAL E	BIKE SPACES	RES LT	RES ST
Level	Total Bike Spaces	Long Term RESIDENTIAL	Short Term RESIDENTIAL
LEVEL 01	76	0	76
LEVEL P1	295	295	0
LEVEL P2	46	46	0
TOTAL BIKE SPACES	417	341	76

RESIDENTIAL UNIT MIX COUNT

Level	Total	BA	1B (+)	2B (+)	3B (+)
LEVEL 39	6	0	1	4	1
LEVEL 38	6	0	1	4	1
LEVEL 37	10	4	3	2	1
LEVEL 36	10	4	3	2	1
LEVEL 35	10	4	3	2	1
LEVEL 34	10	4	3	2	1
LEVEL 33	10	4	3	2	1
LEVEL 32	10	4	3	2	1
LEVEL 31	10	4	3	2	1
LEVEL 30	10	4	3	2	1
LEVEL 29	10	4	3	2	1
LEVEL 28	10	4	4	1	1
LEVEL 27	10	4	4	1	1
LEVEL 26	10	4	4	1	1
LEVEL 25	10	4	4	1	1
LEVEL 24	10	4	4	1	1
LEVEL 23	10	4	4	1	1
LEVEL 22	10	4	4	1	1
LEVEL 21	10	4	4	1	1
LEVEL 20	10	4	4	1	1
LEVEL 19	10	4	4	1	1
LEVEL 18	10	4	4	1	1
LEVEL 17	10	4	4	1	1
LEVEL 16	10	4	4	1	1
LEVEL 15	10	4	4	1	1
LEVEL 14	10	4	4	1	1
LEVEL 13	10	4	4	1	1
LEVEL 12	10	4	4	1	1
LEVEL 11	10	4	4	1	1
LEVEL 10	10	4	4	1	1
LEVEL 09	10	4	4	1	1
LEVEL 08	0	0	0	0	0
LEVEL 07	0	0	0	0	0
LEVEL 06	0	0	0	0	0
LEVEL 05	0	0	0	0	0
LEVEL 04	0	0	0	0	0
LEVEL 03	0	0	0	0	0
LEVEL 02	0	0	0	0	0
LEVEL 01	0	0	0	0	0
TOTAL UNITS	302	116	109	46	31
	100%	39%	36%	15%	10%

387 SHERBOURNE ST RENTAL REPLACEMENT UNIT COUNT Level Total BA 1B (+) LEVEL 07 10 4 6 LEVEL 06 10 4 6

REPLACEMENT UNITS	44	22	22
LEVEL 02	5	3	2
LEVEL 03	9	5	4
LEVEL 04	5	3	2
LEVEL 05	5	3	2
LEVEL 06	10	4	6
LL V LL O1	10		

REPLACEMENT + NEW F	RESIDENTIA	L UNIT COUI	NT		
REPLACEMENT+NEW UNITS	Total	BA	1B (+)	2B (+)	3
	346	138	131	46	
TOTAL UNITS	346	138	131	46	

EXISTING UNIT COUNT A	AT 383 SHEF	RBOURNE ST	
Level	Total	BA	1B (+)
383 - FOURTH FLOOR	8	4	4
383 - THIRD FLOOR	8	4	4
383 - SECOND FLOOR	8	4	4
383 - MAIN FLOOR	8	6	2
202 CHEDDOLIDNE LINITS	22	10	1.1

TOTAL UNITS (EXISTING	+ REPLACE	EMENT + NE	W RESIDENT	TIAL)	
ALL UNITS	Total	BA	1B (+)	2B (+)	3

N.IS SHERBOURNE INC.

CLIENT

NJS SHERBOURNE INC

DATE	DESCRIPTION
2021-06-28	ISSUED FOR ZBA SUBMISSION
2023-05-12	ISSUED FOR ZBA 2ND SUBMISSION
	1202: 00 20


	DATE	DESCRIPTION
-\/IS	SIONS	

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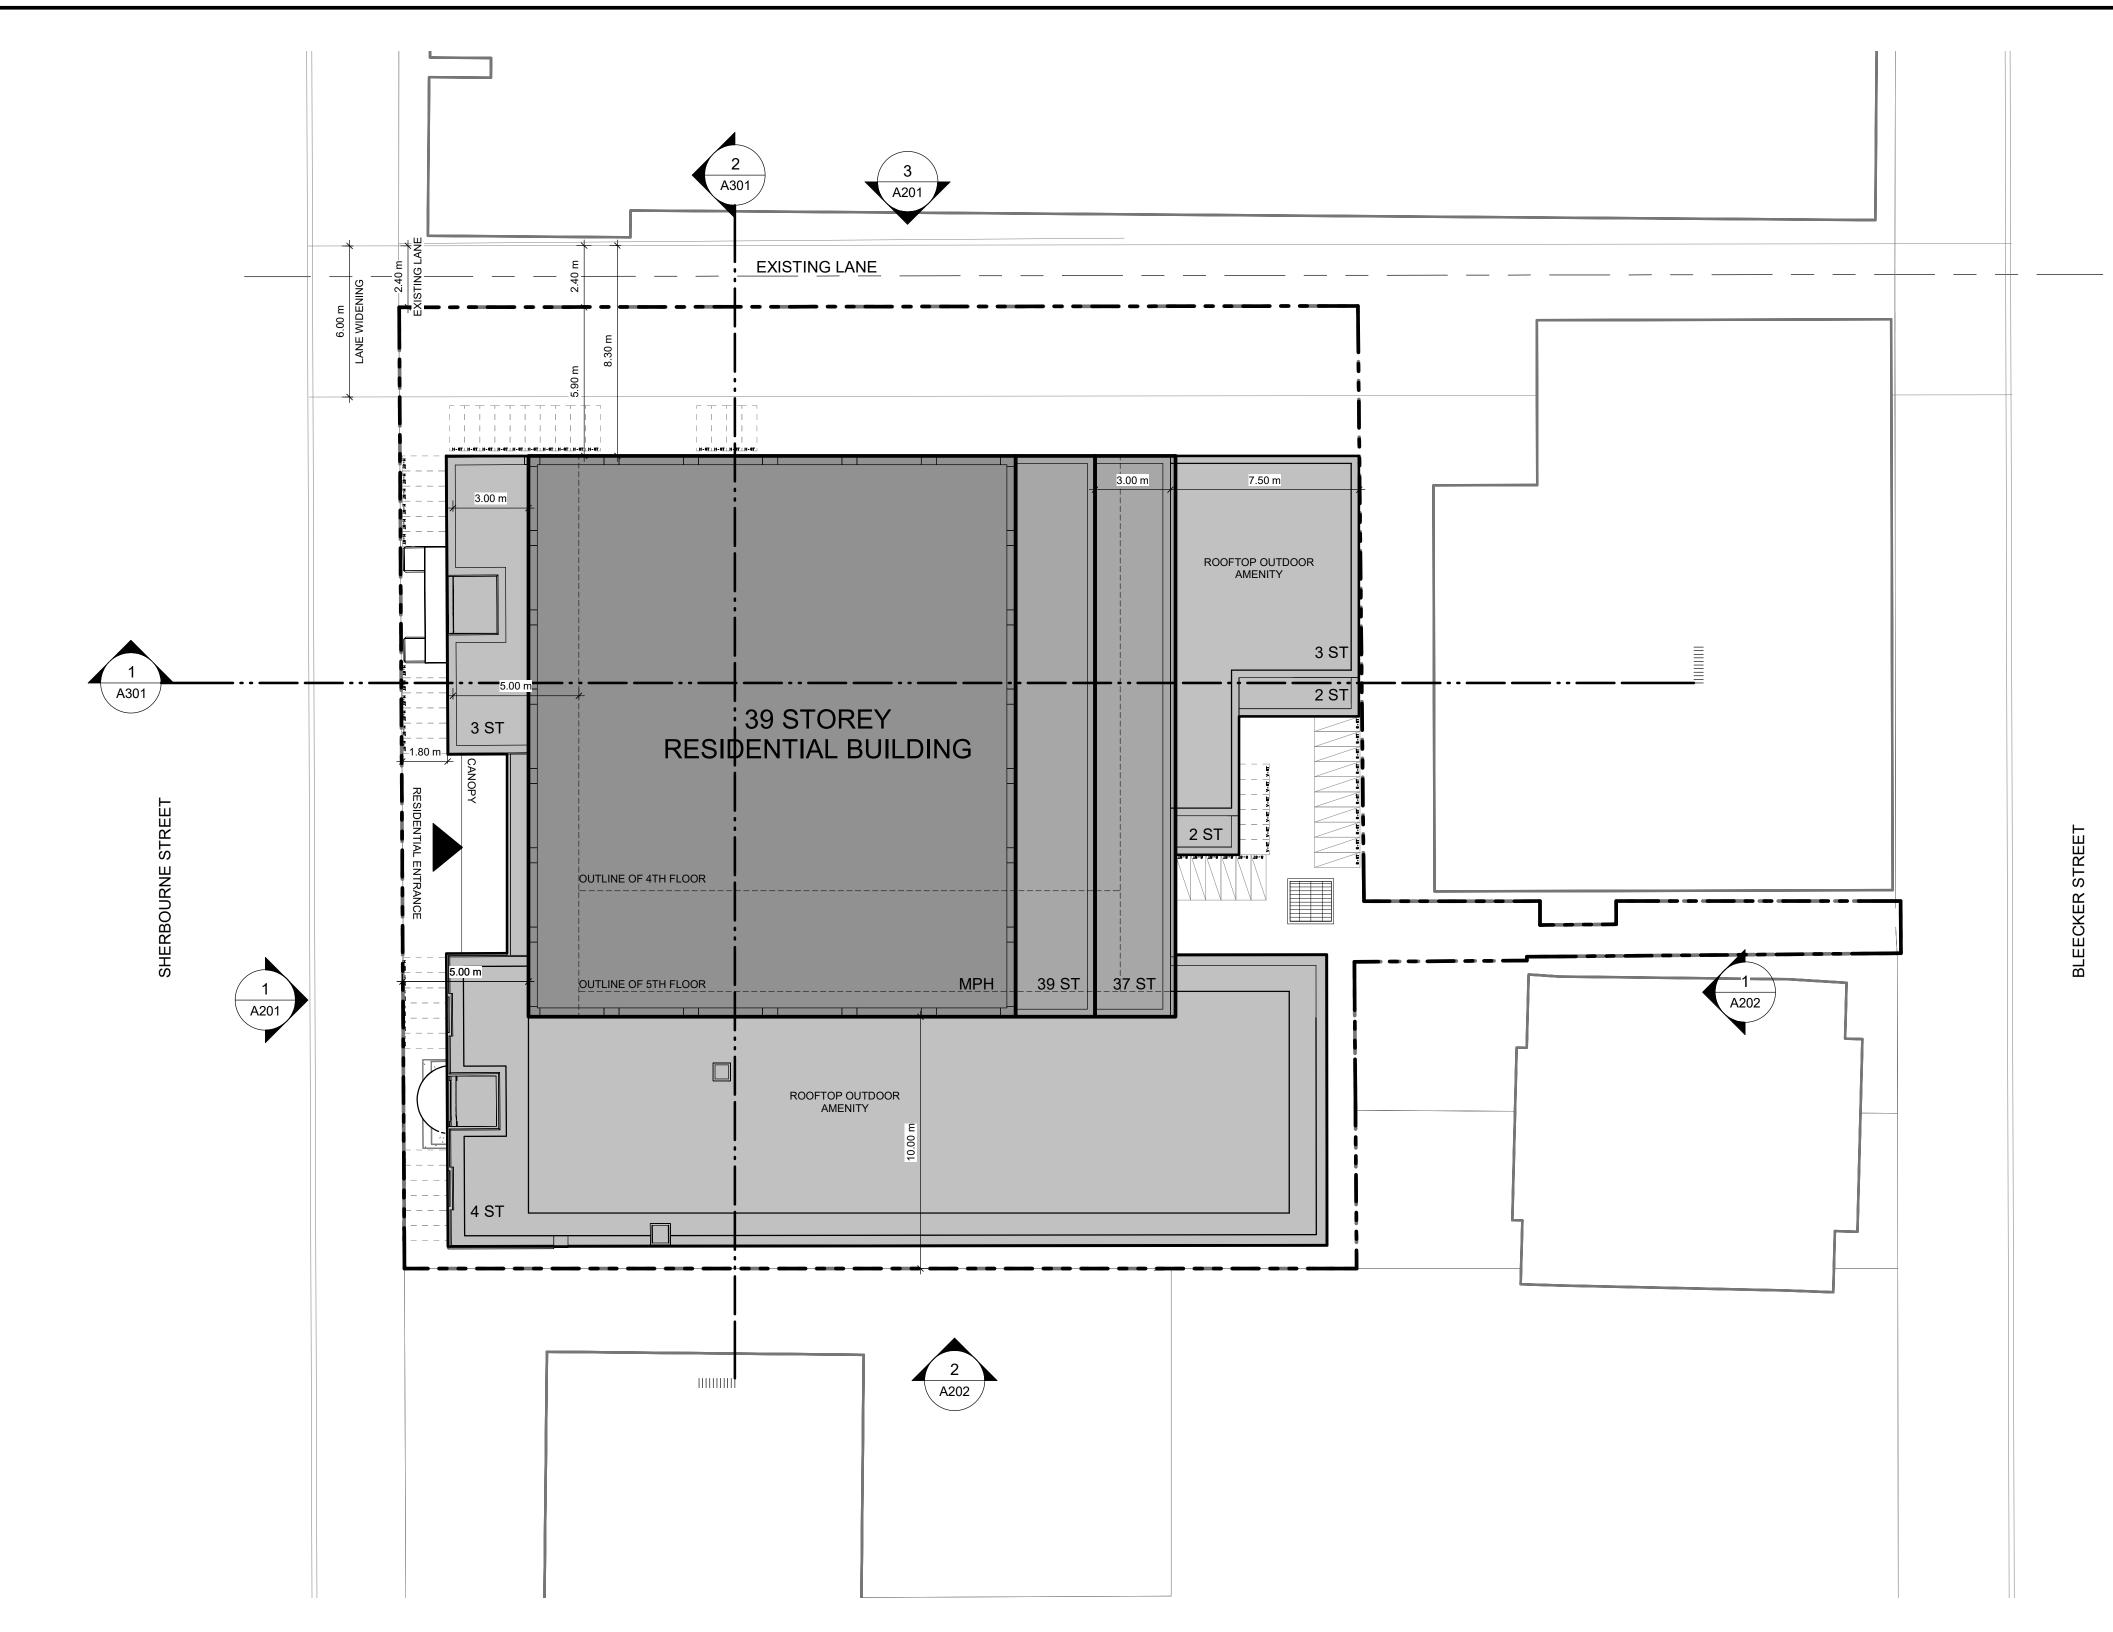


383-387 SHERBOURNE ST.

383-387 Sherbourne St. Toronto, ON Canada

CONTEXT PLAN & STATISTICS

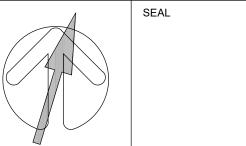	117733		,	A001
Γ	PROJECT NO:		DWG NO.	
	Author	Checker	APR 2023	1 : 500
	DRAWN BY:	CHKD' BY:	DATE:	SCALE:



NOTES:

- LOADING AREA TO BE DESIGNED TO
- COMPLY WITH DESIGN CODE ONTARIO BUILDING CODE COMPLY WITH DESIGN CODE - CITY BULK LIFT VEHICLE IN ADDITION TO BUILDING CODE REQUIREMENTS
- C. COMPLY WITH IMPACT FACTOR 5% FOR MAXIMUM VEHICULAR SPEEDS TO 15 KM/H AND 30% FOR HIGHER SPEEDS
- 200 MM THICK REINFORCED CONCRETE PAD FOR THE LOADING AND BIN HOLDING AREA . THE SPACE WILL HAVE LESS THAN A 2% SLOPE. AND TO BE DESIGNED IN ACCORDANCE WITH THE O.B.C. AND TO SUIT CITY OF TORONTO GARBAGE TRUCK LOAD AND IMPACT FACTORS.
- A TRAINED ON-SITE PERSON MUST BE AVAILABLE TO MANOEUVER THE BINS FOR THE COLLECTION DRIVER AND ALSO ACT AS A FLAG-MAN WHEN THE TRUCK IS REVERSING. IN THE EVENT THE ON-SITE STAFF IS UNAVAILABLE AT THE TIME WHEN THE CITY COLLECTION VEHICLE ARRIVALS, THE COLLECTION VEHICLE WILL LEAVE THE SITE AND NOT RETURN UNTIL THE NEXT SCHEDULED COLLECTION DAY.
- IF THE LOADING AREA IS FULL AND THE COLLECTION VEHICLE CANNOT ACCESS TO LOADING AREA THEN THE VEHICLE WILL RETURN THE NEXT REGULARLY COLLECTION DATE.
- THE TYPE G LOADING SPACE MAY BE SHARED BUT THE OWNER WILL ENSURE THE SPACE IS VACANT FOR THE CITY COLLECTION VEHICLE ON THE SCHEDULED PICK-UP TIME
- WASTE MANAGEMENT METHOD: SINGLE CHUTE WITH TRI-SORTER AT THE BOTTOM EQUIPPED WITH GARGAGE COMPACTOR
- REFER TO LANDSCAPE DRAWINGS FOR THE DETAILS OF THE BICYCLE RINGS OR RACKS
- PARKING GARAGE AIR EXHAUST WILL BE LOCATED AWAY FROM PEDESTRIANS. ONLY THE EXHAUST SHAFT WILL HAVE EXTRACT FANS INSTALLED. SOUND AND VIBRATION DAMPENING TO BE REVIEWED BY THE ACOUSTIC AND MECHANICAL ENGINEERS
- CANADA POST STAFF WILL BE PROVIDED WITH MASTER KEY TO ENTER THE BUILDING
- REFER TO LANDSCAPE DRAWING FOR THE SITE GRADING, SIDEWALK, CURB & RETAILING WALL DETAILS
- ALONG THE WASTE MANAGEMENT COLLECTION VEHICLE ACCESS ROUTE, THE MAXIMUM SLOPE OF THE SURFACE TO BE NO GREATER THAN 8%, THE MINIMUM VERTICAL CLEARANCE OD 4.4 METERS TO BE MAINTAINED. REFER TO SITE GRADING PLANS FOR THE DETAILS.

Statistics Template - Toronto Green Standard Version 3.0 Mid to High Rise Residential and all New Non-Residential Development

The Toronto Green Standard Version 3.0 Statistics Template is submitted with Site Plan Control Applications and stand alone Zoning Bylaw Amendment applications. Complete the table and copy it directly onto the Site Plan submitted as part of the application.

For Zoning Bylaw Amendment applications: complete General Project Description and Section 1. For Site Plan Control applications: complete General Project Description, Section 1 and Section 2.

General Project Description	Proposed
Total Gross Floor Area	18,759 sm
Breakdown of project components (m²)	
Residential	18,759 sm
Retail	
Commercial	
Industrial	
Institutional/Other	
Total number of residential units	346 + 32 existing = 378

Section 1: For Stand Alone Zoning Bylaw Amendment Applications and

Site Plan Control Applications

11-0063 2018-05

Automobile Infrastructure	Required	Proposed	Proposed 9
Number of Parking Spaces	12	8	37%
Number of parking spaces dedicated for priority LEV parking	N/A	N/A	N/A
Number of parking spaces with EVSE	2	2	100%
Cycling Infrastructure	Required	Proposed	Proposed
Number of long-term bicycle parking spaces (residential)	341	341	100%
Number of long-term bicycle parking spaces (all other uses)			
Number of long-term bicycle parking (all uses) located on:			
a) first storey of building			
b) second storey of building			
c) first level below-ground		295	
d) second level below-ground		46	
e) other levels below-ground			

3 1 1

Statistics Template - Toronto Green Standard Version 3.0 Mid to High Rise Residential and all **New Non-Residential Development**

Cycling Infrastructure	Required	Proposed	Proposed %
Number of short-term bicycle parking spaces (residential)	76	76	100%
Number of short-term bicycle parking spaces (all other uses)			
Number of male shower and change facilities (non-residential)			
Number of female shower and change facilities (non-residential)			
Tree Planting & Soil Volume	Required	Proposed	Proposed %
Total Soil Volume (40% of the site area \div 66 m ² x 30 m ³).			

Section 2: For Site Plan Control Applications

Cycling Infrastructure	Required	Proposed	Proposed %
Number of short-term bicycle parking spaces (all uses) at-grade or on first level below grade			
UHI Non-roof Hardscape	Required	Proposed	Proposed %
Total non-roof hardscape area (m²)			
Total non-roof hardscape area treated for Urban Heat Island (minimum 50%) (m²)			
Area of non-roof hardscape treated with: (indicate m²)			
a) high-albedo surface material			
b) open-grid pavement			
c) shade from tree canopy			
d) shade from high-albedo structures			
e) shade from energy generation structures			
Percentage of required car parking spaces under cover (minimum 75%)(non-residential only)			
Green & Cool Roofs	Required	Proposed	Proposed %
Available Roof Space (m²)			
Available Roof Space provided as Green Roof (m²)			
Available Roof Space provided as Cool Roof (m²)			

11-0063 2018-05

Available Roof Space provided as Solar Panels (m²)

Statistics Template - Toronto Green Standard Version 3.0 Mid to High Rise Residential and all

New Non-Residential Development

Page 2 of 3

Water Efficiency	Required	Proposed	Proposed %
Total landscaped site area (m²)			
Landscaped site area planted with drought-tolerant plants (minimum 50%) (m² and %) (if applicable)			
Tree Planting Areas & Soil Volume	Required	Proposed	Proposed %
Total site area (m²)			
Total Soil Volume (40% of the site area ÷ 66 m²x 30 m³)			
Total number of planting areas (minimum of 30m³ soil)			
Total number of trees planted			
Number of surface parking spaces (if applicable)			
Number of shade trees located in surface parking area interior (minimum 1 tree for 5 parking spaces)			

Required	Proposed	Proposed %
required	Тторозса	1 Toposca 70
Required	Proposed	Proposed %
	Required	

11-0063 2018-05

CLIENT

NJS SHERBOURNE INC.

liccc	IOOOLD				
No.	DATE	DESCRIPTION			
1	2021-06-28	ISSUED FOR ZBA SUBMISSION			
2	2023-05-12	ISSUED FOR ZBA 2ND SUBMISSION			

<u>LEGEND</u>

PARKING SPACE DIMENSIONS AS PER CITY OF TORONTO BY-LAW 569-2013 REAR AS AMENDED, BY-LAW 89-2022 PARKING SPACE 5.6m LENGTH 2.6m WIDTH* 2.0m HEADROOM * 0.3m INCREASE ON EACH SIDE WITH OBSTRUCTION

MORE THAN 1.0m FROM THE FRONT OR REAR OF THE PARKING SPACE BARRIER FREE PARKING SPACE (BF) 5.6m LENGTH 3.4m WIDTH - ADJACENT TO 1.5m ACCESS AISLE

2.1m HEADROOM

NO PARKING ZONING STRIP PAINTING

PAINT

MARKED AISLE

R

CONVEX MIRROR ELECTRIC VEHICLE SYMBOL

GREEN ROOF

RENTAL REPLACEMENT UNIT **BICYCLE STALLS BICYCLE TAG** SINGLE HORIZONTAL

ABBREVATIONS 1.8m LENGTH 0.6m WIDTH -HORIZONTAL ு.ப 1.9m MIN HEADROOM -VERTICAL -STACKED SINGLE VERTICAL

1.2m LENGTH ST - SHORT TERM 0.6m WIDTH 1.9m MIN HEADROOM LT - LONG TERM

STACKED 1.8m LENGTH 0.6m WIDTH 1.2m MIN HEADROOM

DESCRIPTION **REVISIONS**


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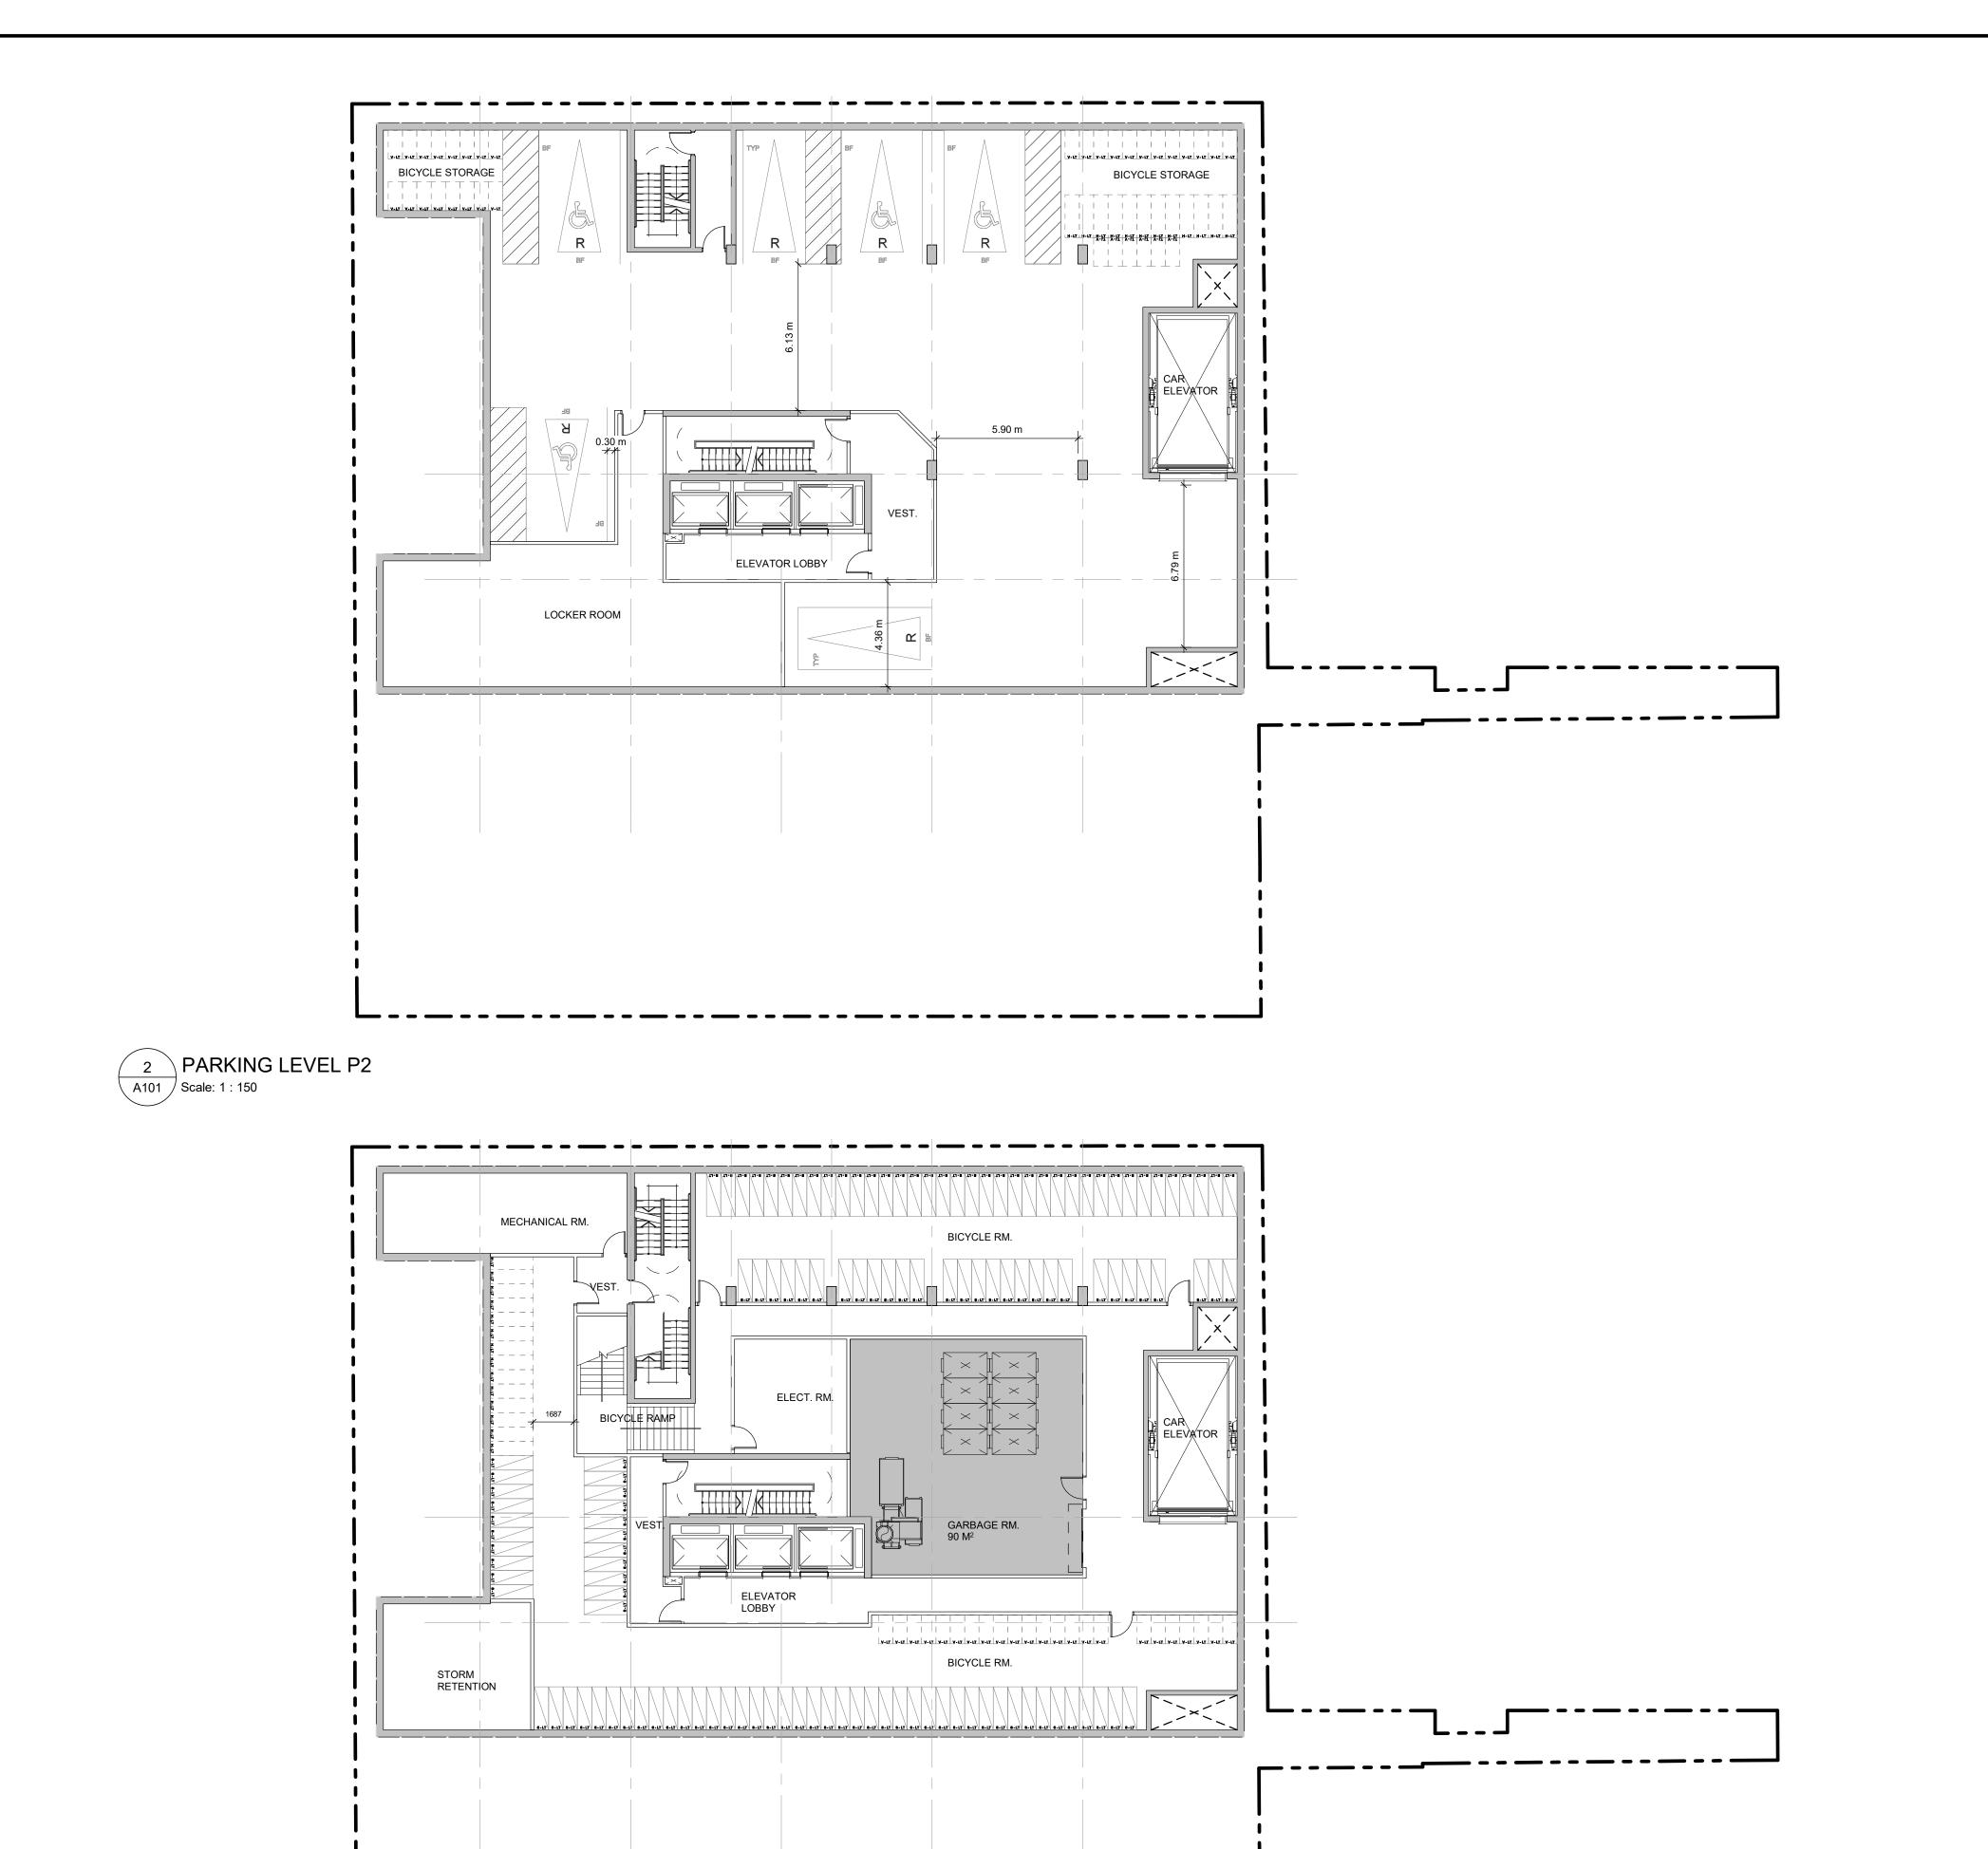
383-387 SHERBOURNE

383-387 Sherbourne St. Toronto, ON Canada

SITE PLAN

DRAWN BY: CHKD' BY: DATE: SCALE: Author APR 2023 1 : 150 PROJECT NO: DWG NO.

117733

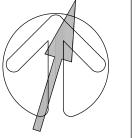

TOTAL NO. OF PARKING STALLS VIS No. of No. of RESIDENTIAL VISITOR
Stalls Stalls No. of Stalls LEVEL P1 **TOTAL PARKING SPACES**

RES LT RES ST

Total Bike Long Term Short Term
Spaces RESIDENTIAL RESIDENTIAL

341

417

TOTAL RESIDENTIAL BIKE SPACES

LEVEL 01 LEVEL P1 LEVEL P2

TOTAL BIKE SPACES

NJS SHERBOURNE INC.

No. DATE DESCRIPTION 1 2021-06-28 ISSUED FOR ZBA SUBMISSION 2 2023-05-12 ISSUED FOR ZBA 2ND SUBMISSION

LEGEND

CLIENT

REAR CITY OF TORONTO BY-LAW 569-2013 AS AMENDED, BY-LAW 89-2022 PARKING SPACE 5.6m LENGTH 2.6m WIDTH* 2.0m HEADROOM

* 0.3m INCREASE ON EACH SIDE WITH OBSTRUCTION MORE THAN 1.0m FROM THE REG FRONT OR REAR OF THE PARKING SPACE FRONT 3400

BARRIER FREE PARKING SPACE (BF) 5.6m LENGTH 3.4m WIDTH - ADJACENT TO 1.5m ACCESS AISLE 2.1m HEADROOM 1.5m WIDE R PAINT MARKED AISLE

NO PARKING ZONING STRIP PAINTING

CONVEX MIRROR ELECTRIC VEHICLE

SYMBOL

ABBREVATIONS

-HORIZONTAL

-VERTICAL -STACKED

GREEN ROOF

RENTAL REPLACEMENT UNIT

BICYCLE STALLS SINGLE HORIZONTAL **BICYCLE TAG** 1.8m LENGTH 0.6m WIDTH ு.ப 1.9m MIN HEADROOM

SINGLE VERTICAL ST - SHORT TERM LT - LONG TERM 1.2m LENGTH 0.6m WIDTH
1.9m MIN HEADROOM


STACKED 1.8m LENGTH 0.6m WIDTH
1.2m MIN HEADROOM

DATE DESCRIPTION REVISIONS

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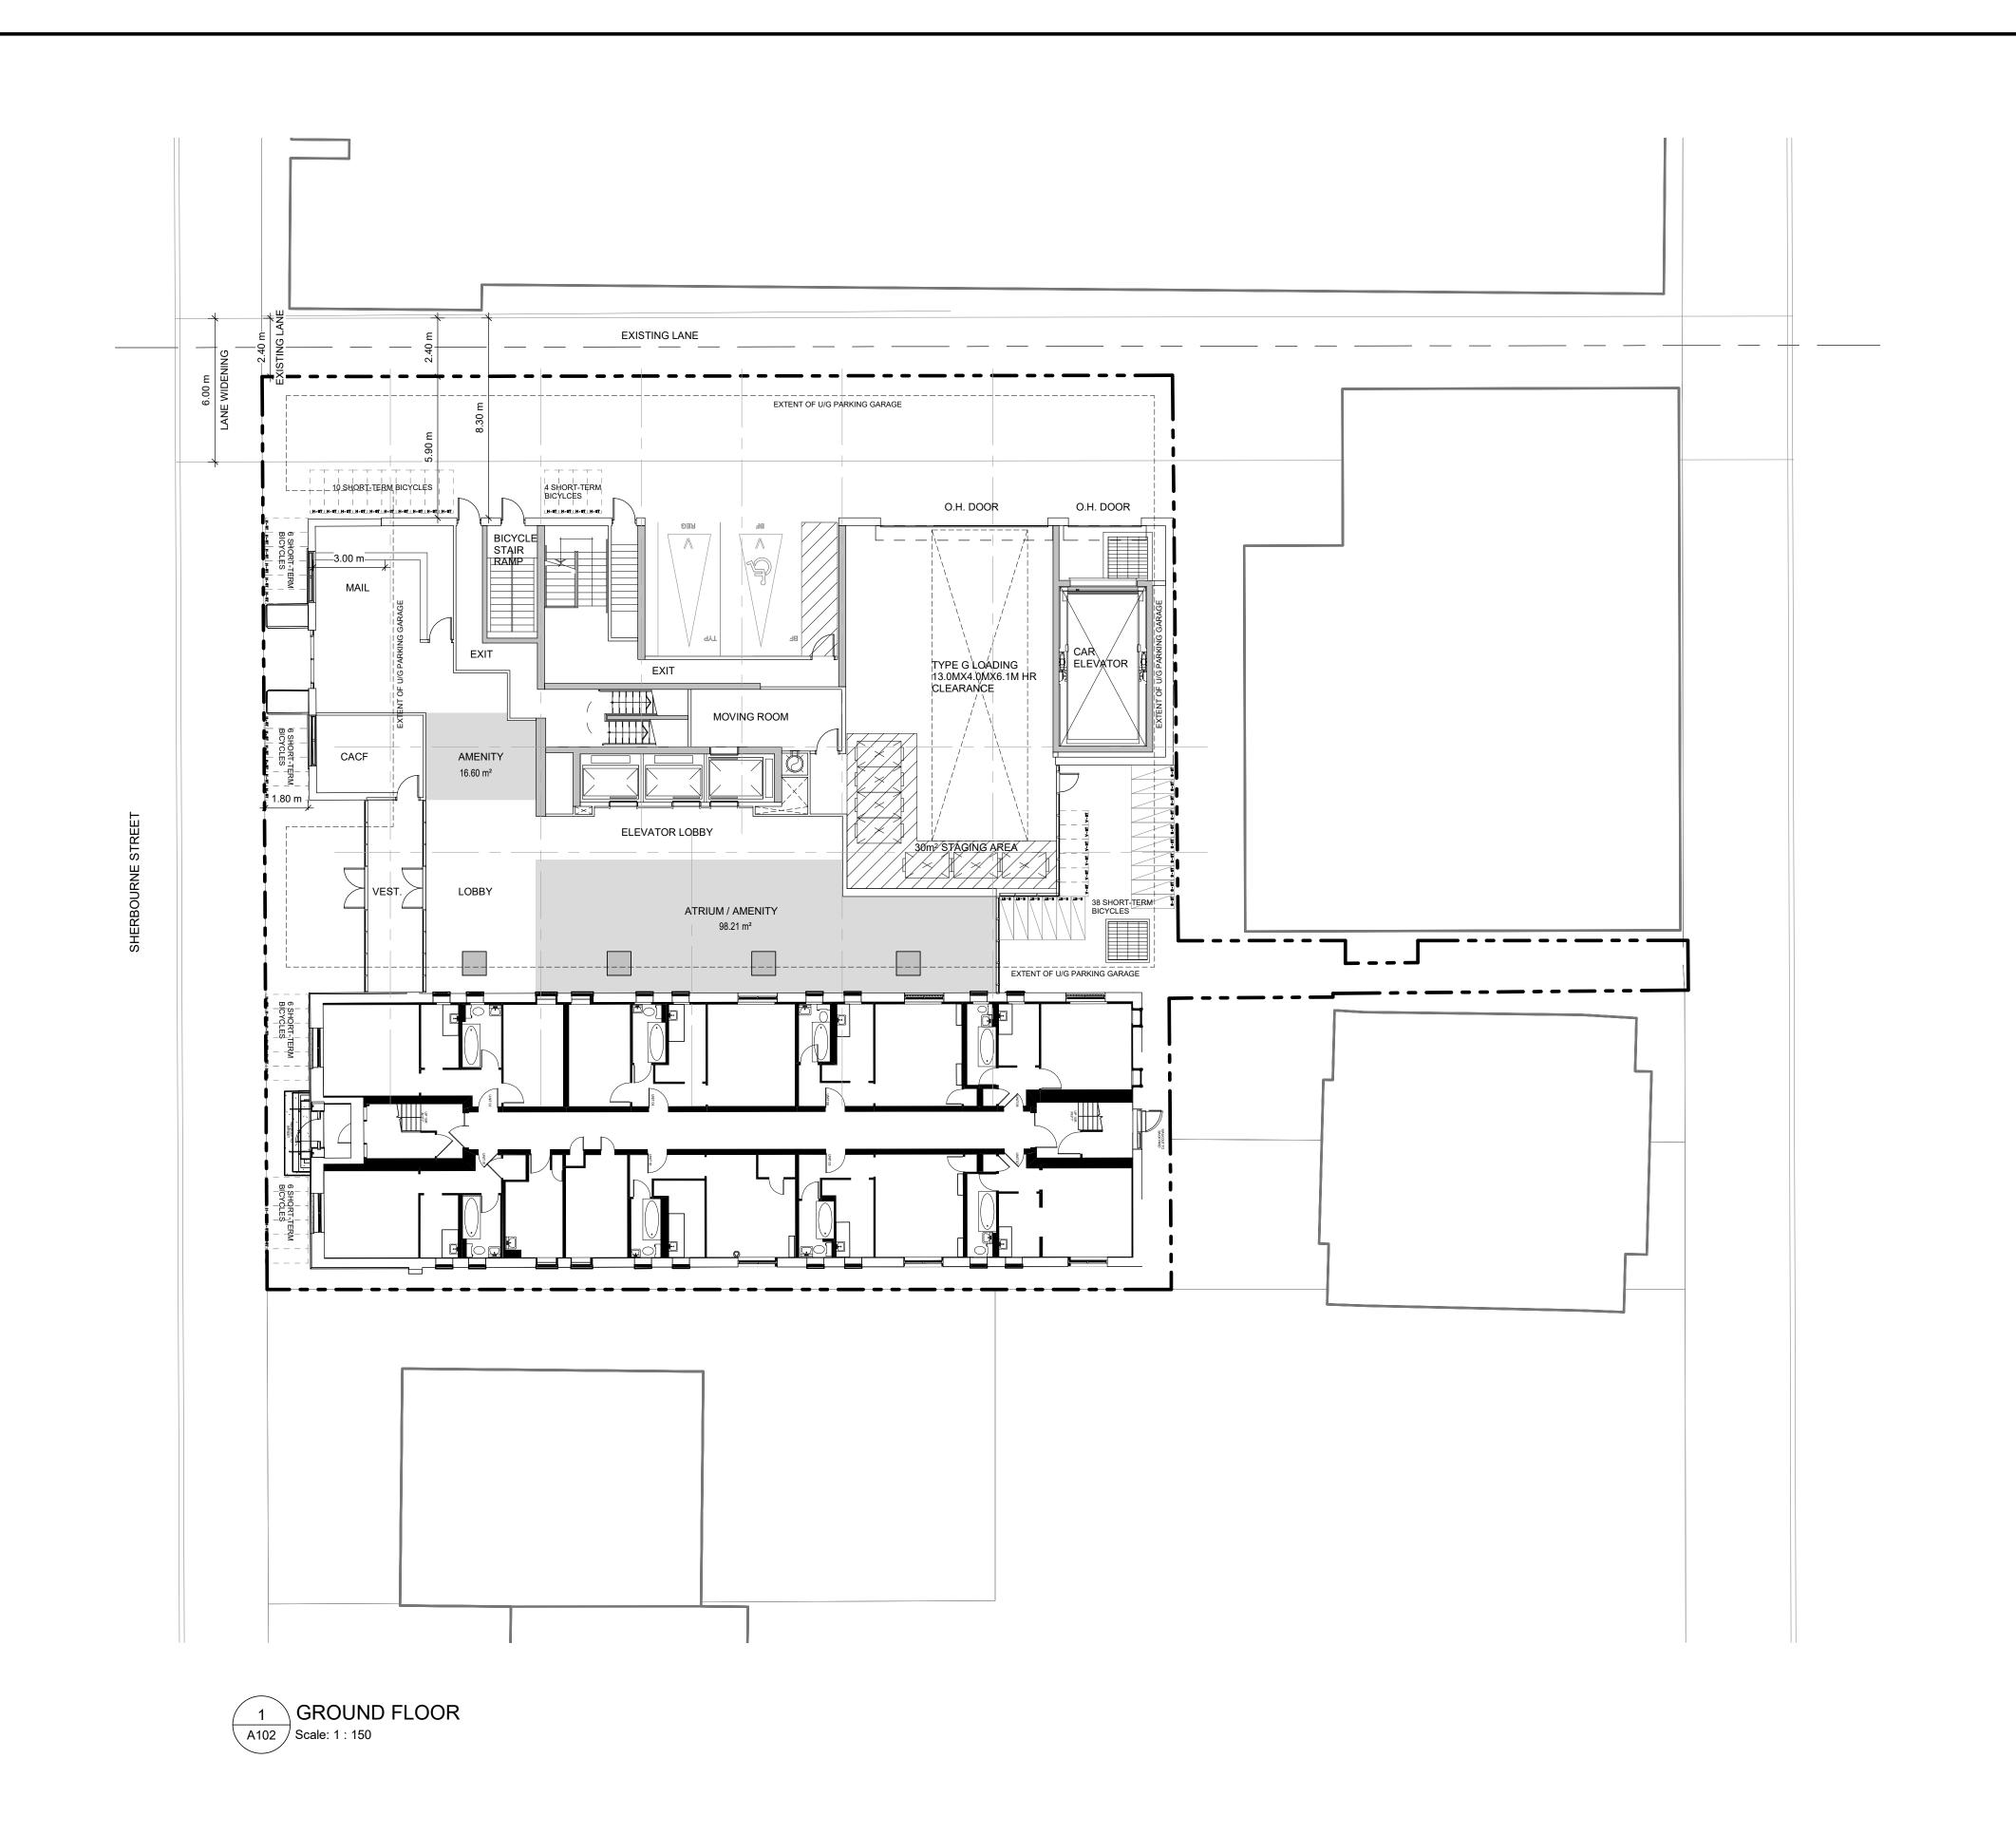
383-387 SHERBOURNE ST.

383-387 Sherbourne St. Toronto, ON Canada

SHEET TITLE P1 TO P2 FLOOR PLANS

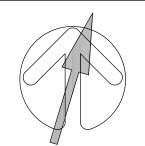DRAWN BY: CHKD' BY: DATE: SCALE: APR 2023 1 : 150 Author PROJECT NO: DWG NO. 117733

1 PARKING LEVEL P1



CLIENT NJS SHERBOURNE INC. DESCRIPTION 1 2021-06-28 ISSUED FOR ZBA SUBMISSION 2 2023-05-12 ISSUED FOR ZBA 2ND SUBMISSION LEGEND REAR CITY OF TORONTO BY-LAW 569-2013
AS AMENDED, BY-LAW 89-2022 PARKING SPACE 5.6m LENGTH 2.6m WIDTH* 2.0m HEADROOM * 0.3m INCREASE ON EACH SIDE WITH OBSTRUCTION MORE THAN 1.0m FROM THE REG FRONT OR REAR OF THE PARKING SPACE FRONT BARRIER FREE PARKING SPACE (BF) 5.6m LENGTH 3.4m WIDTH - ADJACENT TO 1.5m ACCESS AISLE 2.1m HEADROOM R PAINT MARKED AISLE NO PARKING ZONING STRIP PAINTING CONVEX MIRROR ELECTRIC VEHICLE SYMBOL **GREEN ROOF** RENTAL REPLACEMENT UNIT **BICYCLE STALLS** SINGLE HORIZONTAL **BICYCLE TAG ABBREVATIONS** 1.8m LENGTH 0.6m WIDTH -HORIZONTAL ■ ■ 1.9m MIN HEADROOM -VERTICAL -STACKED SINGLE VERTICAL 1.2m LENGTH
0.6m WIDTH
1.9m MIN HEADROOM ST - SHORT TERM LT - LONG TERM STACKED 1.8m LENGTH 0.6m WIDTH 1.2m MIN HEADROOM


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	DATE	DESCRIPTION

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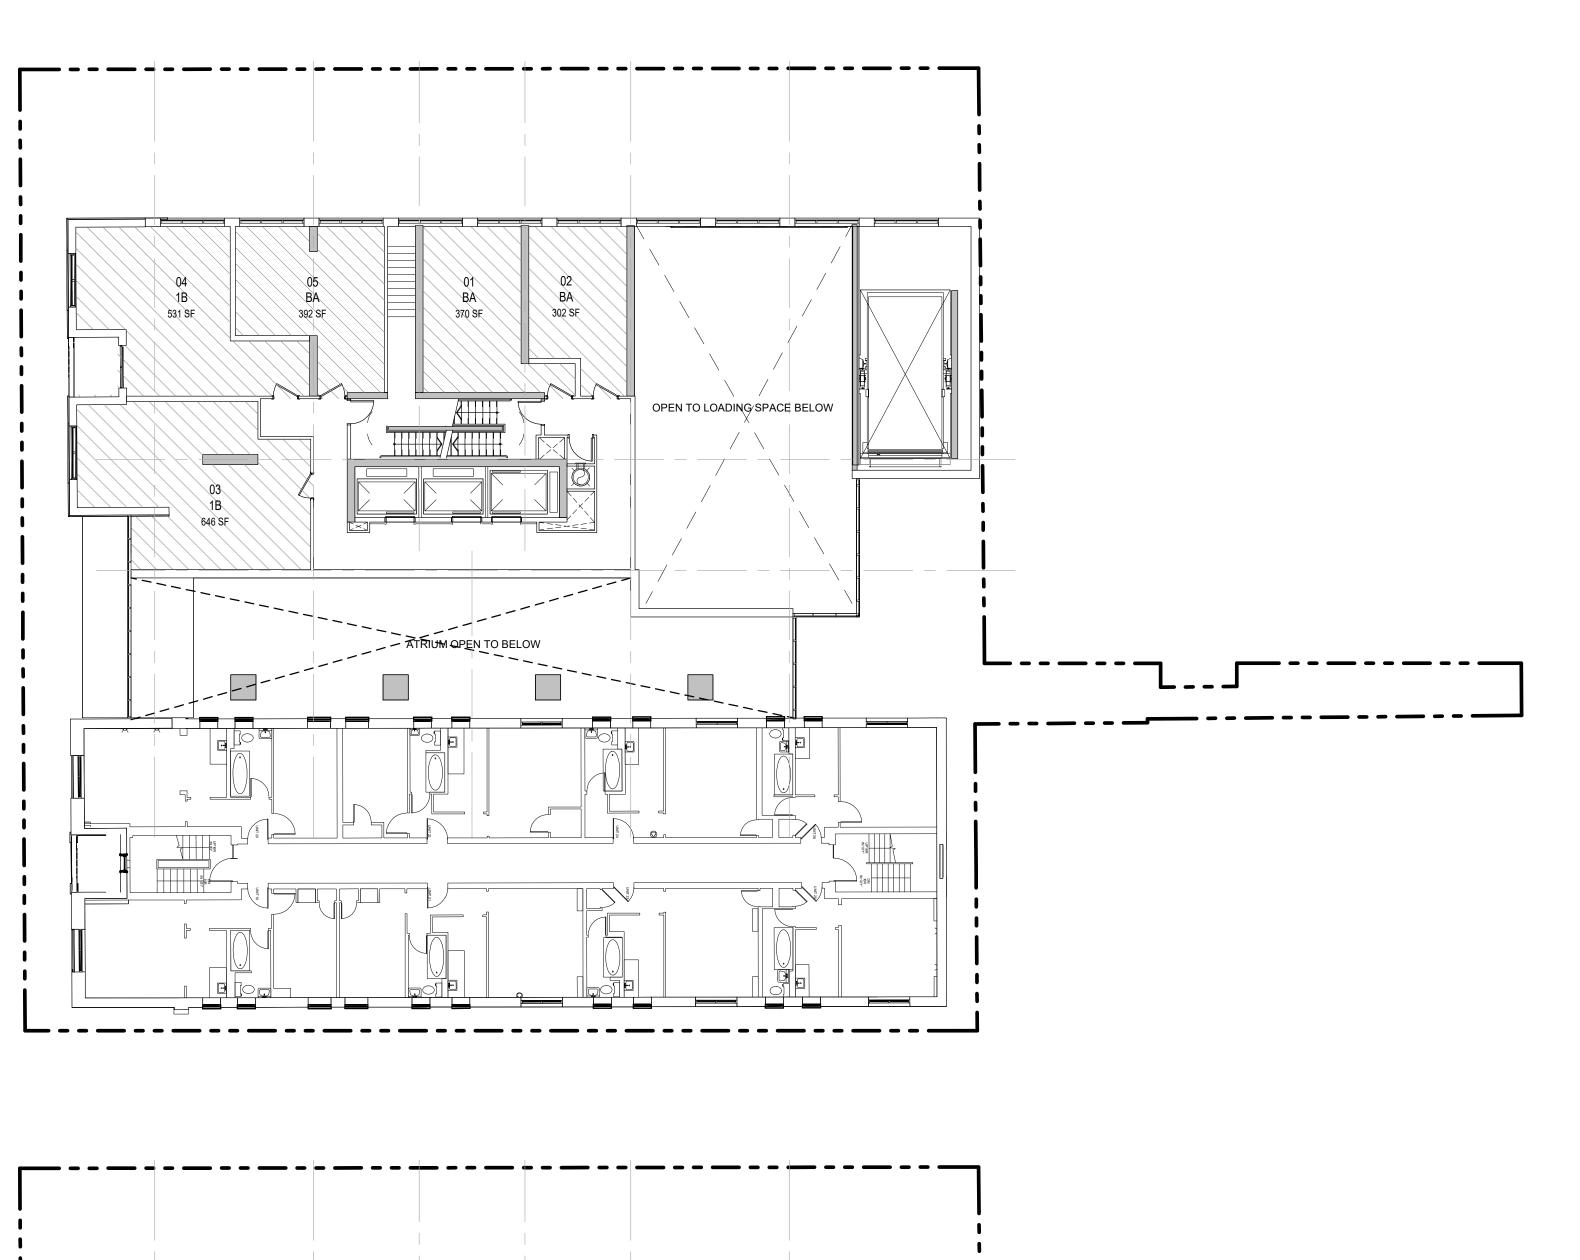



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GROUND FLOOR PLAN

PROJECT NO: 117733		DWG NO.	A102
Author	Checker	APR 2023	1 : 150
DRAWN BY:	CHKD' BY:	DATE:	SCALE:



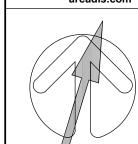

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CLIENT NJS SHERBOURNE INC. No. DATE DESCRIPTION 1 2021-06-28 ISSUED FOR ZBA SUBMISSION 2 2023-05-12 ISSUED FOR ZBA 2ND SUBMISSION LEGEND REAR → PARKING SPACE DIMENSIONS AS PER CITY OF TORONTO BY-LAW 569-2013 AS AMENDED, BY-LAW 89-2022 PARKING SPACE 5.6m LENGTH 2.6m WIDTH* 2.0m HEADROOM * 0.3m INCREASE ON EACH SIDE WITH OBSTRUCTION MORE THAN 1.0m FROM THE REG FRONT OR REAR OF THE PARKING SPACE FRONT BARRIER FREE PARKING SPACE (BF) 5.6m LENGTH 3.4m WIDTH - ADJACENT TO 1.5m ACCESS AISLE 2.1m HEADROOM 1.5m WIDE R | PAINT | MARKED AISLE NO PARKING ZONING STRIP PAINTING CONVEX MIRROR ELECTRIC VEHICLE SYMBOL **GREEN ROOF** RENTAL REPLACEMENT UNIT **BICYCLE STALLS** SINGLE HORIZONTAL **BICYCLE TAG ABBREVATIONS** 1.8m LENGTH 0.6m WIDTH -HORIZONTAL □ □ 1.9m MIN HEADROOM -VERTICAL -STACKED SINGLE VERTICAL ST - SHORT TERM LT - LONG TERM 1.2m LENGTH 0.6m WIDTH
1.9m MIN HEADROOM STACKED 1.8m LENGTH 0.6m WIDTH 1.2m MIN HEADROOM

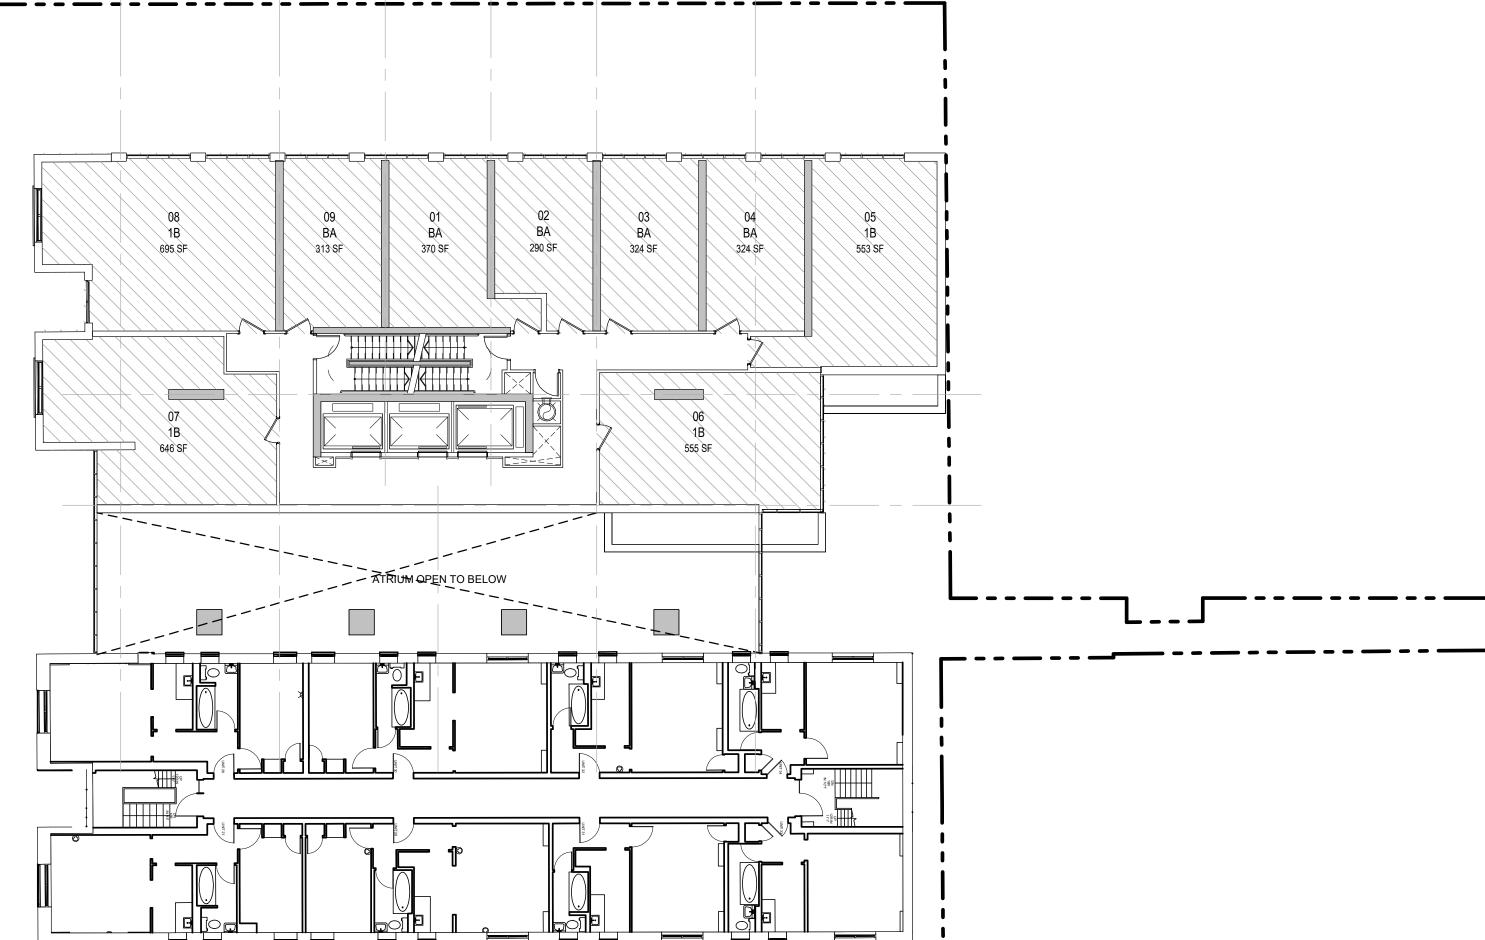No. DATE DESCRIPTION


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Toronto, ON Canada

SHEET TITLE

2ND FLOOR & 3RD

FLOOR PLANS

 DRAWN BY:
 CHKD' BY:
 DATE:
 SCALE:

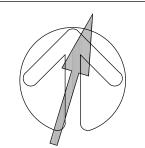 Author
 Checker
 APR 2023
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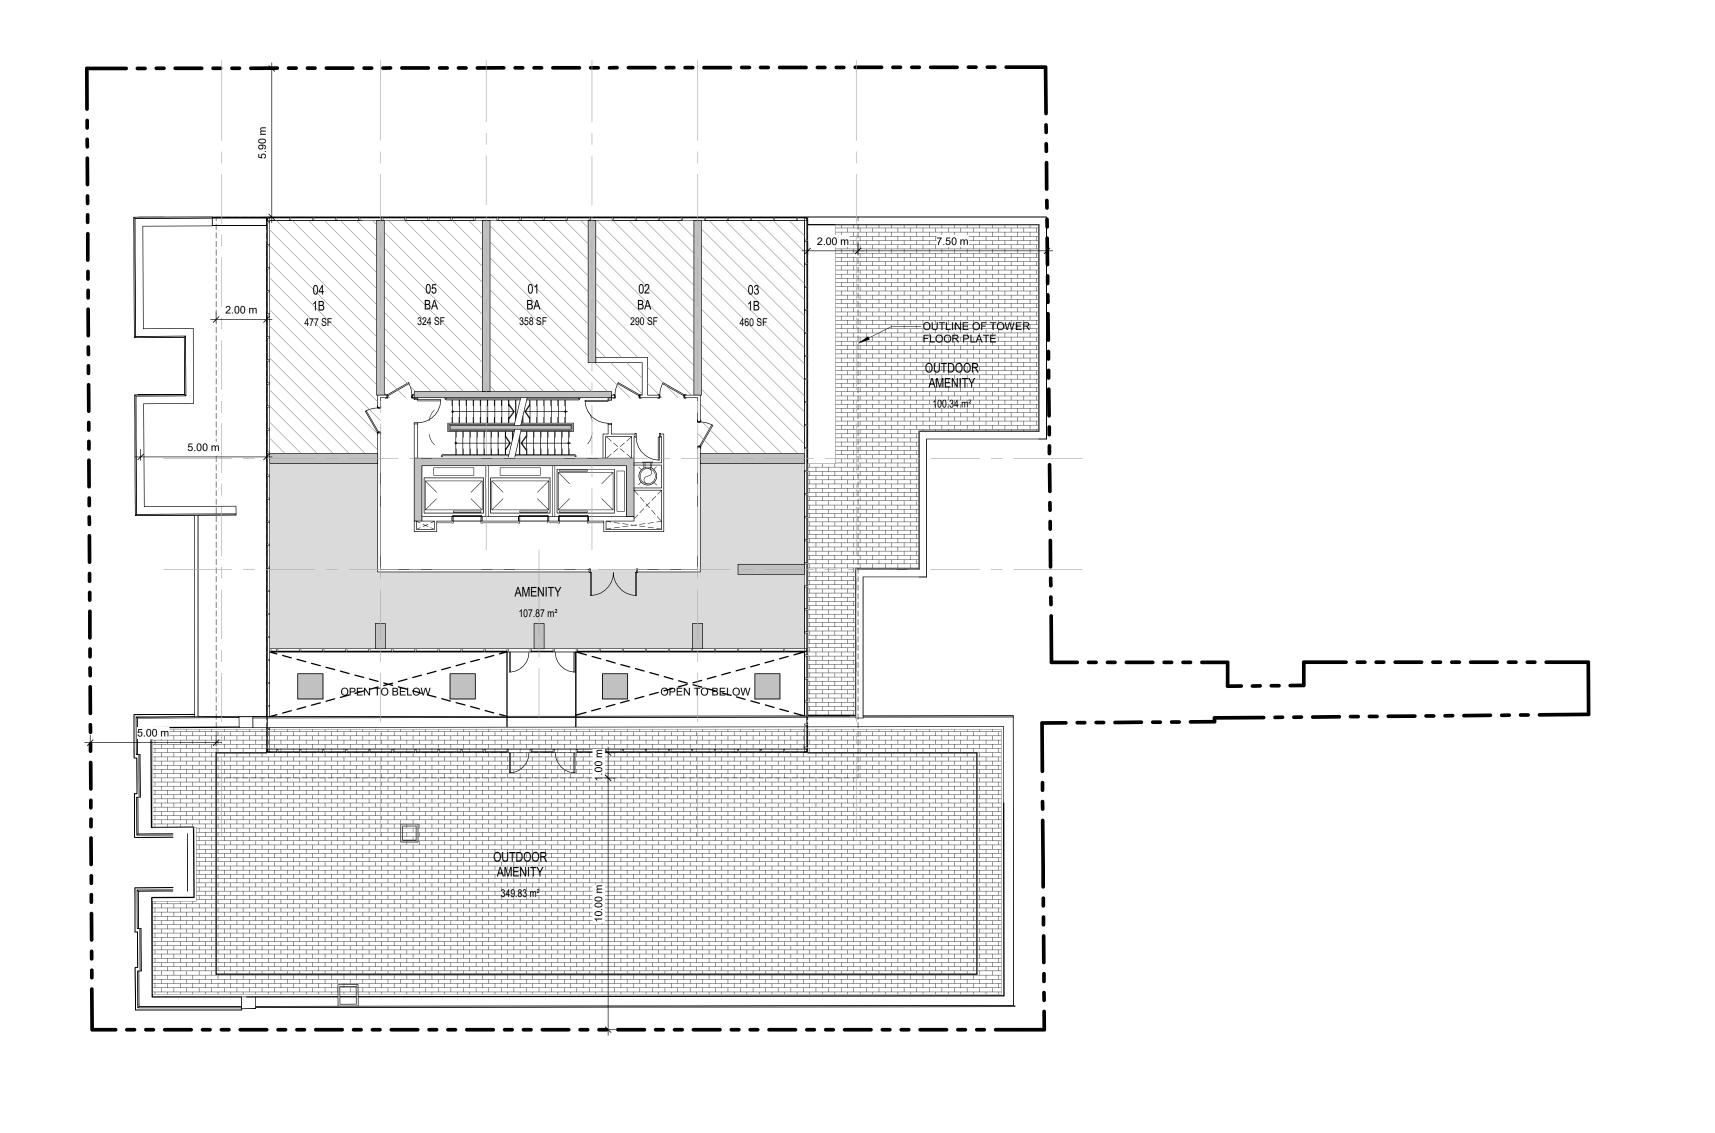
 PROJECT NO:
 DWG NO.

 117733
 A104




1 \ LEVEL 02

A104 / Scale: 1 : 150





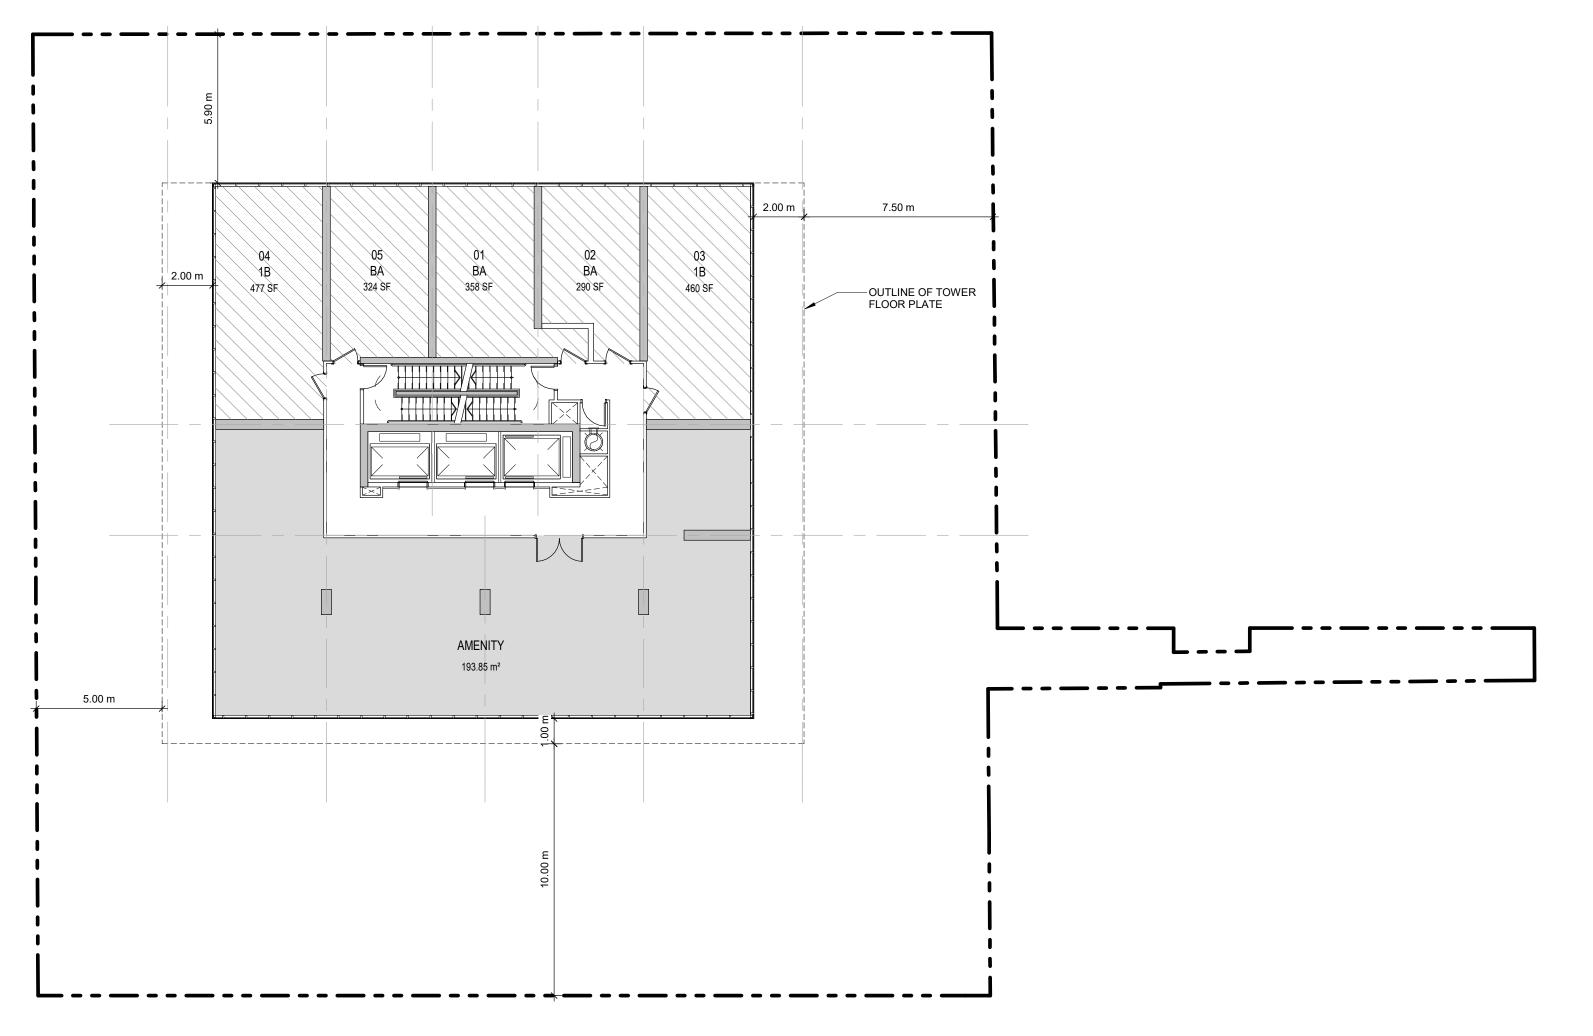



NJS SHERBOURNE INC. No. DATE DESCRIPTION 1 2021-06-28 ISSUED FOR ZBA SUBMISSION 2 2023-05-12 ISSUED FOR ZBA 2ND SUBMISSION

LEGEND

CLIENT

PARKING SPACE DIMENSIONS AS PER AS AMENDED, BY-LAW 89-2022 PARKING SPACE 5.6m LENGTH 2.6m WIDTH* 2.0m HEADROOM

* 0.3m INCREASE ON EACH SIDE WITH OBSTRUCTION MORE THAN 1.0m FROM THE REG FRONT OR REAR OF THE PARKING SPACE FRONT 3400

BARRIER FREE PARKING SPACE (BF) 5.6m LENGTH 3.4m WIDTH - ADJACENT TO 1.5m ACCESS AISLE 2.1m HEADROOM 1.5m WIDE R PAINT MARKED AISLE

NO PARKING ZONING STRIP PAINTING CONVEX MIRROR

ELECTRIC VEHICLE SYMBOL

GREEN ROOF

RENTAL REPLACEMENT UNIT

BICYCLE TAG ABBREVATIONS

-HORIZONTAL

BICYCLE STALLS SINGLE HORIZONTAL 1.8m LENGTH 0.6m WIDTH ு 🗷 1.9m MIN HEADROOM

-VERTICAL -STACKED SINGLE VERTICAL ST - SHORT TERM LT - LONG TERM 1.2m LENGTH 0.6m WIDTH
1.9m MIN HEADROOM

STACKED 1.8m LENGTH 0.6m WIDTH 1.2m MIN HEADROOM

DATE DESCRIPTION REVISIONS


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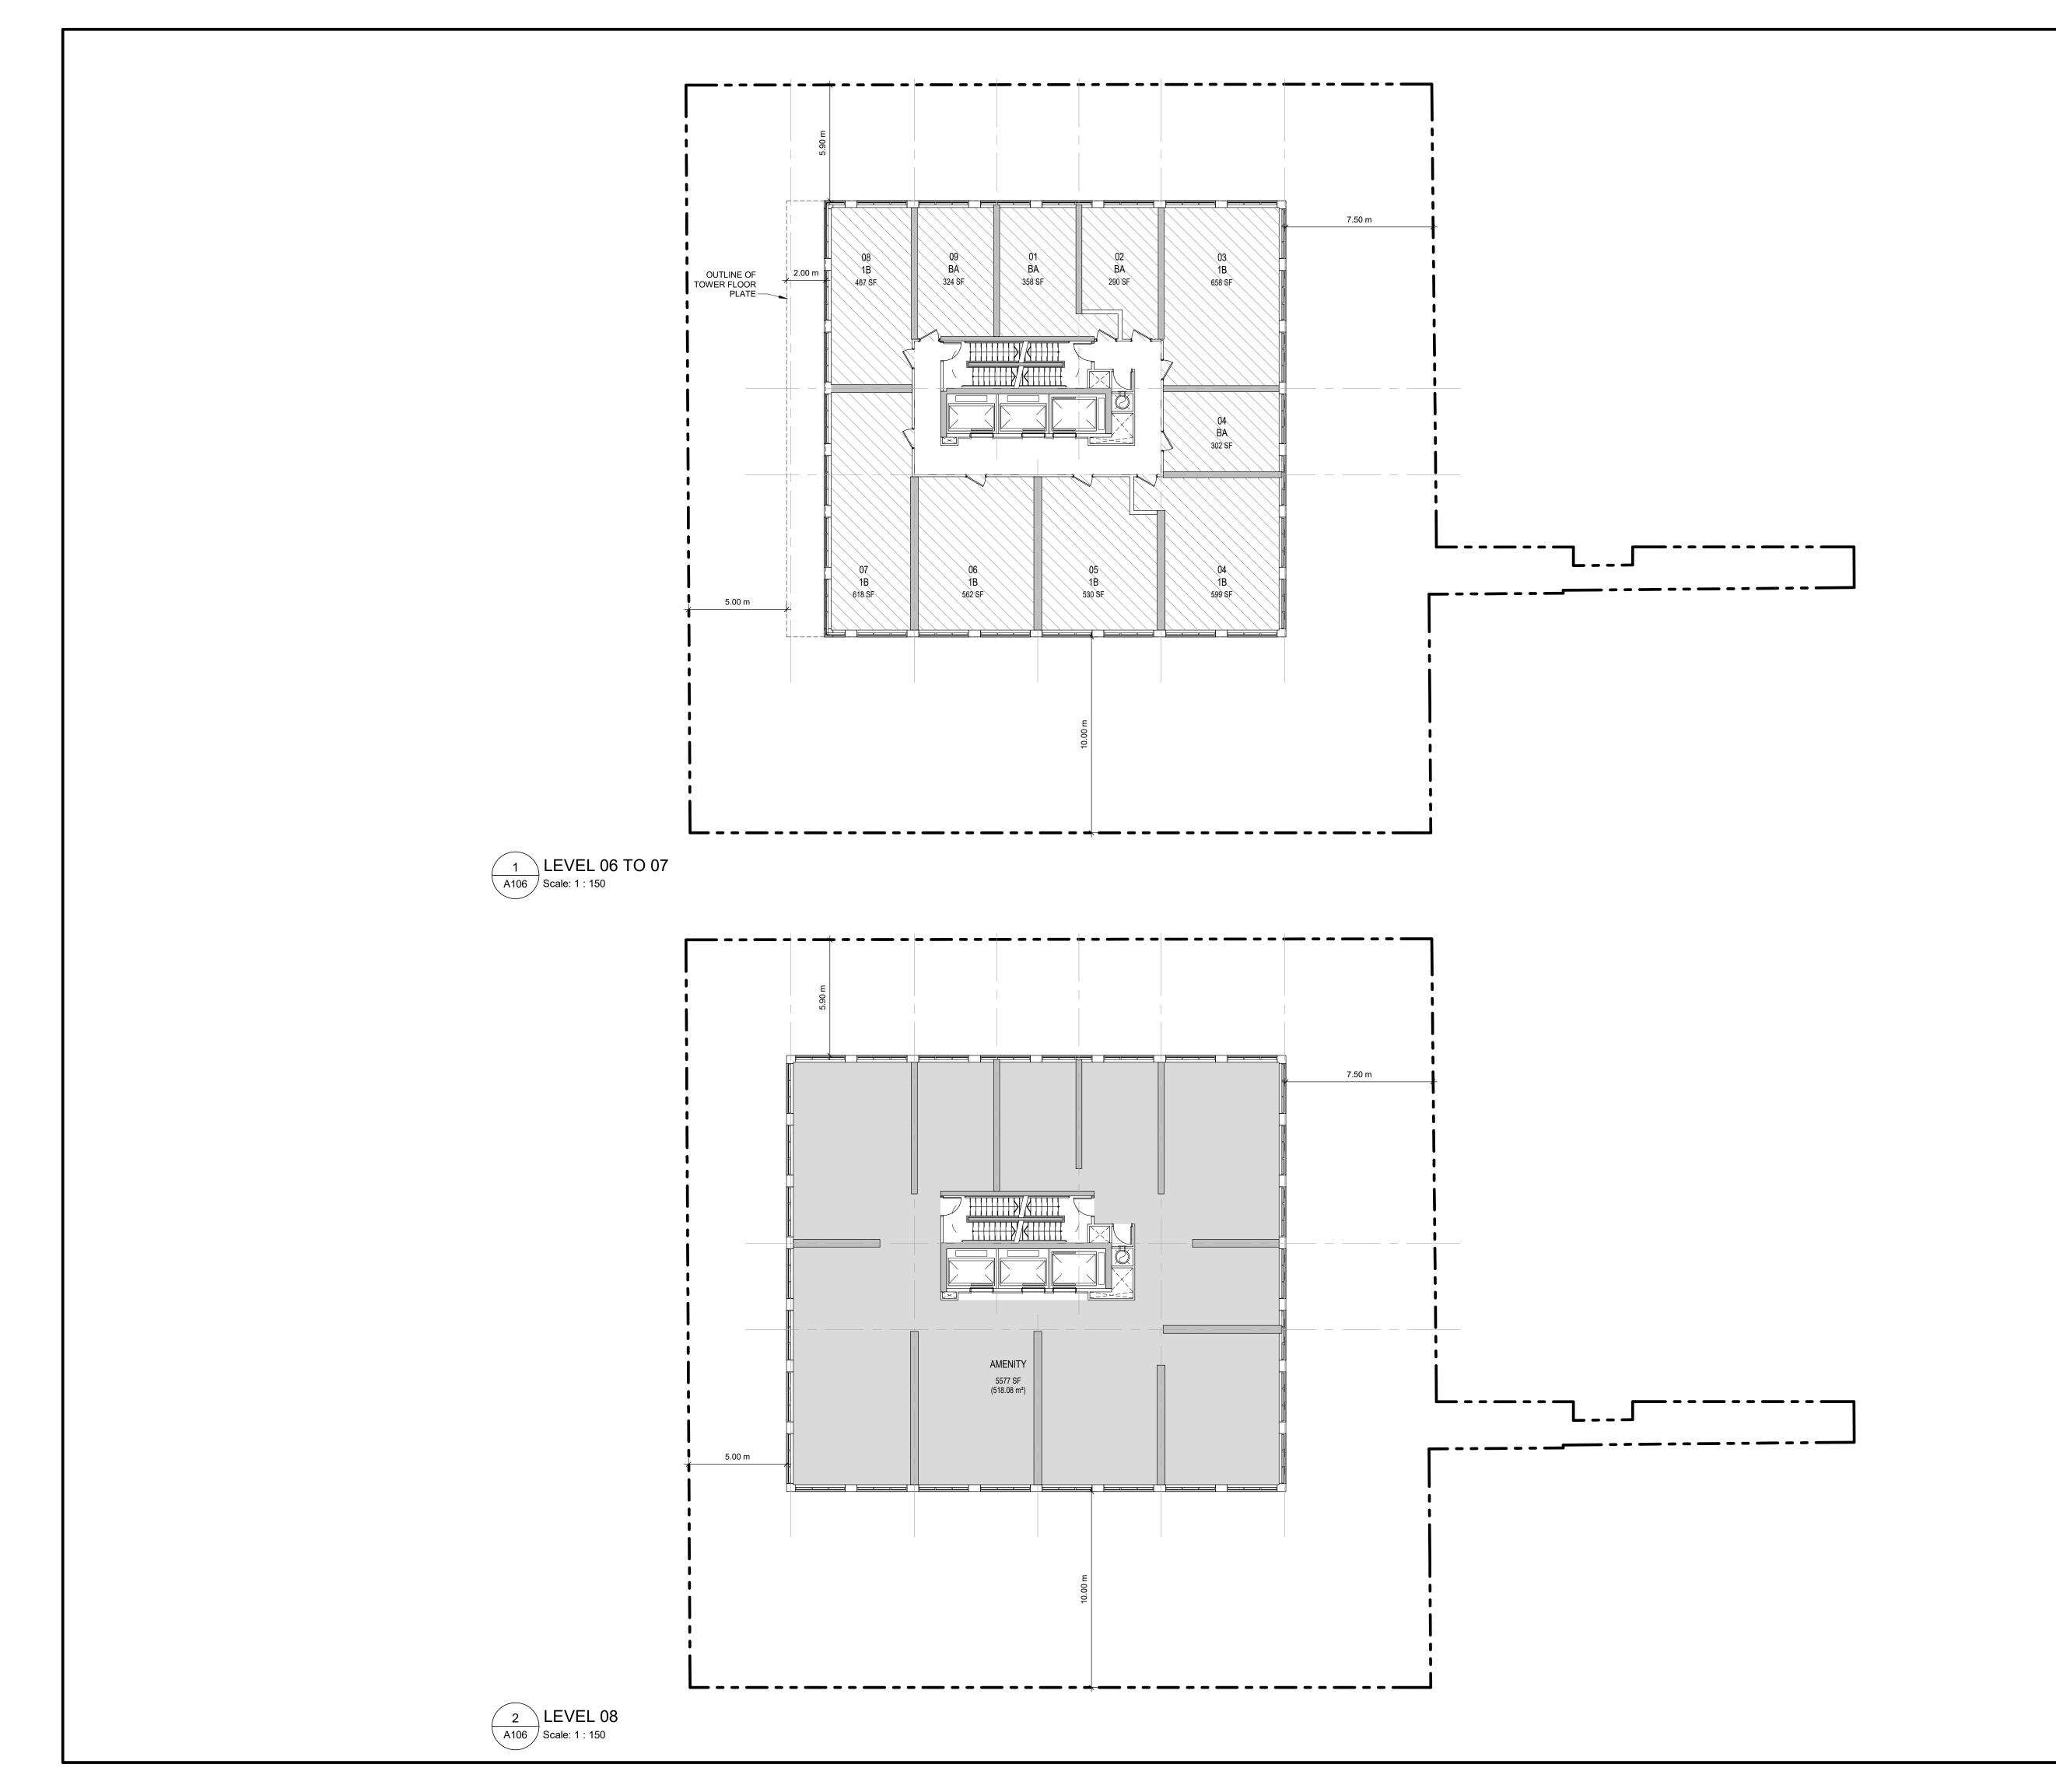
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383-387 SHERBOURNE ST. 383-387 Sherbourne St.

Toronto, ON Canada SHEET TITLE
4TH FLOOR & 5TH FLOOR PLANS

DRAWN BY: CHKD' BY: DATE: SCALE: Author APR 2023 1 : 150 PROJECT NO: DWG NO. 117733



CLIENT NJS SHERBOURNE INC. No. DATE DESCRIPTION 1 2021-06-28 ISSUED FOR ZBA SUBMISSION 2 2023-05-12 ISSUED FOR ZBA 2ND SUBMISSION **LEGEND** → PARKING SPACE DIMENSIONS AS PER PARKING SPACE DIMENSIONS AS PER
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0.6m WIDTH
1.9m MIN HEADROOM ST - SHORT TERM LT - LONG TERM STACKED 1.8m LENGTH 0.6m WIDTH 1.2m MIN HEADROOM DATE DESCRIPTION

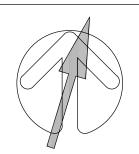
REVISIONS

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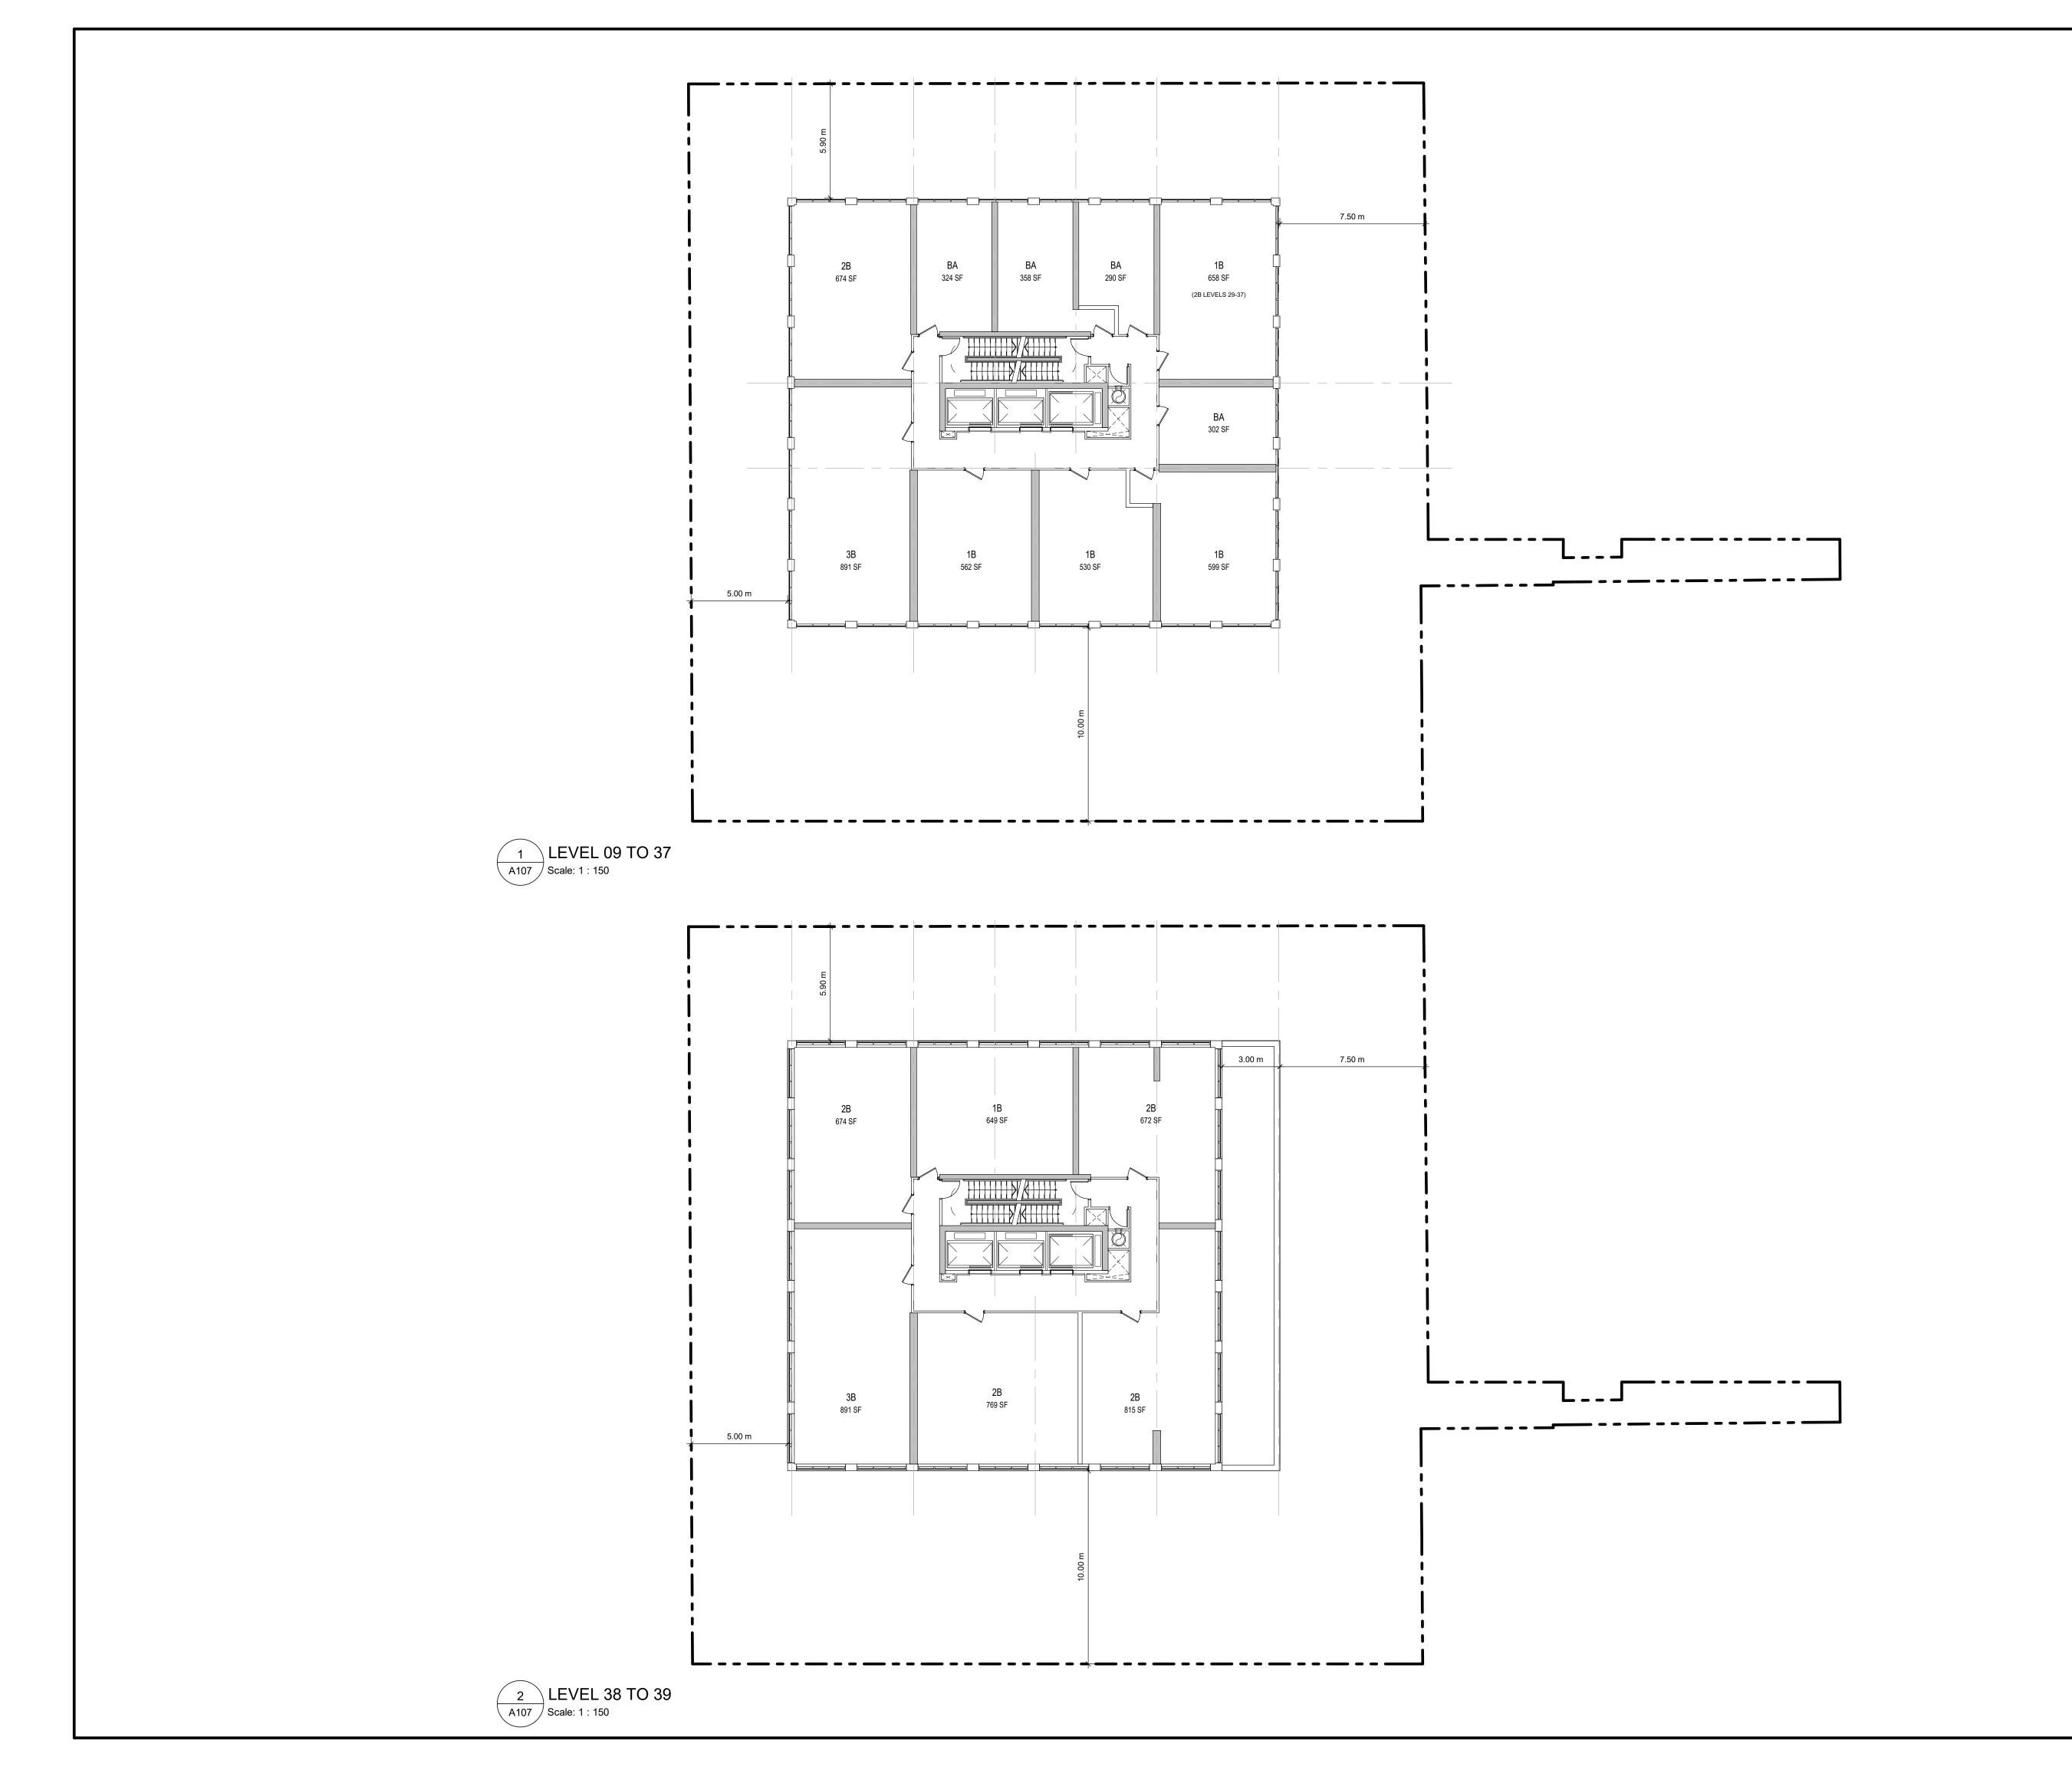


383-387 SHERBOURNE

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6TH-7TH FLOOR & 8TH FLOOR

117733			A106
PROJECT NO:		DWG NO.	
Author	Checker	APR 2023	1 : 150
DRAWN BY:	CHKD' BY:	DATE:	SCALE:

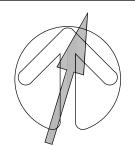


CLIENT NJS SHERBOURNE INC. No. DATE DESCRIPTION 1 2021-06-28 ISSUED FOR ZBA SUBMISSION 2 2023-05-12 ISSUED FOR ZBA 2ND SUBMISSION **LEGEND** → PARKING SPACE DIMENSIONS AS PER PARKING SPACE DIMENSIONS AS PER
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1.9m MIN HEADROOM STACKED 1.8m LENGTH 0.6m WIDTH 1.2m MIN HEADROOM

No.	DATE	DESCRIPTION
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	DIMENSIONS	ARE TO BE CHECKED ON SI

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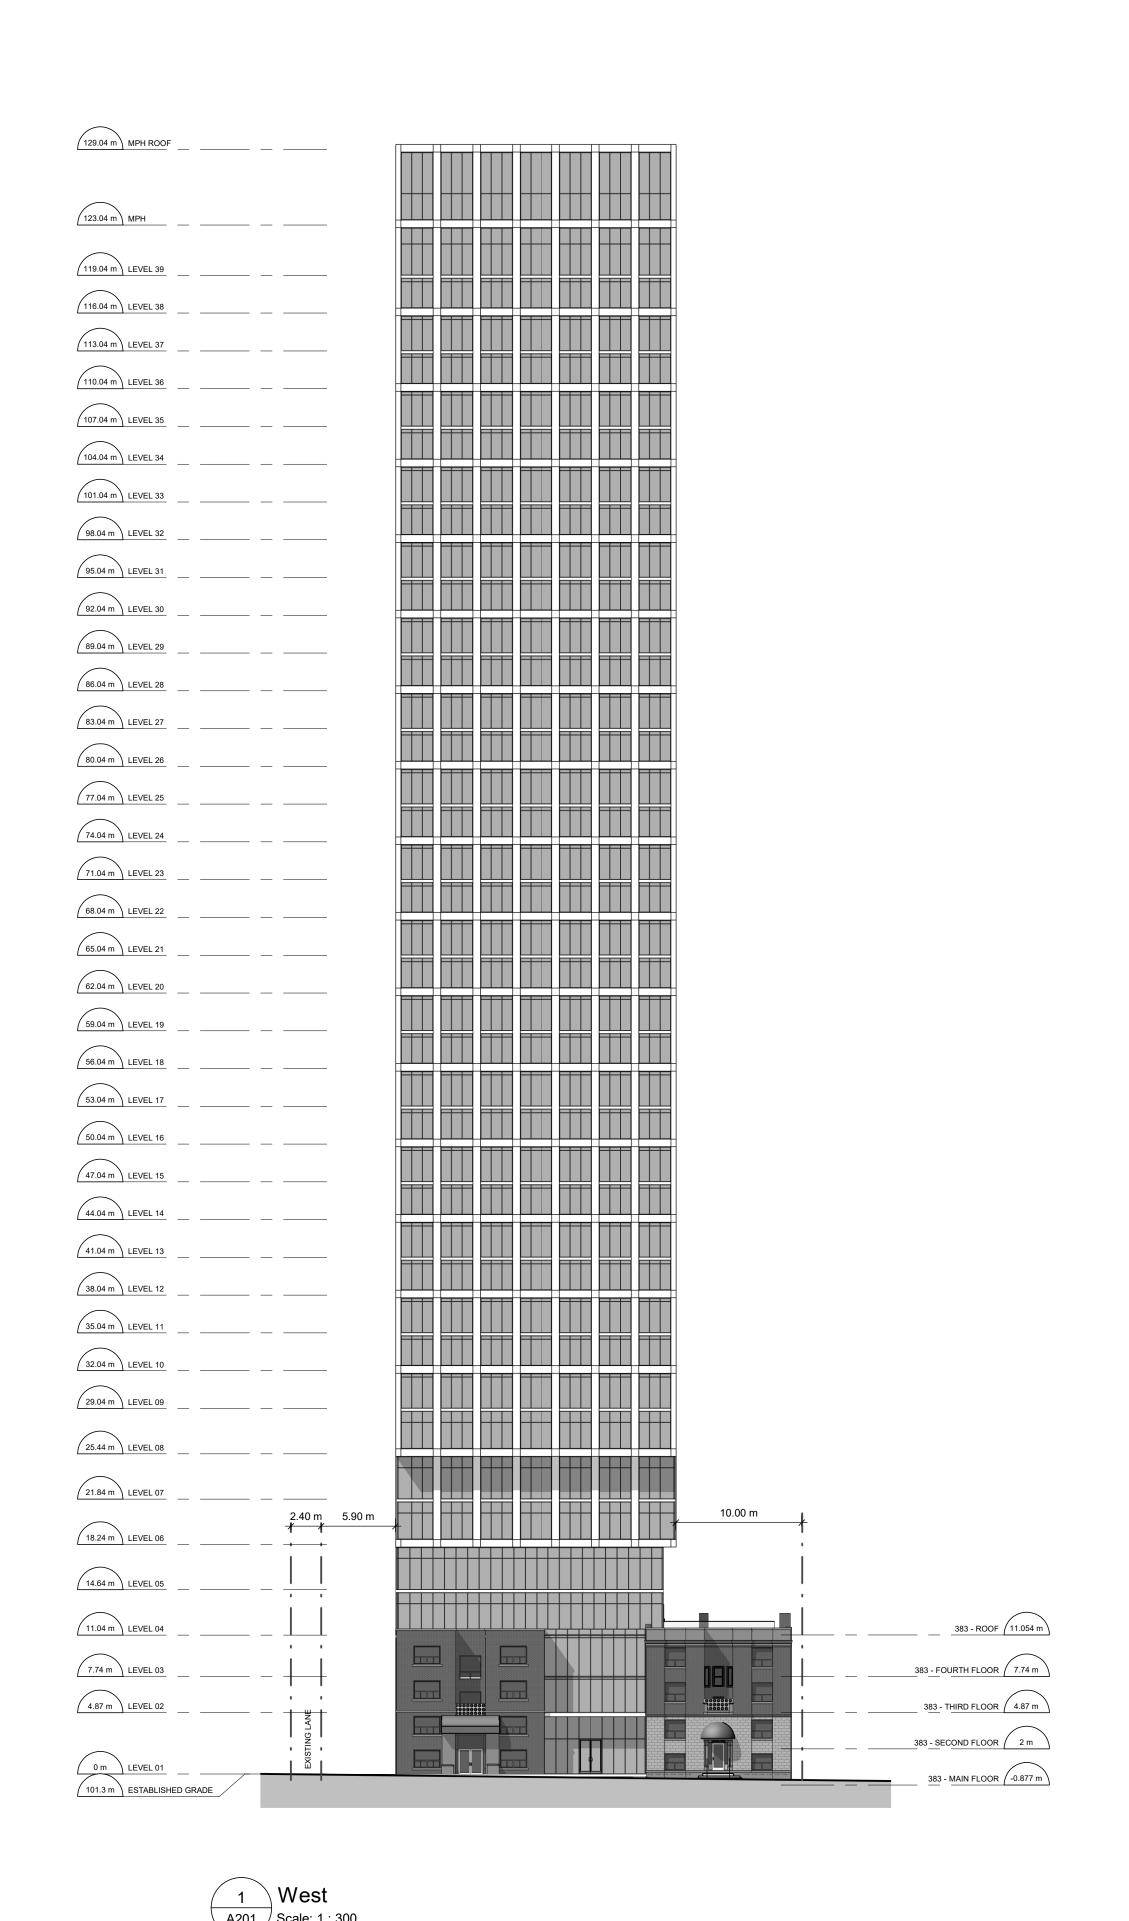



383-387 SHERBOURNE ST.


383-387 Sherbourne St. Toronto, ON Canada

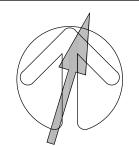TOWER FLOOR PLANS

	117733		A1(
PROJECT NO	:	DWG NO.	
Author	Checker	APR 2023	1:
DRAWN BY:	CHKD' BY:	DATE:	SCAL



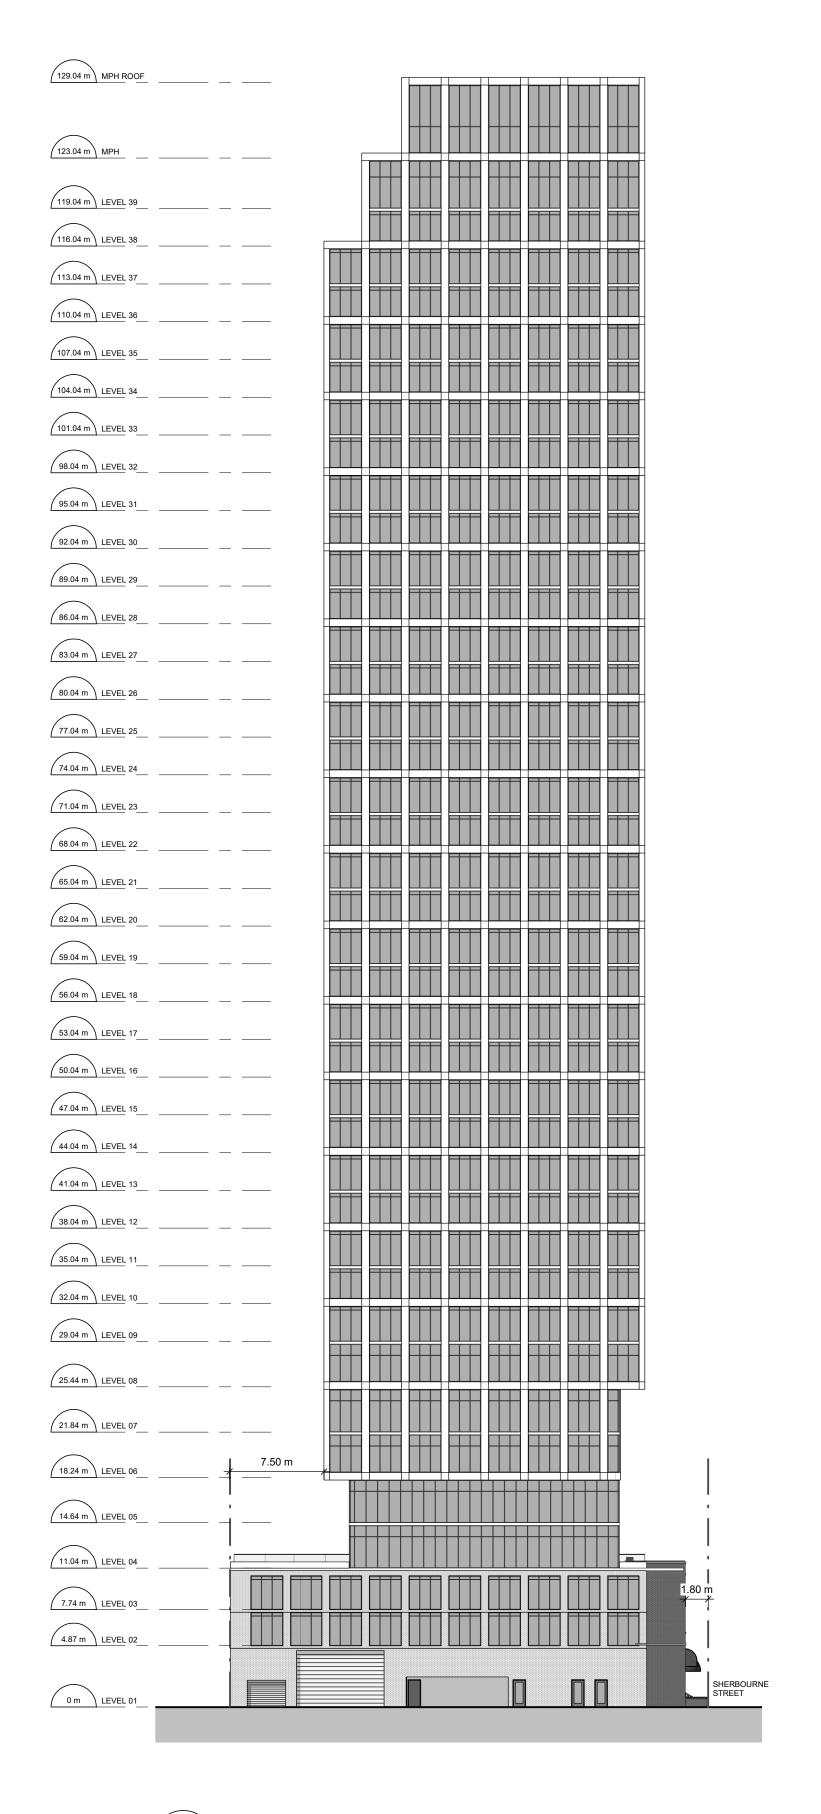

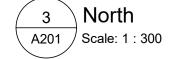

CLIENT

NJS SHERBOURNE INC.

ISSUED			
No.	DATE	DESCRIPTION	
1	2021-06-28	ISSUED FOR ZBA SUBMISSION	
2	2023-05-12	ISSUED FOR ZBA 2ND SUBMISSION	

lo.	DATE	DESCRIPTION	
REVIS	SIONS		
ALL DIMENSIONS ARE TO BE CHECKED ON SITE BY THE			

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SEAL

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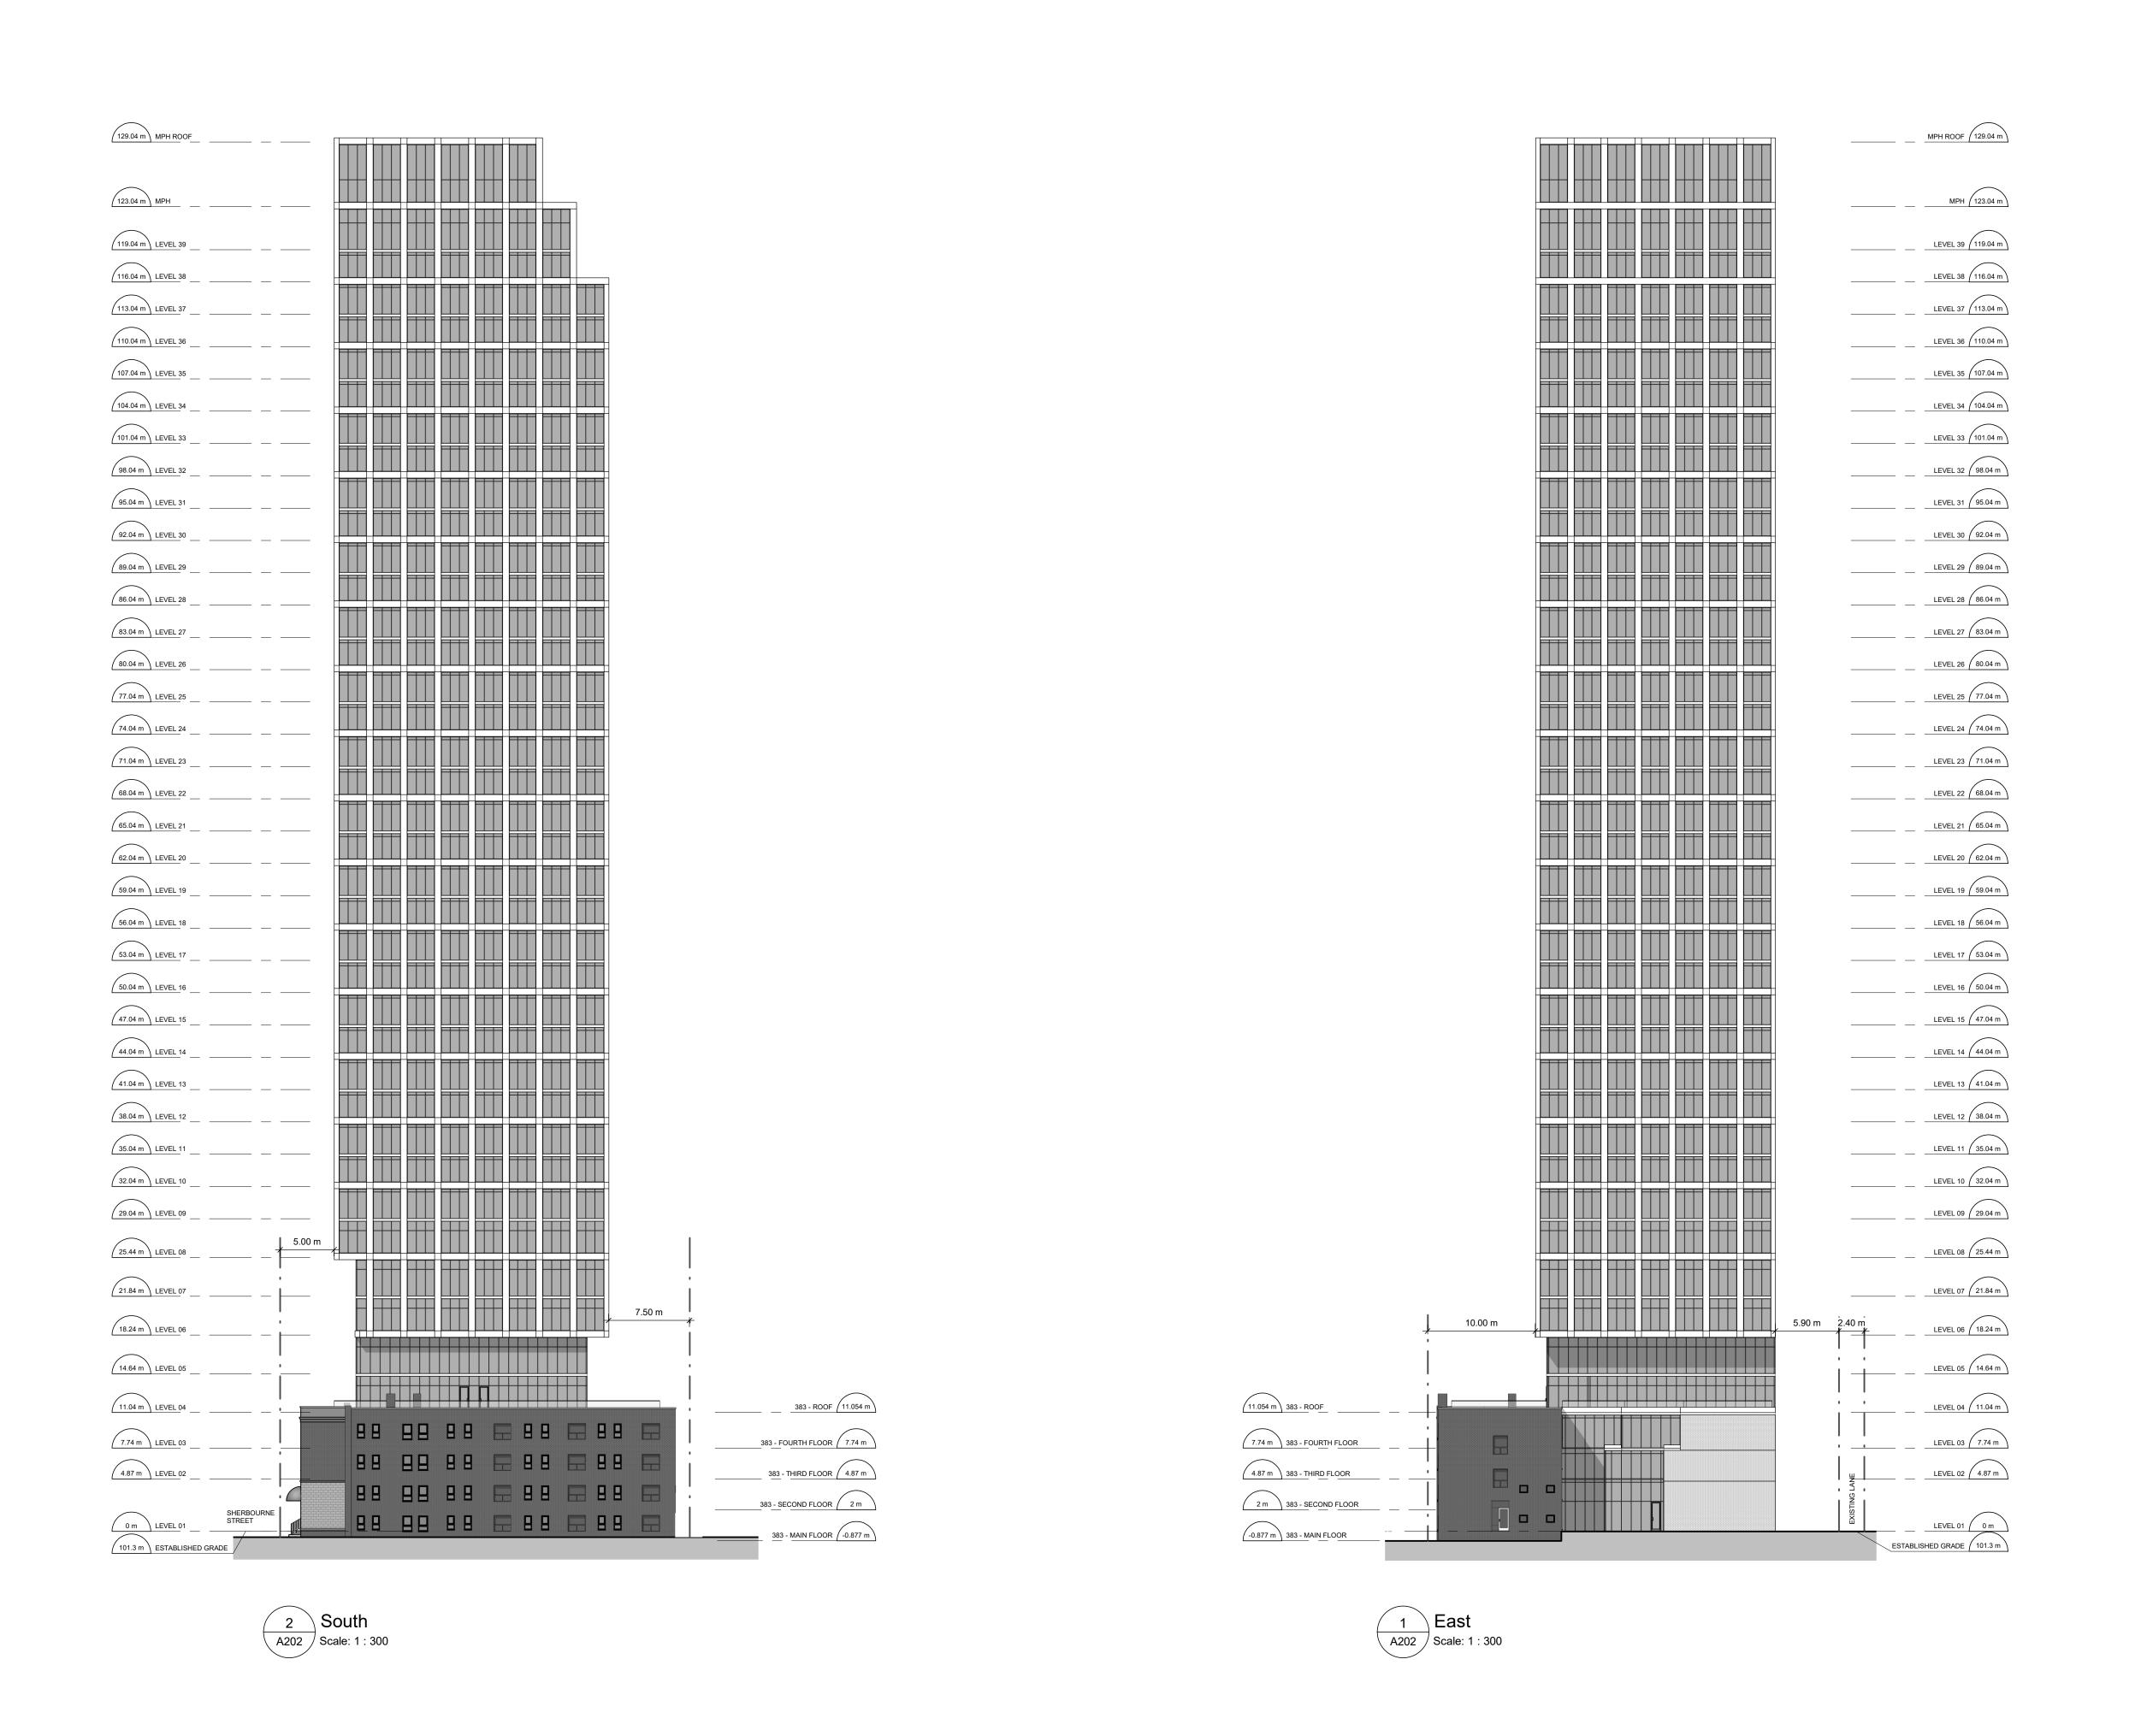
Toronto, ON Canada

SHEET TITLE

WEST & NORTH

ELEVATIONS

	117733		A201
PROJECT NO):	DWG NO.	
Author	Checker	APR 2023	1 : 300
DRAWN BY:	CHKD' BY:	DATE:	SCALE:



CLIENT

NJS SHERBOURNE INC.

ISSUE	ΞD

lissc	JED	
No.	DATE	DESCRIPTION
1	2021-06-28	ISSUED FOR ZBA SUBMISSION
2	2023-05-12	ISSUED FOR ZBA 2ND SUBMISSION

No.	DATE	DESCRIPTION
REVI	SIONS	

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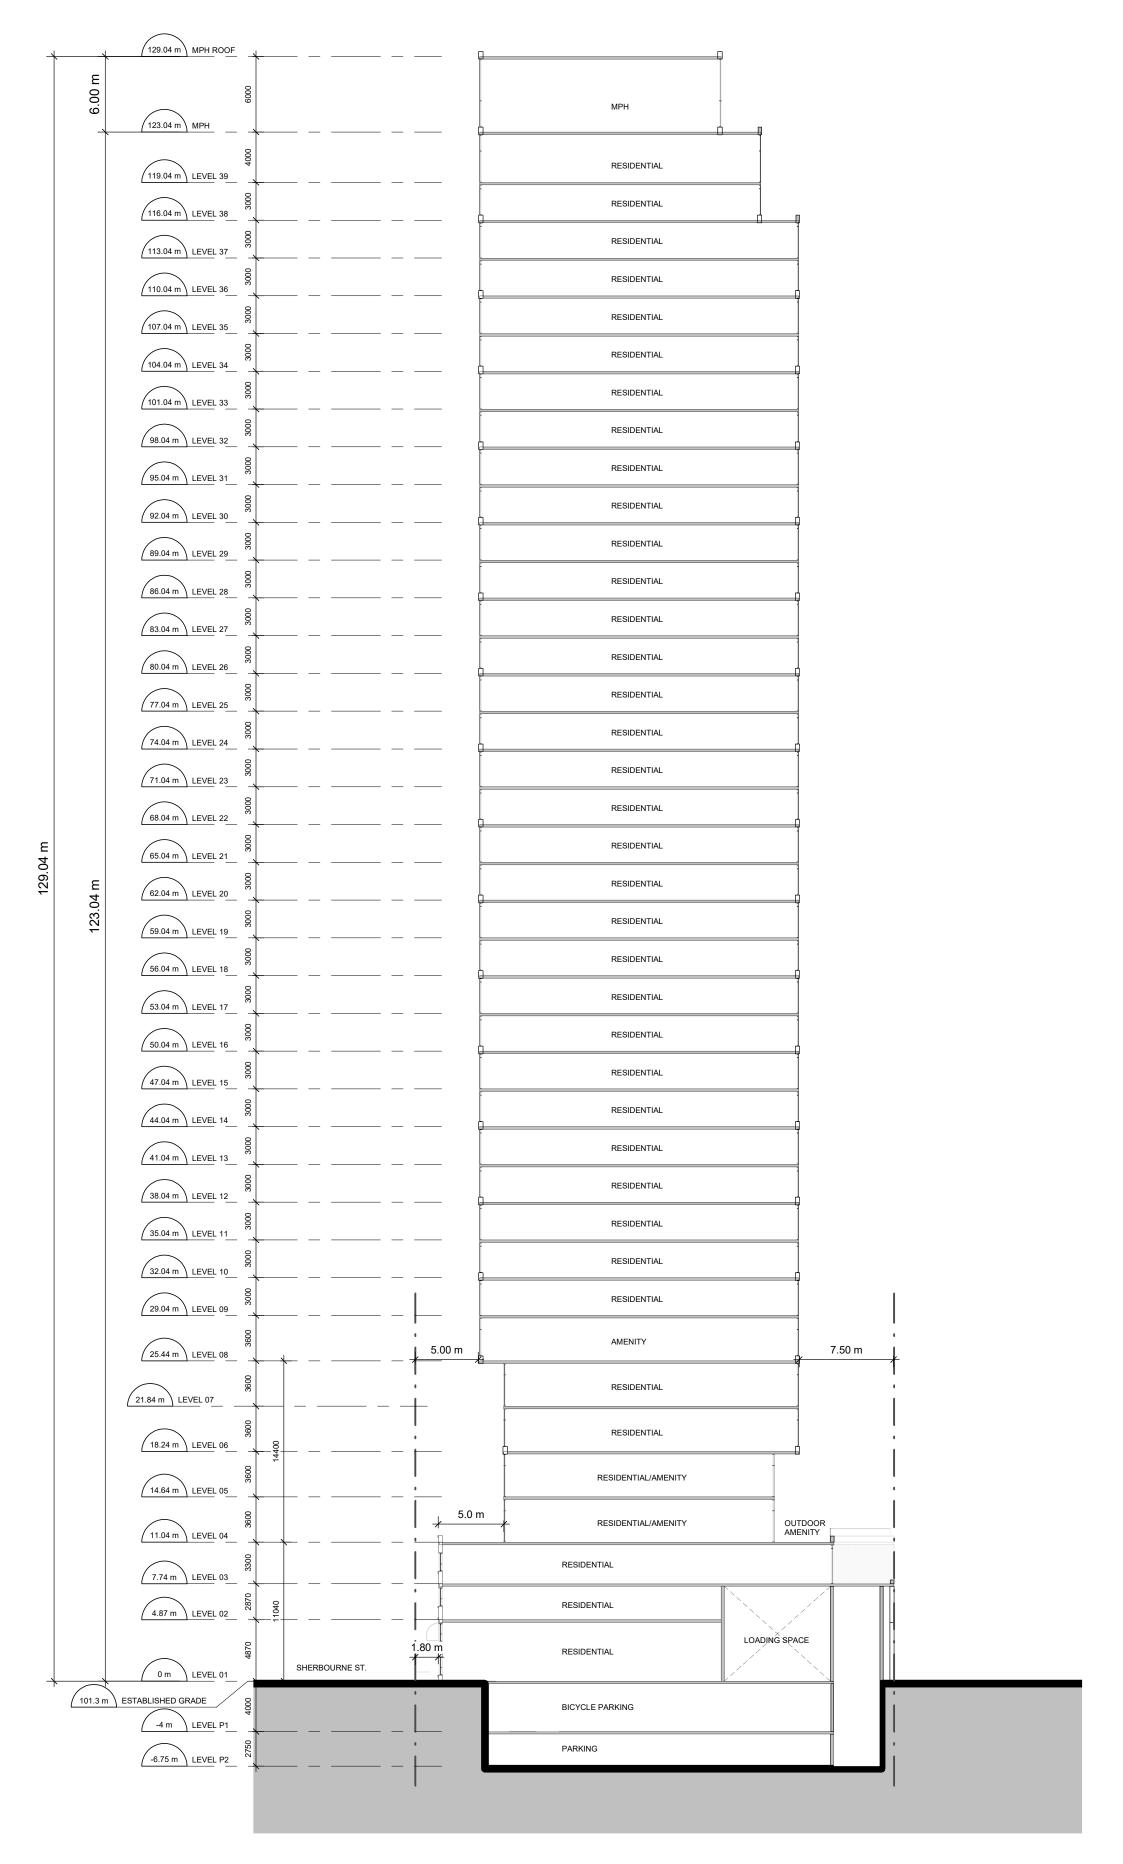
SEAL

383-387 SHERBOURNE ST.


383-387 Sherbourne St. Toronto, ON Canada

SOUTH & EAST ELEVATIONS

	117733		A202
PROJECT NO	:	DWG NO.	
Author	Checker	APR 2023	1 : 300
DRAWN BY:	CHKD' BY:	DATE:	SCALE:



1 EAST-WEST BUILDING SECTION A301 Scale: 1 : 300

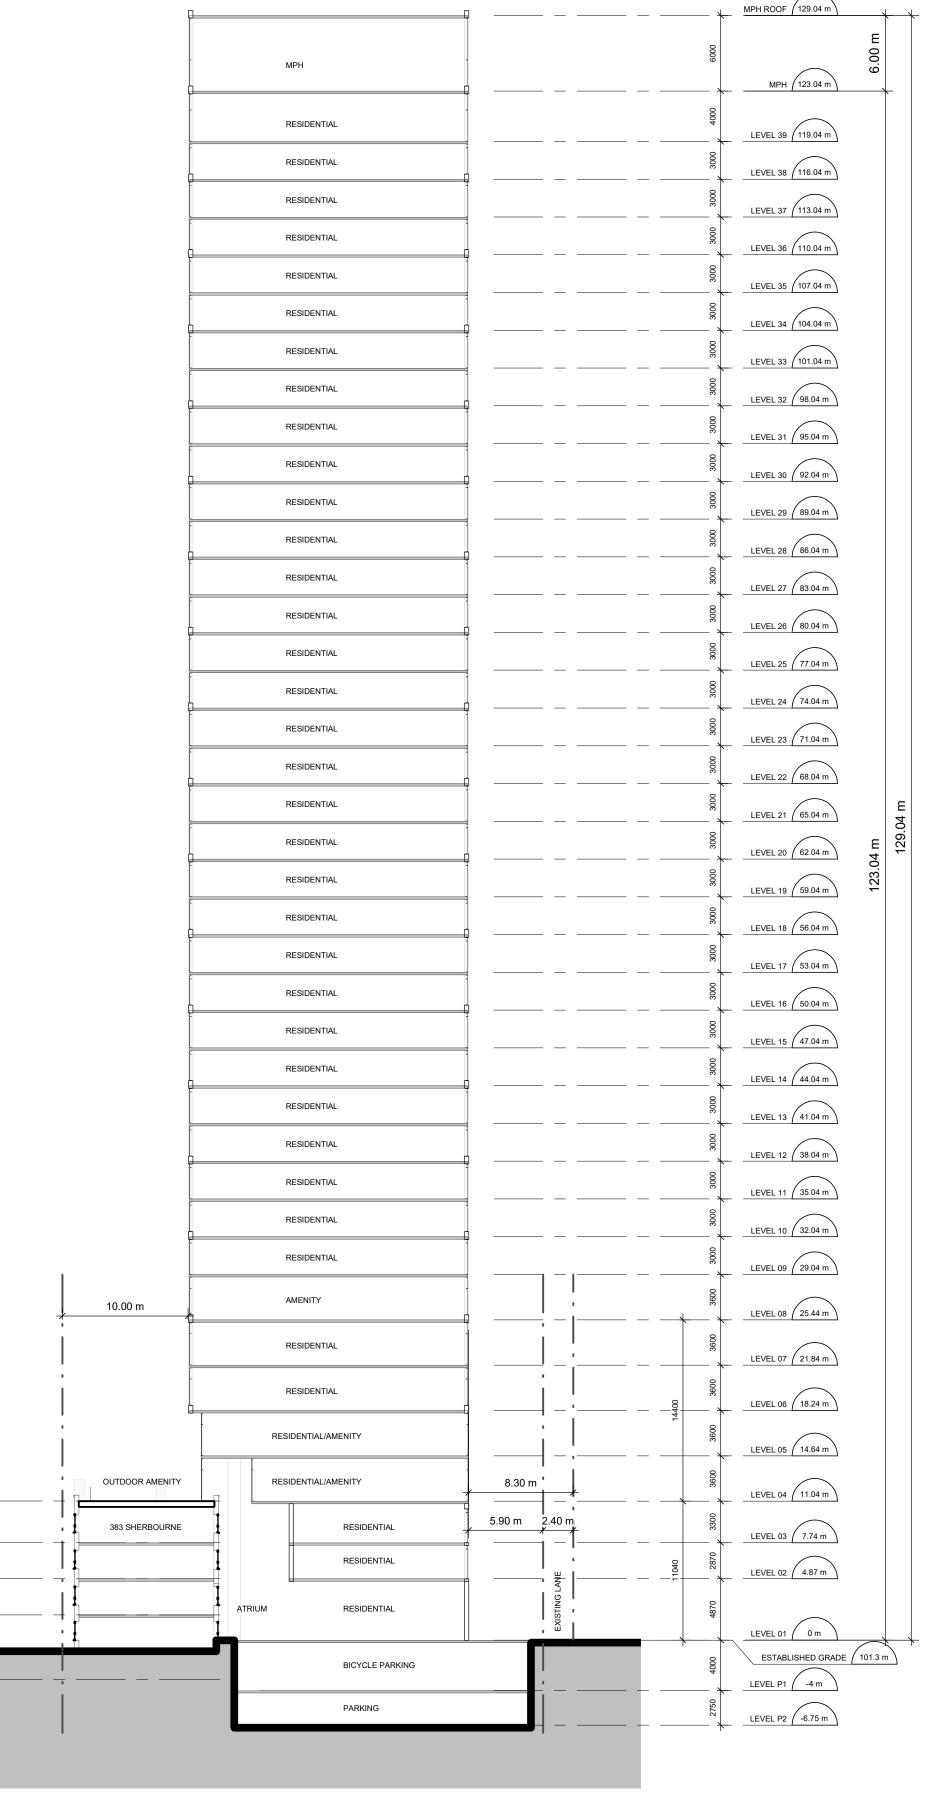

11.054 m 383 - ROOF

7.74 m 383 - FOURTH FLOOR

4.87 m 383 - THIRD FLOOR

-0.877 m 383 - MAIN FLOOR

2 m 383 - SECOND FLOOR

-3.106 m 383 - BASEMENT FLOOR

NORTH-SOUTH BUILDING SECTION
Scale: 1:300

CLIENT

NJS SHERBOURNE INC.

No. DATE DESCRIPTION 1 2021-06-28 ISSUED FOR ZBA SUBMISSION 2 2023-05-12 ISSUED FOR ZBA 2ND SUBMISSION

DATE DESCRIPTION REVISIONS

ALL DIMENSIONS ARE TO BE CHECKED ON SITE BY THE CONTRACTOR. ANY DISCREPANCIES ARE TO BE REPORTED TO THE ARCHITECT BEFORE PROCEEDING WITH THE WORK. DRAWINGS ARE NOT TO BE SCALED.

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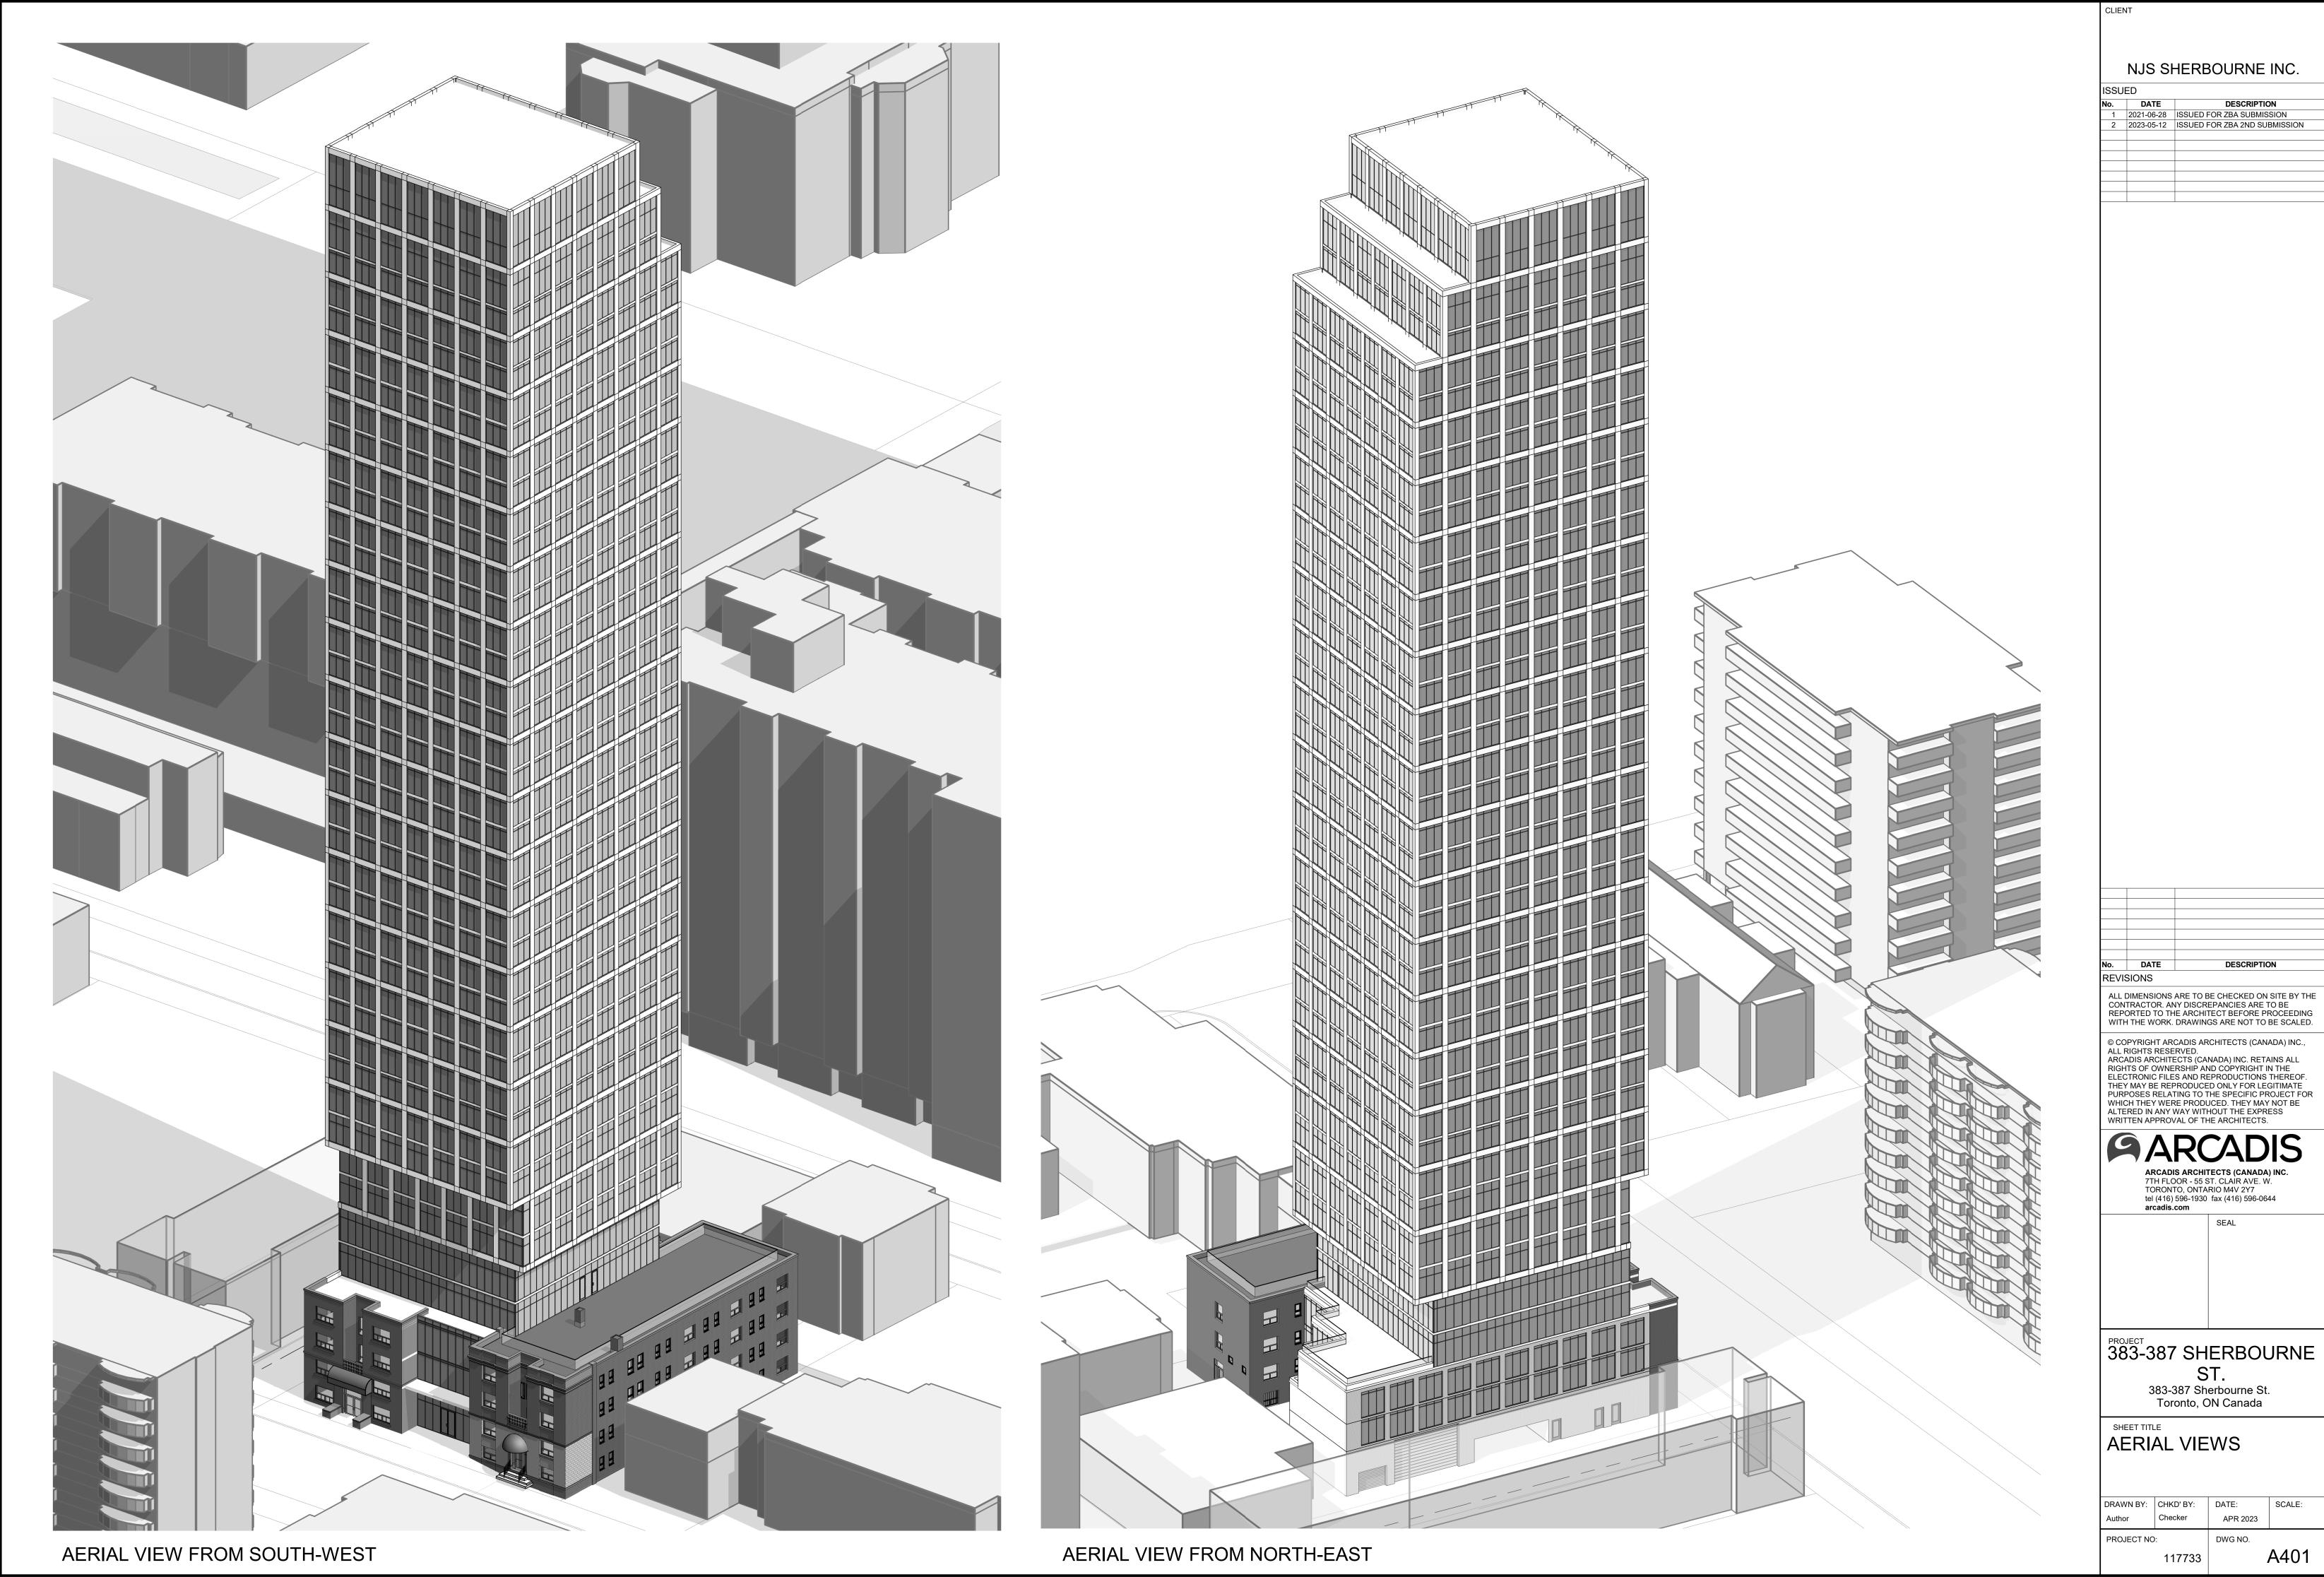
tel (416) 596-1930 fax (416) 596-0644 arcadis.com

383-387 SHERBOURNE ST. 383-387 Sherbourne St.

Toronto, ON Canada

BUILDING SECTIONS

DRAWN BY: CHKD' BY: DATE: SCALE: Author APR 2023 1 : 300 PROJECT NO: DWG NO. A301 117733



1 2021-06-28 ISSUED FOR ZBA SUBMISSION 2 2023-05-12 ISSUED FOR ZBA 2ND SUBMISSION

DESCRIPTION

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383-387 SHERBOURNE

SCALE: APR 2023 DWG NO.