1 RICHVIEW

Proposed 29-Story Rental Building 1 Richview Rd, Toronto, Ontario

Betovan Construction Ltd.



CONSULTANT TEAM

15-067 1 RICHVIEW BUILDING C - Residential Infill

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|---|----|----|----|----|
| | | | | |

NAME: H&R Developments ADDRESS: 3625 Dufferin Street, Suite 409, Toronto, ON,

Evan Miller

TEL: 416.373.4180

emiller@hr-dev.com

ACOUSTIC ENGINEER:

NAME: Valcoustics Canada Ltd. ADDRESS: 30 Wertheim Court, Unit 25, Richmond Hill, Ontario, L4B 1B9 Canada

Michael Lightstone TEL.: (905) 764-5223 FAX: (905) 764-6813

www.valcoustics.com

PROJECT ARCHITECT:

NAME: Kirkor Architects and Planners ADDRESS: 20 Martin Ross Ave., Toronto, ON, M3J 2K8 Cliff Korman, Farzad Gorji TEL: (416) 665-6060 FAX: (416) 665-1234 http://www.kirkorarchitects.com/

ENERGY CONSULTANT:

NAME: EQ Building Performance Inc. ADDRESS: 20 Floral Parkway Concord, ON L4K 4R1 Samantha Menard TEL.: 416.645.1186

www.eqbuilding.com

PLANNER:

NAME: Goldberg Group ADDRESS: 2098 Avenue Road, Toronto, Ontario, M5M 4A8 Michael Goldberg, Talia Ocean TEL.: (416) 322-6364 FAX: (416) 932-9327

WIND CONSULTANT:

spollock@theakston.com

NAME: Theakston Environmental Control ADDRESS: 596 Glengarry Crescent, P.O. Box 390, Fergus, ON, N1M 3E2 Stephen Pollock TEL.: (519)787-2910 FAX: (519)787-2918

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LANDSCAPE ARCHITECT:

NAME: SBK ADDRESS: 5770 Hurontario St., Suite 320, Mississauga, ON L5R 3G5

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TRAFFIC CONSULTANT:

NAME: Dillon Consulting ADDRESS: 235 Yorkland Boulevard Suite 800, Toronto, Ontario, M2J 4Y8 Mike Walters TEL.: (416) 229-4646 FAX: (416) 229-4692 mwalters@dillon.ca

CIVIL ENGINEER:

NAME: Schaeffer & Associates Limited ADDRESS: 6 Ronrose Drive, Concord, Ontario L4K 4R3 Hacik Tozcu, Koryun Shabikian TEL.: (905) 738-6100 FAX: (905) 738-6875 shaeffers.com

SURVEYOR:

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| | | DRAWING LIST | | | |
|-----------------------|-----------------|---|------------------------|------------------------|---|
| Sheets: Sheet Type | Sheet Number | Sheet Name | Re-Zoning (14/12/2018) | Re-Zoning (07/10/2020) | |
| 12 SITE PLAN A | PPROVAL | | | | |
| A0 | | | | | |
| Cover Sheet | dA0.0 | Cover Sheet | | | T |
| A1 | | | | | |
| Admin | dA1.1 | Context Plan, OBC Matrix, Green Roof Statistics | | | |
| | dA1.2 | Building Statistics | | | J |
| Site Plan | dA1.3 | Expropriation Plan | • | |] |
| Site Plan | dA1.4 | Site Plan | • | | |
| | dA1.5 | Survey | | | 1 |
| Site Plan | dA1.6 | Existing Building First Floor | • | | 7 |
| A2 | | | | | |
| | dA2.1 | Parking Level 2 Floor Plan | | | |
| Floor Plans | dA2.2 | Parking Level 1 Floor Plan | | • | |
| Floor Plans | dA2.3 | First Floor Plan | | | T |
| Floor Plans | dA2.4 | Second Floor Plan | | | 1 |
| Floor Plans | dA2.5 | Floor Plans - Podium | | | |
| Floor Plans | dA2.6 | Floor Plans - Levels 5 and 6 | • | • | 1 |
| Floor Plans | dA2.7 | Floor Plans - Levels 7 - 29 and Roof | • | | 7 |
| A4 | | | | | _ |
| Elevations | dA4.1 | Elevations - North | | • | |
| Elevations | dA4.2 | Elevations - South | • | | |
| | dA4.3 | Elevation East & West | | | ٦ |
| Elevations | dA4.5 | Site and Enlarged Elevations | • | | |
| A5 | | | | | |
| Building Sections | dA5.1 | Building Sections | - | • | |
| | dA5.2 | Building Sections | | | _ |
| | | | | | |

dA6.1 3D Views (Renderings)

dA7.1 Shadow Study - June 21 dA7.2 Shadow Study March/September 21

dA7.3 Shadow Study December 21

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Toronto, ON M3J 0H1



| 7. | Re-Zoning Re-submission | Feb 13 ,2023 |
|------|-------------------------|--------------|
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| No.: | Issued For: | Date: |

HR Developments | Fieldgate

Betovan Construction Ltd. Proposed Residential Development

Cover Sheet

Drawn by: Author

Checked by: Checker Project No.: 15-067 Oct 13, 2023

Statistics Template – Toronto Green Standard Version 4.0 Mid to High Rise Residential and all New Non-Residential Development

The Toronto Green Standard Version 4.0 Statistics Template is submitted with Site Plan Control Applications and stand-alone Zoning Bylaw Amendment applications. Complete the table and copy it directly onto the Site Plan submitted as part of the application.

For Zoning Bylaw Amendment applications: complete General Project Description and Section 1. For Site Plan Control applications: complete General Project Description, Section 1 and Section 2.

For further information, please visit www.toronto.ca/greendevelopment

| General Project Description | Proposed |
|---------------------------------------|-----------|
| Total Gross Floor Area | 22,450 m2 |
| Breakdown of project components (m²): | 5 |
| Residential | 22,450 m2 |
| Retail | 7 |
| Commercial | |
| Industrial | 1 |
| Institutional/Other | - |
| Total number of residential units | 306 |

| Low Emissions Transportation | Required | Proposed | Proposed % |
|---|----------|----------|------------|
| Number of Parking Spaces | 637 | 637 | 100 |
| Number of EV Parking Spaces (Residential) | 260 | 260 | 100 |
| Number of EV Parking Spaces (non-residential) | - | | - |
| Cycling Infrastructure | Required | Proposed | Proposed % |
| Number of long-term bicycle parking spaces (all-uses) | 209 | 209 | 100 |
| Number of long-term bicycle parking located on: | | | - |
| a) first storey of building | 4 | 2 | - |
| b) second storey of building | 209 | 209 | 100 |
| c) first level below-ground | - | | |
| d) second level below-ground | - | | e |
| e) other levels below-ground | | | |



Statistics Template – Toronto Green Standard Version 4.0 Mid to High Rise Residential and all New Non-Residential Development

Required Proposed Proposed 9

| Number of short-term bicycle parking spaces | 21 | 21 | 100 |
|--|----------|----------|------------|
| Number of shower and change facilities (non-residential) | | | |
| Tree Canopy | Required | Proposed | Proposed % |
| Total Soil Volume (40% of the site area ÷ 66 m2 x 30 m³) | 1096 | 1416 | 129 |
| Soil volume provided within the site area (m³) | | 1416 | 100 |
| Soil Volume provided within the public boulevard (m³) | | | |

Section 2: For Site Plan Control Applications

| Cycling Infrastructure | Required | Proposed | Proposed % |
|---|----------|----------|------------|
| Number of short-term bicycle parking spaces (all uses) at-grade or on first level below grade | | | |
| Number of publicly accessible bicycle parking spaces | | | |
| Number of energized outlets for electric bicycles | | | |

| Tree Canopy | Required | Proposed | Proposed % |
|--|----------|----------|------------|
| Total site area (m²) | | 6029 | |
| Total Soil Volume (40% of the site area ÷ 66 m² x 30 m³) | 1096 | 1416 | 129 |
| Total number of trees planted | 36 | 36 | 100 |
| Number of surface parking spaces (if applicable) | | | |
| Number of shade trees located in surface parking area | | | |


| Landscaping & Biodiversity | Required | Proposed | Proposed % |
|---|----------|----------|------------|
| Total non-roof hardscape area (m²) | | 2638 | |
| Total non-roof hardscape area treated for Urban Heat Island (minimum residential 75% or non-residential 50%) (m²) | 1978 | 1995 | 76 |
| Area of non-roof hardscape treated with: (indicate m²) | | | |
| a) high-albedo surface material | | 1995 | 100 |
| b) open-grid pavement | | | |
| c) shade from tree canopy | | | |

PART OF LOT 16, CONCESSION D FRONTING THE HUMBER AND PART OF BLOCK C PLAN M-973 CITY OF TORONTO (FORMERLY CITY OF ETOBICOKE) Lot Legal Description Humber River La Rose Park 1 Richview - B 1 Richview - A **Ukranian** Canadian Memorial Park Property Line-Eglinton Ave W. **Proposed Project**

CONTEXT PLAN 2

\dA1.1



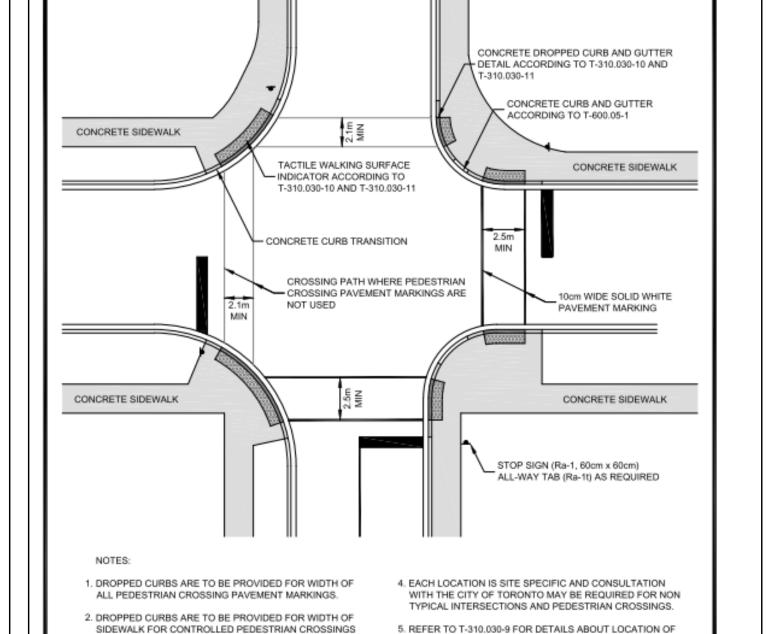

ENGINEERING AND CONSTRUCTION SERVICES STANDARD DRAWING

CONFIGURATIONS OF PEDESTRIAN CROSSINGS

CONTROLLED NON SIGNALIZED INTERSECTION

WHERE PAVEMENT MARKINGS ARE NOT USED.

INSTALLED AT ALL PEDESTRIAN CROSSINGS IN


CONJUNCTION WITH ALL ROAD AND SIDEWALK

All dimensions are in millimetres unless otherwise shown.

3. TACTILE WALKING SURFACE INDICATORS ARE TO BE

CONSTRUCTION, RECONSTRUCTION AND RESURFACING

TACTILE WALKING SURFACE INDICATORS, CURB CUTS,

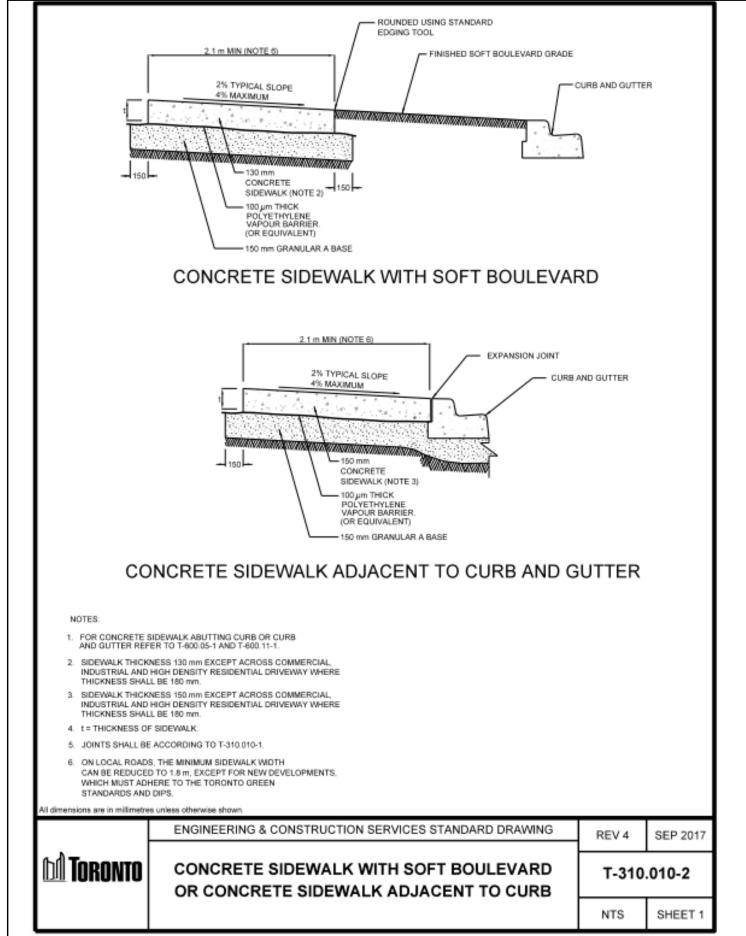



Green Roof Statistics

The Green Roof Statistics Template is required to be submitted for Site Plan Control Applications where a green roof is required under the Toronto Municipal Code Chapter 492, Green Roofs. Complete the table below and copy it directly onto the Roof Plan submitted as part of any Site Plan Control Application requiring a green roof in accordance with the Bylaw. Refer to Section § 492-1 of the Municipal Code for a complete list of defined terms, and greater clarity and certainty regarding the intent and application of the terms included in the template. The Toronto Municipal Code Chapter 492, Green Roofs can be found online at: http://www.toronto.ca/legdocs/municode/1184_492.pdf

Green Roof Statistics

| Available Roof Space Calculation | | Proposed |
|--|------------------|----------|
| Gross Floor Area, as defined in Green Roof Bylaw (m2) | | 22,450 |
| Total Roof Area (m ²) | | 1,453 |
| Area of Residential Private Terraces (m ²) | | 217 |
| Rooftop Outdoor Amenity Space, if in a Residenti | al Building (m²) | 342 |
| Area of Renewable Energy Devices (m ²) | | |
| Tower (s)Roof Area with floor plate less than 750 | m ² | 748 |
| Total Available Roof Space (m ²) | | 146 |
| Green Roof Coverage | Required | Proposed |
| Coverage of Available Roof Space (m ²) | 87 | 110 |
| Coverage of Available Roof Space (%) | 60% | 75% |

GREEN ROOF STATISTICS 3

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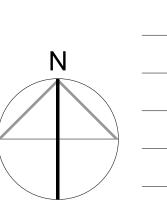
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HR Developments | Fieldgate

Betovan Construction Ltd.

Proposed Residential Development

Context Plan, OBC Matrix, **Green Roof Statistics**



Author Checked by: Checker Project No.: 15-067 Oct 13, 2023

1:2000

Drawn by:

T-310.030-8 6

REV 0 APR 2014

T-310.030-8

NTS SHEET 1

T-310.010-2_Rev4_Sep2017 5

PROJECT STATISTICS 1 Richview 29 Storey Residential Infill Site plan approval # if applicable 1.0 LOT AREA Lot 16, Con. D 19,851 4.9032 2.0 ZONING DESIGNATION Legal Description : Part of Lot 16, Concession D Fronting the Humber and Park of Block C, Plan M-973 City of Toronto Minimum Lot Frontage: Mimimum Lot area for each dwelling: 16 sq.m. 3.0 GROSS FLOOR AREAS 3.1 GFA PROPOSED For New Building (all common & residential areas, excluding shafts, mechancial, retail, parking & amentity areas) Level P2 25.00 25.00 Level P1 269 226.59 2,439 **Ground Level** 1,225.07 13,187 Level 2 1,516.85 16,327 Level 3 1,400.78 Level 4 (Including Indoor Amenity Area) 15,078 (Including Indoor Amenity Area) 1,364.77 14,690 Level 5 703.38 7,571 Level 6 (Including Indoor Amenity Area) 23 x 703.38 Level 7 - 29 16,881.12 181,707 Total GFA (Including Indoor Amenity Area) 23,369 251,268 TOTAL GFA (New Building) (Excluding Required Indoor Amenity Area) 22,450 241,653 3.3 GFA 1A Richview Rd (Existing Building) 468 5,038 Ground Floor 106 512 1,141 5,511 Amenity Area 21,746 234,067 Levels 2-19 Total 1A Richview Rd 22,832 245,756 3.4 GFA 1B Richview Rd (Existing Building) sq.m. 799 8,600 Ground Floor 145 1,561 Amenity Area 21,746 234,067 Levels 2-19 Total 1B Richview Rd 22,779 245,186 GRAND TOTAL GFA 68,060 732,611 4.0 FLOOR SPACE INDEX (GFA divided by LOT AREA) FSI with only Existing Buildings 2.30 3.43 FSI with New Building 5.0 LOT COVERAGE (Ground Floor Area divided by Lot Area) 5.1 Ground Floor Area 2,233 24,036 1A Richview Rd. 1B Richview Rd. 1,088 11,711 1,718 18,492 **New Building** 5.2 Lot Coverage 16.7% 25.4% **Existing Coverage** 3,321 35,747 Coverage with New Building 5,039 54,239 5.3 Landscape Area Coverage sq.m. sq.ft. LANDSCAPE AREA 49.0% 9,718 104,604 6.0 UNIT COUNT 6.1 Existing Buildings Unit Count (1A, 1B)

1 B 1B+D 1A Richview Rd. 182 units 183 units 1B Richview Rd. Total Units 365 units 50% 0% 40% 0% 10% Percent 6.2 New Building Unit Count 1 B 1B+D 2B 2B+D 3B Ground Floor Level 2 Level 3 units/ floor 22 units/ floor Level 4-5 10 units/ floor Level 6 253 units/ floor 306 units **Total Units** 47% 16% 27% 0% 🕻 10% 100% Percent Total Units (New and Existing) 671 units 6.3 Growing Up Guidelines Unit Count Level 3 units/ floor Level 4-5 4 units/ floor 2 units/ floor Level 7 - 29 46 units/ floor Total Units 10% 8% 18% Percent 7.0 PARKING (PA4) Parking Required 7.1 Parking Proposed 1A Richview Rd 182 units 182 units 155 spaces 18 spaces 0.85 x 0.10 x 173 spaces Parking Proposed 1A Richview Rd 7.2 Parking Proposed 1B Richview Rd

0.85 x 0.10 x

0.95

Parking Proposed 1B Richview Rd

183 units

183 units

156 spaces

18 spaces

174 spaces

| A III 1 Im :4- | lew Building | 0.85 x | 200 | 200 | |
|--|--|---|--|--|---|
| All Units Visitor | | 0.85 X 0.10 X | 306 units 306 units | 260 31 | spaces |
| Parking Proposed Ne | | 0.95 | | 291 | space |
| Total Parking Requi | | | | 637 | space |
| 7.4 Barrier Free Parking First 100 Spaces Each 50 spaces above 10 Total Barrier Free Par | 00 spaces | | | 5 11 16 | spaces spaces |
| 7.5 Total Parking Provid | | | | | |
| | New | Existing | 10.00 | | |
| Residential P2 Level P1 Level | Resident 157 179 | Resident 189 | Visitor | | |
| Ground Total Parking | 45 381 | 189 | 67 67 | | 6 |
| 7.6 Barrier Free Parking | a Spaces Provided | | | | To |
| P2 Level | | | | | |
| P1 Level Ground Total Parking | | | | | |
| | | | | | |
| 7.7 Parking to Unit Rati | 0 | | | | 0. |
| | rking Spaces designated fo | or the New Building, v | vill be provided with energ | gized outlet (E | VSE). |
| 8.1 Bicycle Parking (Bid | cycle Zone 2) quired (New building only | ·) | | | |
| Long Term 0.68/ Short Term 0.07/ | | 0.68x 0.07x | 306 units | 209 21 | spaces |
| Total Bicycle Parking | | U.U/X | JUU UIIIIS | 21 | spaces |
| - | vided (New & EXISITNG I | ouilding) | | | |
| Long Term on L2 (NEW E | | | | 206 | spaces |
| Short Term on L1 (NEW I Short Term on L1 (FOR E | | | | 21 20 | spaces spaces |
| Total Bicycle Parking | Required | | | 247 | spaces |
| | | Buildings | | | |
| 1A Richview Rd 2 m²/ 1B Richview Rd 2 m²/ | | 2 x 2 x | 182 units 183 units | 364 366 | m² m² |
| 1B Richview Rd 2 m²/ Total Amenity Area R | unit | 2 x 2 x lings | | | |
| 1B Richview Rd 2 m²/ Total Amenity Area R 9.2 Outdoor Amenity A | unit equired for EXISTING Build rea Required for EXISTIN | 2 x 2 x lings G Buildings | 183 units | 366 | m² |
| 1B Richview Rd 2 m²/ Total Amenity Area R | unit equired for EXISTING Build rea Required for EXISTIN | 2 x 2 x lings | | 366 | m² |
| 1B Richview Rd 2 m²/ Total Amenity Area R 9.2 Outdoor Amenity Ai 1A Richview Rd 2 m²/ 1B Richview Rd 2 m²/ | unit equired for EXISTING Build rea Required for EXISTIN | 2 x 2 x lings G Buildings | 183 units | 366 730 364 | m² m² m² |
| 1B Richview Rd 2 m²/ Total Amenity Area R 9.2 Outdoor Amenity Area R 1A Richview Rd 2 m²/ 1B Richview Rd 2 m²/ Total Amenity Area R | unit equired for EXISTING Build rea Required for EXISTIN unit unit | 2 x 2 x lings G Buildings 2 x 2 x 2 x | 183 units | 366 730 364 366 | m² m² m² m² m² |
| 1B Richview Rd 2 m²/ Total Amenity Area R 9.2 Outdoor Amenity Ai 1A Richview Rd 2 m²/ 1B Richview Rd 2 m²/ Total Amenity Area R 9.3 Indoor Amenity Are 1A Richview Rd - Pool @ | equired for EXISTING Build rea Required for EXISTING unit unit equired for EXISTING Build a Provided in EXISTING E | 2 x 2 x lings G Buildings 2 x 2 x 2 x | 183 units | 366 730 364 366 | m² m² m² m² m² |
| 1B Richview Rd 2 m²/ Total Amenity Area R 9.2 Outdoor Amenity Al 1A Richview Rd 2 m²/ 1B Richview Rd 2 m²/ Total Amenity Area R 9.3 Indoor Amenity Area 1A Richview Rd - Pool @ 1A Richview Rd - Change 1A Richview Rd - Change | equired for EXISTING Build rea Required for EXISTING unit unit equired for EXISTING Build a Provided in EXISTING E L1 e room, Women's @ P1 e room, Men's @ L1 | 2 x 2 x lings G Buildings 2 x 2 x 2 x 8 ings | 183 units | 366 730 364 366 730 236 76 111 | m² m² m² m² m² m² m² m² |
| Total Amenity Area R 9.2 Outdoor Amenity Area R 1A Richview Rd 2 m²/ 1B Richview Rd 2 m²/ Total Amenity Area R 9.3 Indoor Amenity Area R 1A Richview Rd - Pool @ 1A Richview Rd - Change | equired for EXISTING Build rea Required for EXISTING unit unit equired for EXISTING Build a Provided in EXISTING E L1 e room, Women's @ P1 e room, Men's @ L1 rovided for EXISTING Build | 2 x 2 x lings G Buildings 2 x 2 x 2 x lings Buildings | 183 units | 366 730 364 366 730 236 76 111 423 | m² m² m² m² m² m² m² m² m² |
| Total Amenity Area R 9.2 Outdoor Amenity Area R 1A Richview Rd 2 m²/ 1B Richview Rd 2 m²/ Total Amenity Area R 9.3 Indoor Amenity Area R 1A Richview Rd - Pool @ 1A Richview Rd - Change | equired for EXISTING Build rea Required for EXISTING unit unit equired for EXISTING Build a Provided in EXISTING E L1 e room, Women's @ P1 e room, Men's @ L1 | 2 x 2 x lings G Buildings 2 x 2 x 2 x lings Buildings | 183 units | 366 730 364 366 730 236 76 111 | m² m² m² m² m² m² m² m² |
| Total Amenity Area R 9.2 Outdoor Amenity A 1A Richview Rd 2 m²/ 1B Richview Rd 2 m²/ Total Amenity Area R 9.3 Indoor Amenity Area 1A Richview Rd - Pool @ 1A Richview Rd - Change 1A Richview Rd - Pool @ 1A Richview Rd - Pool @ 1A Richview Rd - Change 1A Richview Rd - | equired for EXISTING Build rea Required for EXISTING Build unit unit equired for EXISTING Build a Provided in EXISTING E room, Women's @ P1 e room, Men's @ L1 rovided for EXISTING Build reas Provided in EXISTING Build | 2 x 2 x lings G Buildings 2 x 2 x 2 x lings G Suildings G Condition | 183 units | 366 730 364 366 730 236 76 111 423 sq.m. 96 60 | m² m |
| Total Amenity Area R 9.2 Outdoor Amenity Area R 1A Richview Rd 2 m²/ 1B Richview Rd 2 m²/ Total Amenity Area R 9.3 Indoor Amenity Area R 1A Richview Rd - Pool @ 1A Richview Rd - Change 1A Richvi | equired for EXISTING Build rea Required for EXISTING unit unit equired for EXISTING Build a Provided in EXISTING E room, Women's @ P1 e room, Men's @ L1 rovided for EXISTING Build reas Provided in EXISTING Build reas Provided in EXISTING Build | 2 x 2 x lings G Buildings 2 x 2 x 2 x lings G Suildings G Condition | 183 units | 366 730 364 366 730 236 76 111 423 sq.m. 96 | m² sơ |
| Total Amenity Area R 9.2 Outdoor Amenity Area R 1A Richview Rd 2 m²/ 1B Richview Rd 2 m²/ Total Amenity Area R 9.3 Indoor Amenity Area R 1A Richview Rd - Pool @ 1A Richview Rd - Change 1A Richvi | equired for EXISTING Build rea Required for EXISTING unit unit equired for EXISTING Build a Provided in EXISTING E room, Women's @ P1 e room, Wen's @ L1 rovided for EXISTING Build reas Provided in EXISTING Build Reas Provi | 2 x 2 x lings G Buildings 2 x 2 x 2 x lings G Suildings G Condition | 183 units | 366 730 364 366 730 236 76 111 423 sq.m. 96 60 | m² m |
| Total Amenity Area R 9.2 Outdoor Amenity Ai 1A Richview Rd 2 m²/ 1B Richview Rd 2 m²/ Total Amenity Area R 9.3 Indoor Amenity Are 1A Richview Rd - Pool @ 1A Richview Rd - Change 1A Richview Rd - Change 1A Richview Rd - Change Total Amenity Area P 9.4 Outdoor Amenity Ai Playground Sitting Areas @ Grade Total Outdoor Amenit WITH NEW DEVELOPMEN 9.5 Indoor Amenity Area | equired for EXISTING Build rea Required for EXISTING unit unit equired for EXISTING Build a Provided in EXISTING B c room, Women's @ P1 c room, Men's @ L1 rovided for EXISTING Build reas Provided in EXISTING ty Area Provided in EXISTING TY a Required | 2 x 2 x lings G Buildings 2 x 2 x 2 x 2 x 2 x 2 x 2 x 2 x 2 x 2 | 182 units 183 units | 366 730 364 366 730 236 76 111 423 sq.m. 96 60 156 | m² m² m² m² m² m² m² m² m² 1,0 |
| Total Amenity Area R 9.2 Outdoor Amenity Area R 1A Richview Rd 2 m²/ 1B Richview Rd 2 m²/ Total Amenity Area R 9.3 Indoor Amenity Area R 1A Richview Rd - Pool @ 1A Richview Rd - Change 1A Richview Rd 2 m²/ 1B Richview Rd 2 m²/ 1B Richview Rd 2 m²/ 1B Richview Rd 2 m²/ | equired for EXISTING Build rea Required for EXISTING Build unit equired for EXISTING Build a Provided in EXISTING Build room, Women's @ P1 eroom, Wen's @ L1 rovided for EXISTING Build reas Provided in EXISTING Build reas P | 2 x 2 x lings G Buildings 2 x 2 x 2 x 2 x 2 x 2 x 2 x 2 x 2 x 2 | 182 units 182 units 183 units | 366 730 364 366 730 236 76 111 423 sq.m. 96 60 156 | m² m² m² m² m² m² m² m² m² c 1,6 |
| Total Amenity Area R 9.2 Outdoor Amenity Ai 1A Richview Rd 2 m²/ 1B Richview Rd 2 m²/ Total Amenity Area R 9.3 Indoor Amenity Area 1A Richview Rd - Pool @ 1A Richview Rd - Change Total Amenity Area P 9.4 Outdoor Amenity Ai Playground Sitting Areas @ Grade Total Outdoor Amenity MITH NEW DEVELOPMEI 9.5 Indoor Amenity Area 1A Richview Rd 2 m²/ | equired for EXISTING Build rea Required for EXISTING Build unit unit equired for EXISTING Build a Provided in EXISTING Build a Provided in EXISTING Build room, Women's @ P1 eroom, Men's @ L1 rovided for EXISTING Build reas Provided in EXISTING Build reas Provided in EXISTING Build a Required unit unit | 2 x 2 x lings G Buildings 2 x 2 x 2 x 2 x 2 x 2 x 2 x 2 x 2 x 2 | 182 units 183 units 184 units | 366 730 364 366 730 236 76 111 423 sq.m. 96 60 156 | m² m² m² m² m² m² m² m² m² 1,6 |
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Outdoor Open Space @ Grade

Sitting Areas @ Grade

Total Amenity Area

Level 6 - Outdoor Amenity

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20 De Boers Drive Suite 400

Toronto, ON M3J 0H1 Revisions:

Feb 13 ,2023 Re-Zoning Re-submission Feb 10 ,2023 6. Re-Zoning Re-submission 5. Re-Zoning Re-submission Feb 08 ,2023 Feb 03 ,2023 4. Re-Zoning Re-submission Dec 22 ,2020 Re-Zoning Re-submission 2. Re-Zoning Re-submission Oct 07 ,2020 Re-Zoning Dec 14 ,2018 No.: Issued For:

HR Developments | Fieldgate

Betovan Construction Ltd. Proposed Residential Development

Drawing Title: **Building Statistics**

Drawn by: Author Checked by: Checker Project No.: 15-067 Oct 13, 2023

RESERVED 5 dA1.2 NTS


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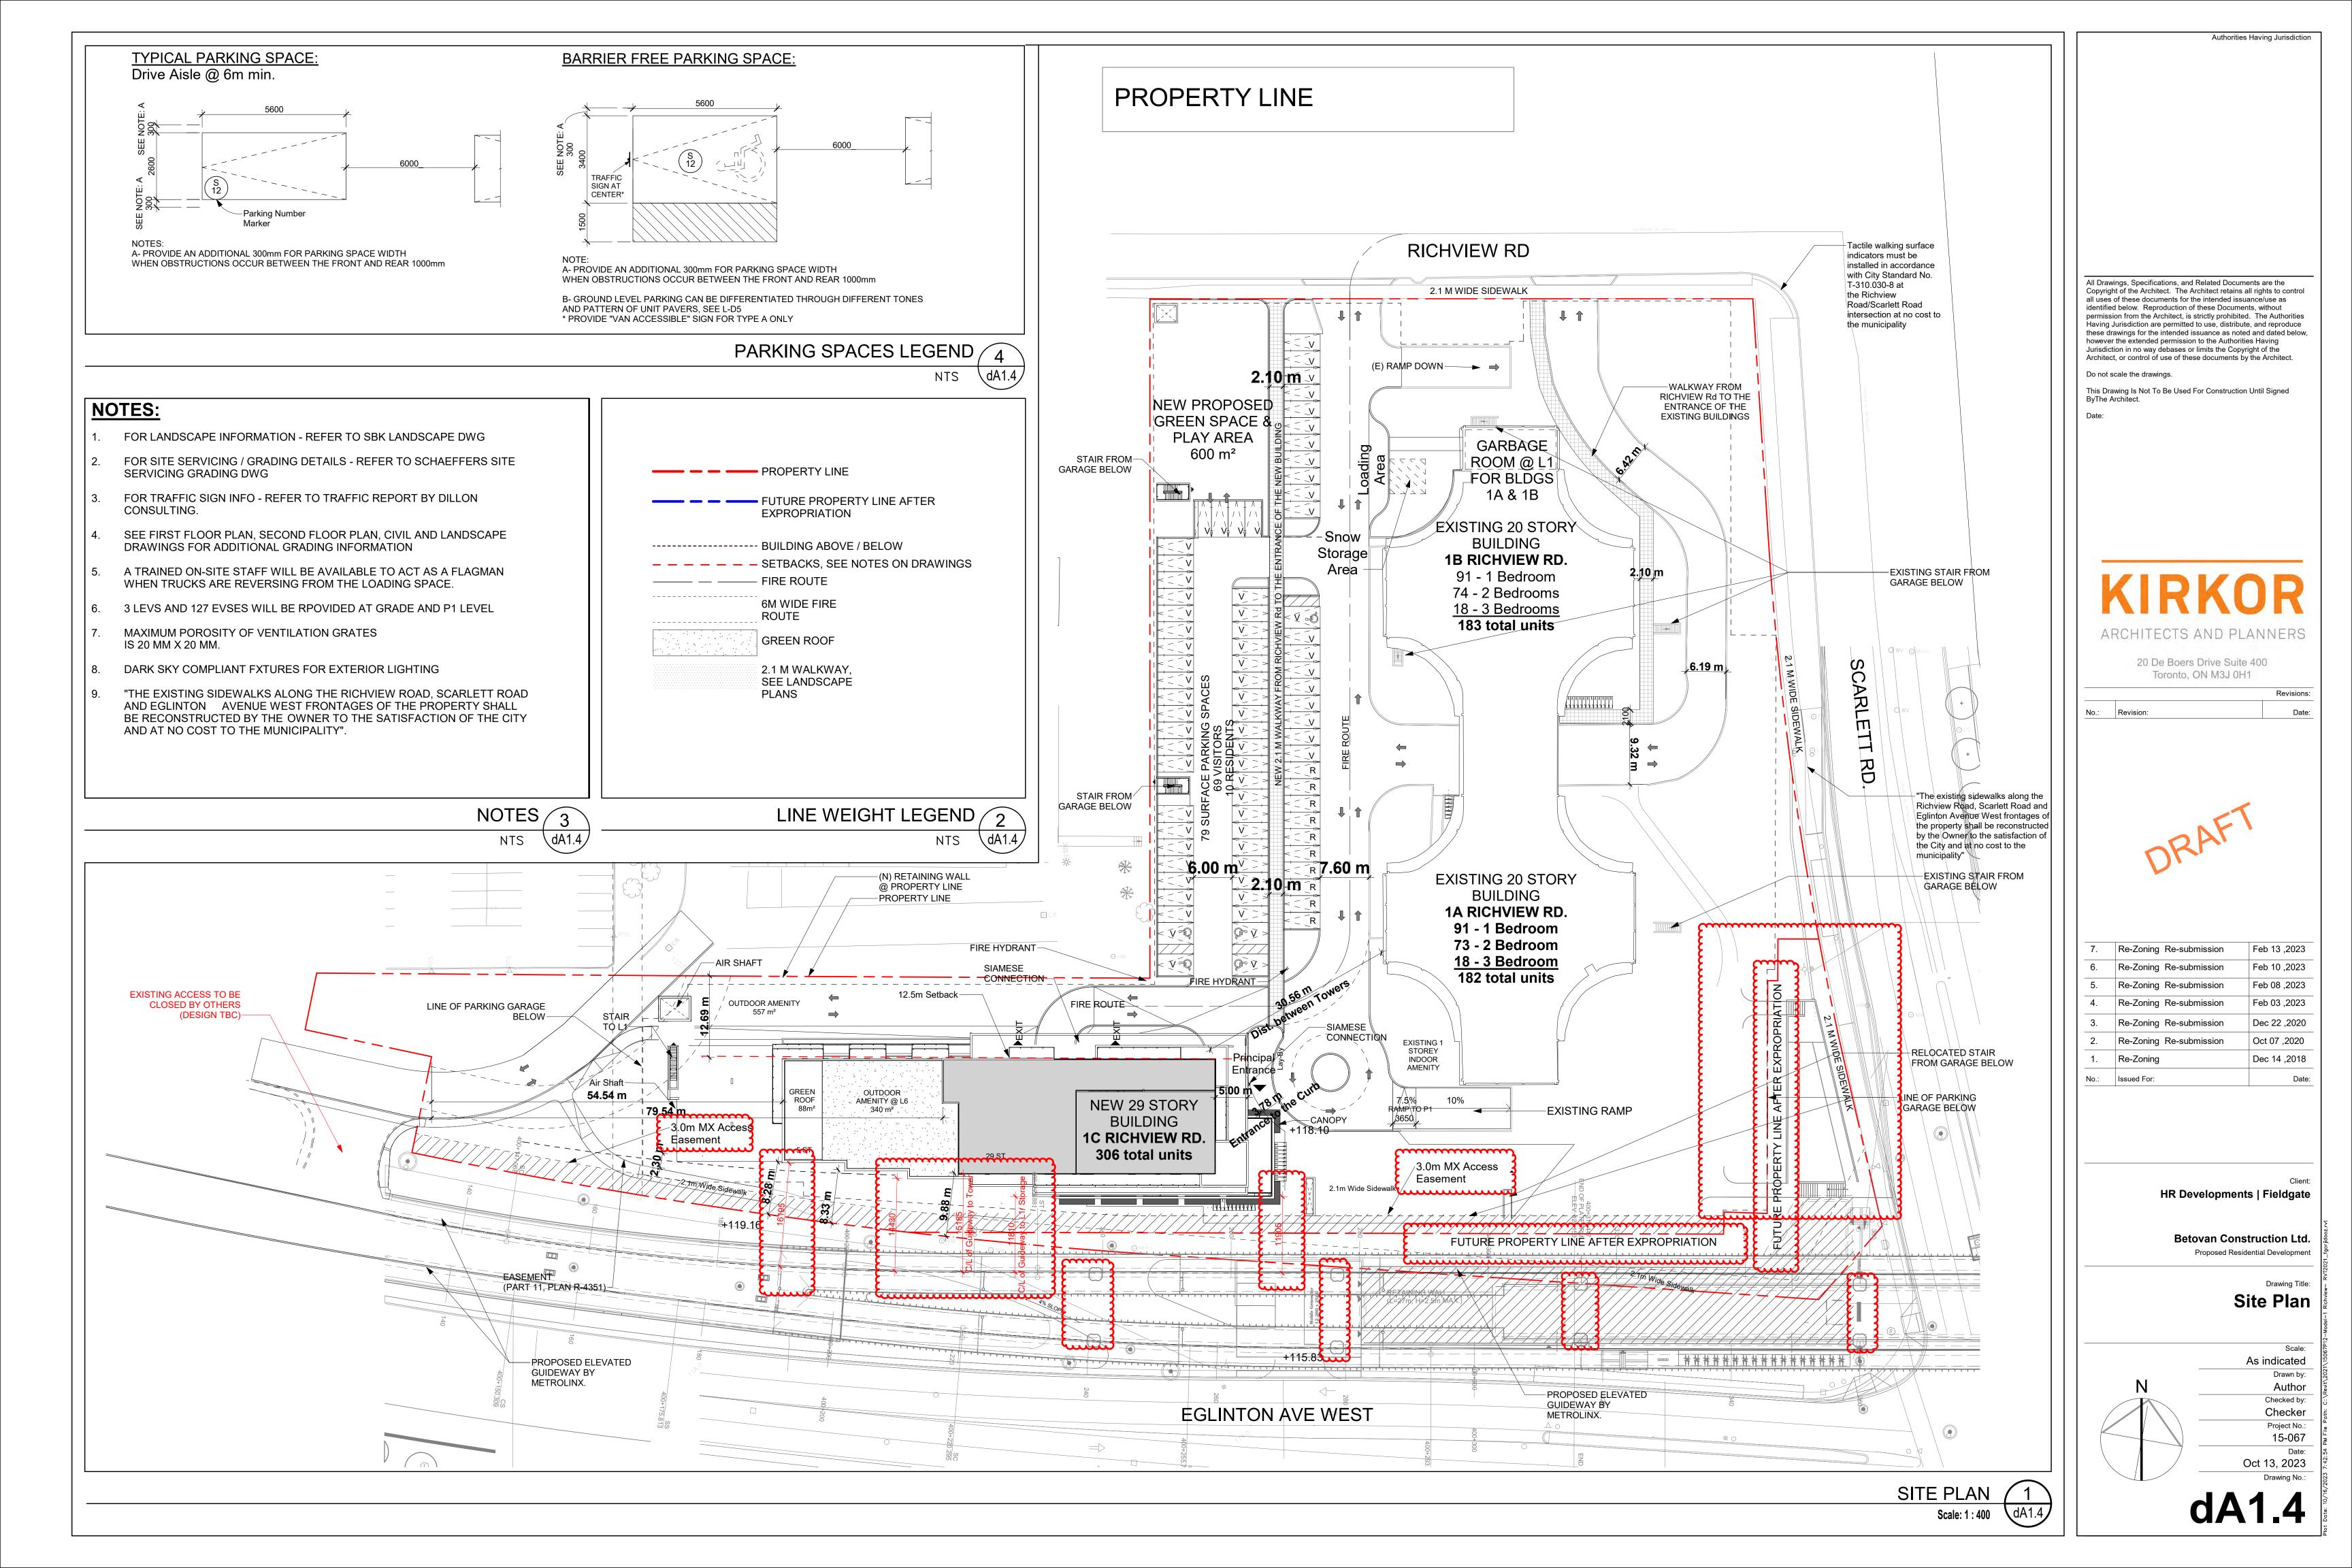
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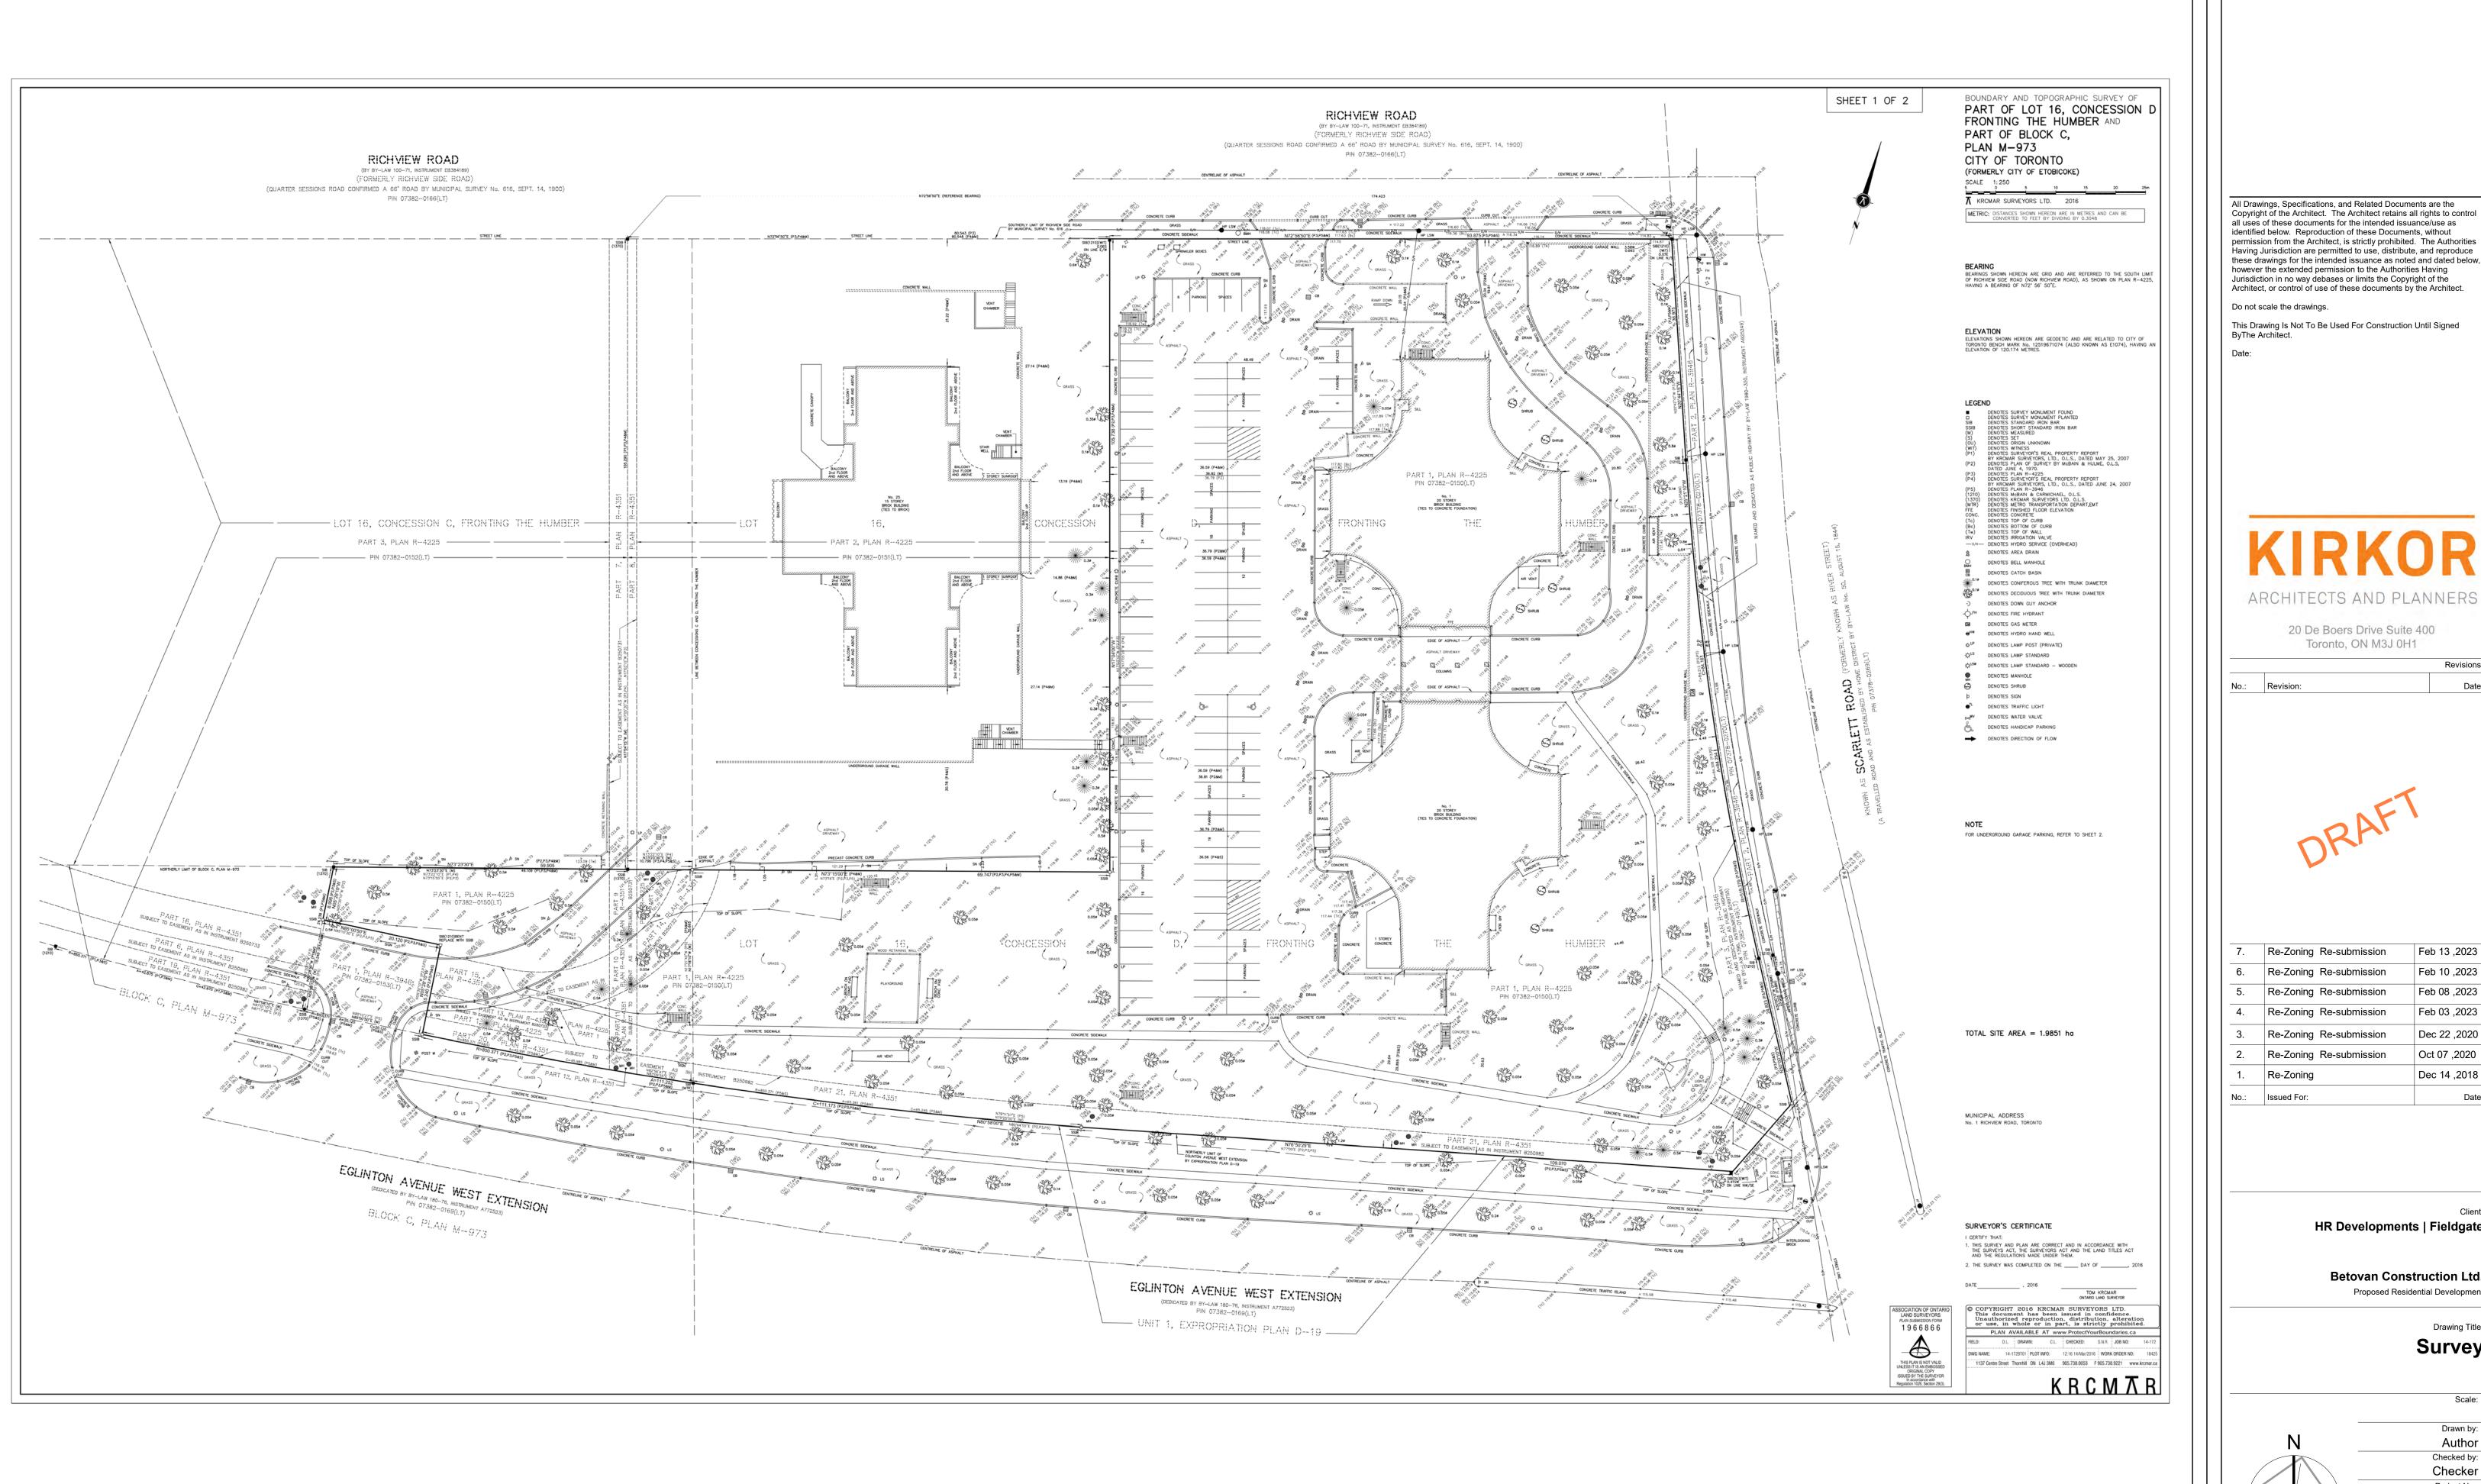
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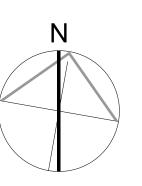


| 7. | Re-Zoning Re-submission | Feb 13 ,2023 |
|------|-------------------------|--------------|
| 6. | Re-Zoning Re-submission | Feb 10 ,2023 |
| 5. | Re-Zoning Re-submission | Feb 08 ,2023 |
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| 2. | Re-Zoning Re-submission | Oct 07 ,2020 |
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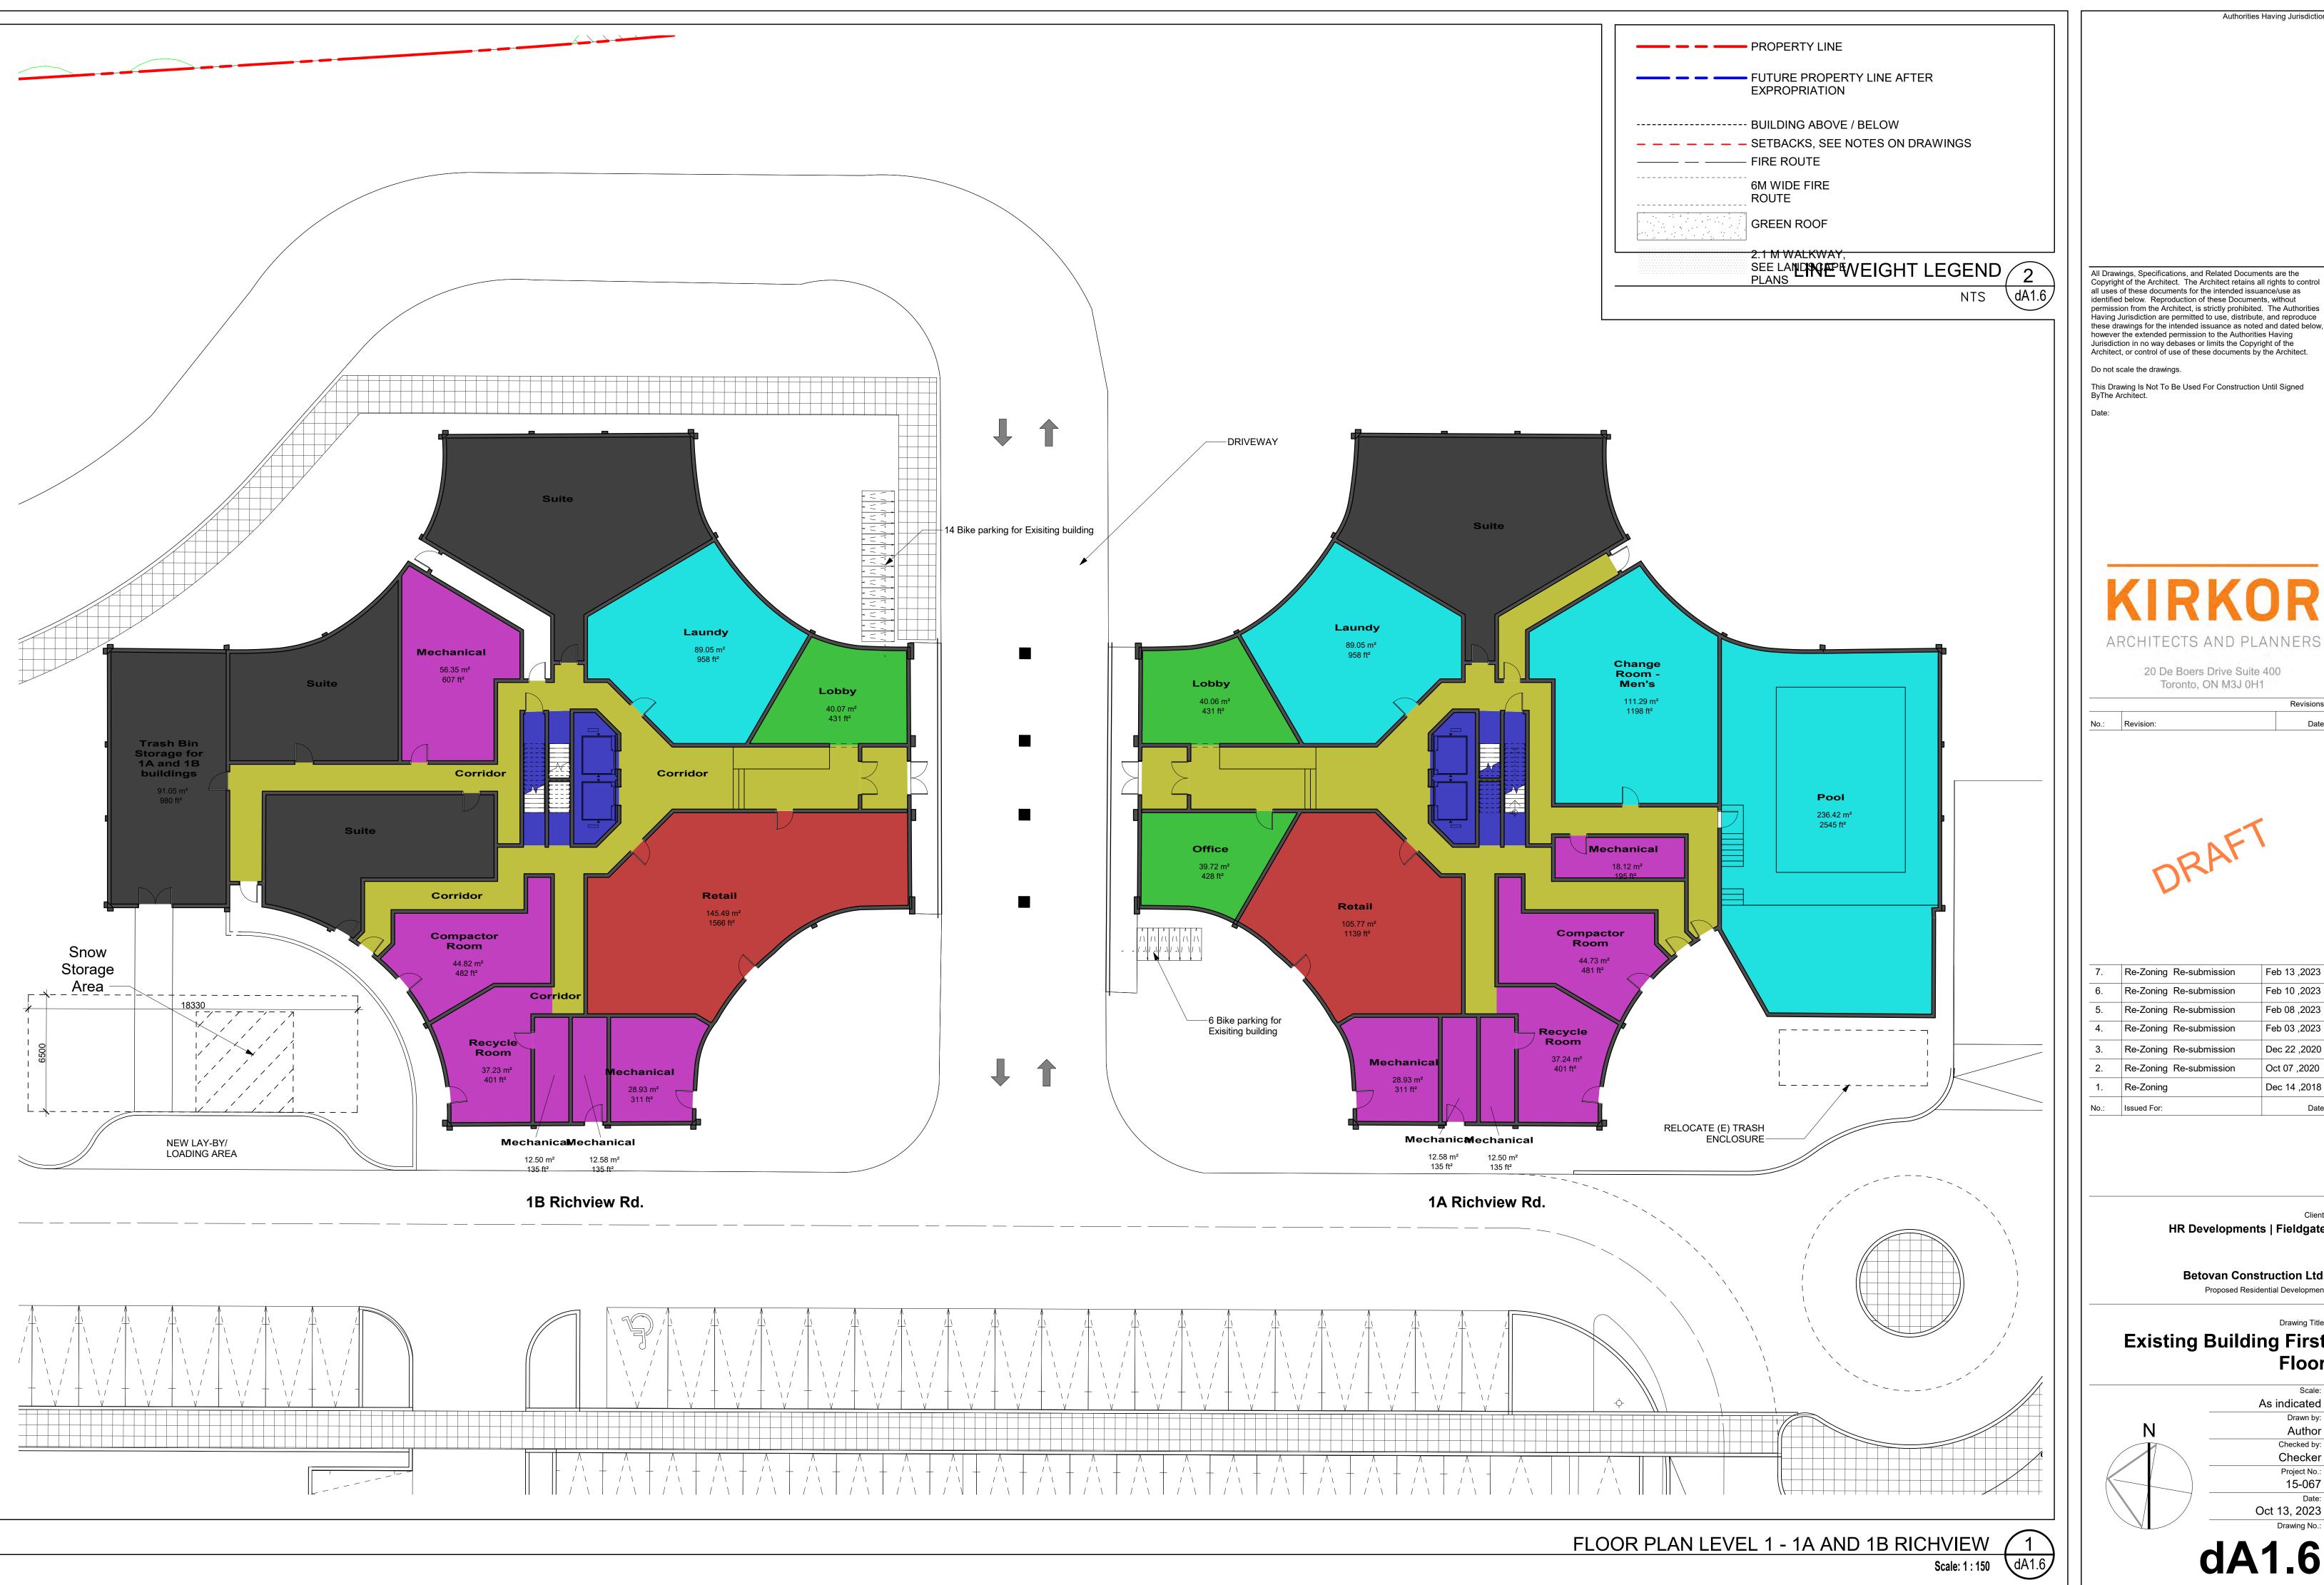
> Drawing Title: Survey



Survey 1

NTS \dA1.5
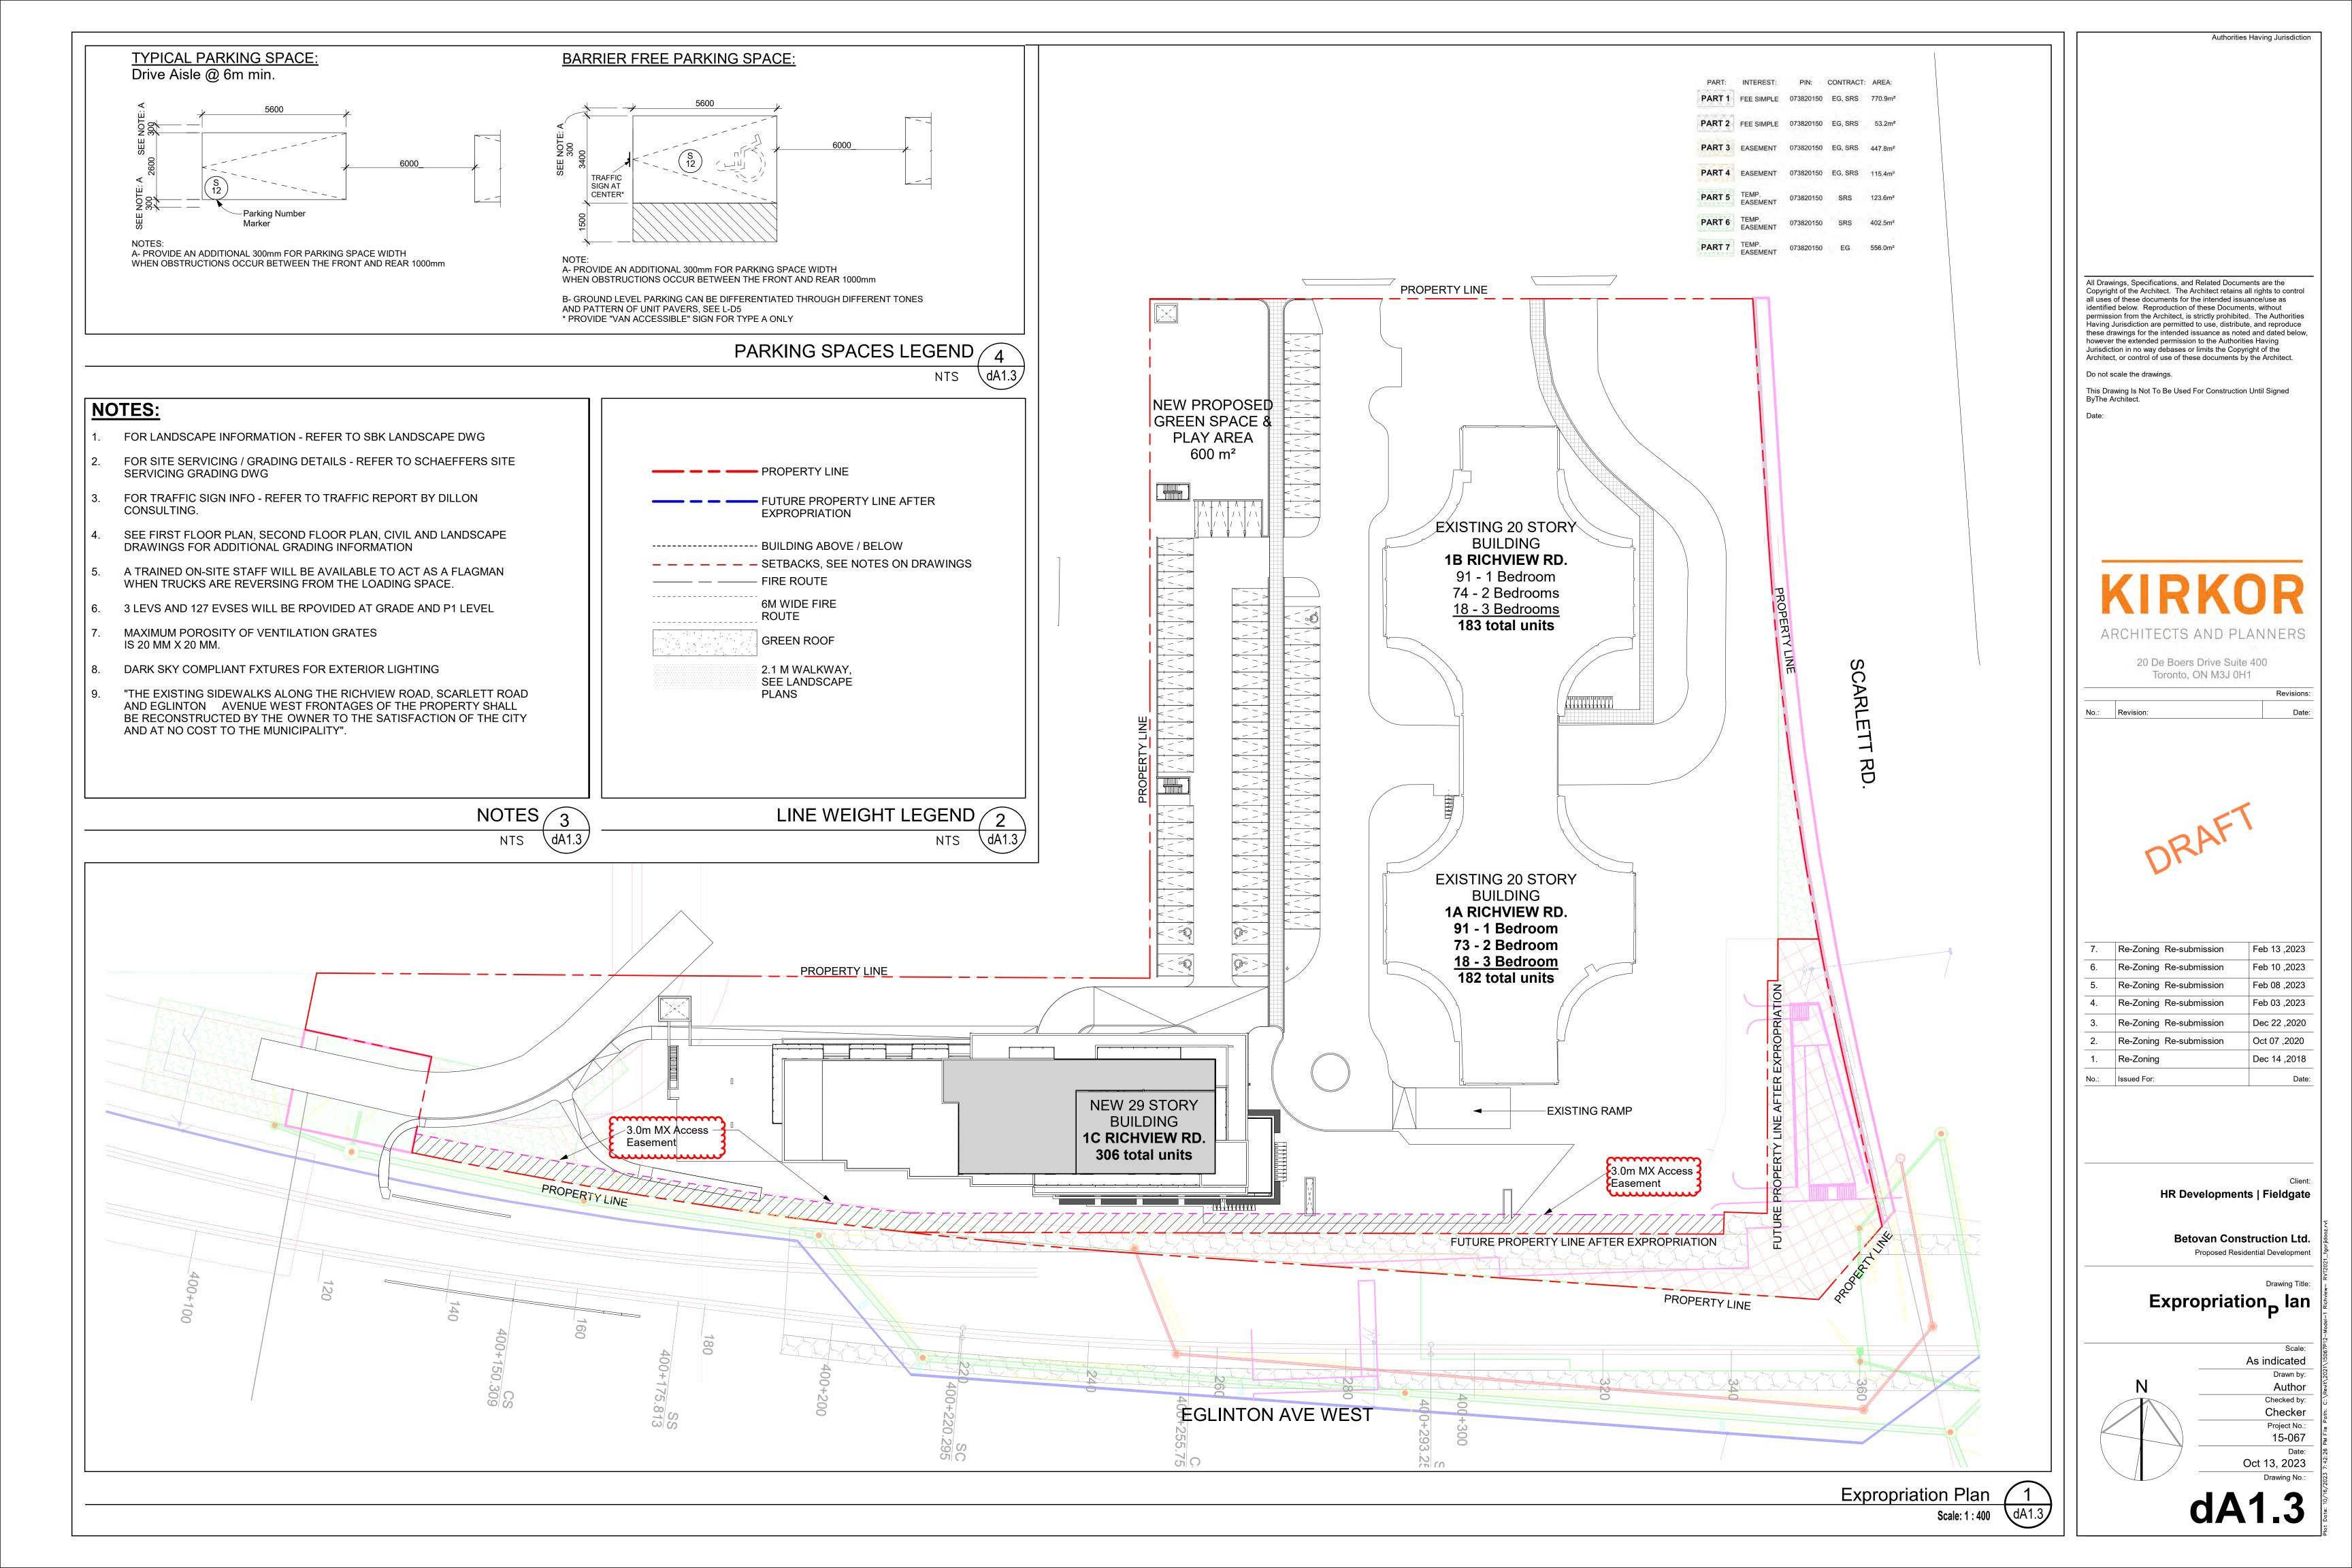
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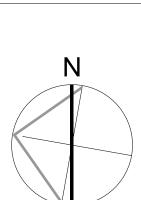
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| 1. | Re-Zoning | Dec 14 ,2018 |
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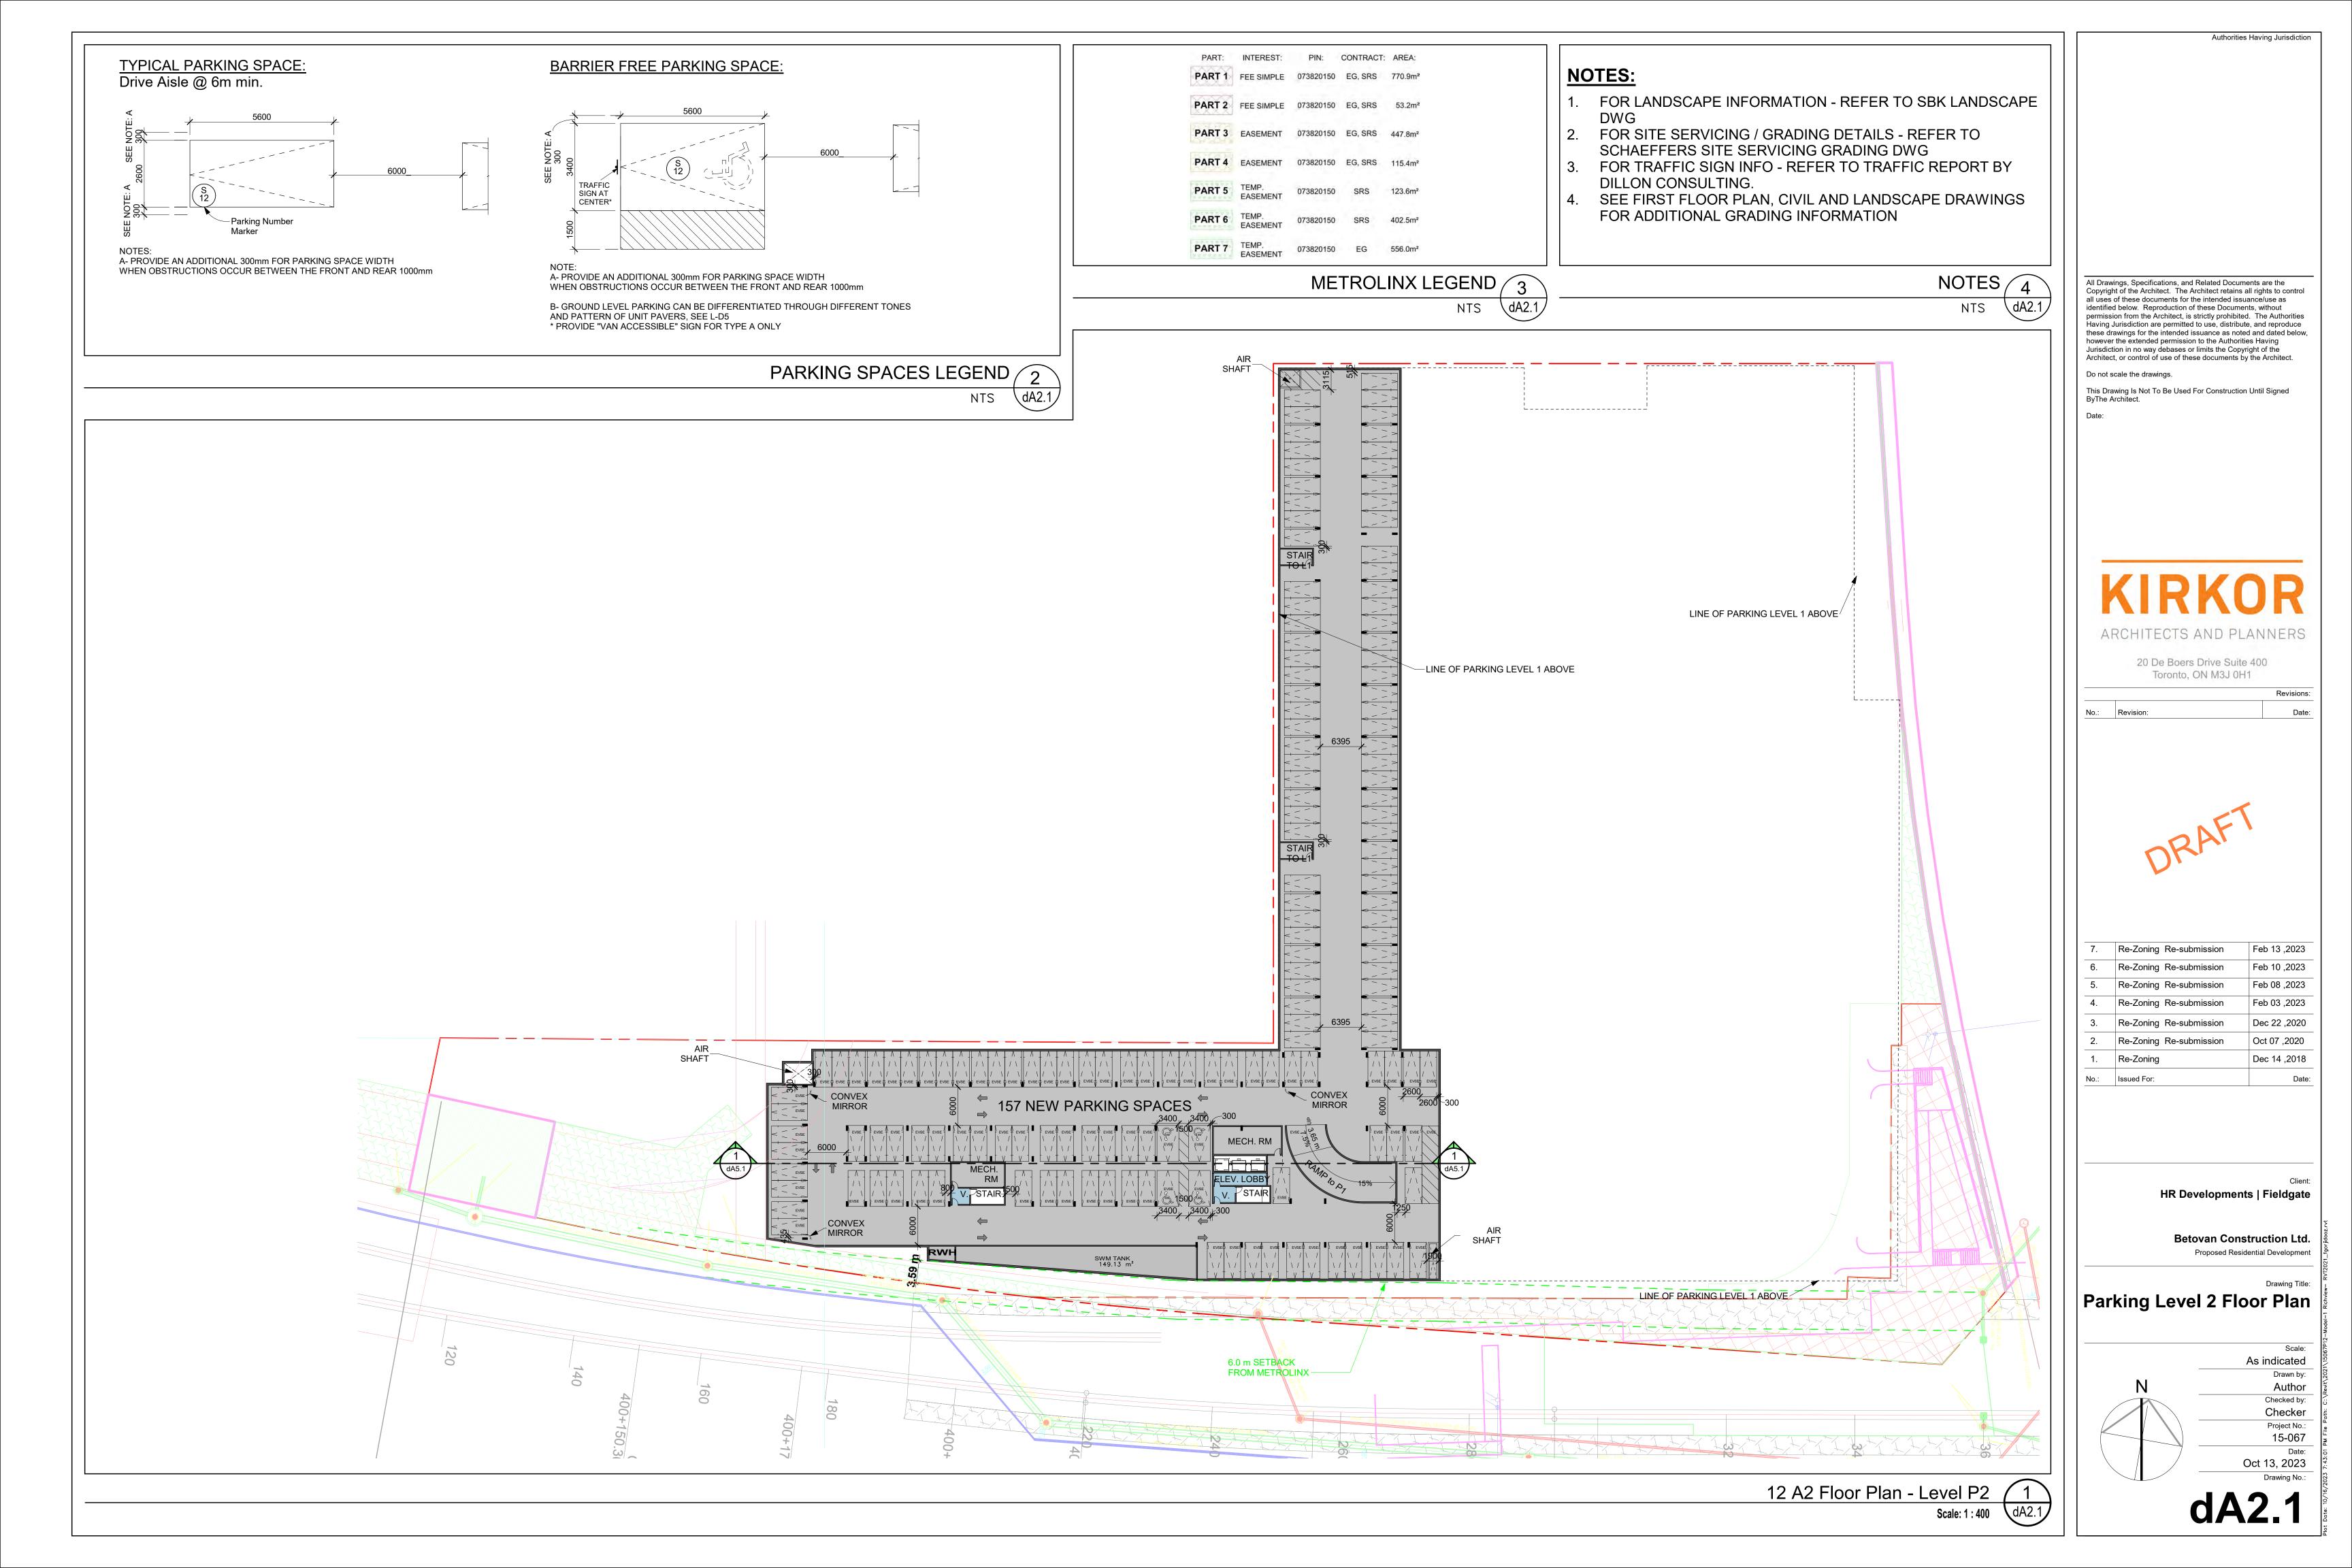
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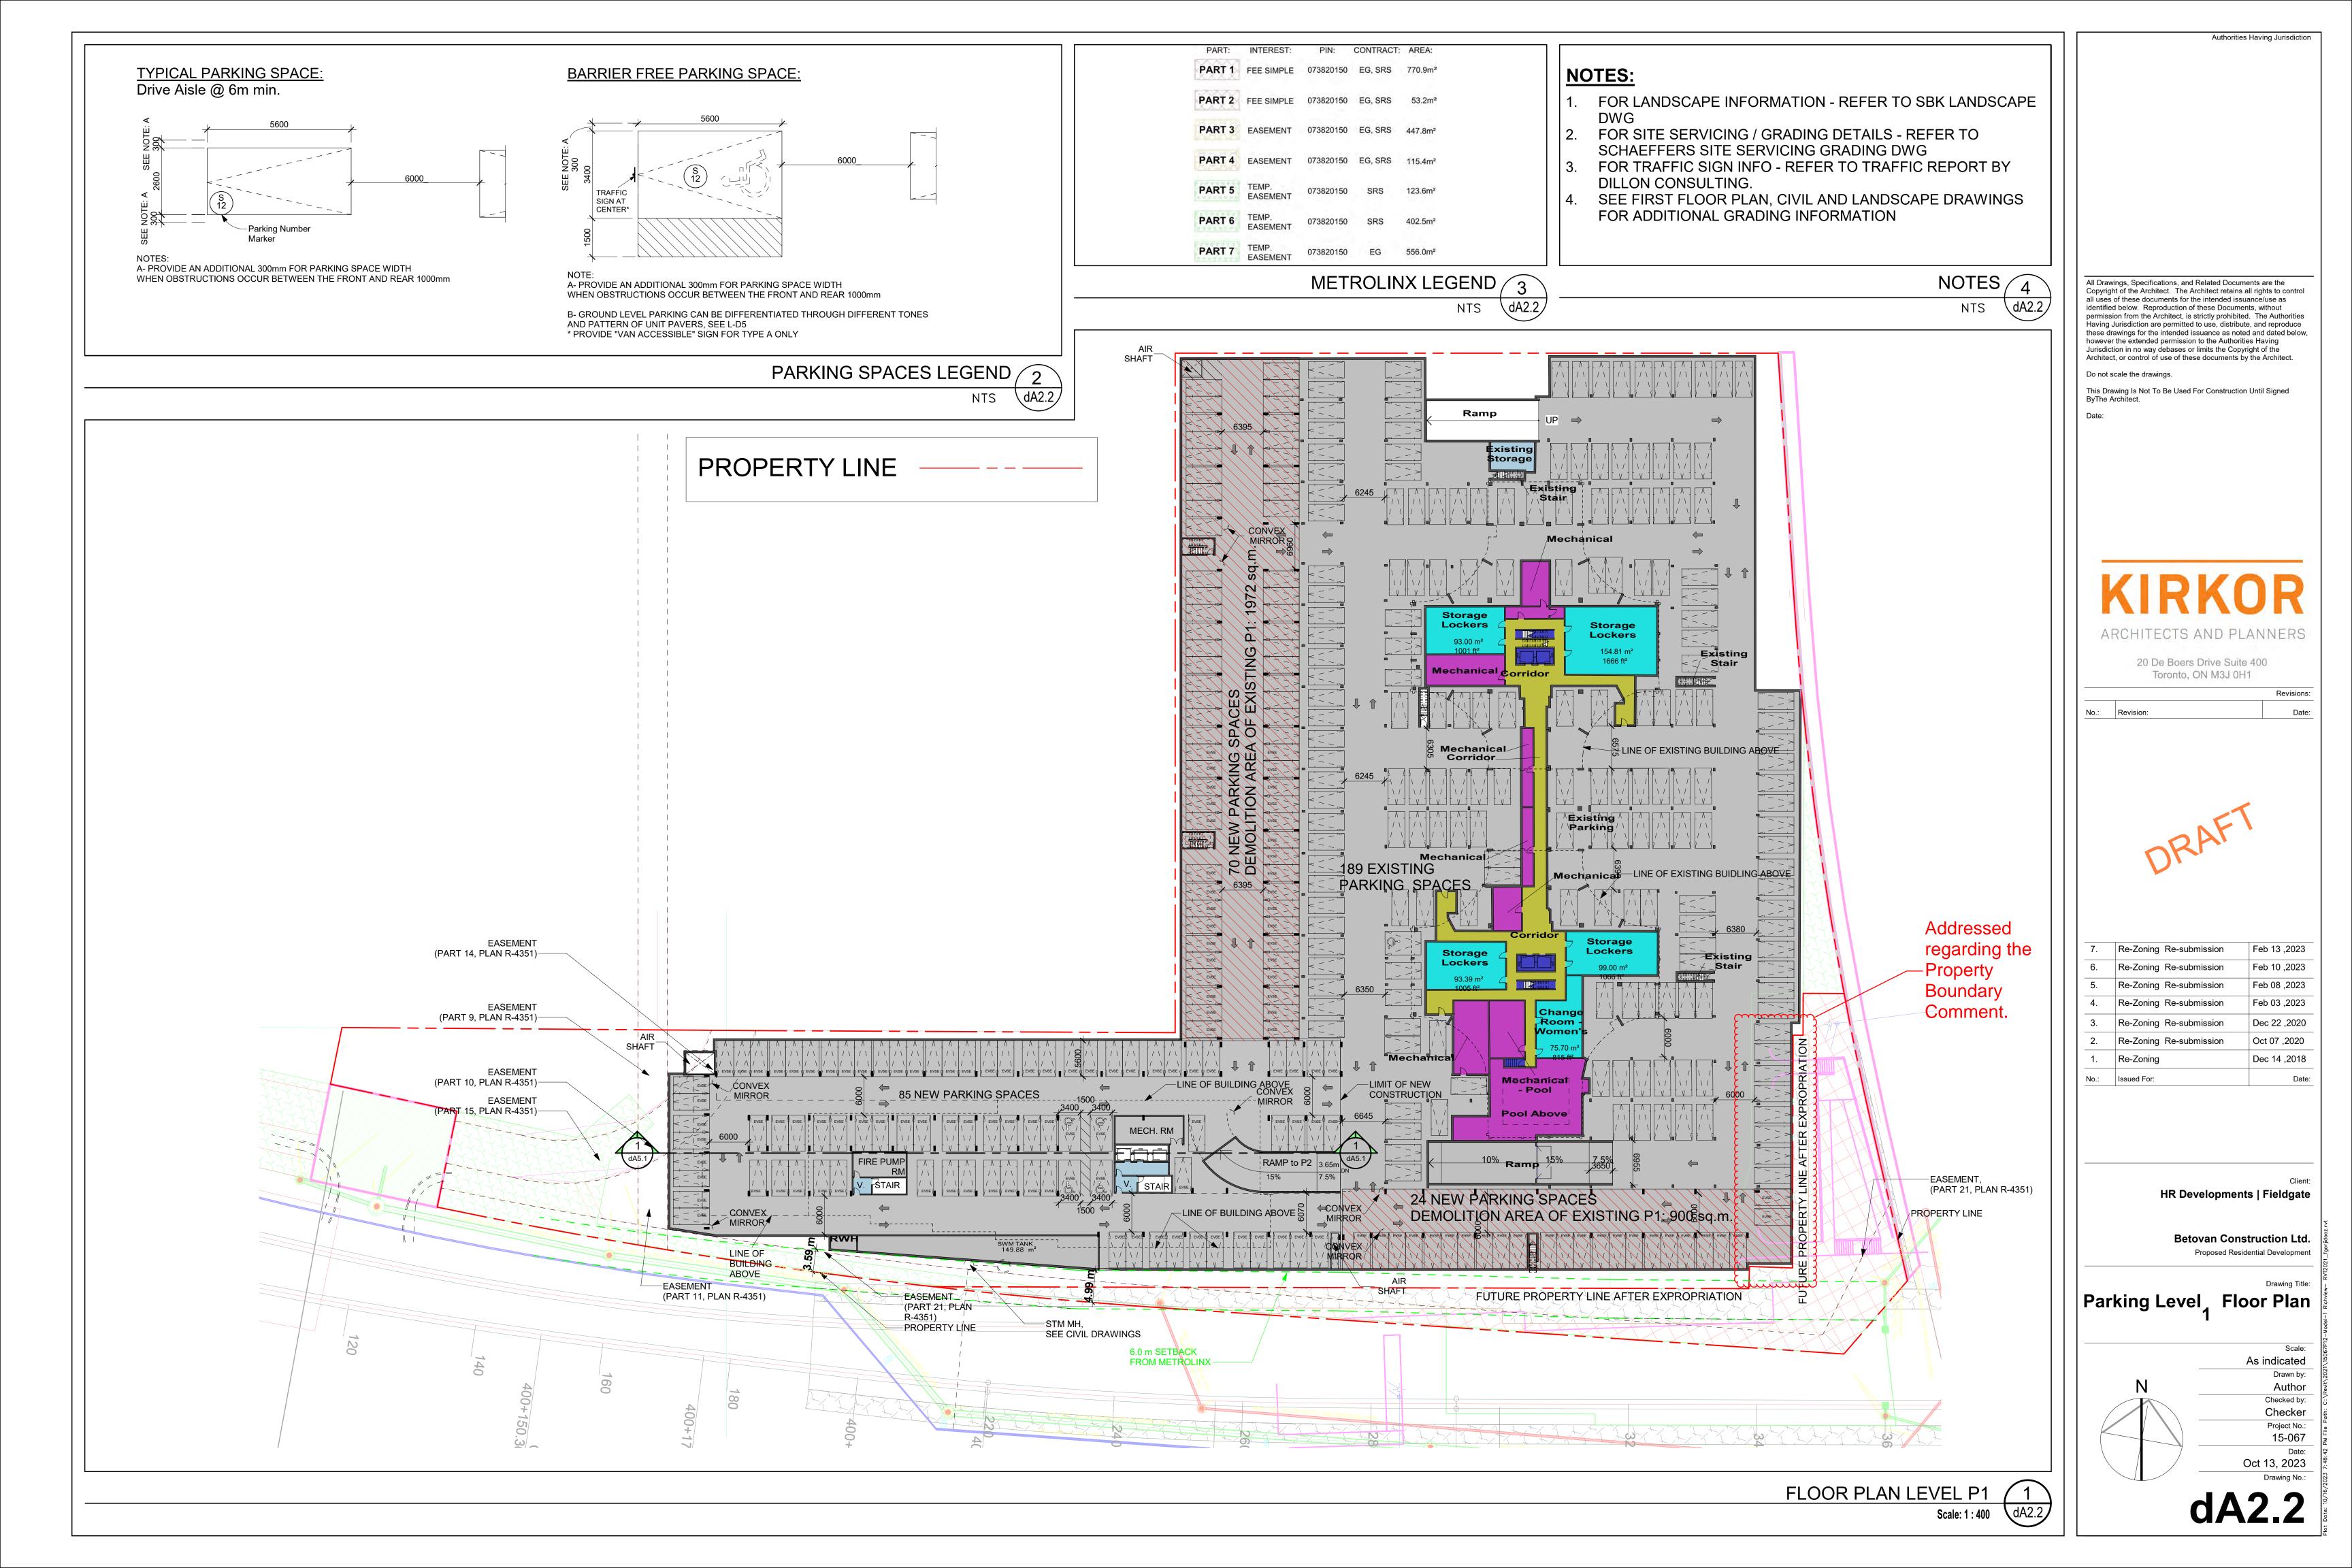
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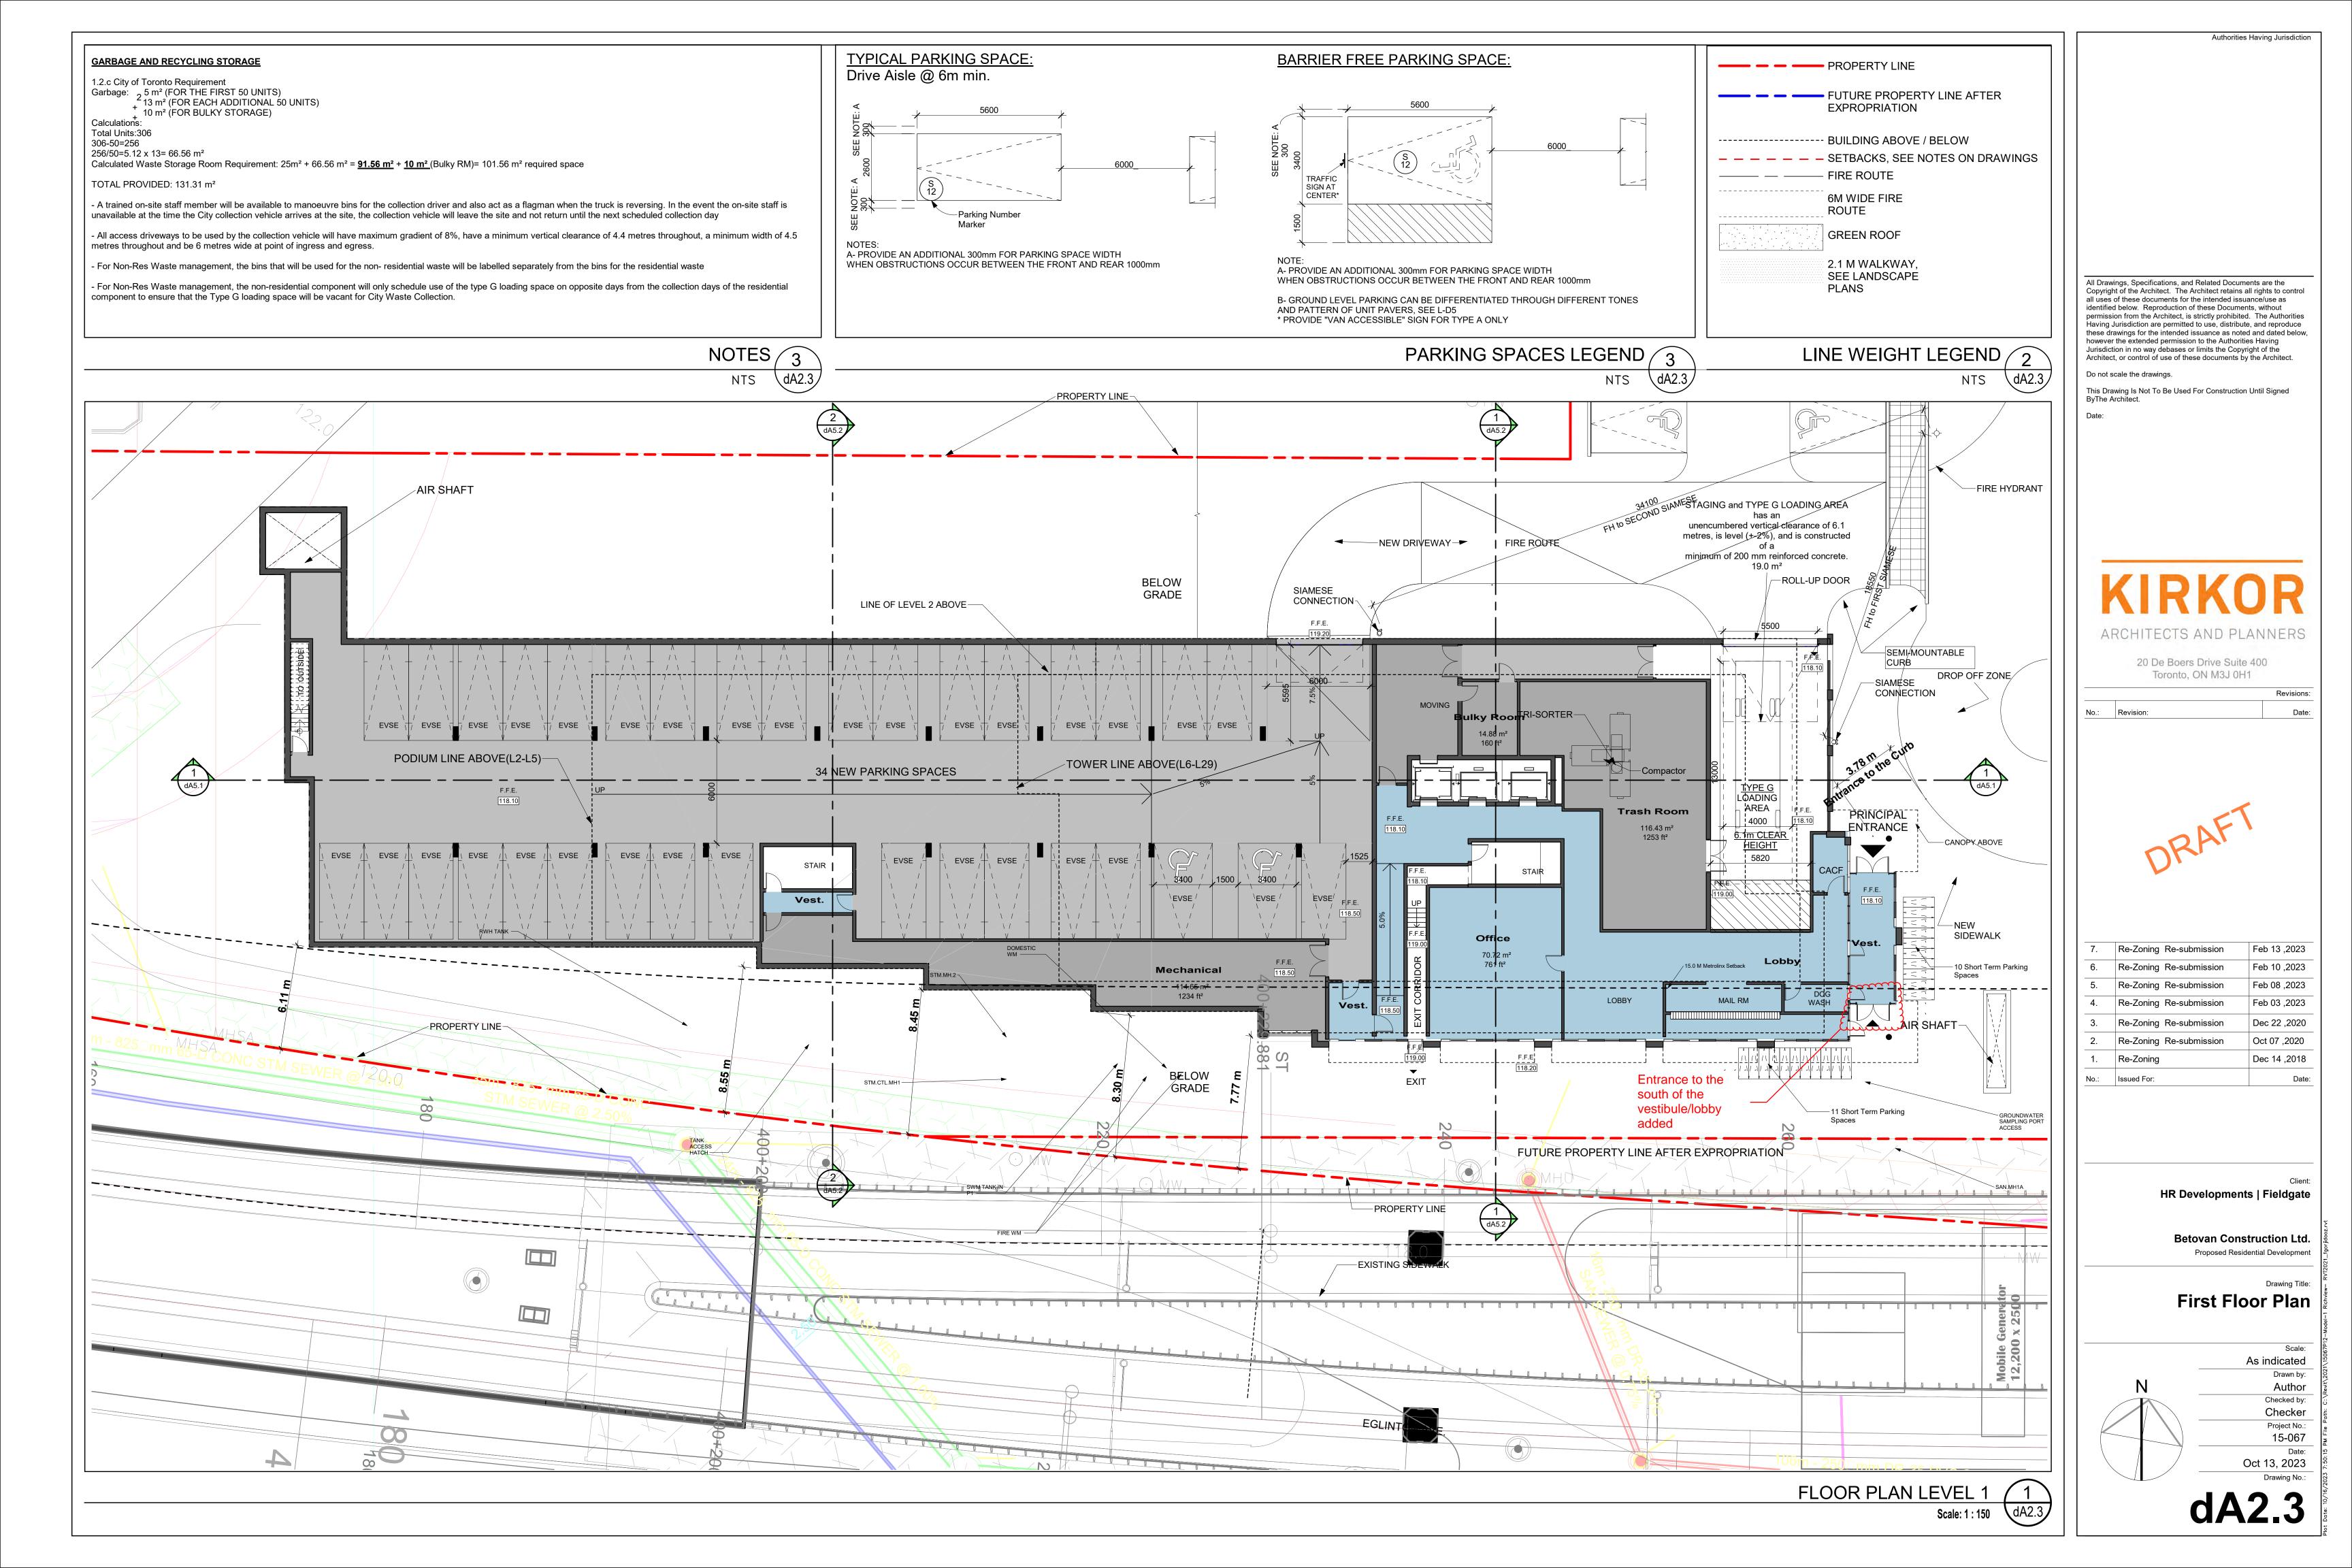
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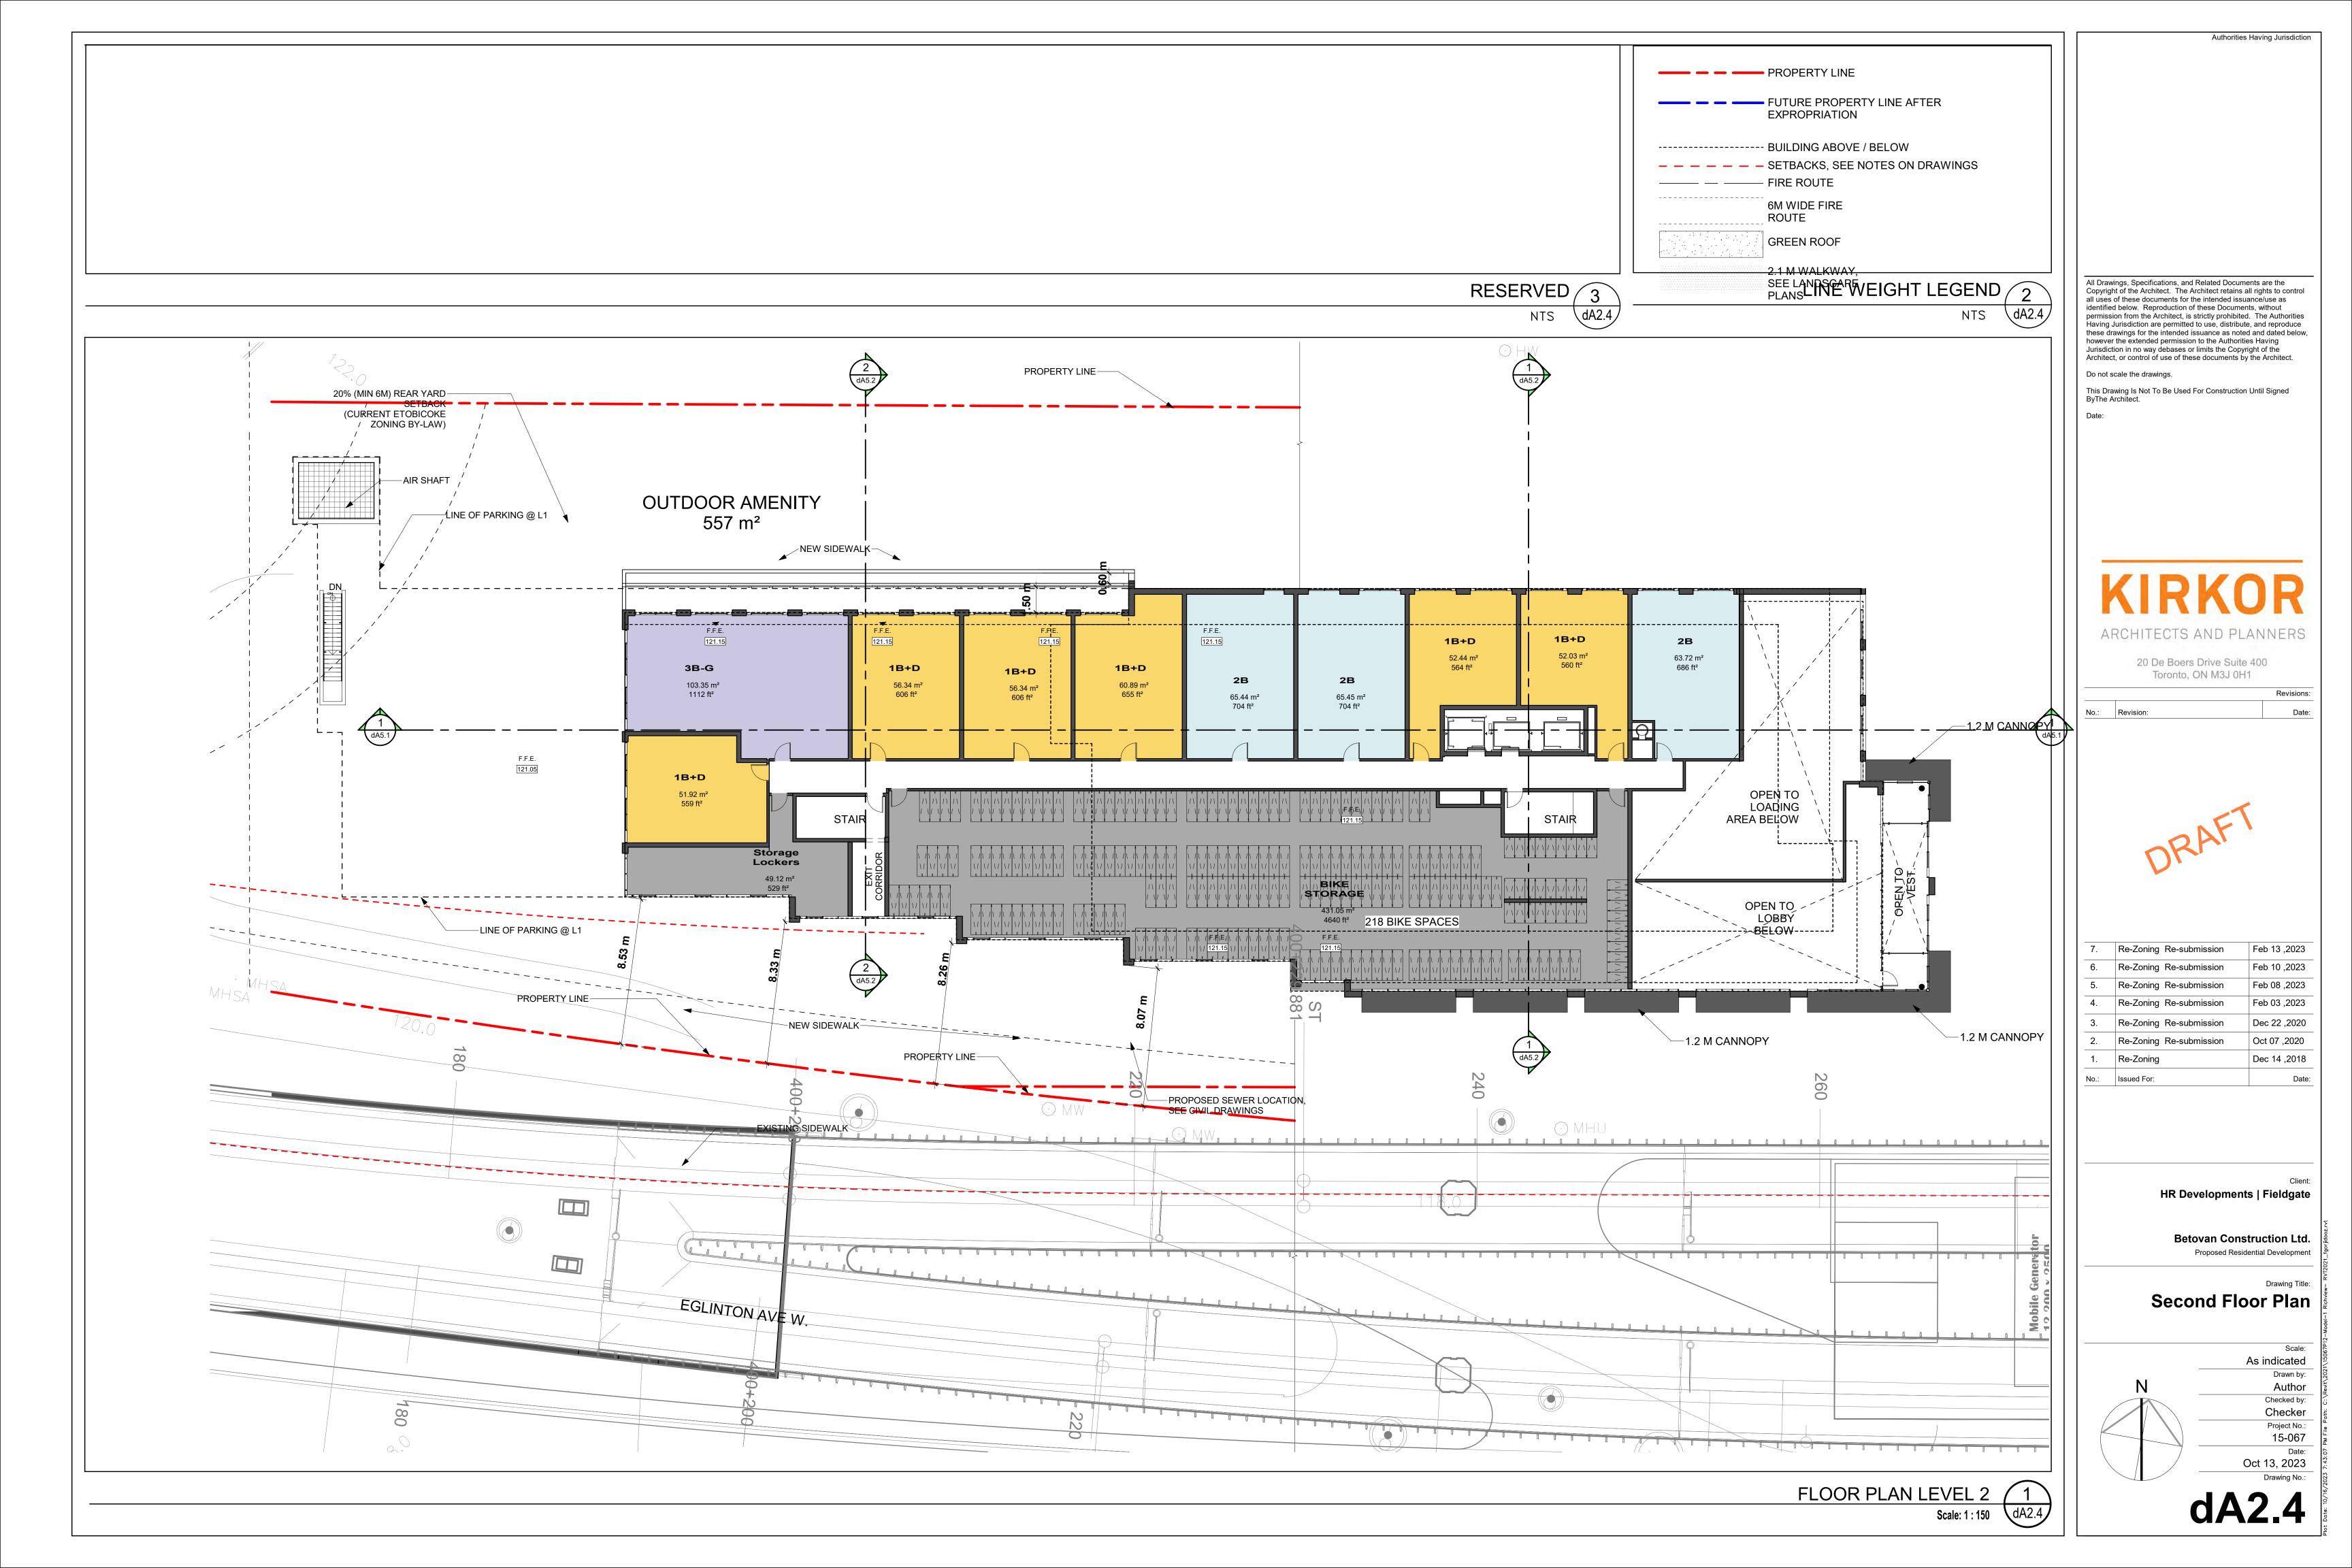



As indicated Author Checked by: Checker Project No.: 15-067 Date: Oct 13, 2023










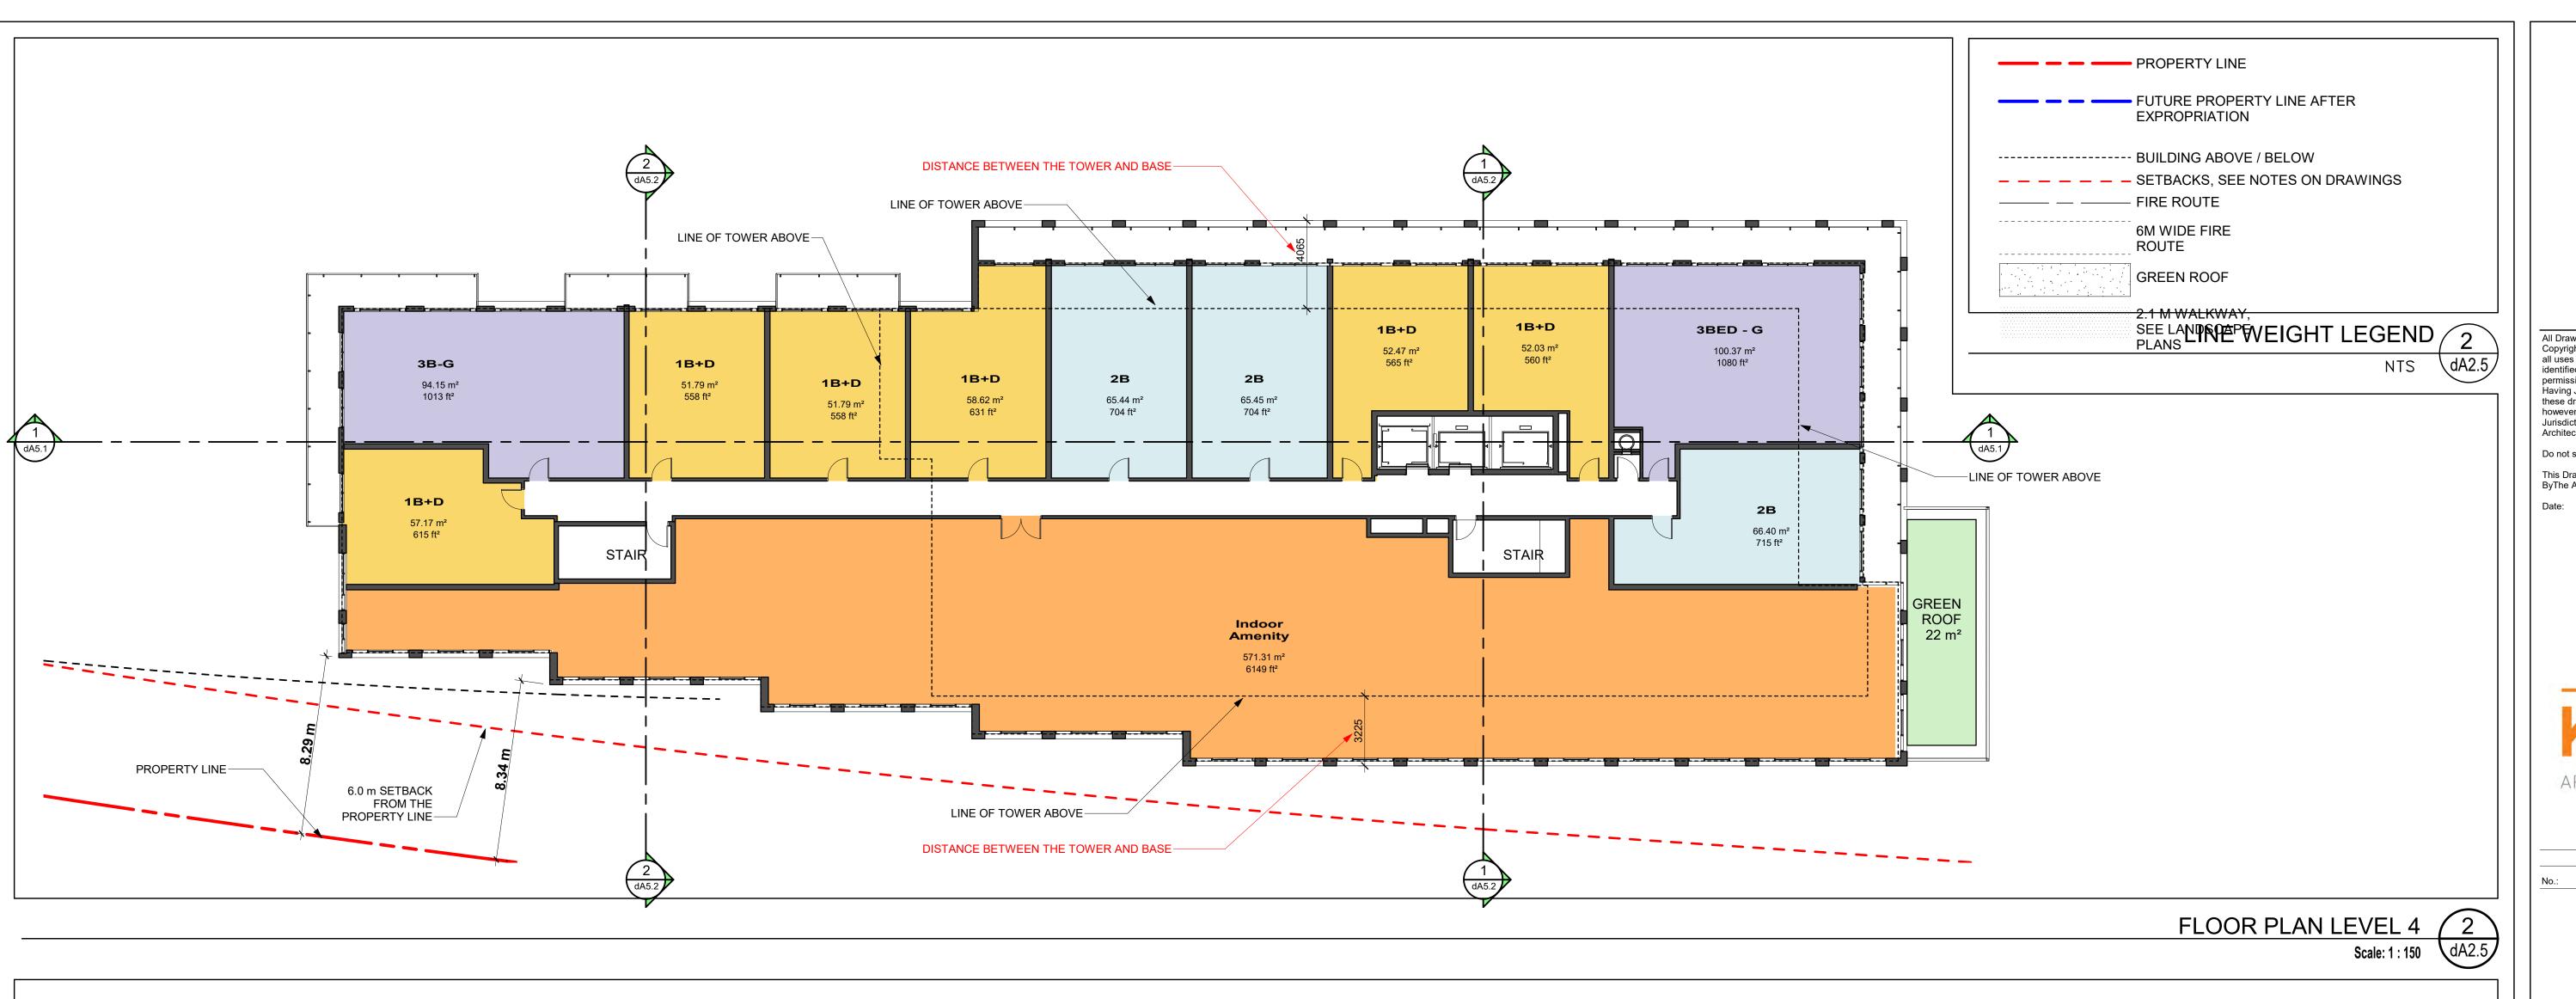

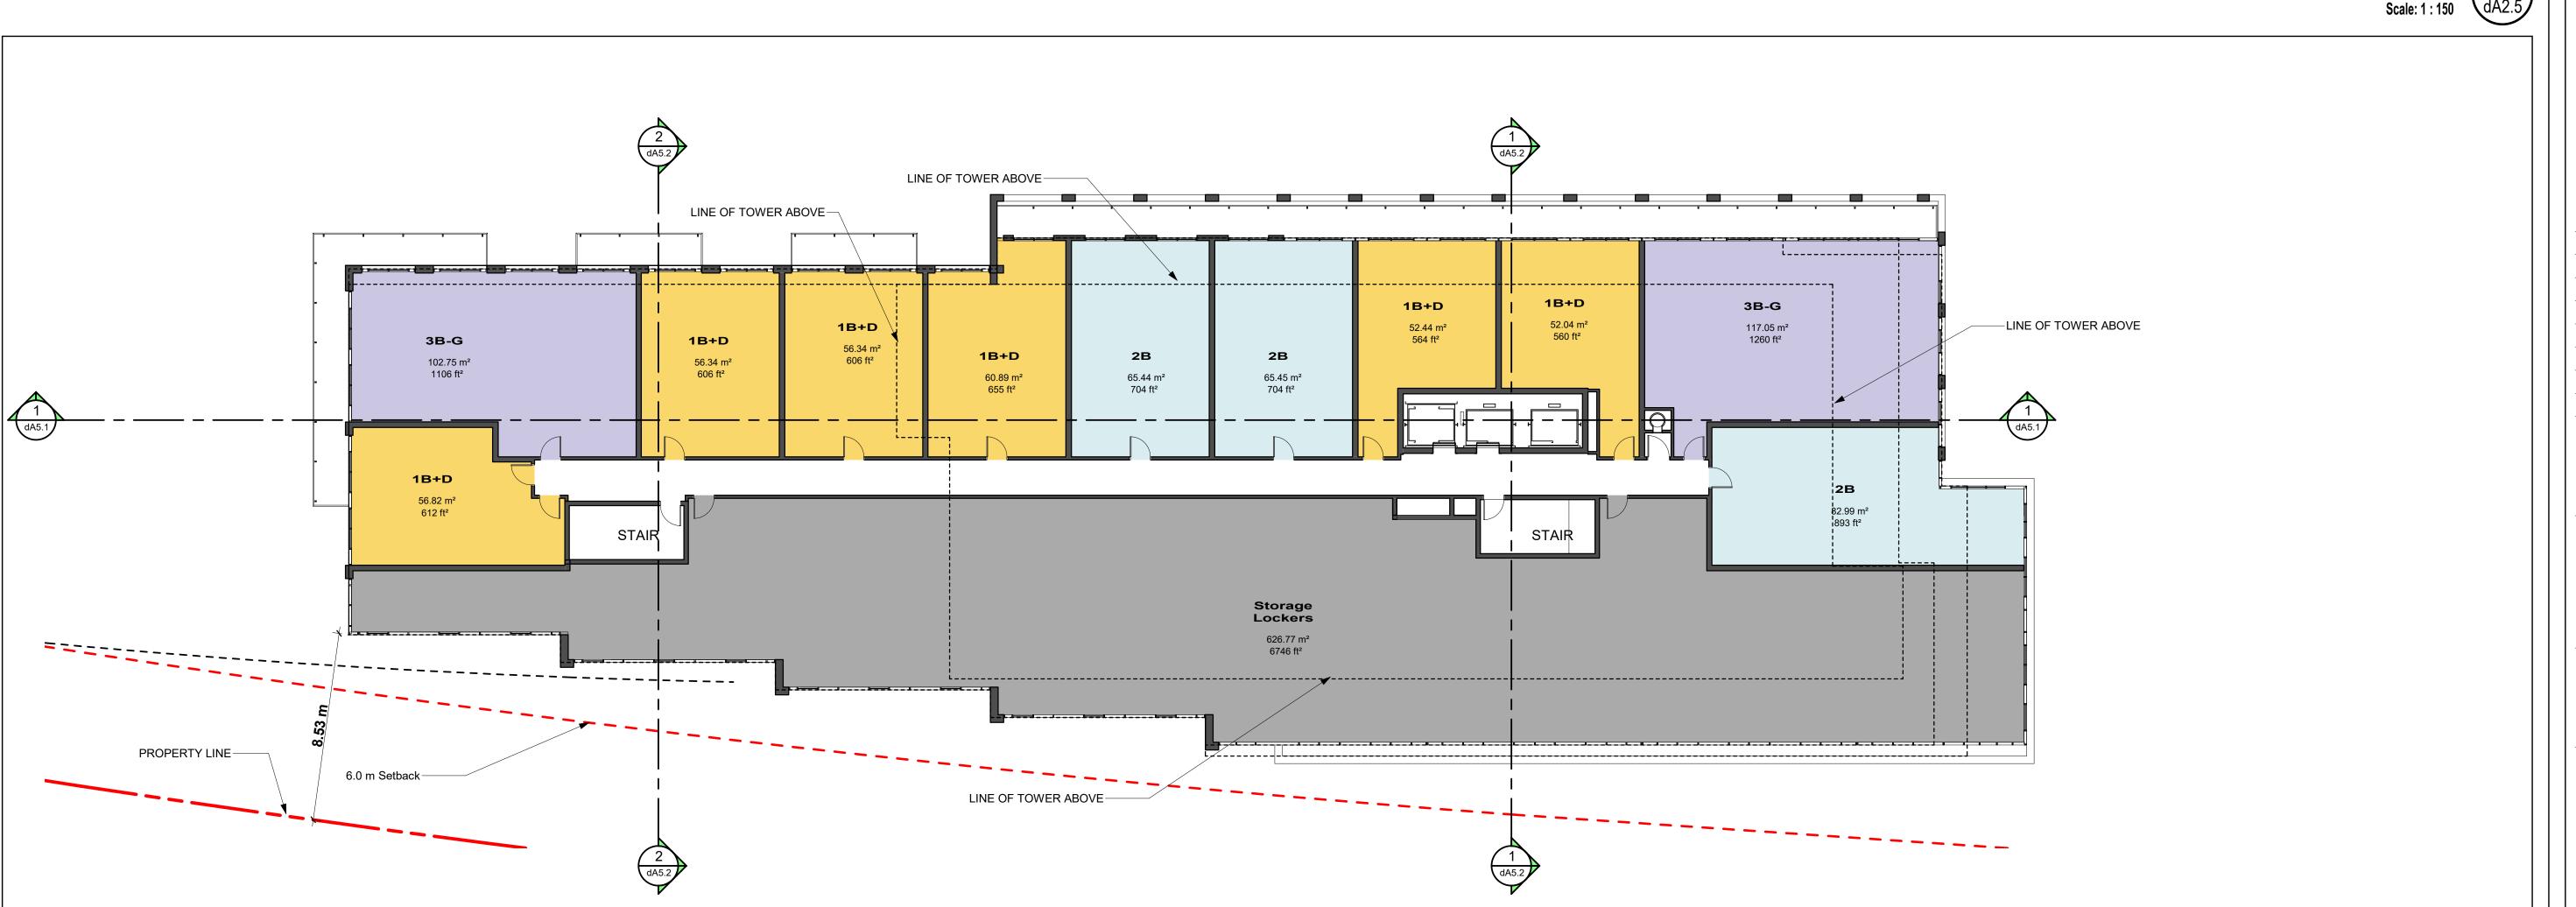

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Betovan Construction Ltd.

Proposed Residential Development

Floor Plans - Podium


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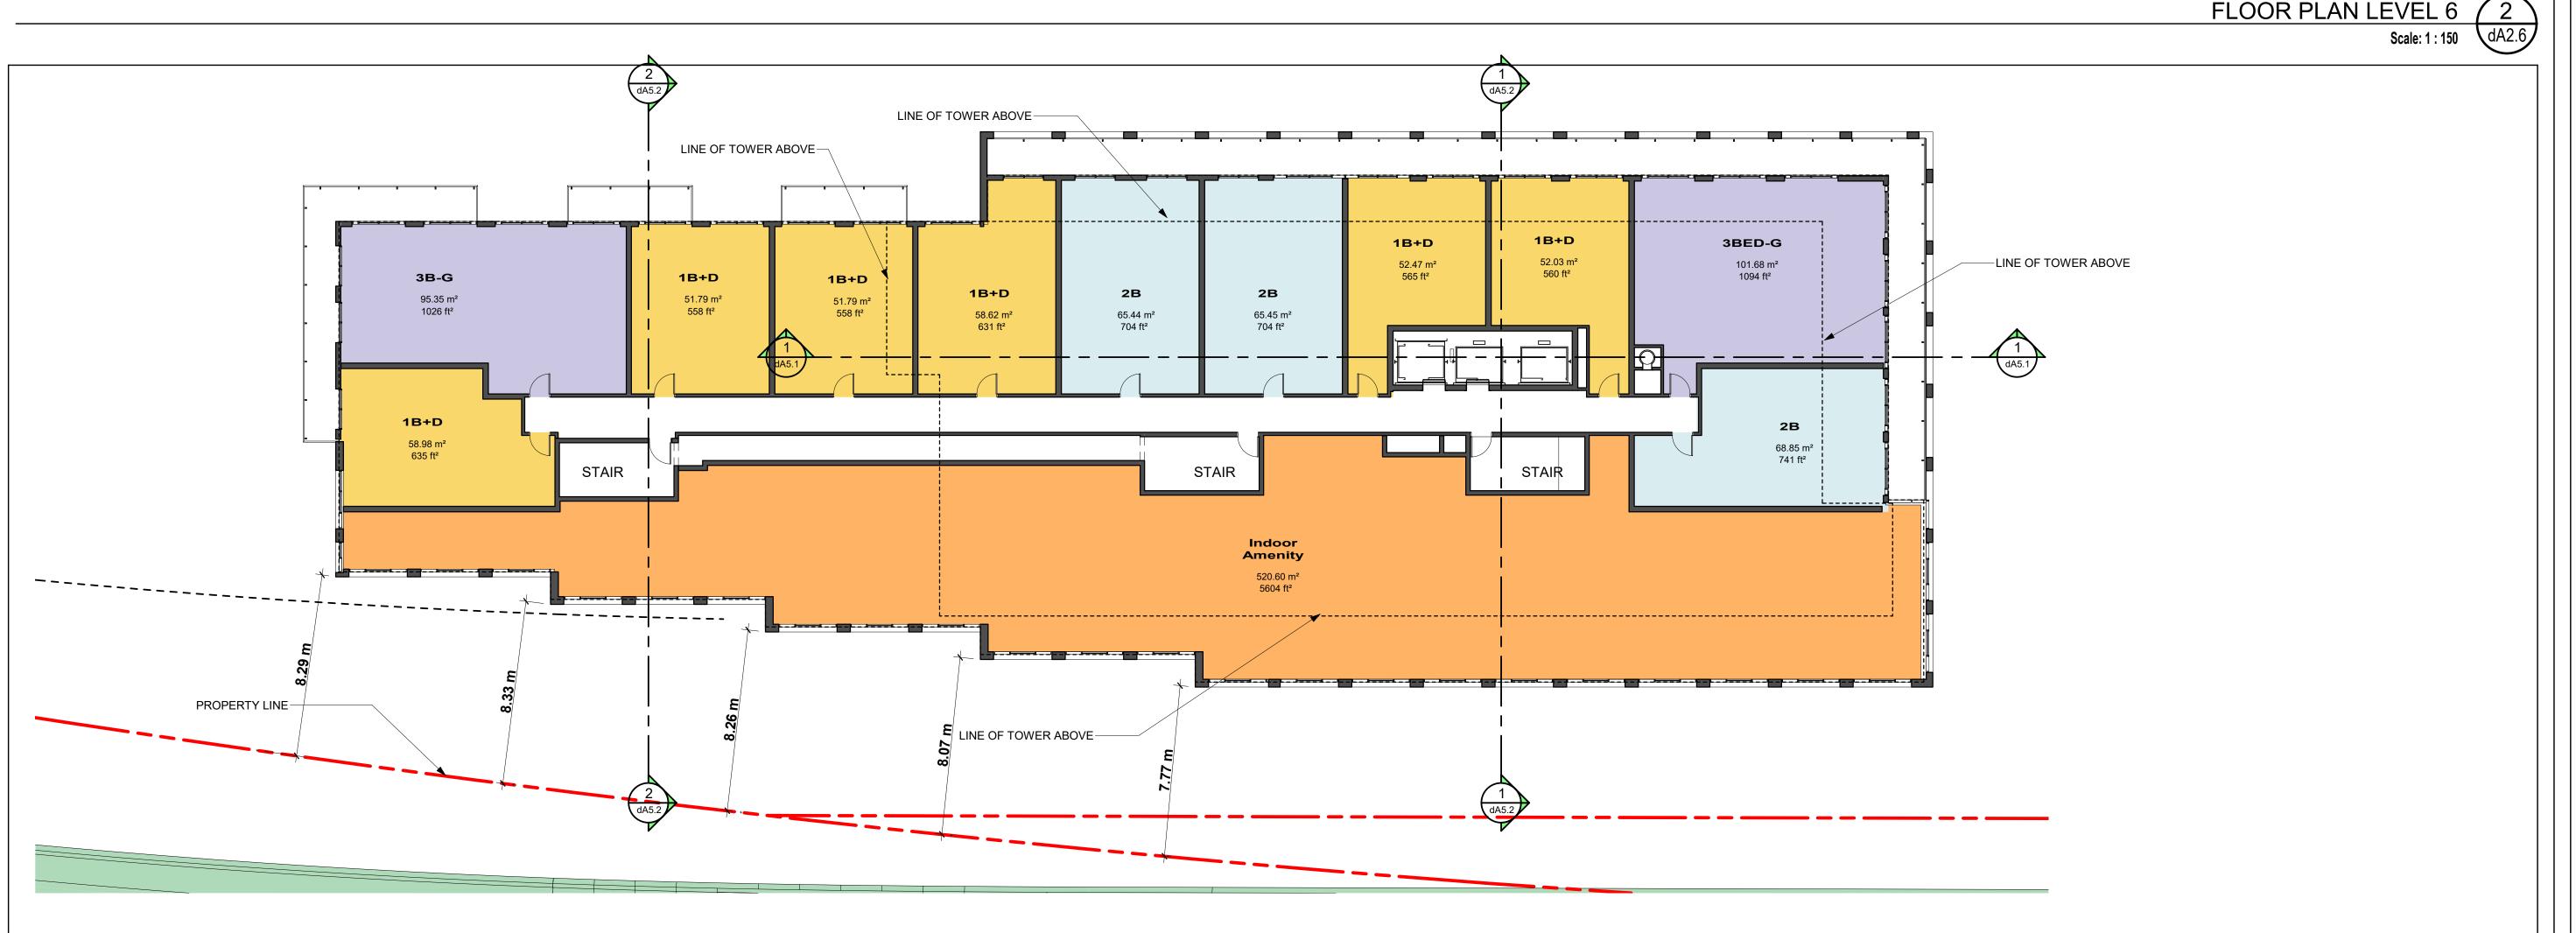
FLOOR PLAN LEVEL 3 1

As indicated

Drawn by:
Author
Checked by:
Checker
Project No.:
15-067
Date:
Oct 13, 2023

dA2.5



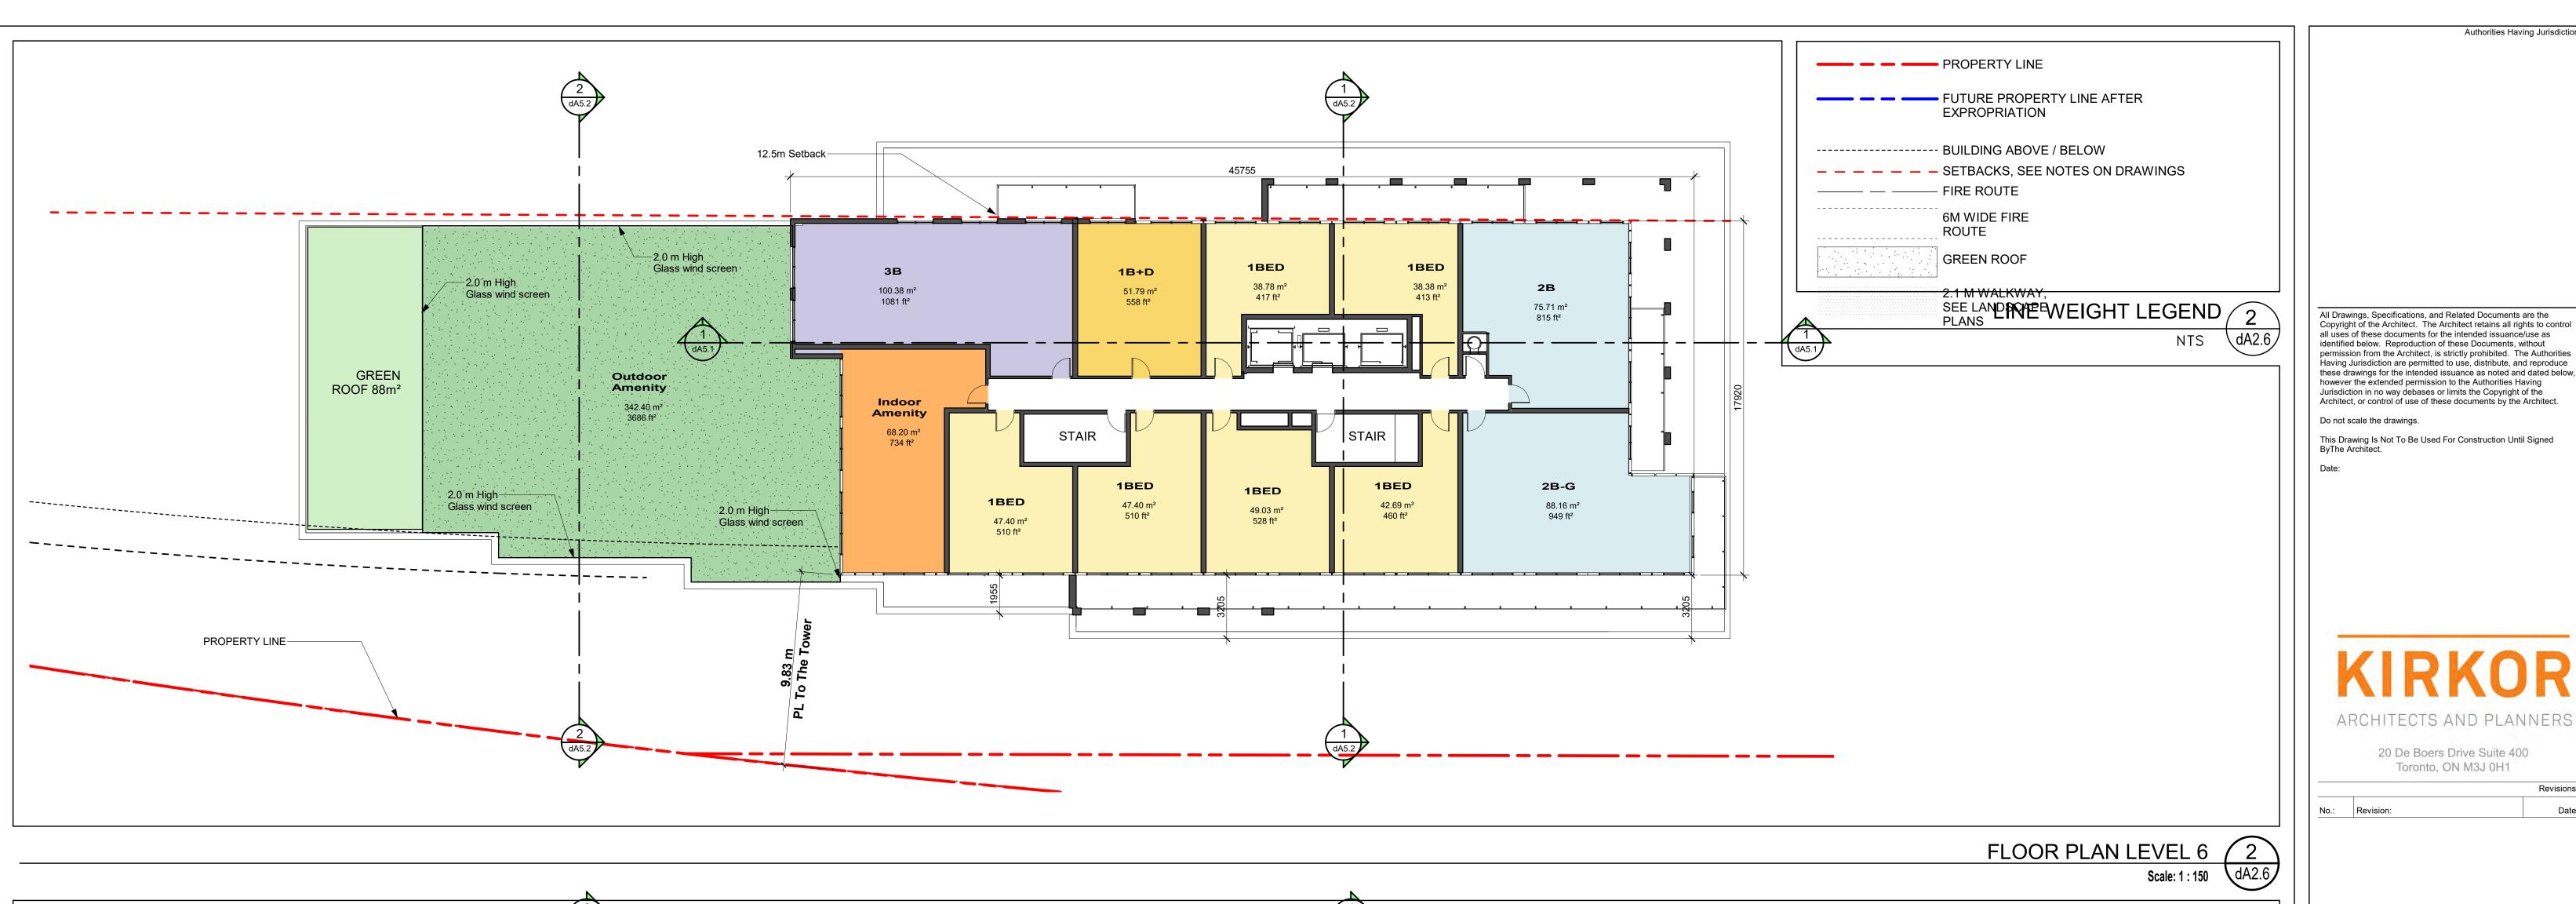

FLOOR PLAN LEVEL 5 1
Scale: 1:150 dA2.6

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| 2. | Re-Zoning Re-submission | Oct 07 ,2020 |
| 1. | Re-Zoning | Dec 14 ,2018 |
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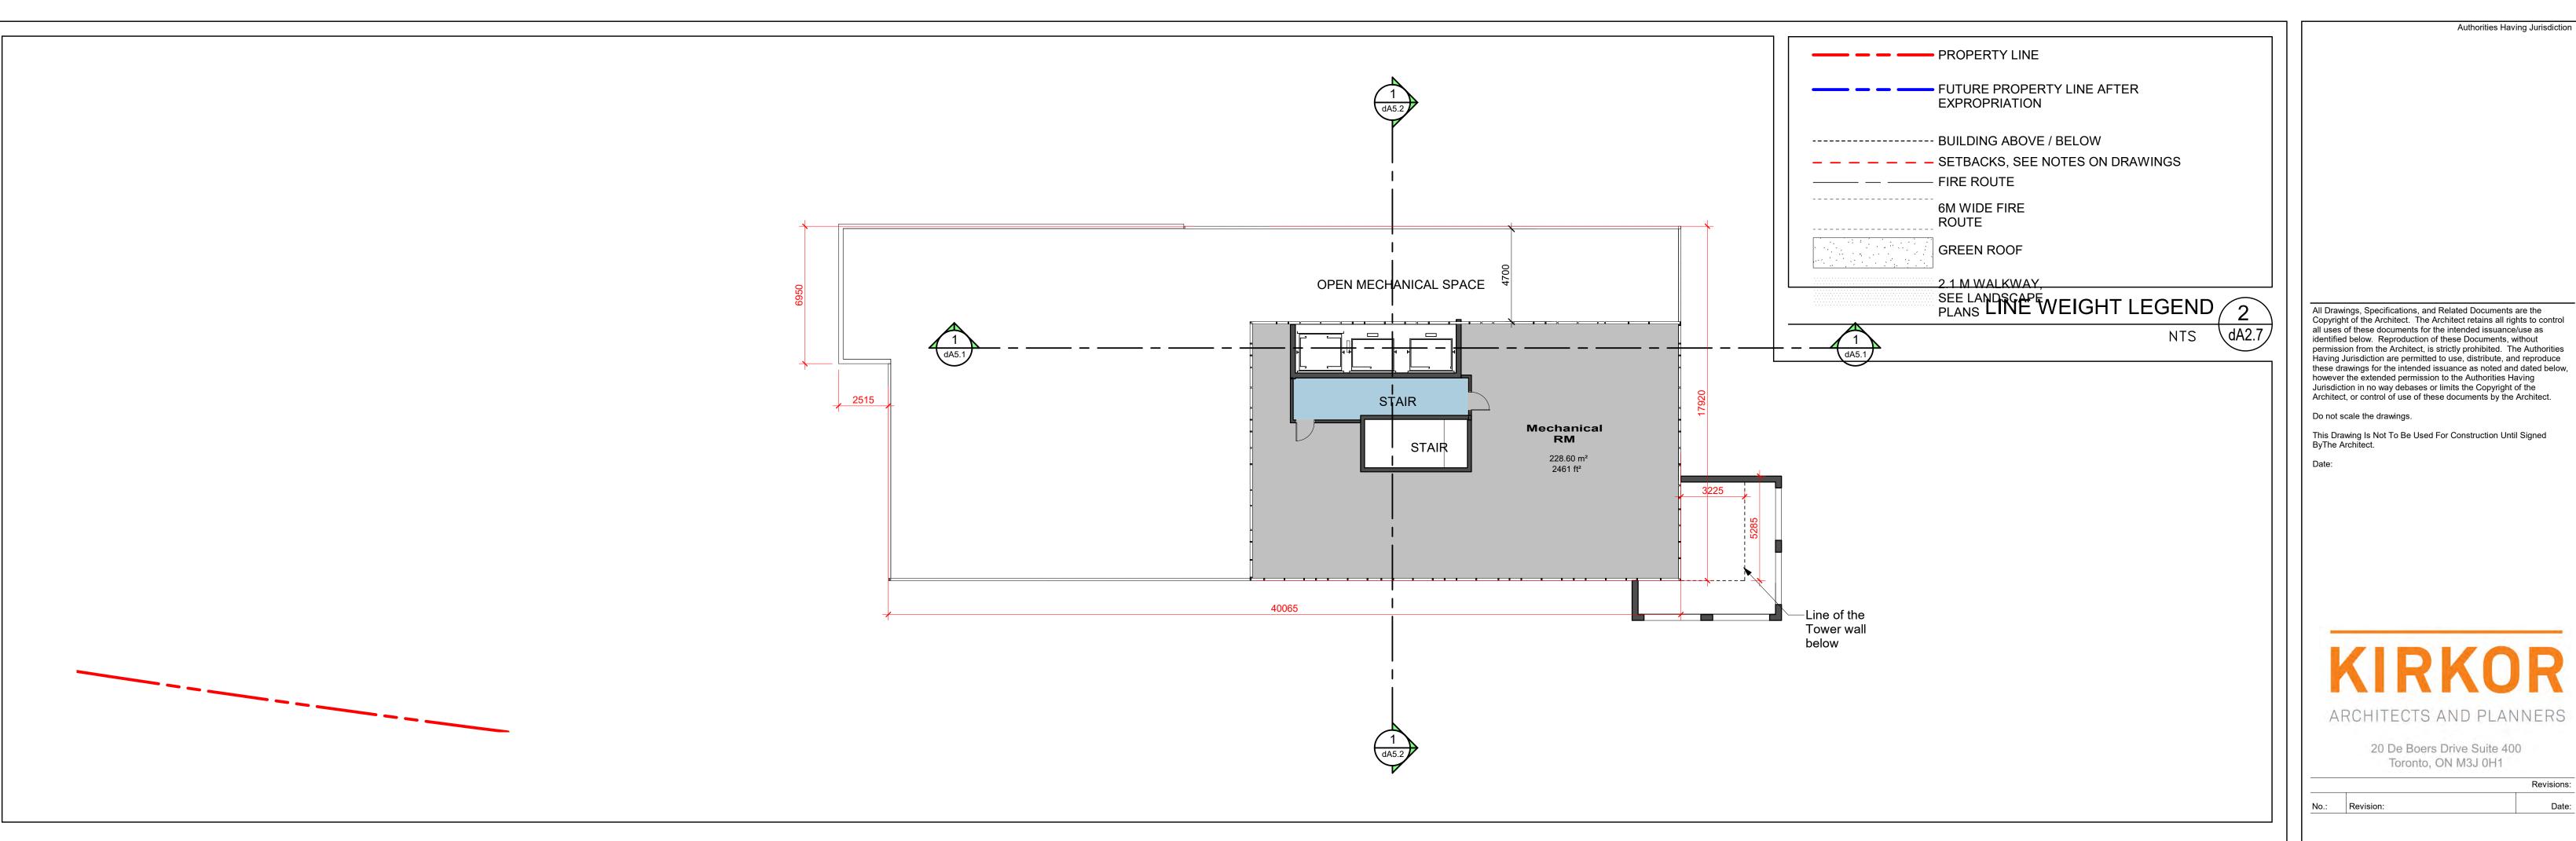
Betovan Construction Ltd. Proposed Residential Development

Floor Plans - Levels 5 and

Date: Oct 13, 2023

As indicated

Author Checked by: Checker Project No.: 15-067





FLOOR PLAN LEVEL 7-29 1 Scale: 1:150 dA2.7

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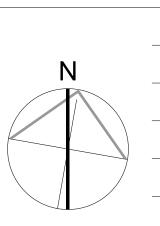
| 7. | Re-Zoning Re-submission | Feb 13 ,2023 |
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| 2. | Re-Zoning Re-submission | Oct 07 ,2020 |
| 1. | Re-Zoning | Dec 14 ,2018 |
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Betovan Construction Ltd.

Proposed Residential Development Drawing Title:

Floor Plans - Levels 7 - 29 and Roof



Checked by: Checker Project No.: 15-067 Date: Oct 13, 2023

As indicated

Author