



Interior -

GENERAL NOTES 1. All dimensions in millimetres (mm)

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LEGEND - PAVING

P.I.P Concrete - Natural 2

Pedestrian Strength As Per City Standards SRI: 35 Asphalt Paving SRI: <29

Unit Paving "Series" By Unilock Size: 400x200x70mm Colour: Mineral Ice SRI: 33


L-300

Existing Unit Paving As Per City Standards

√ (5)

LEGEND - LIGHTING

NOTE: All light specs to be dark sky compliant. Refer to Electrical Engineer for lighting specs.

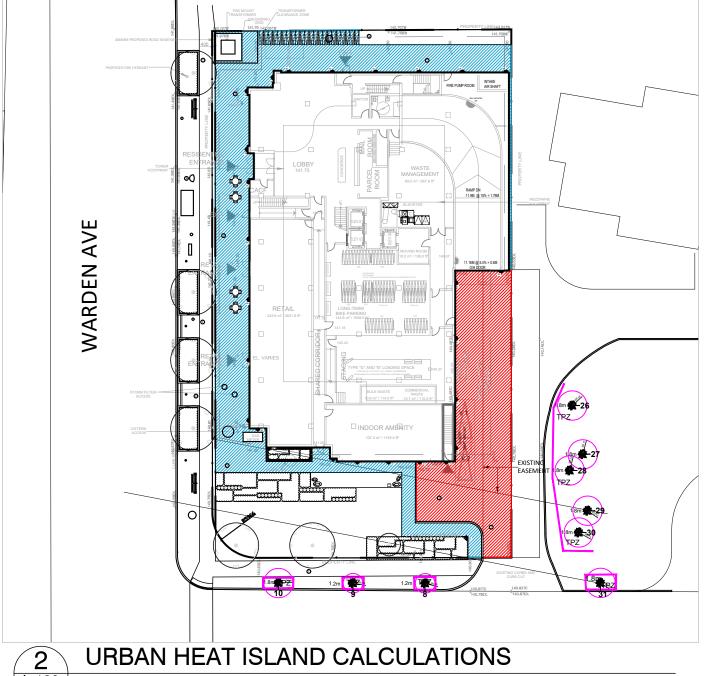

			_			
URBAN	HEAT ISLAND TREATMENT CALC		XIIII			
	AREA [m²]	AREA [%]				
Treated	503.4	62.2%	TREATED	UNTREATED		
Untreated	306.0	37.8%	(REFER TO PAVING LEGEND FOR EACH PAVING TYPE AND TREATMENT)			
Total	809.4	100.00%]			

TORONTO GREEN STANDARDS - NOTES AQ 3.4 PEDESTRIAN LIGHTING Pedestrian-scaled lighting to be provided for outdoor landscape areas through a

EC 1.4 Watering Program All tree planting (including street trees within • All exterior lighting shall comprise of Dark-Sky R.O.W.) to be irrigated by automatic drip irrigation system, fed from building cistern (non-potable water source). combination of building-mounted fixtures and • Irrigation system to be operated indefinitely for • All planting to be irrigated by automatic drip

EC 3.2 Invasive Species

No invasive species shall be planted.

Irrigation system, fed from building cistern stormwater reuse. EC 3.1 Native and Pollinator Supportive Species • Irrigation system to be operated indefinitely for Minimum of 50% non-roof hardscape to be
 50% of planting (by individual plant count) to stormwater reuse. be native species or selections of native

(non-potable water source). EC 4.3 Grate Porosity Any ground level grates, intakes and exhaust

EC 5.1 Exterior Lighting

WQ 4.1 Drought-Tolerant Landscapes

x 20mm or 40mm x 10mm

shafts will have a maximum porosity of 20mm

with a minimum caliper of 70mm. The Owner shall ensure that each tree will have the burlap and wire cage opened and soil brushed away until the first proper root is found indicating the top of the real root crown. The Owner shall ensure that the tree is then planted with this level (real root crown), to be considered the top of root-ball as per the Urban Forestry planting details and any/all other instructions. The Owner acknowledges and agrees that any tree found planted with the first proper root more than 2.5cm below planting level will be rejected and require replacement or replanting at the discretion of the General Manager of Parks, Forestry and Recreation".

the tree planting process

P-RE-546-01

The Owner/applicant acknowledges and agrees that the planting areas of the site and the street allowance to be de-compacted, as preparation for planting, by excavating 100-120cm (or the depth of the proposed soil volume calculation) of the existing soil, scarify the open faces and bottom, and replace with new top soil, (City standard soil requirements) prior to tree planting. The Owner shall further provide proof (photos) of the planting preparation process indicating all stages in accordance with the approved Site Plan, Landscape Plan, Planting Details and Toronto Standard Details, and any other plans which are connected with

The Owner/applicant acknowledges and agrees that all trees must be planted as per the

plans, approved by Urban Forestry and must arrive on site in Balled and Burlapped condition,

APR.16.2024 REISSUED FOR SPA SEPT.09.2022 ISSUED FOR SPA


REV DATE DESCRIPTION

GROUND FLOOR LANDSCAPE PLAN

CHECKED BY: JW

TORONTO, ON

BLACK TUSK GROUP

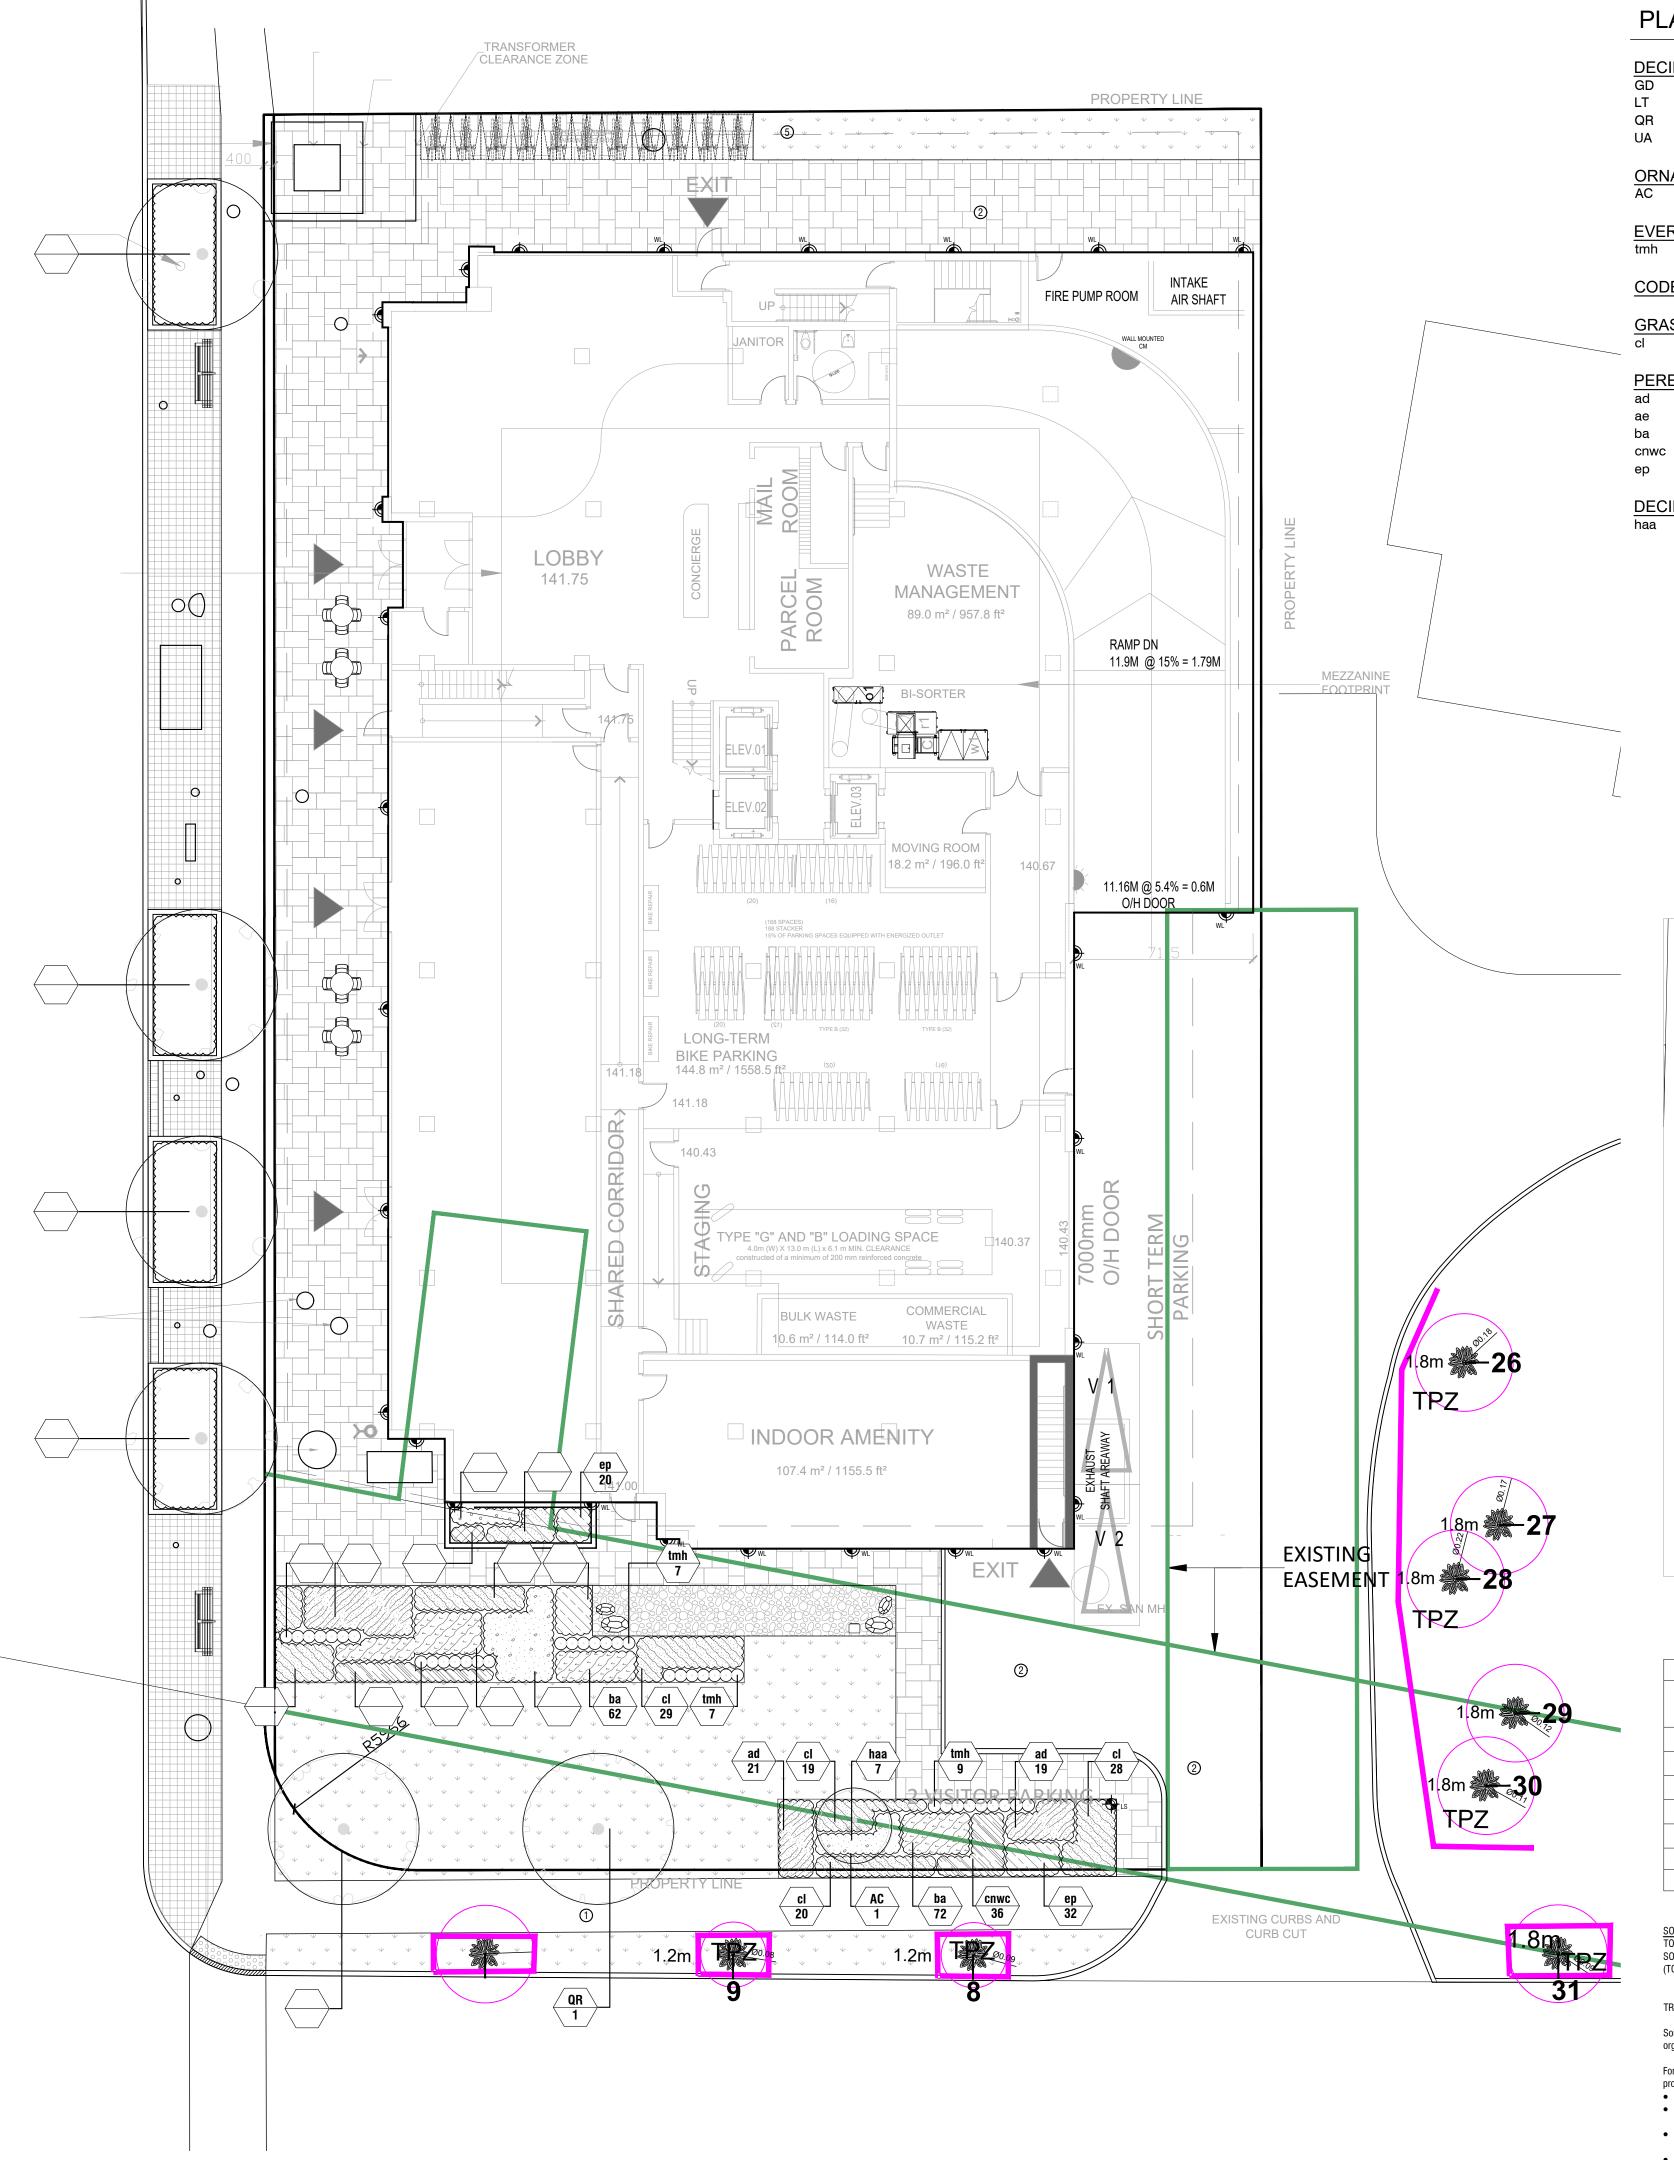

PLANT SCHEDULE

DECIDUOUS TREES GD _T QR JA	QTY 2 1 1 2	BOTANICAL NAME Gymnocladus dioica Liriodendron tulipifera Quercus rubra Ulmus americana 'Valley Forge'	COMMON NAME Kentucky Coffee Tree Tulip Poplar Red Oak Valley Forge American Elm	CONT W.B. W.B W.B. W.B.	CAL 70mm Cal. 70mm Cal. 70mm Cal. 70mm Cal.	NATIVE Native Native Native Native	DROUGHT Native Native Native Yes	
ORNAMENTAL TREES	QTY 1	BOTANICAL NAME Amelanchier canadensis	COMMON NAME Canadian Serviceberry	CONT W.B.	SIZE 2000mm Ht.	NATIVE Native	DROUGHT Yes	
EVERGREEN SHRUBS	<u>QTY</u> 37	BOTANICAL NAME Taxus x media 'Hicksii'	COMMON NAME Hicks Anglo-Japanese Yew	CONT Potted	SIZE 500mm Ht.	NATIVE	DROUGHT	
CODE	<u>QTY</u>	BOTANICAL NAME	COMMON NAME	CONT	SIZE	<u>NATIVE</u>	DROUGHT	
GRASSES cl	<u>QTY</u> 158	BOTANICAL NAME Chasmanthium latifolium	COMMON NAME Northern Sea Oats	CONT 1 gal. potted	SIZE 2 yr. growth	NATIVE Native	DROUGHT Yes	
PERENNIALS ad ae ba coa conwo	QTY 80 9 249 68 83	BOTANICAL NAME Aster divaricatus Aster ericoides Baptisia australis Calamintha nepeta 'White Cloud' Echinacea purpurea	COMMON NAME White Wood Aster Heath Aster Blue Wild Indigo White Cloud Lesser Calamint Coneflower	CONT 1 gal. potted	SIZE 2 yr. growth	NATIVE Native Native Native Native	DROUGHT Yes Yes Yes Yes Yes Yes	
DECIDUOUS SHRUBS	<u>QTY</u> 25	BOTANICAL NAME Hydrangea arborescens 'Annabelle'	COMMON NAME Annabelle Hydrangea	CONT Potted	SIZE 400mm Ht.	<u>NATIVE</u>	DROUGHT	



Architect -Civil Eng -Mech Eng -Interior -

GENERAL NOTES

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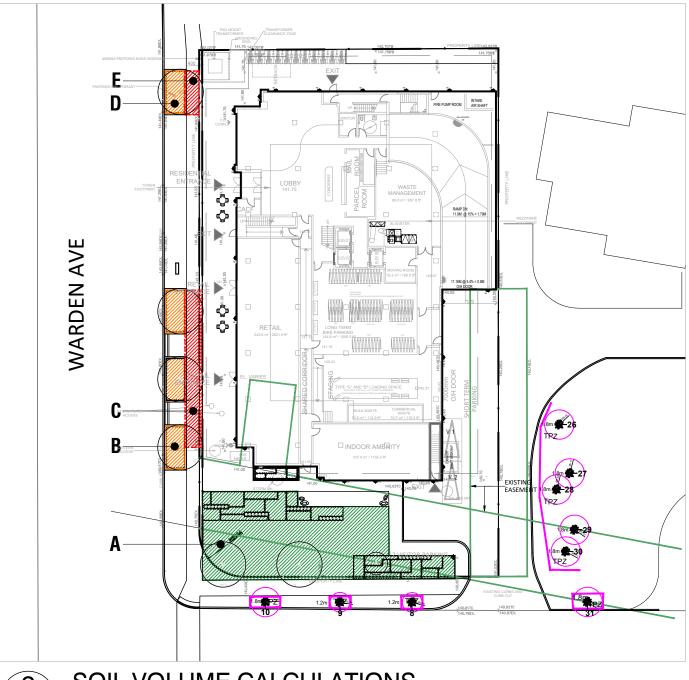
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SOIL VOLUME CALCULATIONS

LEGEND - SOIL VOLUME CALCULATIONS SOIL VOLUME CALCULATIONS

	SOIL ZONE	ON/OFF SLAB	AREA (m²)	DEPTH (m)	VOLUME (m³)	# OF TREES	SOIL VOLUME PER TREE (m³)
4	Open Planting Bed	OFF	290.7	1.5	436.1	2	218.0
3	Open Planting Bed	OFF	42.3	1.4	59.2	3	76.7
)	Soil Cells	OFF	47.8	1.1	52.6		
)	Open Planting Bed	OFF	14.0	1.4	19.6	1	31.5
=	Soil Cells	OFF	10.8	1.1	11.9		
	TOTAL PROVIDED				579.3	6	
	TOTAL REQUIRED				500.3		

1.5m Depth

Soil Cells 1.1m Depth

P-RE-546-06

Open Planting Bed

SOIL VOLUME REQUIREMENTS:
TOTAL SITE AREA: 2751.8m² SOIL VOLUME REQUIRED: 500.3m³ (TOTAL SITE AREA ÷ 66m² x 40% x 30m³)

*Existing trees not included in Soil Volume Calculations

TREE PLANTING NOTES:

P-RE-546-03

Soil for all tree planting shall conform to the following the City standard: a sandy loam texture profile (with 50-60% sand, 20-40% silt, and 6-10% clay, 2-5% organic matter by dry weight, and a maximum pH of 7.5.

For landscaped open space areas over any underground structure, including parking structures, where tree planting is proposed, cross sections will be

- provided at S.P.A. showing indicating the following: • minimum of 1200 mm between the top of the structure and the final grade at the base of the tree is required.
- this 1200 mm includes any protective board over waterproofing membranes, any insulation that would be required in the case of a heated structure below, an engineered drainage layer and the specified soil; • the soil specifications are: a minimum of 600 mm of sandy loam soil, comprising of 50 to 60% sand, 20 to 40% silt, 6 to 10% clay, 2 to 5% organic
- the sandy loam soil must be topped with a minimum 300 mm of minimum 2 year old woodchip mulch. The first lift of mulch must be dug-in with the sandy loam soil;
- each tree requires a minimum of 30 m₃ of soil/tree. It is recommended that the 30 m₃ of soil for each tree is contiguous in order for the trees to share the soil volume for their mutual benefit.

The Owner/applicant acknowledges and agrees that all trees must be planted as per the plans, approved by Urban Forestry and must arrive on site in Balled and Burlapped condition, with a minimum caliper of 70mm. The Owner shall ensure that each tree will have the burlap and wire cage opened and soil brushed away until the first proper root is found indicating the top of the real root crown. The Owner shall ensure that the tree is then planted with this level (real root crown), to be considered the top of root-ball as per the Urban Forestry planting details and any/all other instructions. The Owner acknowledges and agrees that any tree found planted with the first proper root more than 2.5cm below planting level will be rejected and require replacement or replanting at the discretion of the General Manager of Parks, Forestry and Recreation".

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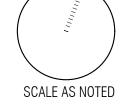
PLANTING PLAN



DRAWN BY: VB

CHECKED BY: JVV

PRINT DATE: Apr.16.2024



INITIAL





Architect -Civil Eng -Mech Eng -Interior -

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DESCRIPTION

SCALE AS NOTED

INITIAL

GRADING COORDINATION PLAN

DRAWN BY: VB
CHECKED BY: JVV
PRINT DATE: Apr.16.2024

L-102

673 WARDEN
TORONTO, ON
BLACK TUSK GROUP




P-RE-546-04

NOT FOR CONSTRUCTION. For review and coordination purposes

NOTE:

only. Refer to Grading Plans prepared by Civil Engineering.

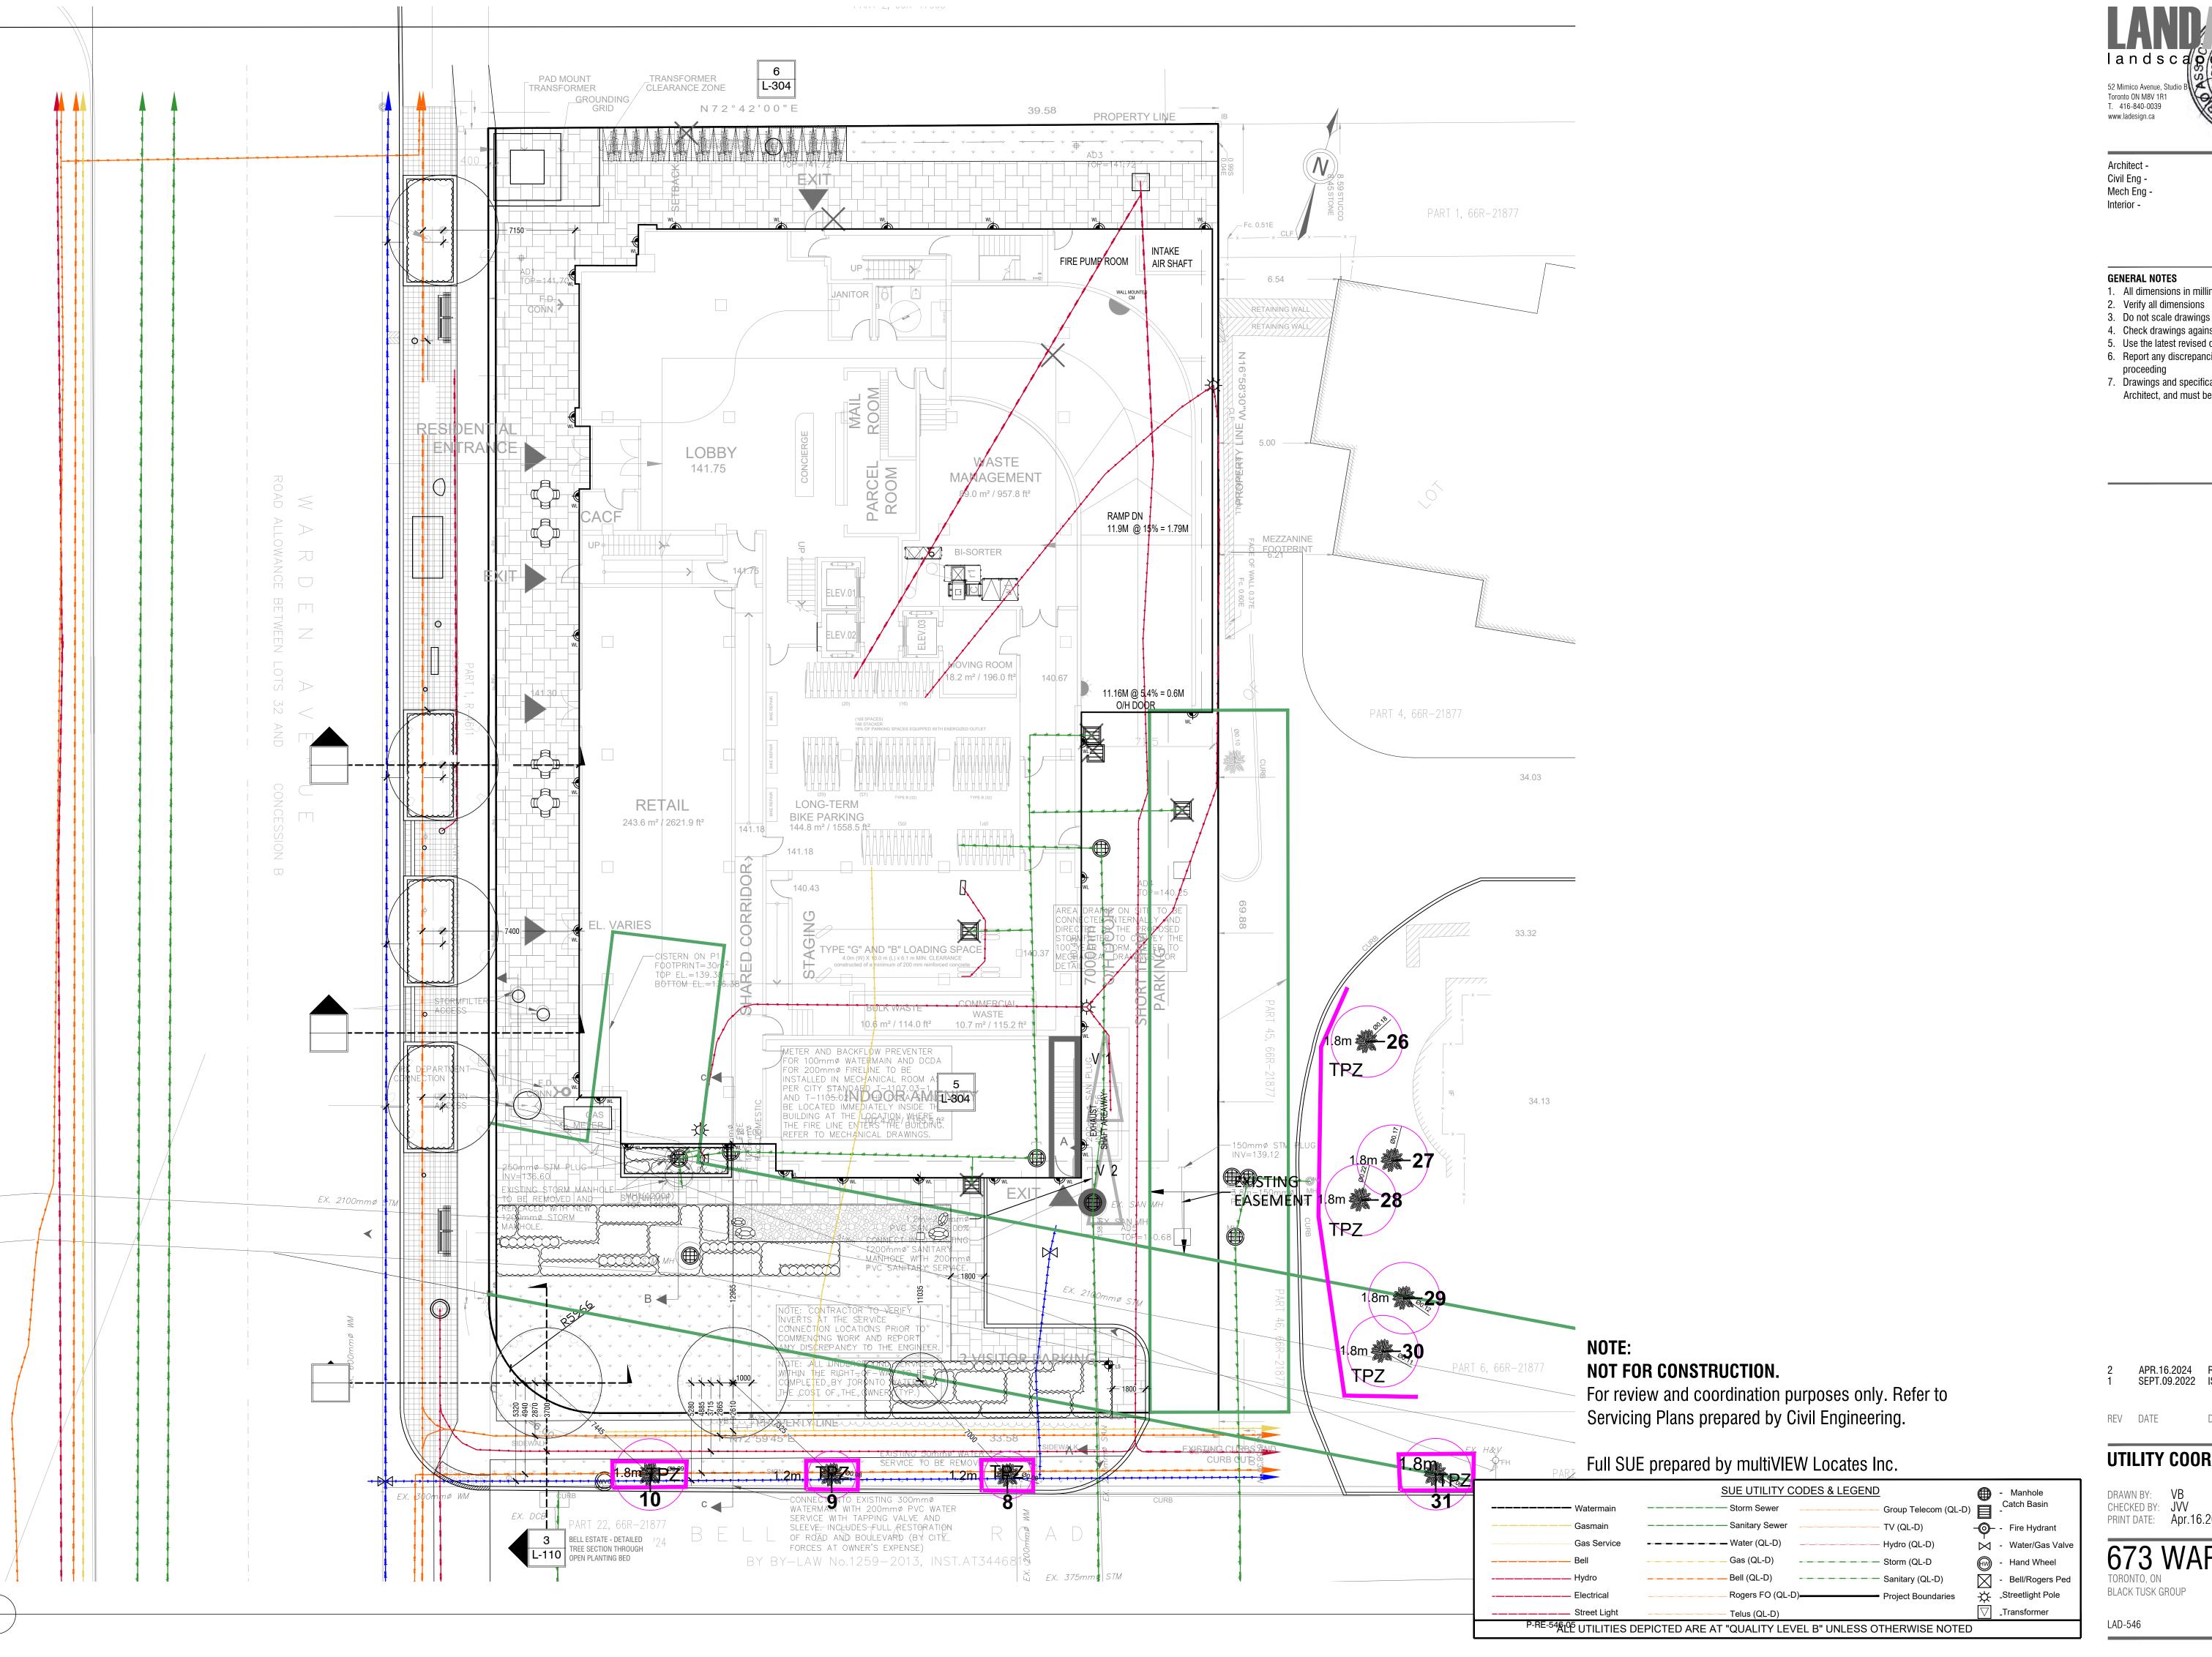



Civil Eng -Mech Eng -

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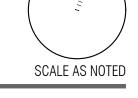
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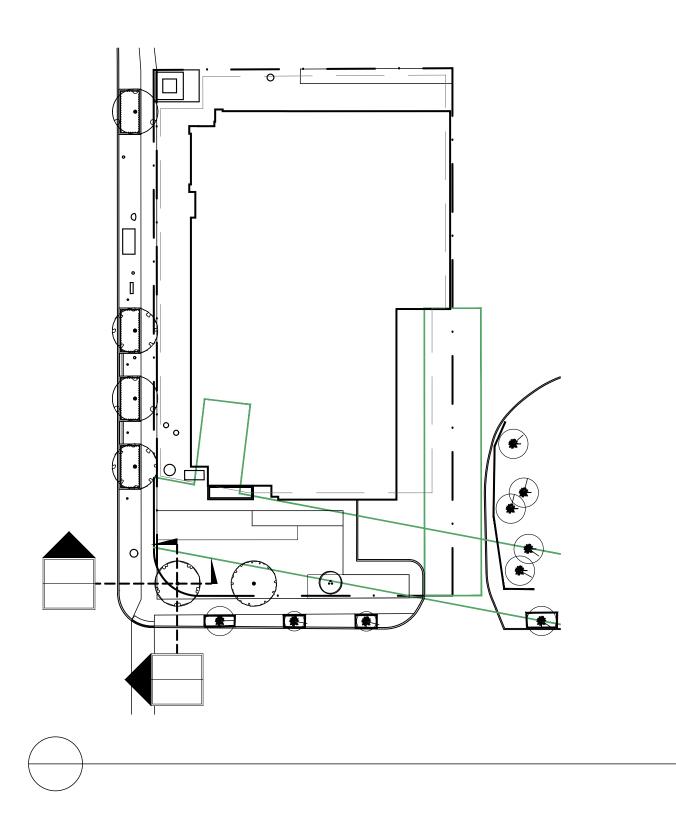
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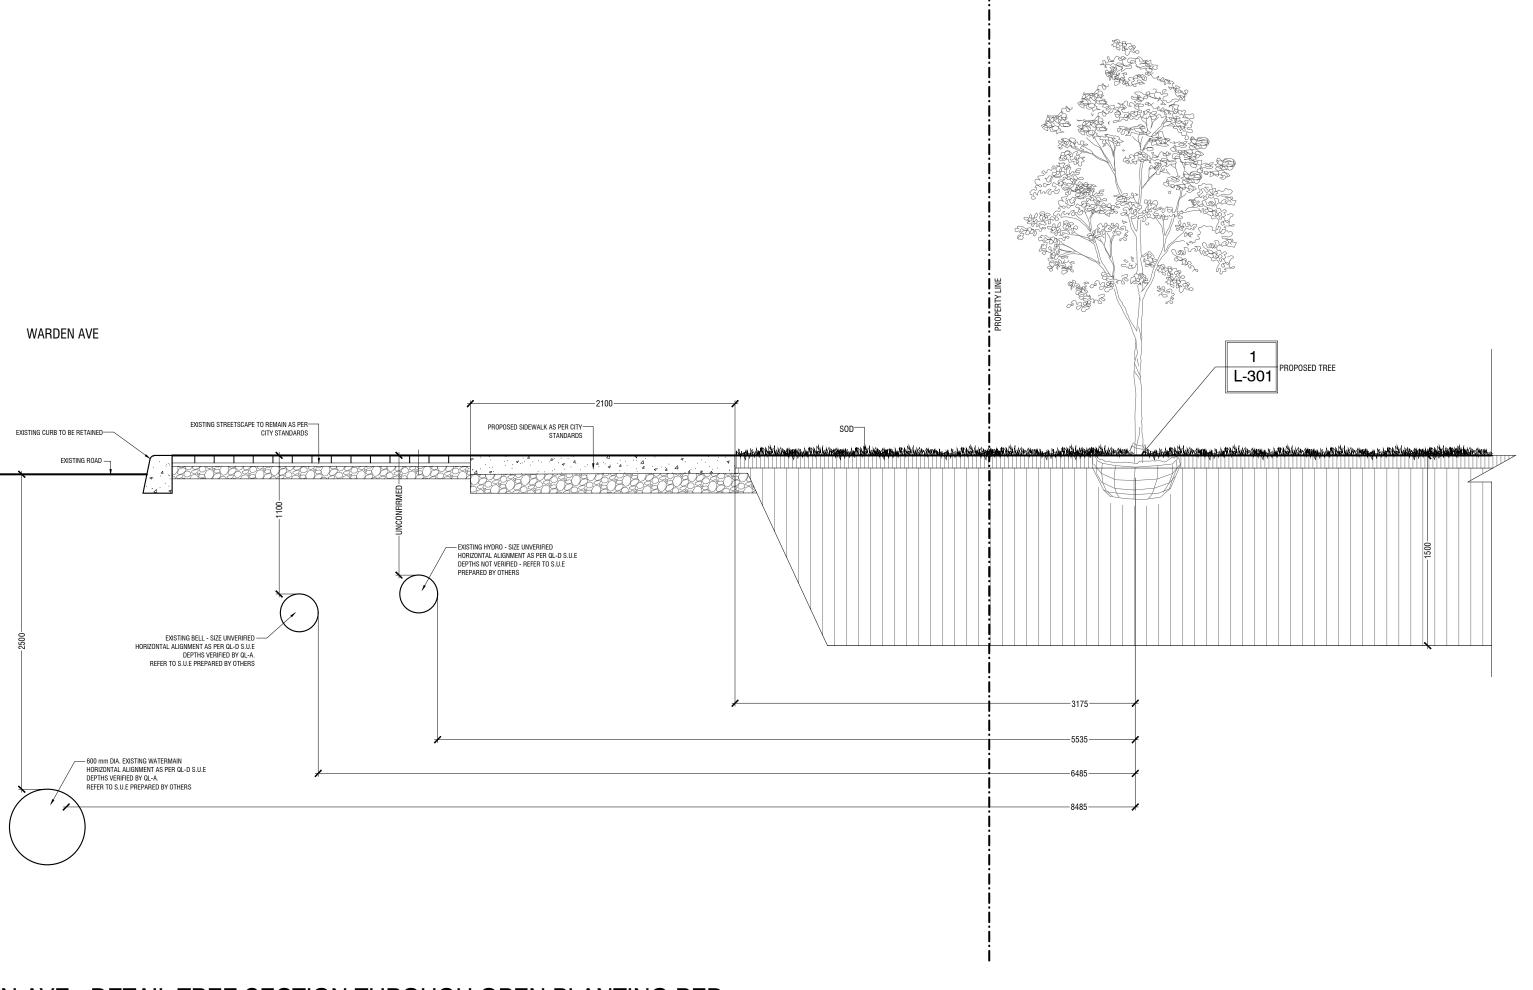
UTILITY COORDINATION PLAN


DRAWN BY: VB
CHECKED BY: JVV
PRINT DATE: Apr.16.2024

673 WARDEN







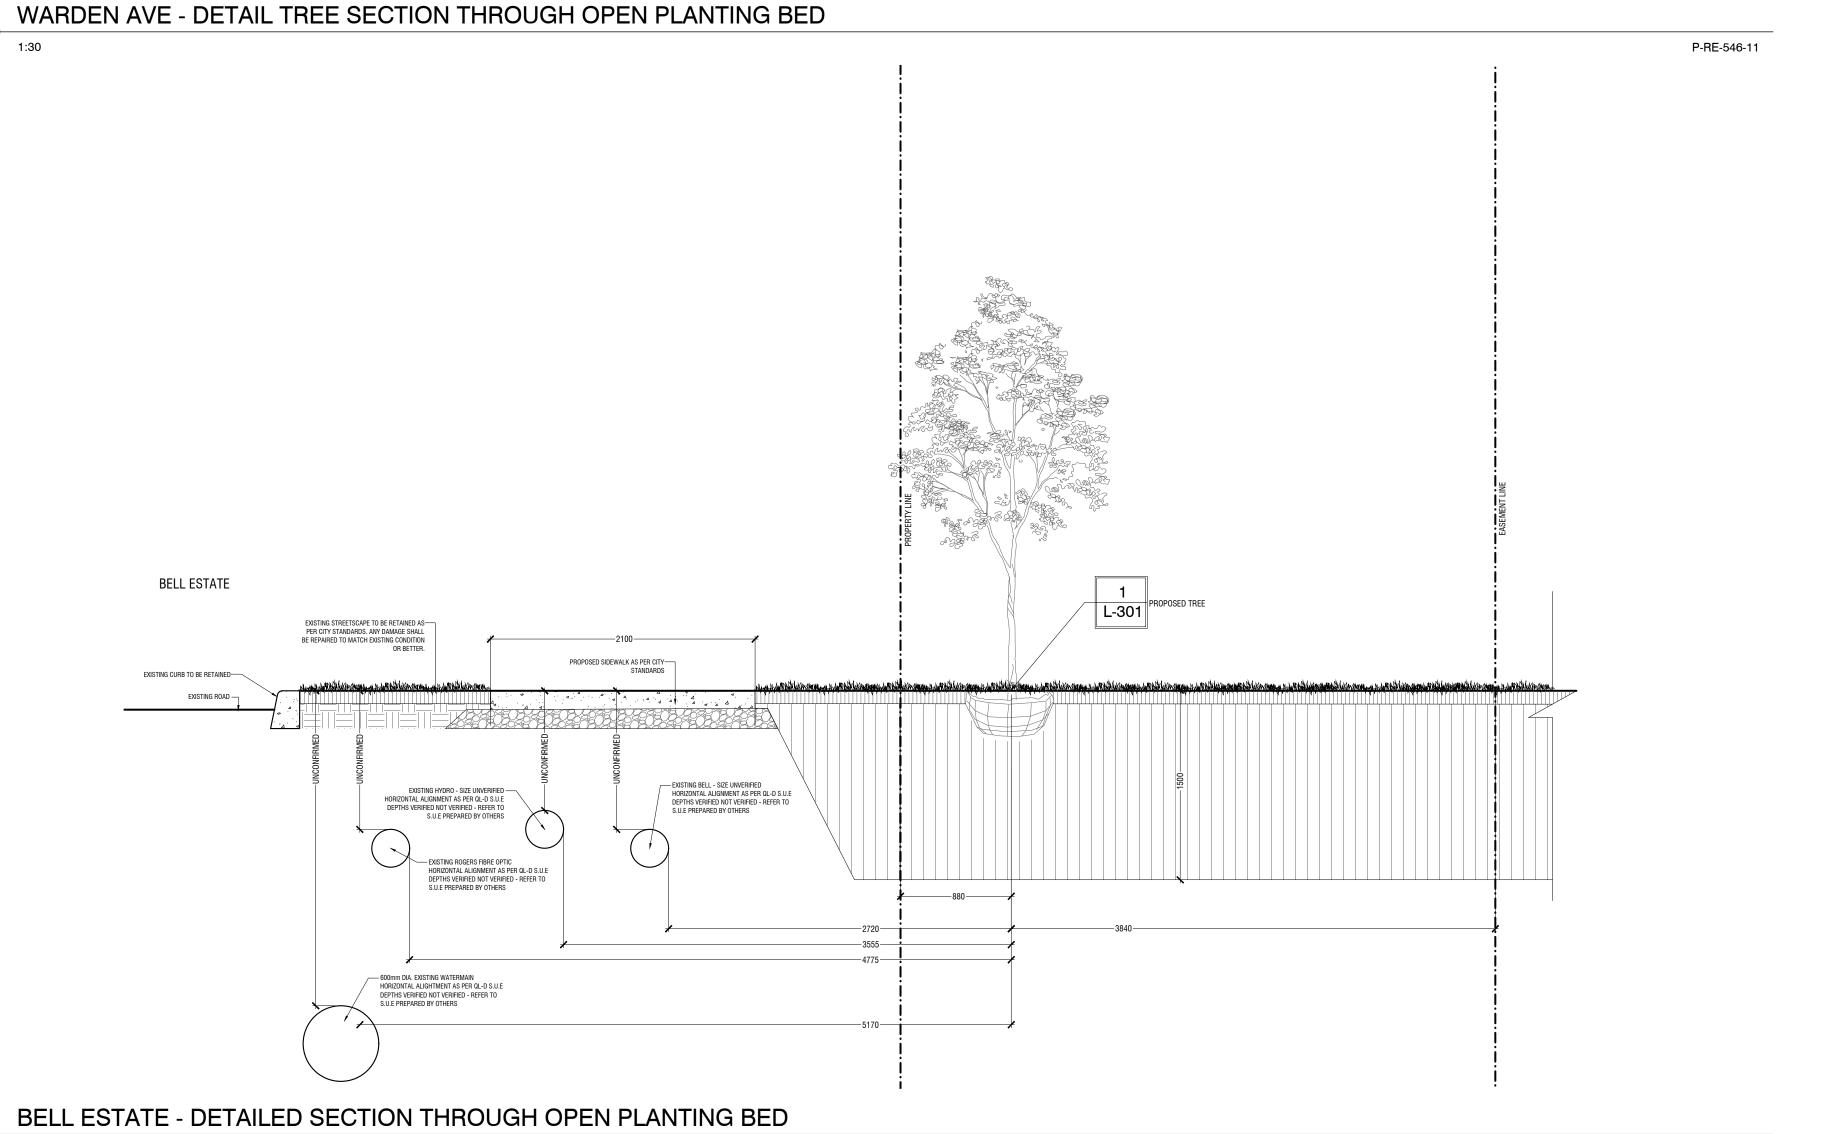



Architect -Civil Eng -Mech Eng -Interior -

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2 APR.16.2024 REISSUED FOR SPA 1 SEPT.09.2022 ISSUED FOR SPA

REV DATE DESCRIPTION

INITIAL

BELL ESTATE DETAILED TREE SECTIONS


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PRINT DATE: Apr.16.2024

L-11(

673 WARDEN

BLACK TUSK GROUP

P-RE-546-12

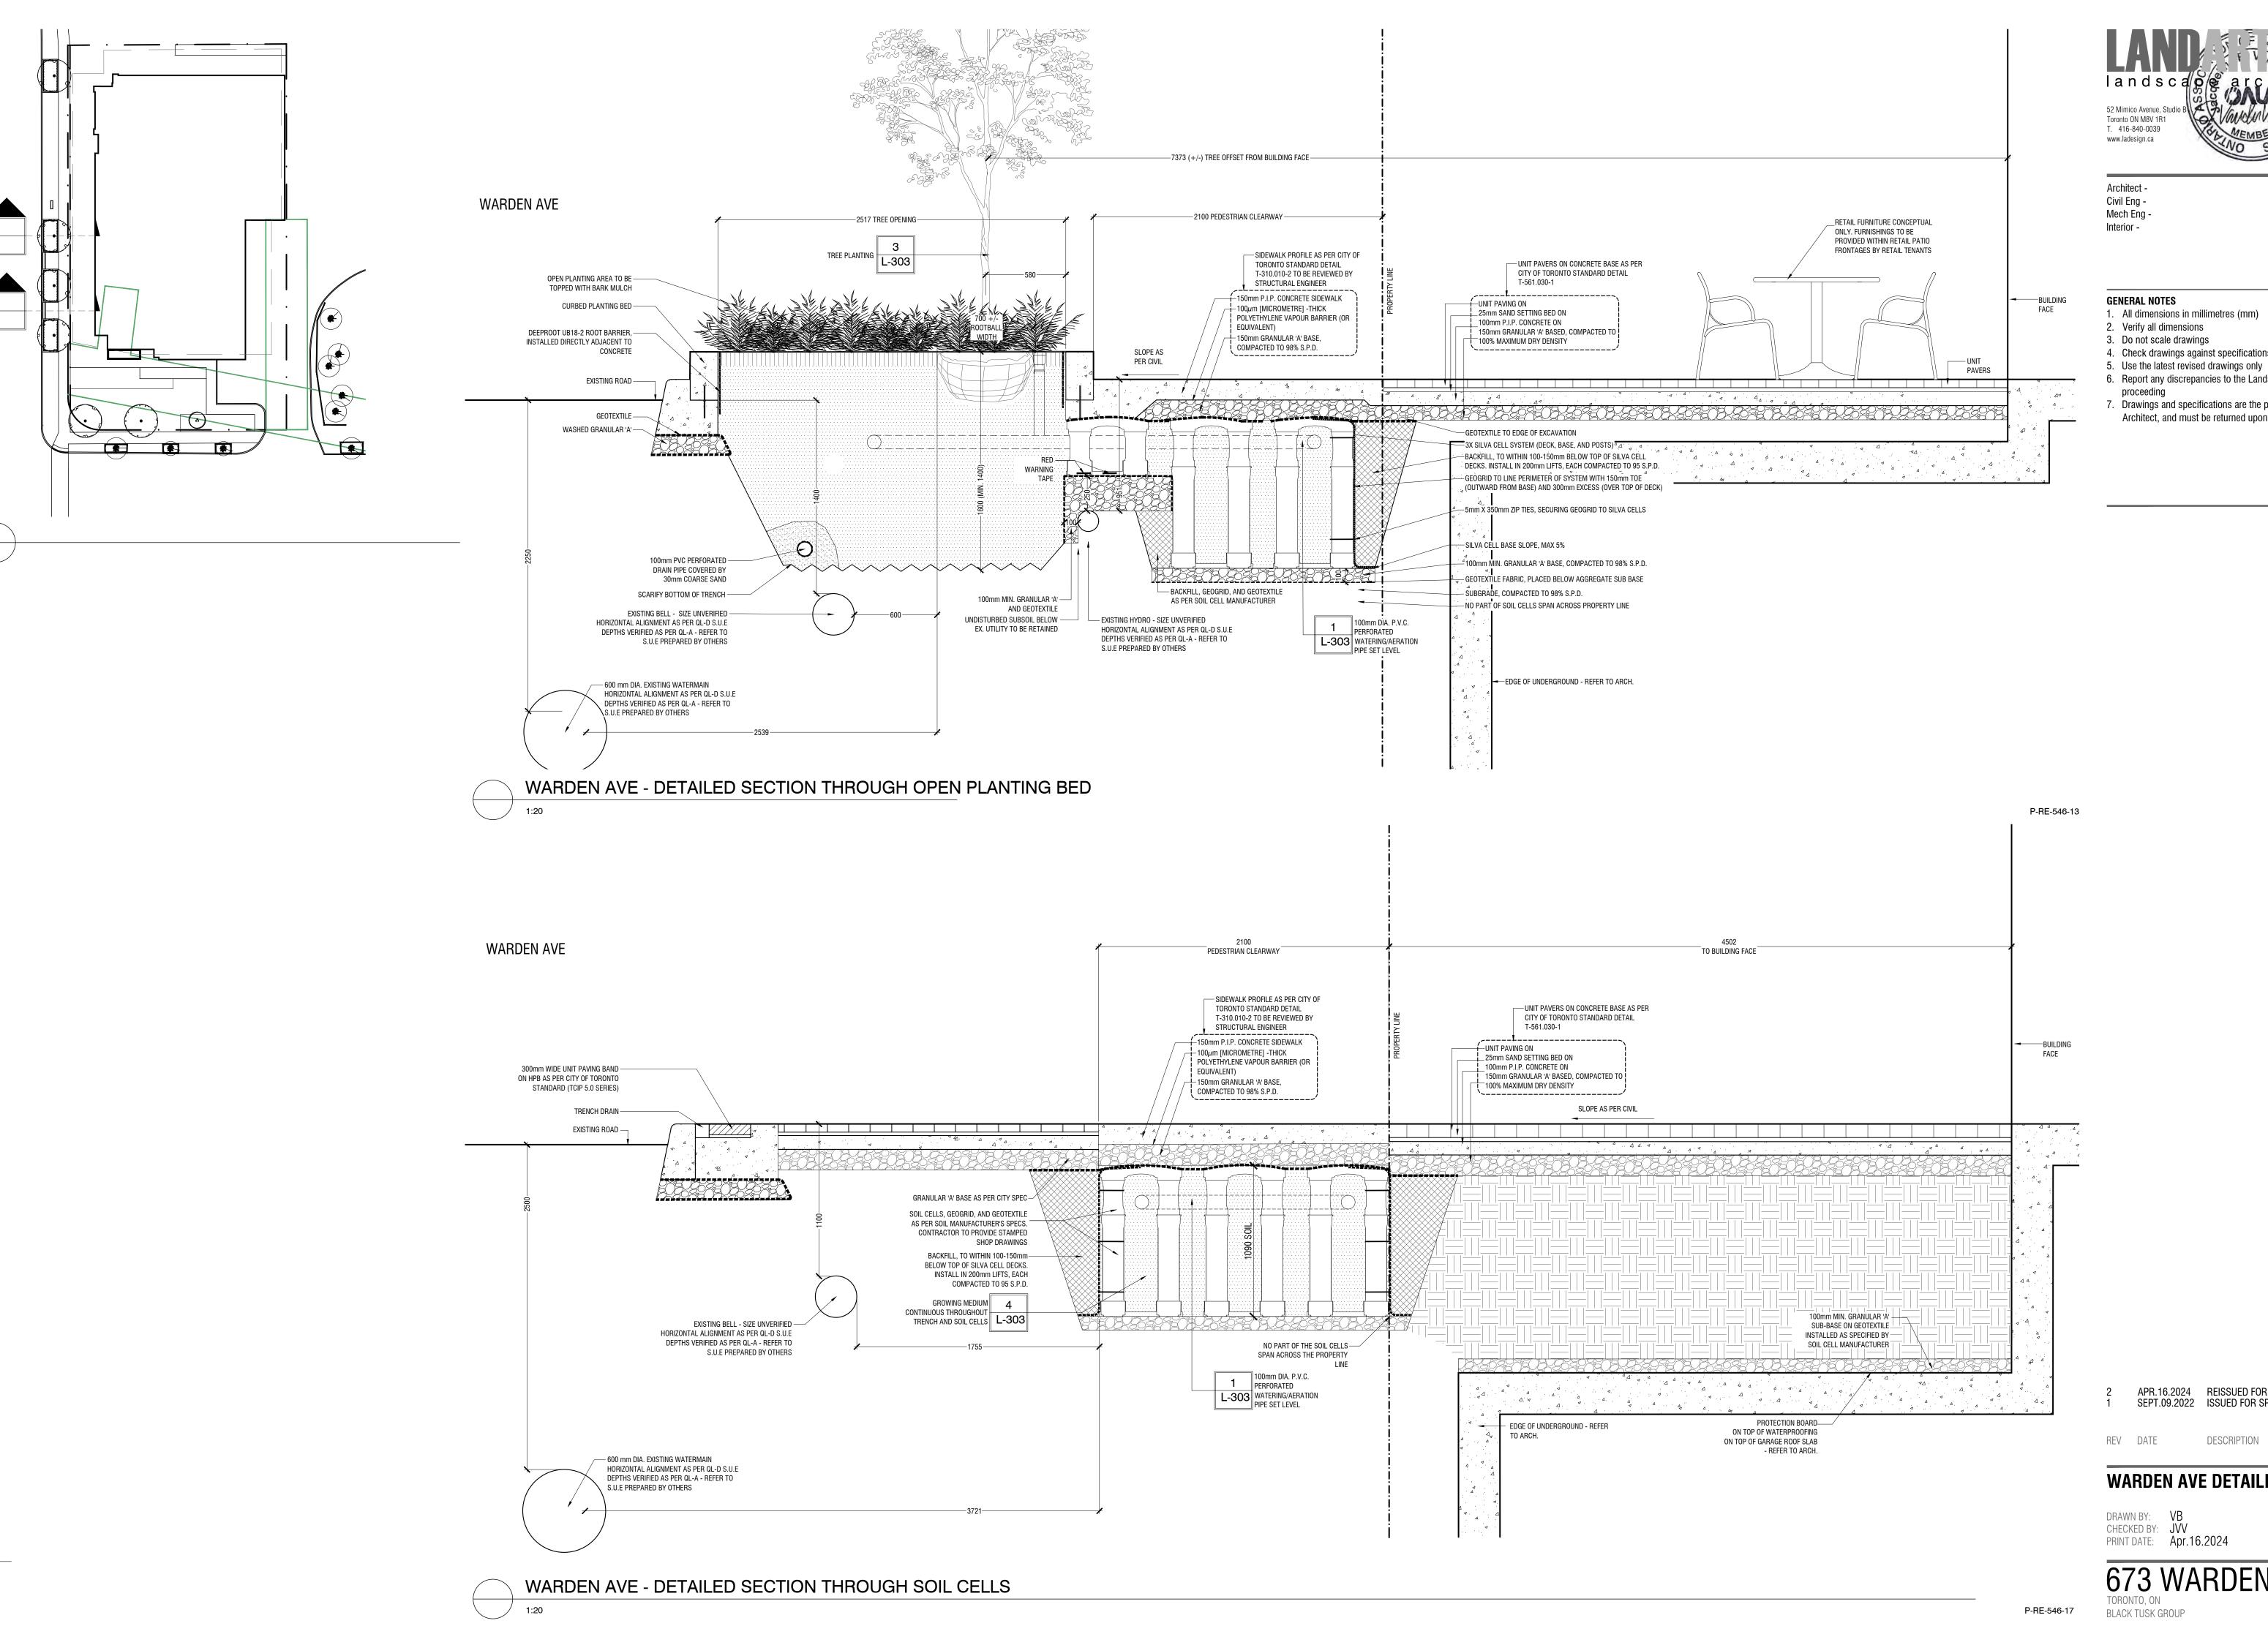

52 Mimico Avenue, Studio B Toronto ON M8V 1R1 T. 416-840-0039 www.ladesign.ca

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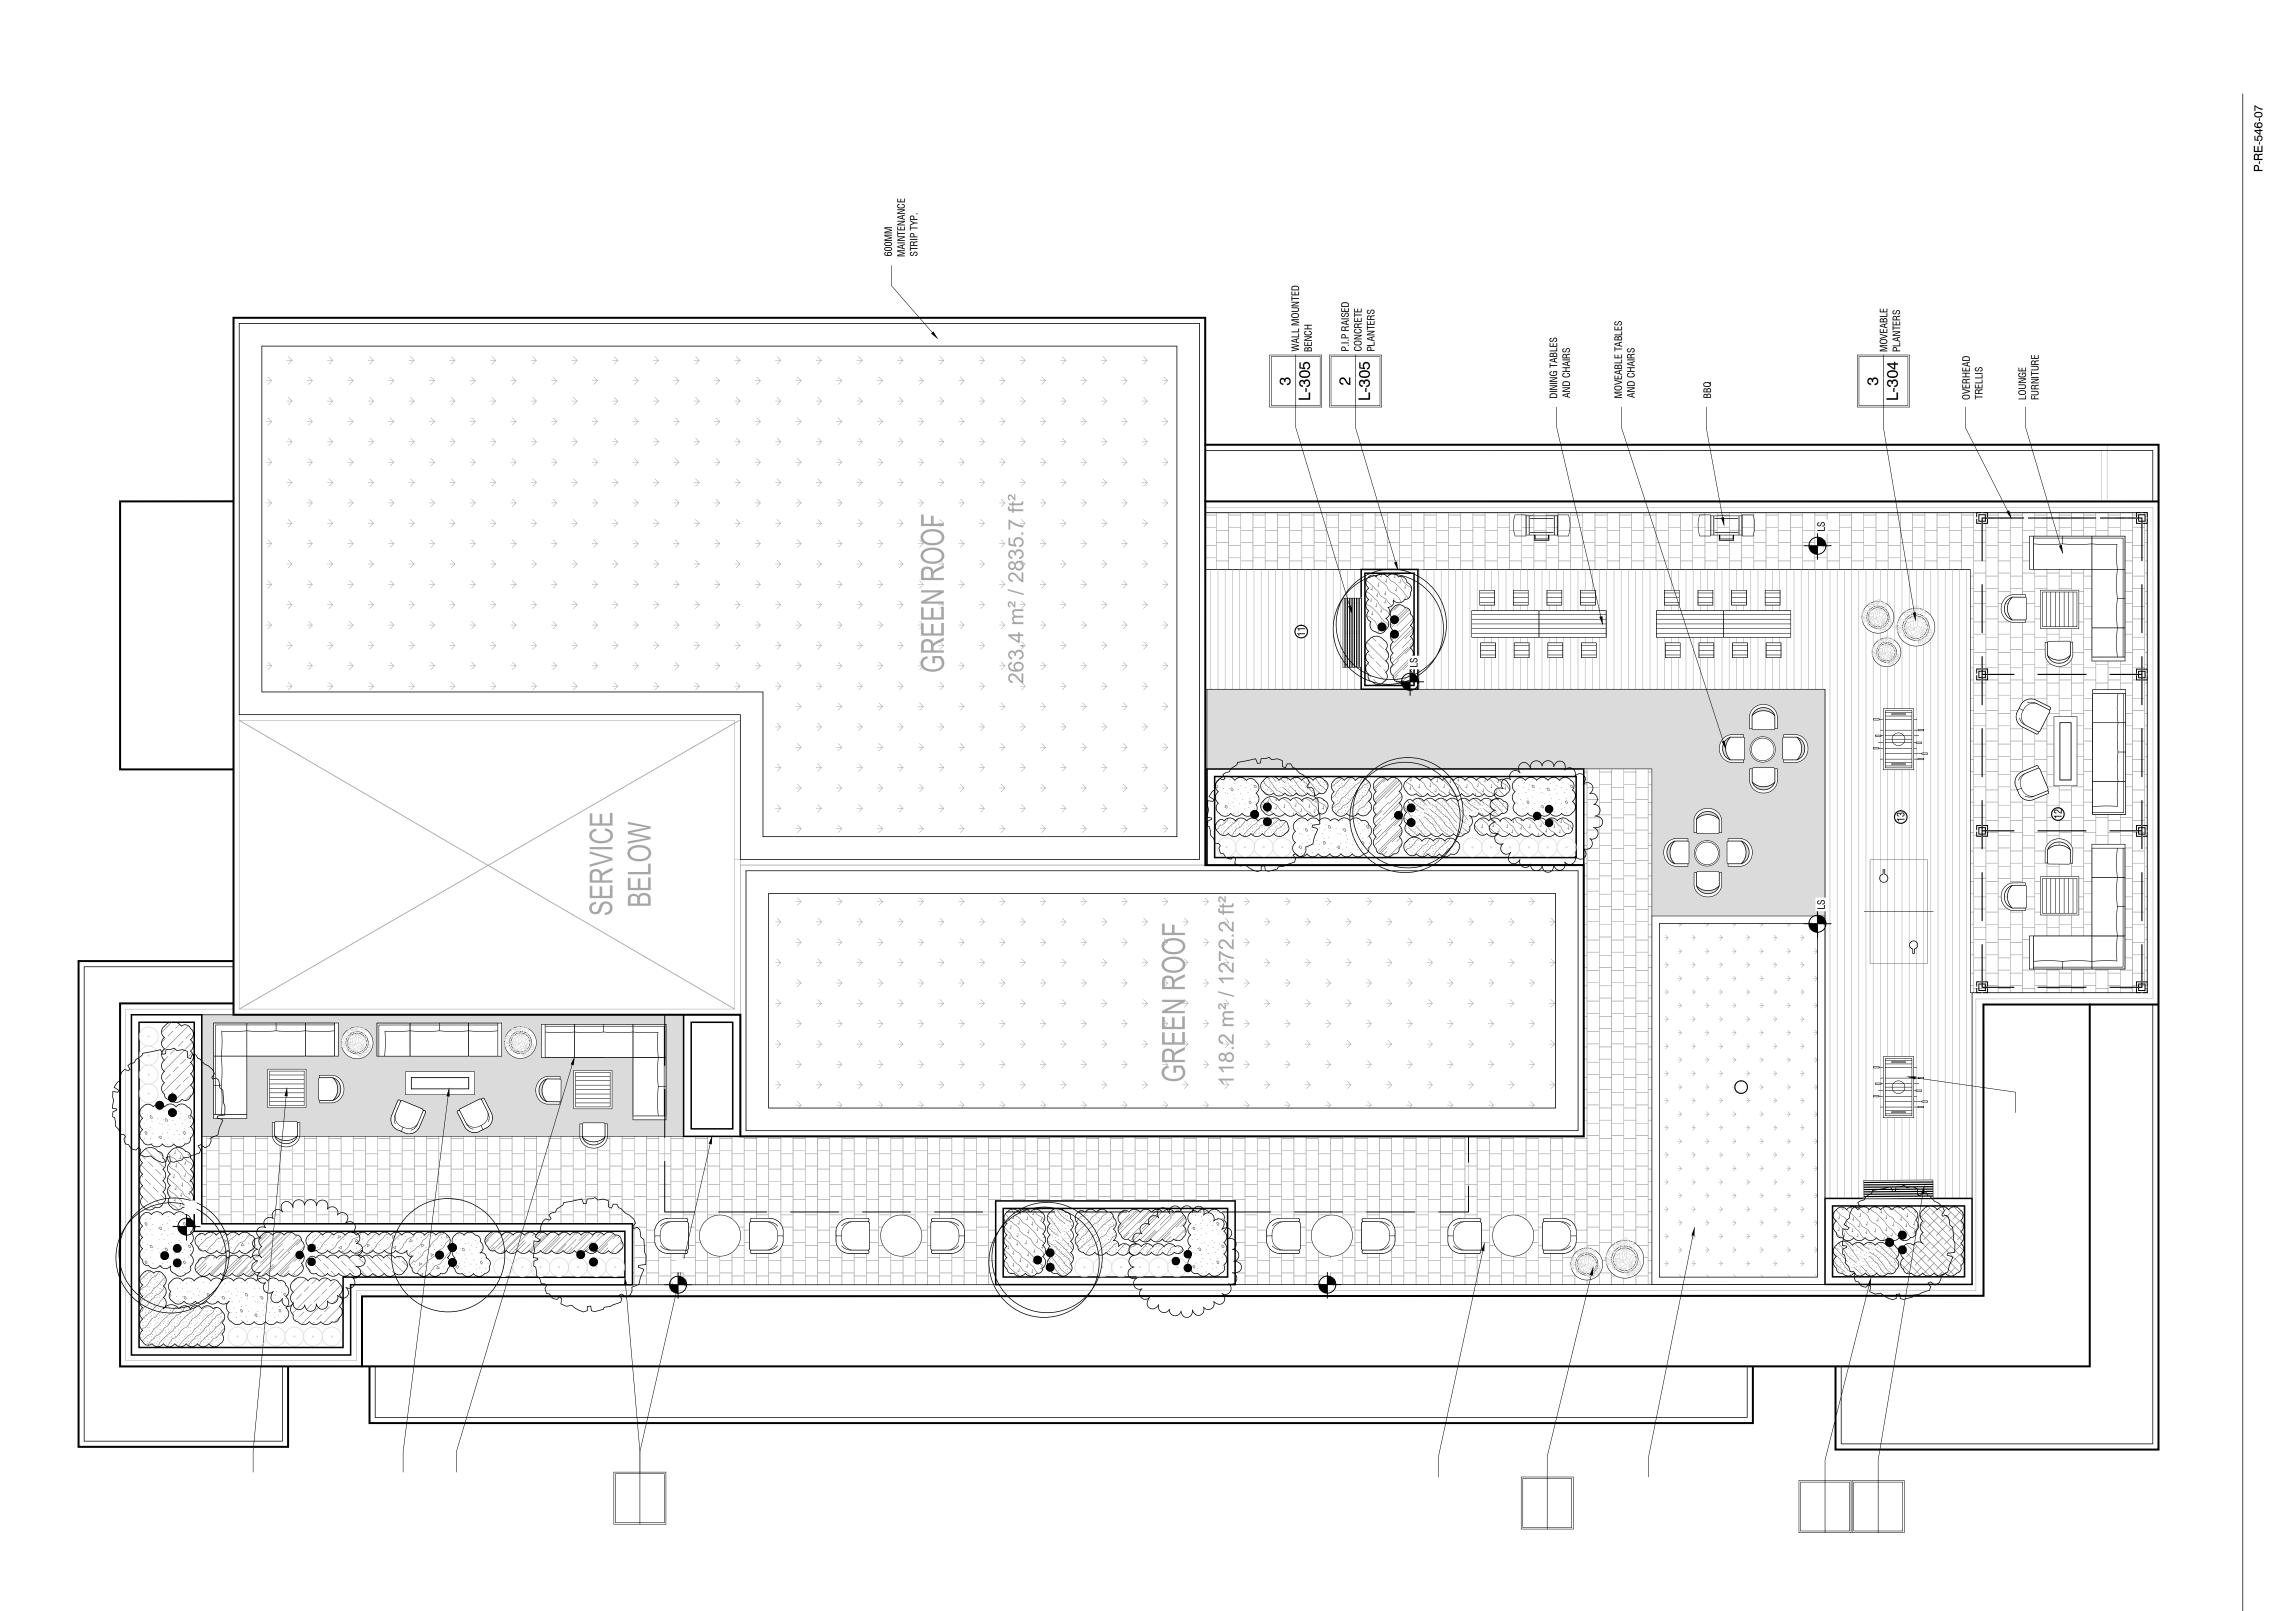
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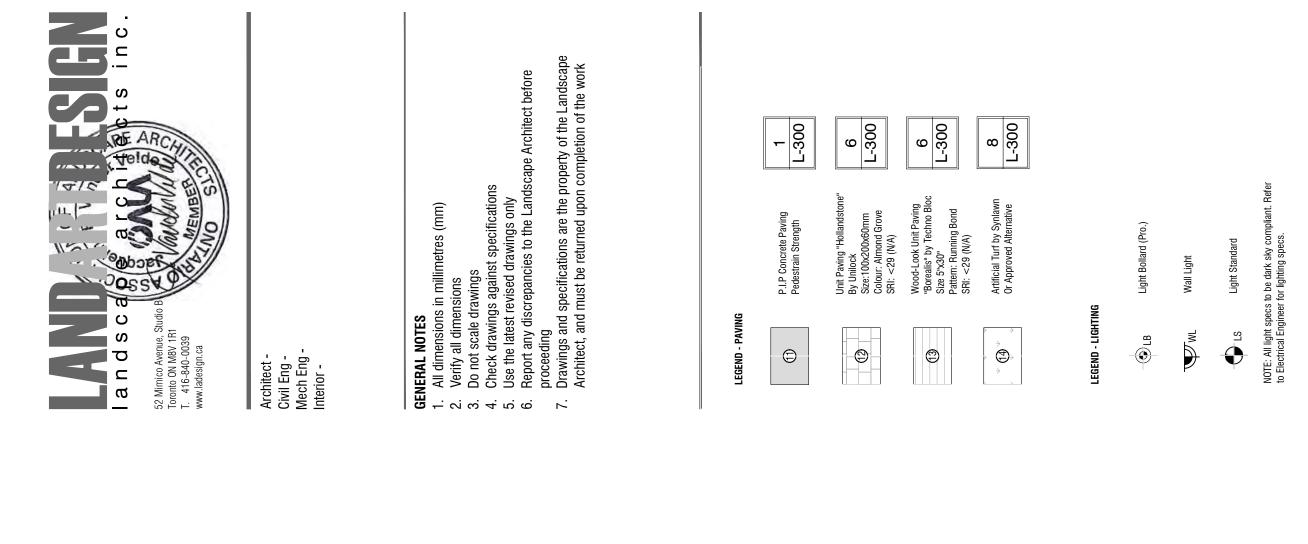
DRAWN BY: VB CHECKED BY: JVV
PRINT DATE: Apr.16.2024

INITIAL

673 WARDEN

BLACK TUSK GROUP





Contractor shall provide alternative pricing from both suppliers. GREEN ROOF NOTE:

XEROFLOR: 90E-T


88

APR.16.2024 REISSUED FOR SPA SEPT.09.2022 ISSUED FOR SPA

INITIAL

DATE


ROOFTOP AMENITY TERRACE PLAN

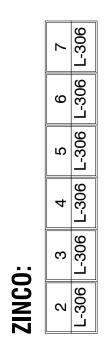




LAD-546

L-200

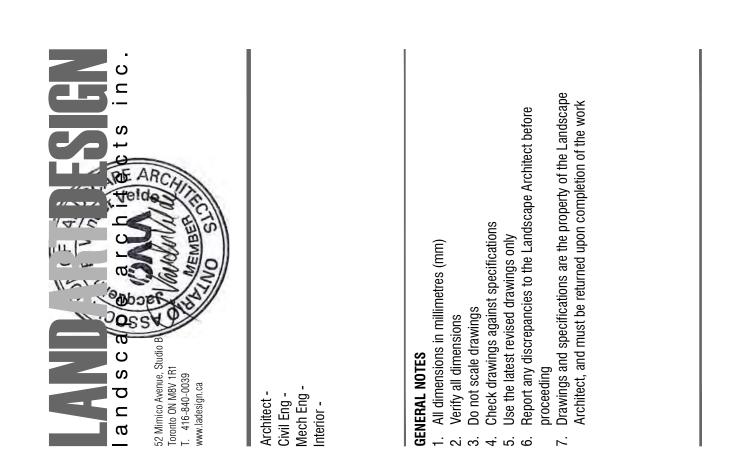

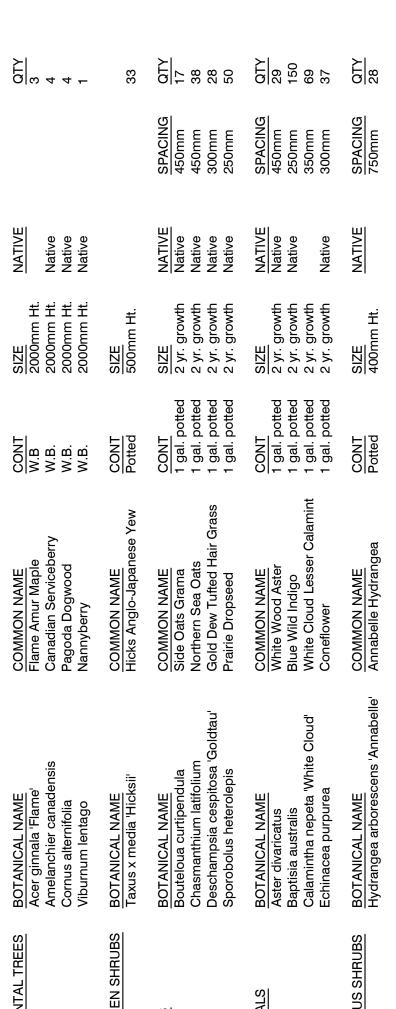

88

APR.16.2024 REISSUED FOR SPA SEPT.09.2022 ISSUED FOR SPA

PLANT SCHEDULE


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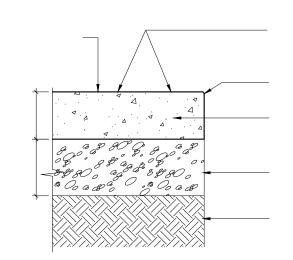
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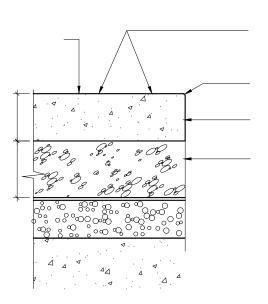
ROOFTOP AMENITY PLANTING PLAN


L-201

DRAWN BY: VB CHECKED BY: JVV PRINT DATE: Apr.16.2024 673 WARDEN





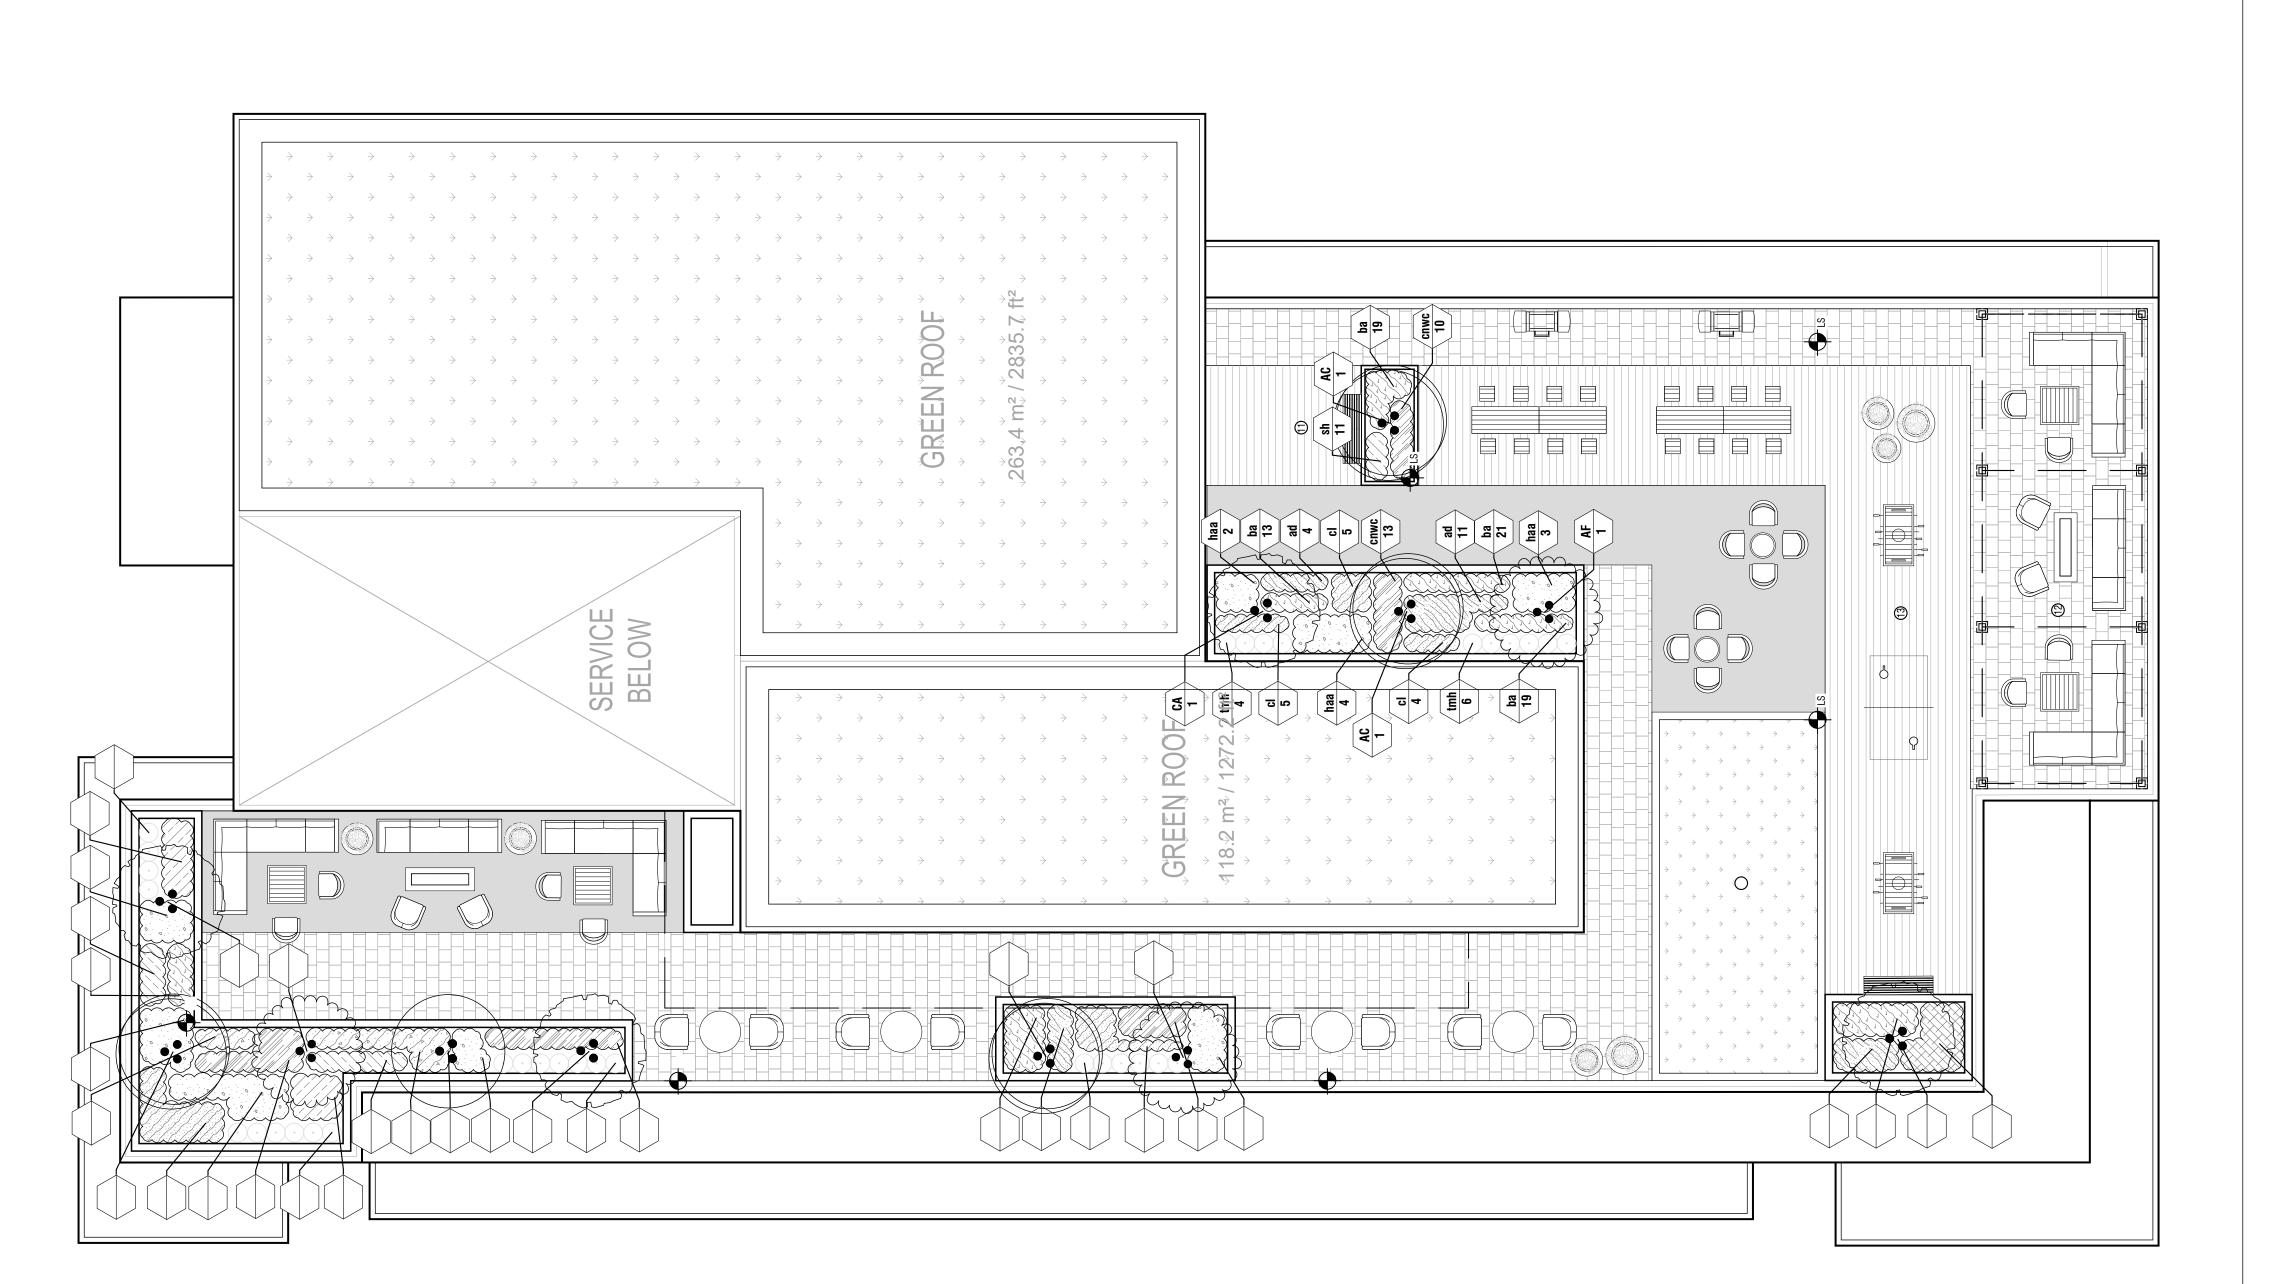

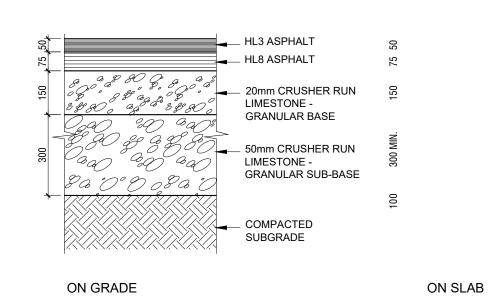


UNIT PAVING

6 L-300

2 L-300

HEAVY DUTY ASPHALT PAVING

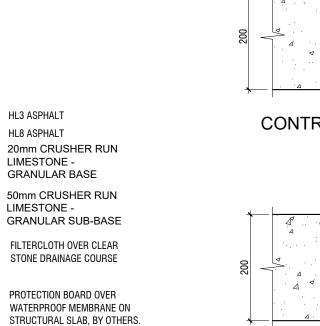

L-300

HL3 ASPHALT

HL8 ASPHALT

LIMESTONE -


LIMESTONE -

GRANULAR BASE

REFER TO ARCH. DWGS.

321201-03

321401-01

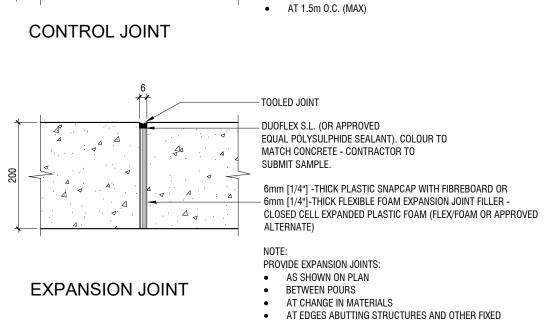


CONTROL AND EXPANSION JOINTS

EDGE RESTRAINT FOR UNIT PAVING

ELEMENTS • AT MAX 6m 0.C.

PROVIDE CONTROL JOINTS


AS SHOWN ON PLAN OR

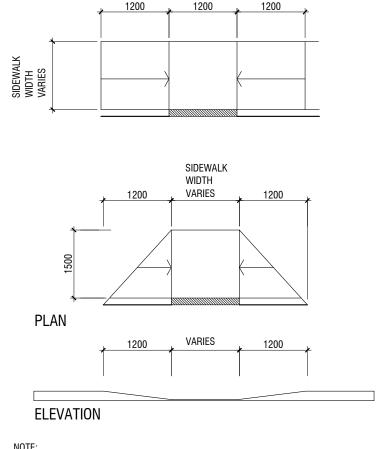



APPROACH TO CURB CUT


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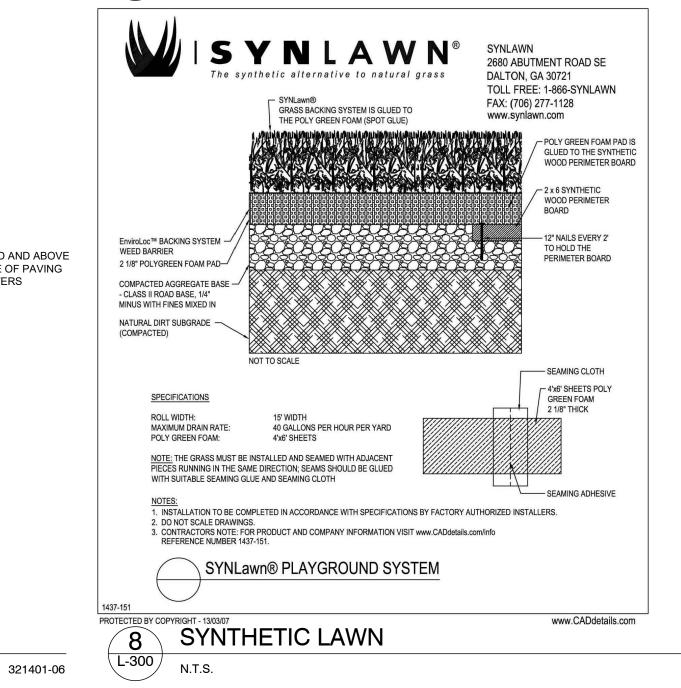
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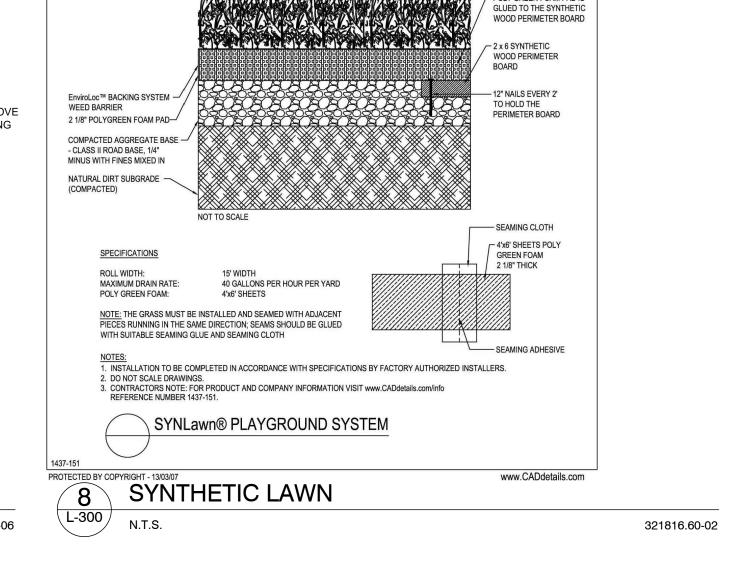




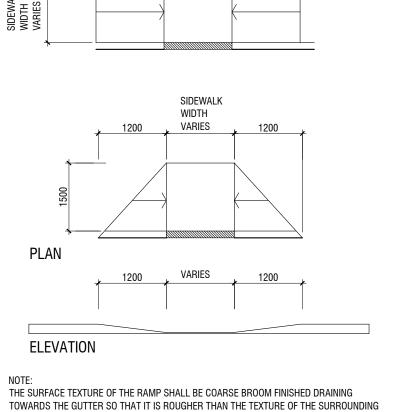


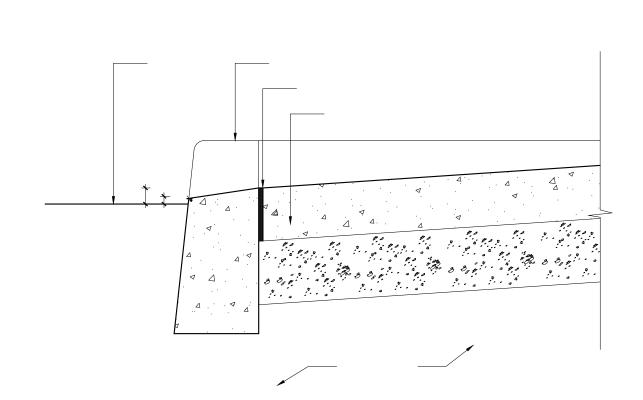

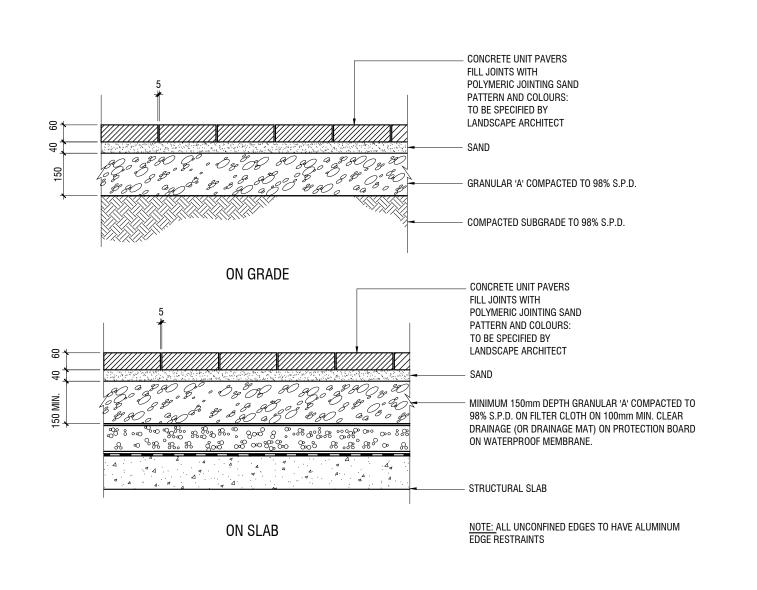

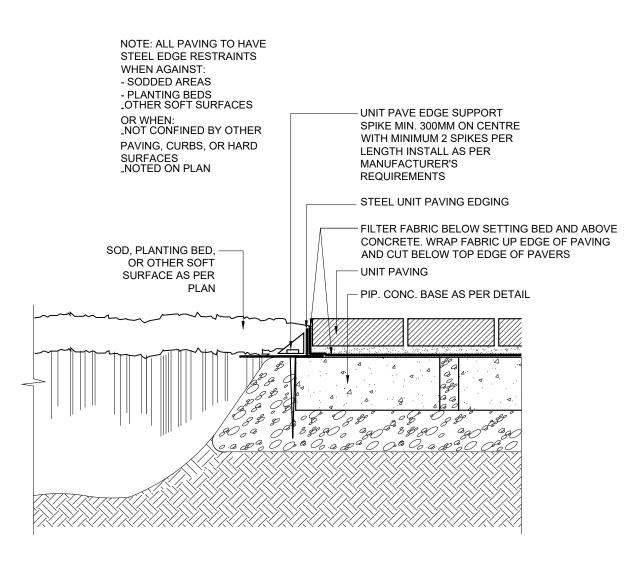

321313.01-21

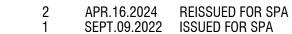

REV DATE

INITIAL

PAVING DETAILS

DRAWN BY: VB
CHECKED BY: JVV
PRINT DATE: Apr.16.2024

673 WARDEN TORONTO, ON

SCALE AS NOTED





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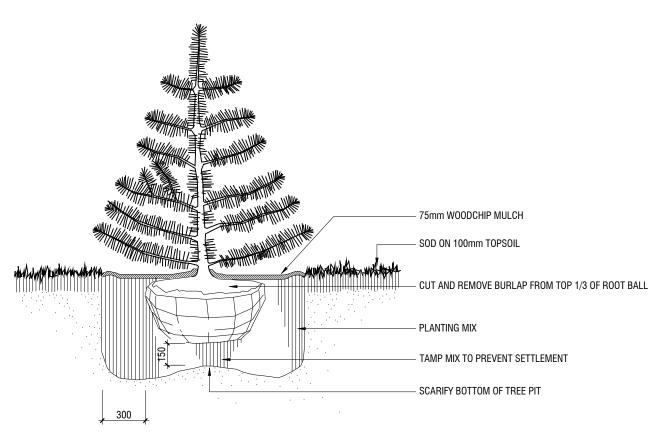
2. Verify all dimensions

DESCRIPTION

BLACK TUSK GROUP



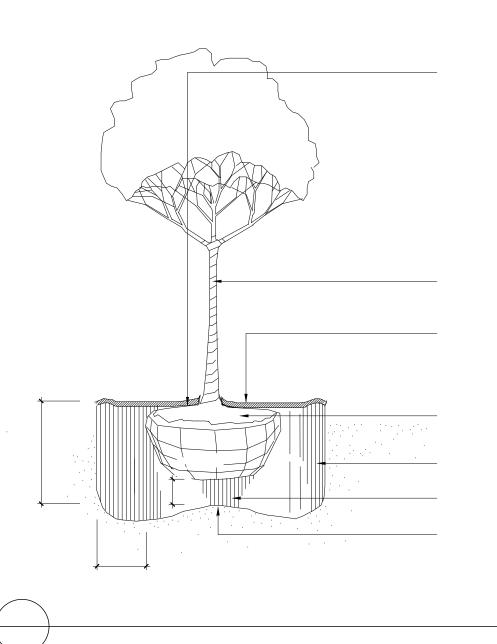

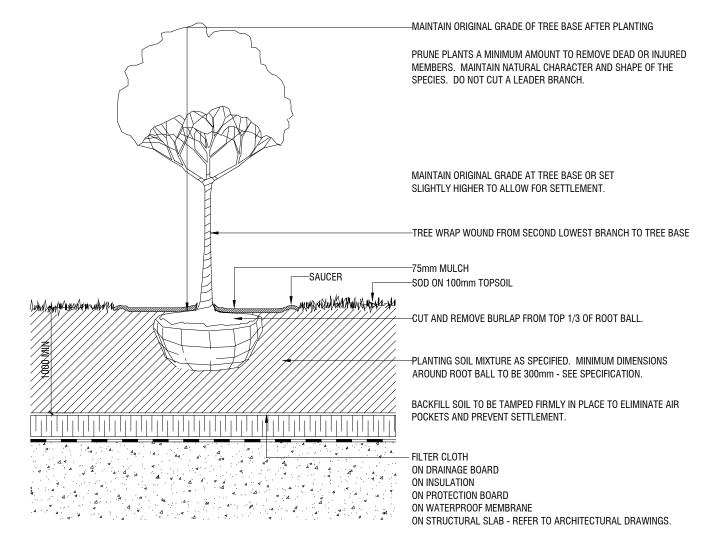


CONIFEROUS TREE PLANTING ON GRADE

L-301 /

329343.01-30

329333.01-11

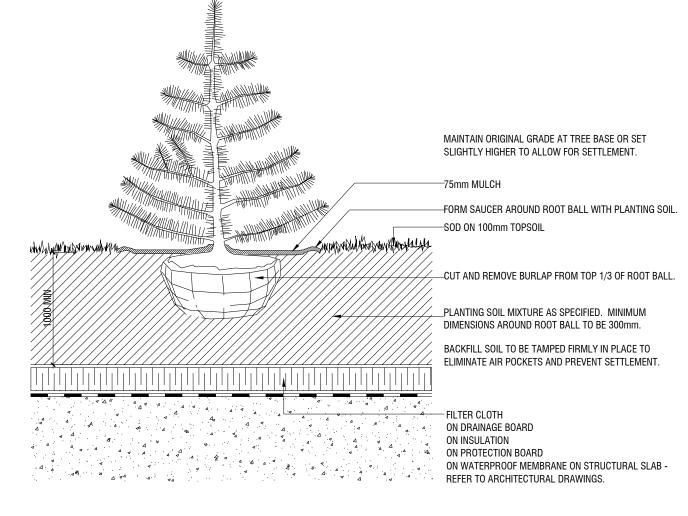


CONIFEROUS TREE PLANTING ON SLAB

- INVERTED ROOF PROFILE

L-301

329343.01-31

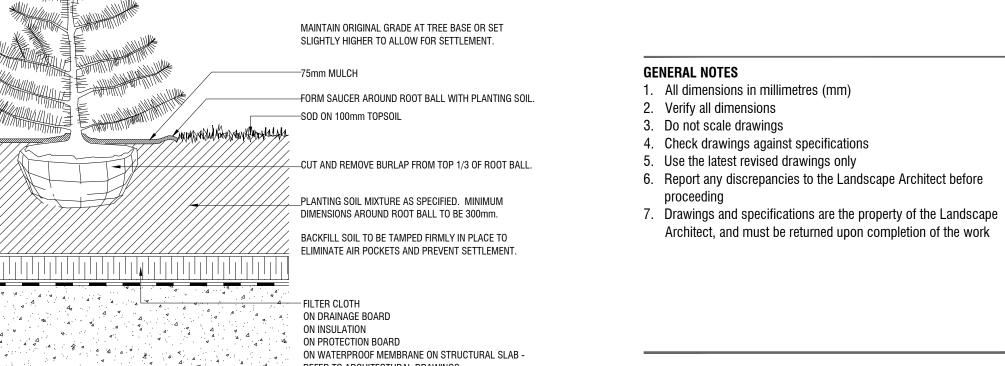

329343.01-32

PRUNE PLANTS A MINIMUM AMOUNT TO REMOVE DEAD OR

INJURED MEMBERS. MAINTAIN THE NATURAL CHARACTER


AND SHAPE OF THE SPECIES. DO NOT CUT A LEADER BRANCH.


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Architect -Civil Eng -Mech Eng -Interior -





DECIDUOUS TREE PLANTING ON SLAB

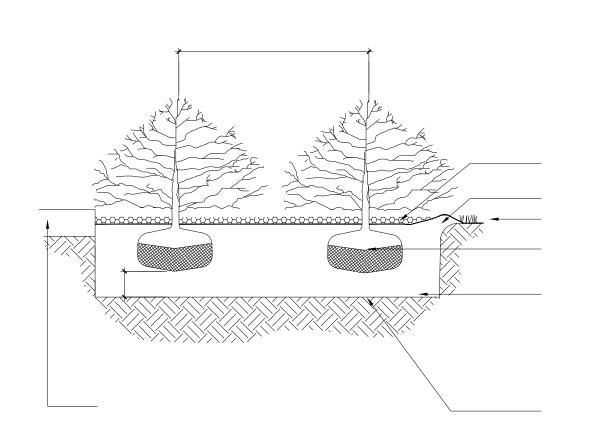2 L-301

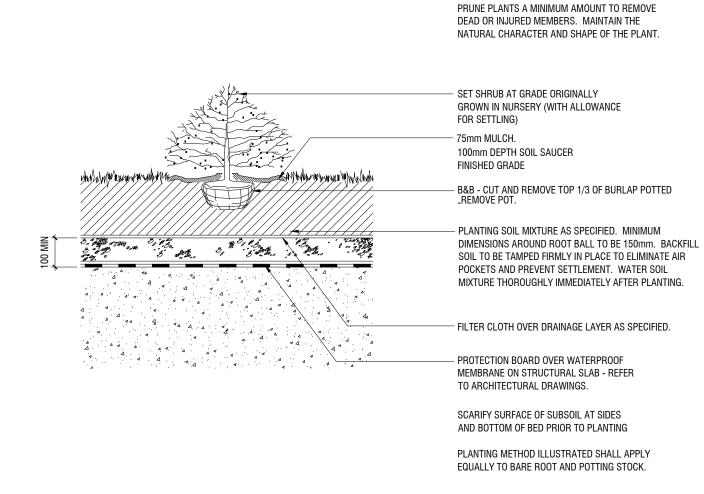

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REV DATE DESCRIPTION INITIAL


PLANTING DETAILS

DRAWN BY: VB CHECKED BY: JVV PRINT DATE: Apr.16.2024

LAD-546


BLACK TUSK GROUP



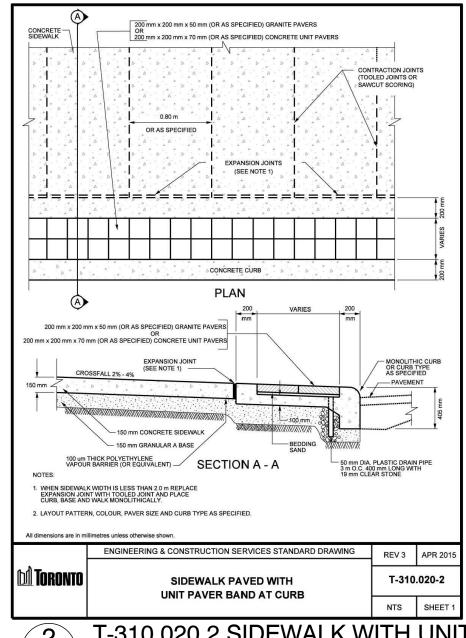


2 T-310.020.2 SIDEWALK WITH UNIT PAVER BAND

N.T.S. 320101.10-30

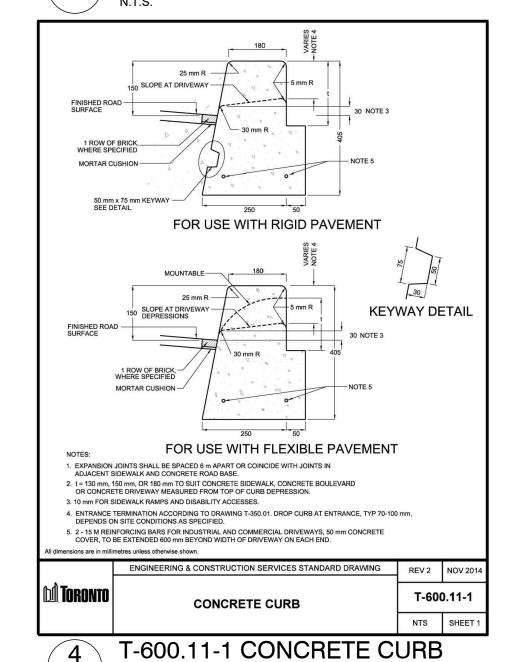


L-302

320101.10-61 5 LC L-302 N.T.S

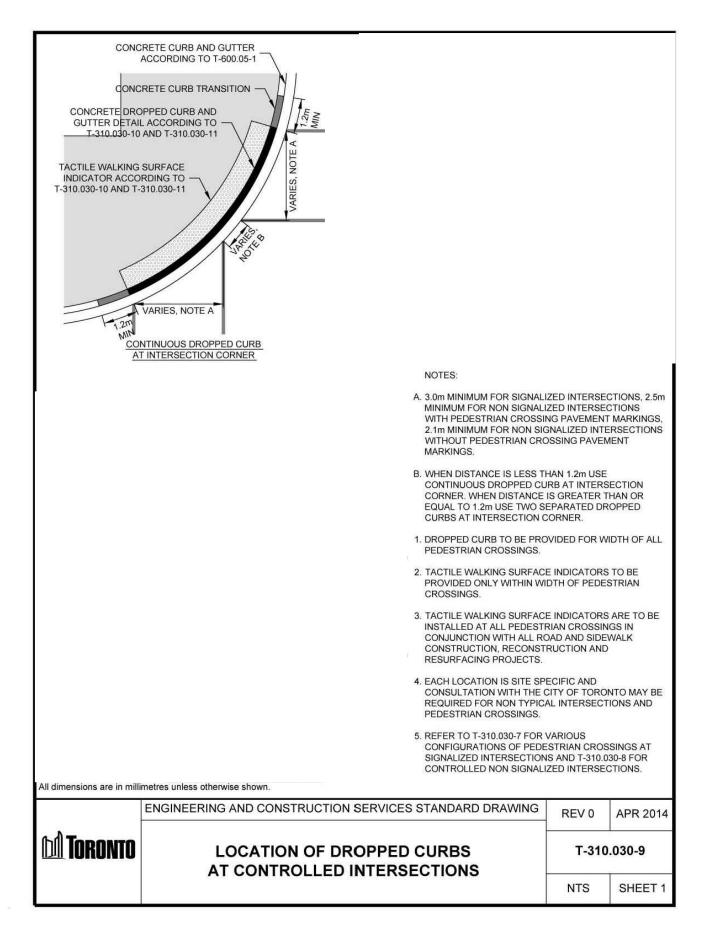



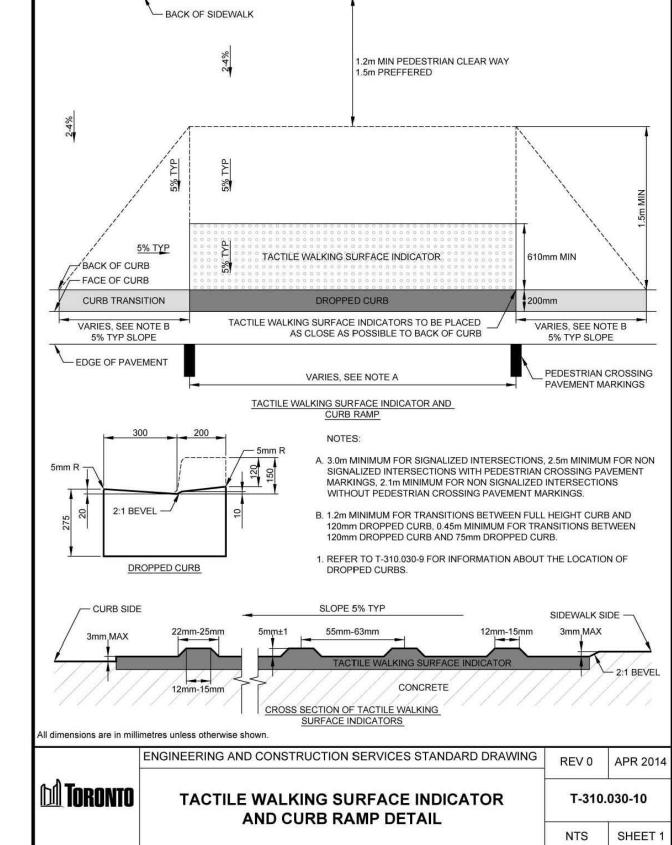

TACTILE SURFACE - CURB RAMP



Architect -Civil Eng -Mech Eng -Interior -

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320101.31-10

CITY OF TORONTO STANDARD DETAILS

DRAWN BY: VB
CHECKED BY: JVV
PRINT DATE: Apr.16.2024


L-302

VB


INITIAL

673 WARDEN
TORONTO, ON
BLACK TUSK GROUP

SCALE AS NOTED

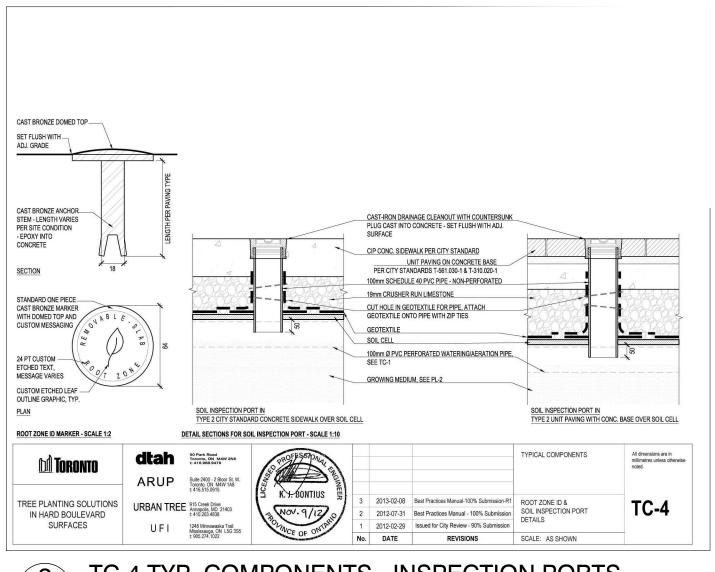




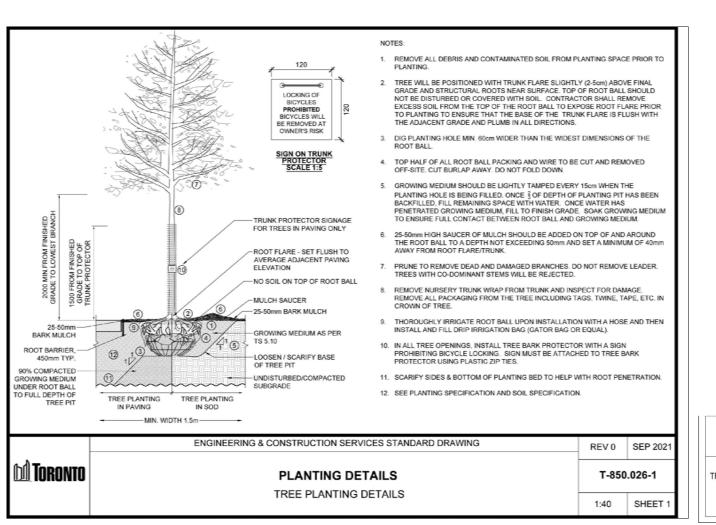



L-303

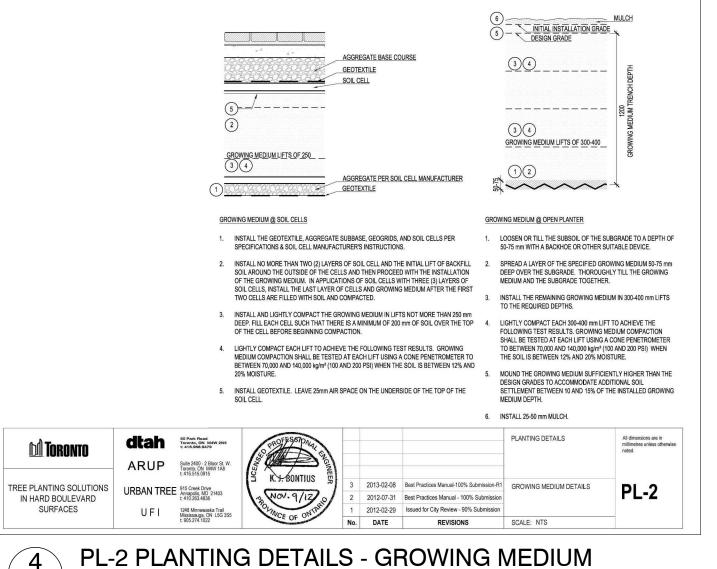

The Owner/applicant acknowledges and agrees that all trees must be planted as per the plans, approved by Urban Forestry and must arrive on site in Balled and Burlapped condition, with a minimum caliper of 70mm. The Owner shall ensure that each tree will have the burlap and wire cage opened and soil brushed away until the first proper root is found indicating the top of the real root crown. The Owner shall ensure that the tree is then planted with this level (real root crown), to be considered the top of root-ball as per the Urban Forestry planting details and any/all other instructions. The Owner acknowledges and agrees that any tree found planted with the first proper root more than 2.5cm below planting level will be rejected and require replacement or replanting at the discretion of the General Manager of Parks, Forestry and Recreation".

The Owner/applicant acknowledges and agrees that the planting areas of the site and the street allowance to be de-compacted, as preparation for planting, by excavating 100-120cm (or the depth of the proposed soil volume calculation) of the existing soil, scarify the open faces and bottom, and replace with new top soil, (City standard soil requirements) prior to tree planting. The Owner shall further provide proof (photos) of the planting preparation process indicating all stages in accordance with the approved Site Plan, Landscape Plan, Planting Details and Toronto Standard Details, and any other plans which are connected with the tree planting process

www.ladesign.ca Architect -Civil Eng -Mech Eng -Interior -

landscape archide

52 Mimico Avenue, Studio E

Toronto ON M8V 1R1

T 416-840-0039

GENERAL NOTES

320101.20-62

T. 416-840-0039

1. All dimensions in millimetres (mm)

2. Verify all dimensions 3. Do not scale drawings

4. Check drawings against specifications

5. Use the latest revised drawings only 6. Report any discrepancies to the Landscape Architect before

proceeding 7. Drawings and specifications are the property of the Landscape Architect, and must be returned upon completion of the work

APR.16.2024 REISSUED FOR SPA SEPT.09.2022 ISSUED FOR SPA

REV DATE DESCRIPTION

INITIAL

CITY OF TORONTO PLANTING DETAILS

DRAWN BY: VB CHECKED BY: JVV PRINT DATE: Apr.16.2024

BLACK TUSK GROUP

SCALE AS NOTED



Cooking Surface: 432 sq. inches BTUs Primary: 32,000 BTUs Backburner: 10,000 Designed for condos, apartments, or anywhere space is at a premium. The American Outdoor Grill In- Ground and Patio Post Mount units pack a lot of grilling enjoyment into smaller spaces (432 square inches). The In-Ground Grill models must be cemented into the ground. Pedestal models may be bolted to a deck or concrete slab. Both

designed to conceal the unsightly propane tank while a safety chain keeps the tank securely in place

Stainless steel rod cooking grids

6 L-304

BIKE RACK

"24NPT" BY AMERICAN

OUTDOOR GRILL

www.americanoutdoorgrill.com

- Warming rack Distinctively designed analog thermometer with polished bezel
- Solid brass valves for precise temperature control and long life Heavy duty 300 series stainless steel construction "Rapid Light" piezo ignition system
- Advanced high-quality 300 series stainless steel burners Stainless steel vaporizer panels for even heat distribution
 Backburner and rotisserie kit (not available on -OOSP grills)
- Easy to handle 4-prong adjustable meat holder for rotisserie
- Easy to use drip collection system Include a three hour safety timer, automatically shuts gas off.

POST MOUNT BBQ 2 L-304

3 L-304

129310-50

129350.50-01

Wannsee

I H 737mm

IH 34" I H 864mm

IH 39"

MOVEABLE PLANTER

SUPPLIER: Greenville Planters 5576 Ambler Drive

Mississauga ON L4W 2K9

www.greenvilledesigns.com

129331.69-02

Tel. (905) 361-1368

D 1118mm | H 991mm

69230.33 D 33" | H 29"

D 838mm

69230.39

D 39" D 991mm

69230.44 D 44"



RAISED METAL PLANTER

"TERRACE ALUMINUM PLANTER" BY HAUSER

The Terrace Aluminum Planter features an all-welded aluminum, powdercoated body with a flush mount base, and a 12" removable shelf depth. Available in any HauserKote powdercoat finish, and in a variety of custom sizes (refer to plan).

Provide galvanized steel liner.

PS-230-AL-[CUSTOM SIZE] sales@hausersite.com 800-268-7328 hausersite.com

129335.47-30

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Architect -Civil Eng -

Mech Eng -

GENERAL NOTES

proceeding

2. Verify all dimensions

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Architect, and must be returned upon completion of the work

5. Use the latest revised drawings only

Interior -

LOOP Bike Rack Product Drawing Date: 2/2/2018 www.landscapeforms.com Ph: 800.521.2546 (4) 5/16-18 UNC-2A FULLY THREADED RODS, 4" LENGTH, INCLUDED CONFIDENTIAL DRAWING INFORMATION CONTAINED HEREIN IS THE PROPERTY OF LANDSCAPE FORMS, INC. INTENDED USE IS LIMITED TO DESIGN PROFESSIONALS SPECIFYING LANDSCAPE FORMS, INC. PRODUCTS AND THER DIRECT CLIENTS. DRAWING IS NOT TO BE COPIED OR DISCLOSED TO OTHERS WITHOUT THE CONSENT OF LANDSCAPE FORMS, INC. ALL RIGHTS RESERVED.

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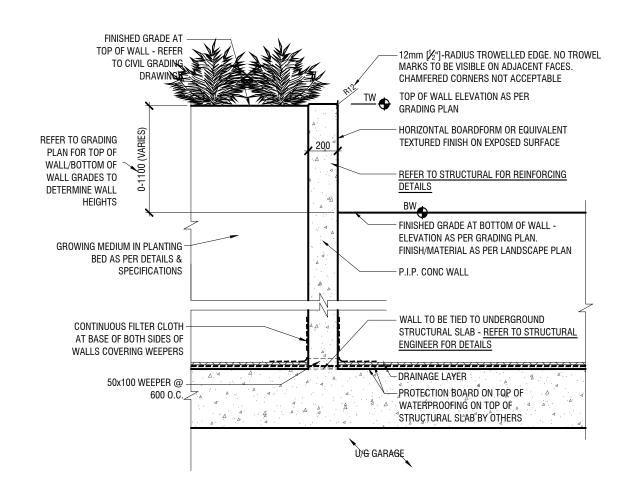
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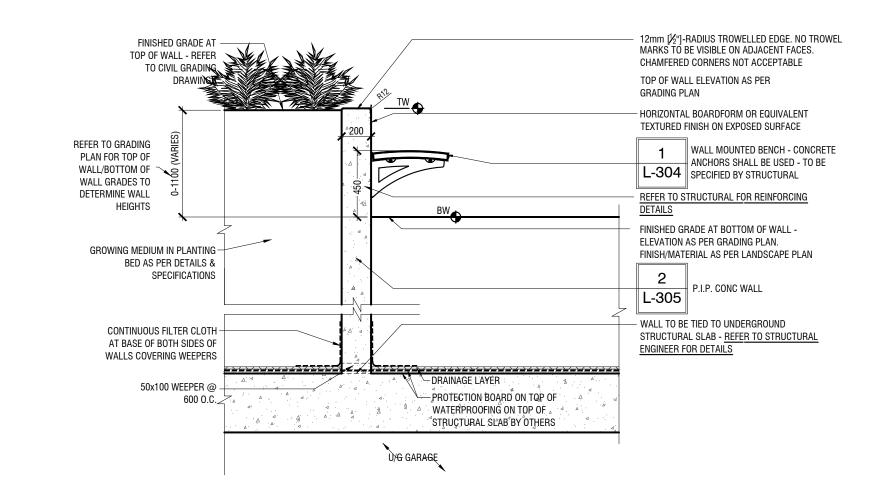
FURNITURE DETAILS

DRAWN BY: VB
CHECKED BY: JVV
PRINT DATE: Apr.16.2024

673 WARDEN

BLACK TUSK GROUP





P.I.P. CONCRETE RETAINING WALL ON SLAB

CANTILEVERED WALL MOUNTED BENCH 3 L-305

P-RE-380-34

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Architect -Civil Eng -Mech Eng -Interior -

GENERAL NOTES

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P-RE-422-75

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FENCE AND WALL DETAILS


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DRAWN BY: VB
CHECKED BY: JVV
PRINT DATE: Apr.16.2024

INITIAL

673 WARDEN

BLACK TUSK GROUP



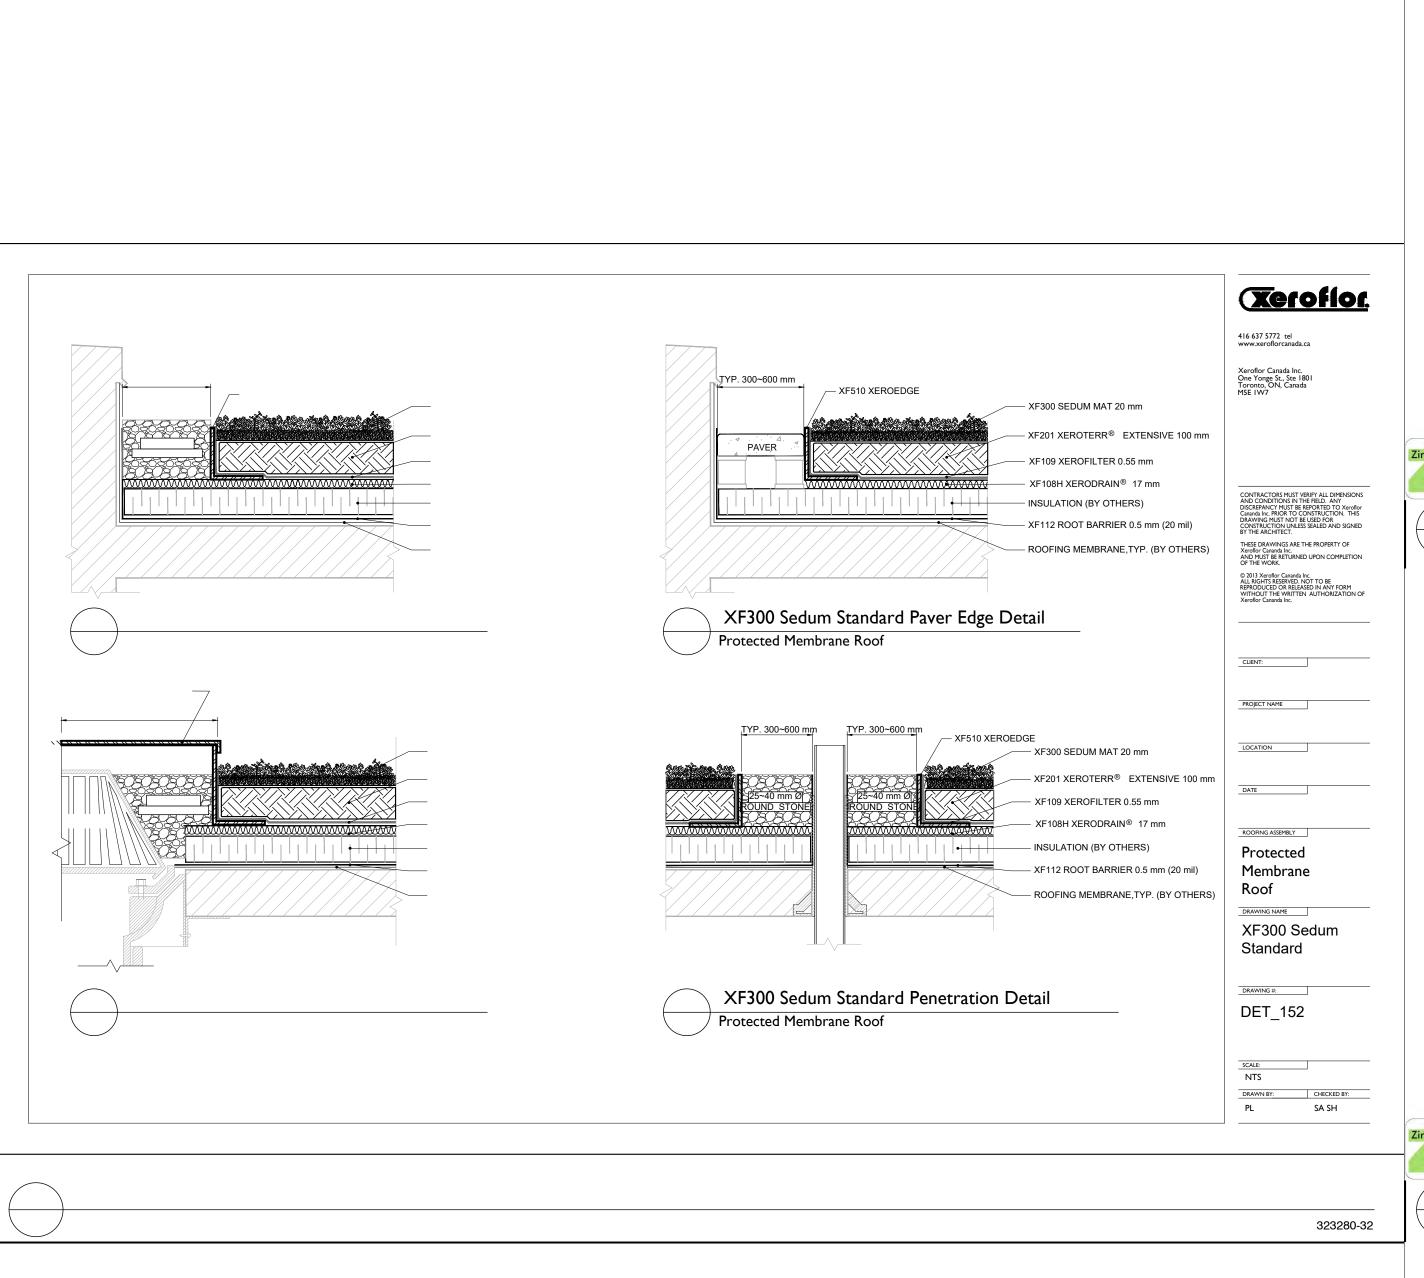



Architect -Civil Eng -Mech Eng -Interior -

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REV DATE DESCRIPTION

INITIAL

GREEN ROOF DETAILS

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673 WARDEN TORONTO, ON BLACK TUSK GROUP

SCALE AS NOTED