GROSS FLOOR AREA DEFINITION

CITY OF TORONTO ZONING BY-LAW NO.569-2013

Mixed Use:

(3) Gross Floor Area Calculations for a Mixed Use Building in the Commercial Residential Zone Category.

In the Commercial Residential Zone category the gross floor area of a mixed use building is reduced by the area in the building used for: (A) parking, loading and bicycle parking below-ground;

- (B) required loading spaces at the ground level and required bicycle parking spaces at or above-ground; (C) storage rooms, washrooms, electrical, utility, mechanical and ventilation rooms in the basement
- (D) shower and change facilities required by this By-law for required bicycle parking spaces;

(E) amenity space required by this By-law,

(F) elevator shafts; (G) garbage shafts;

(H) mechanical penthouse; and

(I) exit stairwells in the building.

PROJECT SITE AREA

SITE AREAS	m²	ft²
PARCEL 1	11,194.3	120,494
PARCEL 2	3,027.9	32,592
TOTAL SITE AREA	14,222.2	153,086

PROJECT INFORMATION

PROVIDED	BUILDING A	BUILDING B	BUILDING C
BUILDING HEIGHT	118.25M (37 ST)	34.65M (10 ST)	64.75M (20 ST)
BUILDING SETBACKS			
NORTH SETBACK	33.60 M	3.00 M	1.50 M
SOUTH SETBACK	2.00 M	3.00 M	20.10M(easement)
EAST SETBACK	1.50 M	2.30 M	1.60 M
WEST SETBACK	3.00 M	N/A	4.40 M
LOADING SPACE	1 X TYPE 'G'	1 X TYPE 'G'	1 X TYPE 'G'
	1 X TYPE 'C'		
	1 X TYPE 'B'		
ESTABLISHED GRADE		102.40 M	

GROSS FLOOR AREA SUMMARY

BLDG	USE	G	FA	FSI
		m²	ft²	
	NON-RESIDENTIAL	6,003.9	64,626	0.42
	SUBTOTAL NON-RESIDENTIAL	6,003.9	64,626	0.42
BLDG A+B+C				
A-D-O	RESIDENTIAL 1127 UN	ITS 77,988.0	839,457	5.48
	SUBTOTAL RESIDENTIAL	77,988.0	839,457	5.48
	TOTAL	83,992.0	904,082	5.90

Last Updated: Tuesday, 23 April 2024 14:54:04 PM

GROSS FLOOR AREA SUMMARY

BLDG	USE		GF	A	FSI
			m²	ft²	
	NON-RESIDENTIAL		5,503.1	59,235	0.49
	SUBTOTAL NON-RESIDENTIA	L	5,503.1	59,235	0.49
BLDG A+B					
ATD	RESIDENTIAL	903 UNITS	60,769.9	654,122	5.43
	SUBTOTAL RESIDENTIAL		60,769.9	654,122	5.43
	TOTAL		66,273.0	713,357	5.92

Last Updated: Tuesday, 23 April 2024 14:53:38 PM

GROSS FLOOR AREA SUMMARY BLDG USE

0.45
0.45
3.79
3.79
4.24

GFA

m²

FSI

GROSS FLOOR AREA SUMMARY

BLDG	USE	GF	Ā	FSI
		m²	ft²	
	NON-RESIDENTIAL	503.1	5,416	0.04
	SUBTOTAL NON-RESIDENTIAL	503.1	5,416	0.04
BLDG B				
	RESIDENTIAL 262 UNITS	18,292.4	196,898	1.63
	SUBTOTAL RESIDENTIAL	18,292.4	196,898	1.63
	TOTAL	18,795.5	202,313	1.68
Last Update	ed: Tuesday, 23 April 2024 11:31:48 AM			

GROSS FLOOR AREA SUMMARY

OROCOTE				
BLDG	USE	GI	FA	FSI
		m²	ft²	
	NON-RESIDENTIAL	500.8	5,390	0.17
	SUBTOTAL NON-RESIDENTIAL	500.8	5,390	0.17
BLDG C				
	RESIDENTIAL 224 UNITS	17,218.2	185,335	5.69
	SUBTOTAL RESIDENTIAL	17,218.2	185,335	5.69
	TOTAL	17,719.0	190,725	5.85
Last Update	ed: Tuesday, 23 April 2024 11:31:53 AM			

UNIT MIX SUMMARY

BLDG			SALEA	BLE			RENTAL AFF	ORDABLE			TOT	AL		AVG. UN	IIT SIZE	
	BUILDING	1B	2B	3B	TOTAL	1B	2B	3B	TOTAL	1B	2B	3B	TOTAL	m²	ft²	
	А	436	96	60	592	36	8	5	49	472	104	65	641	58.7	631	
	В	195	40	27	262					195	40	27	262	62.4	671	
	С	160	32	21	213	7	2	2	11	167	34	23	224	67.4	726	
BLDG	SUBTOTAL	791	168	108	1067	43	10	7	60	834	178	115	1127			
A+B+C	TOTAL UNITS	791	168	108	1067	43	10	7	60	834	178	115	1127			
	UNIT MIX	74.1%	15.7%	10.1%	100.0%	71.7%	16.7%	11.7%	100.0%	74.0%	15.8%	10.2%	100.0%		600	
	UNIT MIX TOTAL	74.1%	15.7%	10.1%	100.0%	71.7%	16.7%	11.7%	100.0%	74.0%	15.8%	10.2%	100.0%	61.3	660	
	AVG UNIT SIZE	53.4	75.9	94.0	61.0	55.9	75.3	111.7	65.6	53.5	75.9	95.1	61.3		1	
	AVG UNIT SIZE TOTAL	53.4	75.9	94.0	61.0	55.9	75.3	111.7	65.6	53.5	75.9	95.1	61.3			

Last Updated: Tuesday, 23 April 2024 14:54:08 PM

UNIT MIX SUMMARY

BLDG			SALEA	BLE			RENTAL AFF	ORDABLE			TOT	AL		AVG. UN	NIT SIZE	
	BUILDING	1B	2B	3B	TOTAL	1B	2B	3B	TOTAL	1B	2B	3B	TOTAL	m²	ft²	
	А	436	96	60	592	36	8	5	49	472	104	65	641	58.7	631	
	В	195	40	27	262					195	40	27	262	62.4	671	
	SUBTOTAL	631	136	87	854	36	8	5	49	667	144	92	903			
BLDG A+B	TOTAL UNITS	631	136	87	854	36	8	5	49	667	144	92	903			
	UNIT MIX	73.9%	15.9%	10.2%	100.0%	73.5%	16.3%	10.2%	100.0%	73.9%	15.9%	10.2%	100.0%	59.7	643	
	UNIT MIX TOTAL	73.9%	15.9%	10.2%	100.0%	73.5%	16.3%	10.2%	100.0%	73.9%	15.9%	10.2%	100.0%	59.7	043	
	AVG UNIT SIZE	52.7	73.1	88.7	59.6	53.2	73.7	107.4	62.1	52.7	73.1	89.7	59.7			
	AVG UNIT SIZE TOTAL	52.7	73.1	88.7	59.6	53.2	73.7	107.4	62.1	52.7	73.1	89.7	59.7	1		

Last Updated: Tuesday, 23 April 2024 14:53:43 PM

UNIT MIX SUMMARY

BLDG	FLOOR		SALEA	BLE			RENTAL AFF	ORDABLE			TOTA	4L		AVG. UN	IIT SIZE
		1B	2B	3B	TOTAL	1B	2B	3B	TOTAL	1B	2B	3B	TOTAL	m²	ft²
	SUBTOTAL	436	96	60	592	36	8	5	49	472	104	65	641		
	TOTAL UNITS	436	96	60	592	36	8	5	49	472	104	65	641		
BLDG A	UNIT MIX	73.6%	16.2%	10.1%	100.0%	73.5%	16.3%	10.2%	100.0%	73.6%	16.2%	10.1%	100.0%	E0 7	624
	UNIT MIX TOTAL	73.6%	16.2%	10.1%	100.0%	73.5%	16.3%	10.2%	100.0%	73.6%	16.2%	10.1%	100.0%	58.7	631
	AVG UNIT SIZE	51.0	72.6	89.0	58.4	53.2	73.7	107.4	62.1	51.2	72.7	90.4	58.7		
	AVG UNIT SIZE TOTAL	51.0	72.6	89.0	58.4	53.2	73.7	107.4	62.1	51.2	72.7	90.4	58.7		

Last Updated: Tuesday, 23 April 2024 14:52:05 PM

UNIT MIX SUMMARY

BLDG	FLOOR		SALEA		AVG. UNIT SIZE			
		1B	2B	3B	TOTAL	m²	ft²	
	SUBTOTAL	195	40	27	262			
	TOTAL UNITS	195	40	27	262			
BLDG B	UNIT MIX	74.4%	15.3%	10.3%	100.0%	62.4	671	
	UNIT MIX TOTAL	74.4%	15.3%	10.3%	100.0%	02.4	0/1	
	AVG UNIT SIZE	56.4	74.2	88.1	62.4			
	AVG UNIT SIZE TOTAL	56.4	74.2	88.1	62.4			

Last Updated: Tuesday, 23 April 2024 11:32:10 AM

UNIT MIX SUMMARY	


BLDG	FLOOR		SALEA	BLE			RENTAL AFF	ORDABLE			тот	AL		AVG. UN	IIT SIZE
		1B	2B	3B	TOTAL	1B	2B	3B	TOTAL	1B	2B	3B	TOTAL	m²	ft²
	SUBTOTAL	160	32	21	213	7	2	2	11	167	34	23	224		
	TOTAL UNITS	160	32	21	213	7	2	2	11	167	34	23	224	67.4	726
BLDG C	UNIT MIX	75.1%	15.0%	9.9%	100.0%	63.6%	18.2%	18.2%	100.0%	74.6%	15.2%	10.3%	100.0%		
	UNIT MIX TOTAL	75.1%	15.0%	9.9%	100.0%	63.6%	18.2%	18.2%	100.0%	74.6%	15.2%	10.3%	100.0%		
	AVG UNIT SIZE	56.0	88.1	116.1	66.7	70.1	81.5	122.2	81.6	56.6	87.7	116.6	67.4		
	AVG UNIT SIZE TOTAL	56.0	88.1	116.1	66.7	70.1	81.5	122.2	81.6	56.6	87.7	116.6	67.4		

CC19.13 - CONFIDENTIAL APPENDIX B - made public on July 4, 2024

Last Update	ed: Monday, 15 April 2024	17:16:41 PM						
	TOTAL AMENITY	4.00 m²/UNIT	2,564.0	27,599	4.00 m²/UNIT	2,565.8	27,618	
BLDG A	OUTDOOR AMENITY	TOTAL AMEN THE INDOO (N		PROVIDED	1.02 m²/UNIT	660.0	7,104	
	INDOOR AMENITY	2.00 m²/UNIT	1,282.0	13,799	2.97 m²/UNIT	1,905.8	20,513	
		RATIO	m²	ft²	RATIO	m²	ft²	
	TYPE	R	REQUIRED		PROVIDED			

AMENITY AREAS REQUIRED & PROVIDED BLDG B

Last Updated: Friday, 12 April 2024 17:45:06 PM

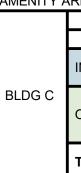

TURNER FLEISCHER

Turner Fleischer Architects Inc.

67 Lesmill Road Toronto, ON, M3B 2T8 T 416 425 2222 turnerfleischer.com

This drawing, as an instrument of service, is provided by and is the property of Turner Fleischer Architects Inc. The contractor must verify and accept responsibility for all dimensions and conditions on site and must notify Turner Fleischer Architects Inc. of any variations from the supplied information. This drawing is not to be scaled. The architect is not responsible for the accuracy of survey, structural, mechanical, electrical, etc., information shown on this drawing. Refer to the appropriate consultant's drawings before proceeding with the work. Construction must conform to all applicable codes and requirements of authorities having jurisdiction. The contractor working from drawings not specifically marked 'For Construction' must assume full responsibility and bear costs for any corrections or damages resulting from his work.


AMENITY AREAS REQUIRED & PROVIDED

TYPE	Я	REQUIRED		F	ROVIDED								
	RATIO	m²	ft²	RATIO	m²	ft²							
INDOOR AMENITY	2.00 m²/UNIT	524.0	5,640	2.00 m²/UNIT	526.5	5,667							
OUTDOOR AMENITY	TOTAL AMEN THE INDOO (N		PROVIDED	2.00 m²/UNIT	526.1	5,663							
TOTAL AMENITY	4.00 m²/UNIT	1,048.0	11,281	4.01 m²/UNIT	1,052.6	11,330							

	TOTAL AMENITY	4.00 m²/UNIT	896.0	9,644	4.00 m²/UNIT	896.7	9,652	
BLDG C	OUTDOOR AMENITY	TOTAL AMEN THE INDOOI (N		PROVIDED	1.21 m²/UNIT	273.2	2,940	
	INDOOR AMENITY	2.00 m²/UNIT	448.0	4,822	2.78 m²/UNIT	623.5	6,712	
		RATIO	m²	ft²	RATIO	m²	ft²	
	TYPE	R	REQUIRED		PROVIDED			

9 2024-06-04 REISSUED FOR SETTLEMENT OFFER MNZ 8 2024-05-16 REISSUED FOR SETTLEMENT OFFER MNZ 7 2024-04-30 ISSUED FOR SETTLEMENT OFFER MNZ 6 2024-04-23 ISSUED FOR DRAFT SETTLEMENT OFFER REVIEW MNZ 5 2024-04-01 ISSUED FOR MEDIATION MNZ 4 2024-03-19 ISSUED FOR MEDIATION MNZ 3 2024-02-21 ISSUED FOR MEDIATION MNZ 2 2022-12-16 ISSUED FOR REZONING APPLICATION AYU 1 2022-05-02 ISSUED FOR REZONING APPLICATION AYU # DATE DESCRIPTION BY Queenscorp (Royal York) Inc. ROJEC Queen Elizabeth Blvd + Royal York Rd, Toronto, ON 2, 7 and 10 Queen Elizabeth Boulevard, 506, 514, 516, 520, 522 Royal York Rd and 3, 5, 15 Sinclair Street DRAWING STATISTICS

WITHOUT PREJUDICE

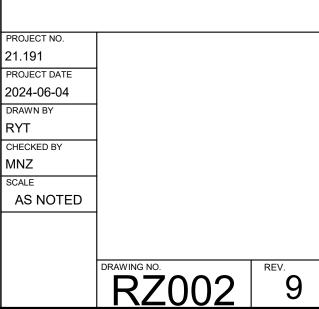

	FLOOR	US	SE	TOTAL						
	FLOOK	RESIDENTIAL	NON-RESIDENTIAL	TOTAL						
	Bldg A_Floor 1		10	10						
BLDG	U/G 1	201	53	254						
A+B+C	U/G 2	282		282						
	U/G 3	282		282						
	U/G 3.5	22		22						
	TOTAL	787	63	850						
Last Update	Last Updated: Tuesday, 04 June 2024 15:41:55 PM									

VEHICULAR PARKING PROVIDED

	FLOOR	U	SE	TOTAL							
	FLOOK	RESIDENTIAL		TOTAL							
BLDG A	U/G 1	56	35	91							
BLDG A	U/G 2	101		101							
	U/G 3	101		101							
	TOTAL	258	35	293							
Last Update	Last Updated: Tuesday, 04 June 2024 15:41:41 PM										

VEHICULAR PARKING PROVIDED

	U	TOTAL		
FLOOK	RESIDENTIAL	NON-RESIDENTIAL	TOTAL	
Bldg A_Floor 1		10	10	
U/G 1	128	5	133	
U/G 2	137		137	
U/G 3	137		137	
TOTAL	402	15	417	
	U/G 1 U/G 2 U/G 3	FLOORRESIDENTIALBldg A_Floor 1128U/G 1128U/G 2137U/G 3137	RESIDENTIALNON-RESIDENTIALBidg A_Floor 110U/G 1128U/G 2137U/G 3137	

Last Updated: Tuesday, 04 June 2024 15:41:46 PM

VEHICULAR PARKING PROVIDED

	FLOOR	U	SE	TOTAL
	FLOOK	RESIDENTIAL	NON-RESIDENTIAL	TOTAL
	U/G 1	17	13	30
BLDG C	U/G 2	44		44
	U/G 3	44		44
	U/G 3.5	22		22
	TOTAL	127	13	140

Last Updated: Tuesday, 04 June 2024 15:41:50 PM

VEHICULAR PARKING REQUIRED

					RES.		Non-Residential (m2)
		STUDIO	1B	2B	3B	Visitor	
	MIN. RATIO	N/A	N/A	N/A	N/A	2 + 0.05	N/A
	MIN. COUNT	N/A	N/A	N/A	N/A	62	N/A
BLDG. A+B+C						5 for the first 5 units, 0.1 per unit for the	
	MAX. RATIO	0.8	0.9	1	1.2	sixth and subsequent units	3.5/100
	MAX. COUNT		749	178	137	124	209
	TOTAL					1188	209
	GRAND TOTAL						1397

VEHICULAR PARKING REQUIRED

*PARKING ZONE(ALL OTHER PARTS)

					Non-Residential (m2)		
		STUDIO	1B	2B	3B	Visitor	Non-Residential (III2)
	MIN. RATIO	N/A	N/A	N/A	N/A	2 + 0.05	N/A
BLDG. A	MIN. COUNT	N/A	N/A	N/A	N/A		N/A
515 6171						5 for the first 5 units, 0.1 per unit for the	
	MAX. RATIO	0.8	0.9	1	1.2	sixth and subsequent units	3.5/100
	MAX. COUNT		424	104	78	68	175
	TOTAL					674	175
*PARKING ZONE(A	ALL OTHER PARTS)						

VEHICULAR PARKING REQUIRED


-									
I				RES.					
			STUDIO	1B	2B	3B	Visitor	Non-Residential (m2)	
I		MIN. RATIO	N/A	N/A	N/A	N/A	2 + 0.05	N/A	
	BLDG. B	MIN. COUNT	N/A	N/A	N/A	N/A	15	N/A	
I	BLDG. B						5 for the first 5 units, 0.1 per unit for the		
I		MAX. RATIO	0.8	0.9	1	1.2	sixth and subsequent units	3.5/100	
I		MAX. COUNT		175	40	32	30	17	
I		ΤΟΤΑΙ					277	17	

VEHICULAR PARKING REQUIRED

*PARKING ZONE(ALL OTHER PARTS)

					RES.		Non-Residential (m2)
		STUDIO	1B	2B	3B	Visitor	Non-Residential (IIIZ)
	MIN. RATIO	N/A	N/A	N/A	N/A	2 + 0.05	N/#
BLDG. C	MIN. COUNT	N/A	N/A	N/A	N/A		8 N/#
BLDG. C						5 for the first 5 units, 0.1 per unit for the	
	MAX. RATIO	0.8	0.9	1	1.2	sixth and subsequent units	3.5/100
	MAX. COUNT		150	34	27	26	5 17
	TOTAL					237	1
*PARKING ZONE(ALL OTHER PARTS)						

100E00ID	
BLDG A	U/G 1
DLDG A	U/G 2
	U/G 3
	TOTA
Last Update	ed: Mor

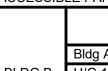


	FLOOR	US	TOTAL	
	FLOOK	RESIDENTIAL	NON-RESIDENTIAL	TOTAL
	Bldg A_Floor 1		1	1
BLDG B	U/G 1	4		4
	U/G 2	2		2
	U/G 3	2		2
	TOTAL	8	1	9
Last Update	ed: Monday, 22 April 2024	16:07:26 PM		


ACCESSIB	LE PARKING PROVIDED			
	FLOOR	U	TOTAL	
	FLOOK	RESIDENTIAL	NON-RESIDENTIAL	TOTAL
	U/G 1	3	1	4
BLDG C	U/G 2	2		2
	U/G 3	2		2
	U/G 3.5			
	TOTAL	7	1	8
1 6 1 1 1 . 6	adı Maraday (20 Aravil 2004)	40.07.04 DM		

	RATIO		USE	SPACES
			RES. UNITS/SQM	
		0.9/1B UNIT	834	751
BLDG	RES.	1.0/2B UNIT	178	178
A+B+C	neo.			
		1.2/3B UNIT	115	138
	VISITOR	0.1/ UNIT	1,127	113
	NON-RES.	1/100SQM	6003.9	60
	TOTAL			1,239

EFFECTIVE VEHICULAR PARKING SPACES

	RATIO		USE	SPACES
			RES. UNITS/SQM	
		0.9/1B UNIT	472	425
	RES.	1.0/2B UNIT	104	104
BLDG A				
		1.2/3B UNIT	65	78
	VISITOR	0.1/ UNIT	641	64
	NON-RES.	1/100SQM	5000	50
	TO	TAL		721

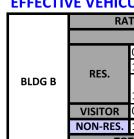

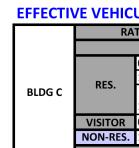

ACCESSIBLE PARKING PROVIDED

FLOOR	0	TOTAL	
FLOOK	RESIDENTIAL	NON-RESIDENTIAL	TOTAL
G 1	4	2	6
G 2	6		6
G 3	6		6
TAL	16	2	18
/londay, 22 April 2024	16:07:22 PM		

ACCESSIBLE PARKING PROVIDED

Last Updated: Monday, 22 April 2024 16:07:31 PM

EFFECTIVE VEHICULAR PARKING SPACES

EFFECTIVE VEHICULAR PARKING SPACES

	USE	SPACES
	RES. UNITS/SQM	
0.9/1B UNIT	195	176
1.0/2B UNIT	40	40
1.2/3B UNIT	27	32
0.1/ UNIT	262	26
1/100SQM	503.1	5
TAL		279

EFFECTIVE VEHICULAR PARKING SPACES

ΓΙΟ	USE	SPACES
	RES. UNITS/SQM	
0.9/1B UNIT	167	150
1.0/2B UNIT	34	34
1.2/3B UNIT	23	28
0.1/ UNIT	224	22
1/100SQM	500.8	5
ΓAL		239

ACCESSIBLE PARKING REQUIRED

	EFFECTIVE PARKING SPACES	RATIO	SPACES
DI DC	BLDG A		18
BLDG A+B+C	BLDG B	5 FOR FIRST 100+1PER	9
Атотс	BLDG C	50 THEREAFTER	8
	TOTAL		35

BUILDING A+B+C	FLOOR		RESIDE	NTIAL	NON-	RESIDENTIAL	TOTAL
			SHORT TERM	LONG TERM	SHORT TERM	LONG TERM	
	FLOOR 1		79	153	19	1	25
	U/G LEVEL 1		0	614	0	8	62
	TOTAL		79	767	19	9	87
ARCEL 1+2 BIKE P	ARKING RATIO		(REQUIRED)				
BUILDING A+B+C	ТҮРЕ	RATIO		COUNT		RESIDENTIAL UNIT:	1,12
	RES. SHORT TERM	0.07	per unit	79	•		
	RES. LONG TERM	0.68	per unit	766			
	NON-RES. SHORT TERM	3+0.15	per 100m2	19			
		+ + - +					

PARCEL 1 BIKE PARKING COUNT

BUILDING A+B	FLOOR		RESIDE	INTIAL	NON-	RESIDENTIAL	TOTAL
			SHORT TERM	LONG TERM	SHORT TERM	LONG TERM	
	FLOOR 1		63	0	15	0	78
	U/G LEVEL 1		0	614	0	8	622
	TOTAL		63	614	15	8	700
PARCEL 1 BIKE PARK	ING RATIO		(REQUIRED)				
BUILDING A+B	ТҮРЕ	R	ATIO	COUNT		RESIDENTIAL UNIT:	903
	RES. SHORT TERM	0.07	per unit	63			
	RES. LONG TERM	0.68	per unit	614			
	NON-RES. SHORT TERM	3+0.15	per 100m2	15			
	NON-RES. LONG TERM	0.13	per 100m2	8			

BLDG A BIKE PARKING COUNT

BUILDING A	FLOOR		RESIDE	INTIAL	NON-RESIDENTIAL		TOTAL
			SHORT TERM	LONG TERM	SHORT TERM	LONG TERM	
	FLOOR 1		45	0	11	0	56
	U/G LEVEL 1		0	436	0	7	443
	TOTAL		45	436	11	7	499
BLDG A BIKE PARKI	NG RATIO		(REQUIRED)				
BUILDING A	ТҮРЕ	R	ATIO	COUNT		RESIDENTIAL UNIT:	641
	RES. SHORT TERM	0.07	per unit	45			
	RES. LONG TERM	0.68	per unit	436			
	NON-RES. SHORT TERM	3+0.15	per 100m2	11			
	NON-RES. LONG TERM	0.13	per 100m2	7			
BLDG B BIKE PARKI	NG COUNT		(PROVISION)		-		
BUILDING B	FLOOR		RESIDENTIAL		NON-RESIDENTIAL		TOTAL
			SHORT TERM	LONG TERM	SHORT TERM	LONG TERM	
	FLOOR 1		18		4		22
	U/G LEVEL 1						
	0/G LEVEL I			178		1	
	TOTAL		18		4	1	201
BLDG B BIKE PARKI	TOTAL		18 (REQUIRED)		4	1	201
BLDG B BIKE PARKIN BUILDING B	TOTAL	R				1 1 RESIDENTIAL UNIT:	201 262
	TOTAL NG RATIO		(REQUIRED)	178			
	TOTAL NG RATIO TYPE	0.07 0.68	(REQUIRED) ATIO per unit per unit	178 COUNT			
	TOTAL NG RATIO TYPE RES. SHORT TERM	0.07 0.68	(REQUIRED) ATIO per unit	178 COUNT 18			

PARCEL 2 BIKE PARK	(PROVISION)						
BUILDING C	BUILDING C FLOOR		RESIDENTIAL		NON-RESIDENTIAL		TOTAL
			SHORT TERM	LONG TERM	SHORT TERM	LONG TERM	
	FLOOR 1		16	153	4	1	174
	U/G LEVEL 1						
	TOTAL		16	153	4	1	174
PARCEL 2 BIKE PAR	(ING RATIO		(REQUIRED)				
BUILDING C	ТҮРЕ	R	ATIO	COUNT		RESIDENTIAL UNIT:	224
	RES. SHORT TERM	0.07	per unit	16			
	RES. LONG TERM	0.68	per unit	153			
	NON-RES. SHORT TERM	3+0.15	per 100m2	4			
	NON-RES. LONG TERM	0.13	per 100m2	1			

Turner Fleischer Architects Inc.

TURNER

FLEISCHER

This drawing, as an instrument of service, is provided by and is the property of Turner Fleischer Architects Inc. The contractor must verify and accept responsibility for all dimensions and conditions on site and must notify Turner Fleischer Architects Inc. of any variations from the supplied information. This drawing is not to be scaled. The architect is not responsible for the accuracy of survey, structural, mechanical, electrical, etc., information shown on this drawing. Refer to the appropriate consultant's drawings before proceeding with the work. Construction must conform to all applicable codes and requirements of authorities having jurisdiction. The contractor working from drawings not specifically marked 'For Construction' must assume full responsibility and bear costs for any corrections or damages resulting from his work.


67 Lesmill Road Toronto, ON, M3B 2T8 T 416 425 2222

turnerfleischer.com

(PROVISION)

WITHOUT PREJUDICE 9 2024-06-04 REISSUED FOR SETTLEMENT OFFER MNZ 8 2024-05-16 REISSUED FOR SETTLEMENT OFFER MNZ 7 2024-04-30 ISSUED FOR SETTLEMENT OFFER MNZ 6 2024-04-23 ISSUED FOR DRAFT SETTLEMENT OFFER REVIEW MNZ # DATE DESCRIPTION BY Queenscorp (Royal York) Inc. ROJEC Queen Elizabeth Blvd + Royal York Rd, Toronto, ON 2, 7 and 10 Queen Elizabeth Boulevard, 506, 514, 516, 520, 522 Royal York Rd and 3, 5, 15 Sinclair Street DRAWING STATISTICS (PARKING BREAKDOWN) PROJECT NO. 21.191 PROJECT DATE 2024-06-04 DRAWN BY RYT CHECKED BY MNZ SCALE 1:1

RZ002a 9

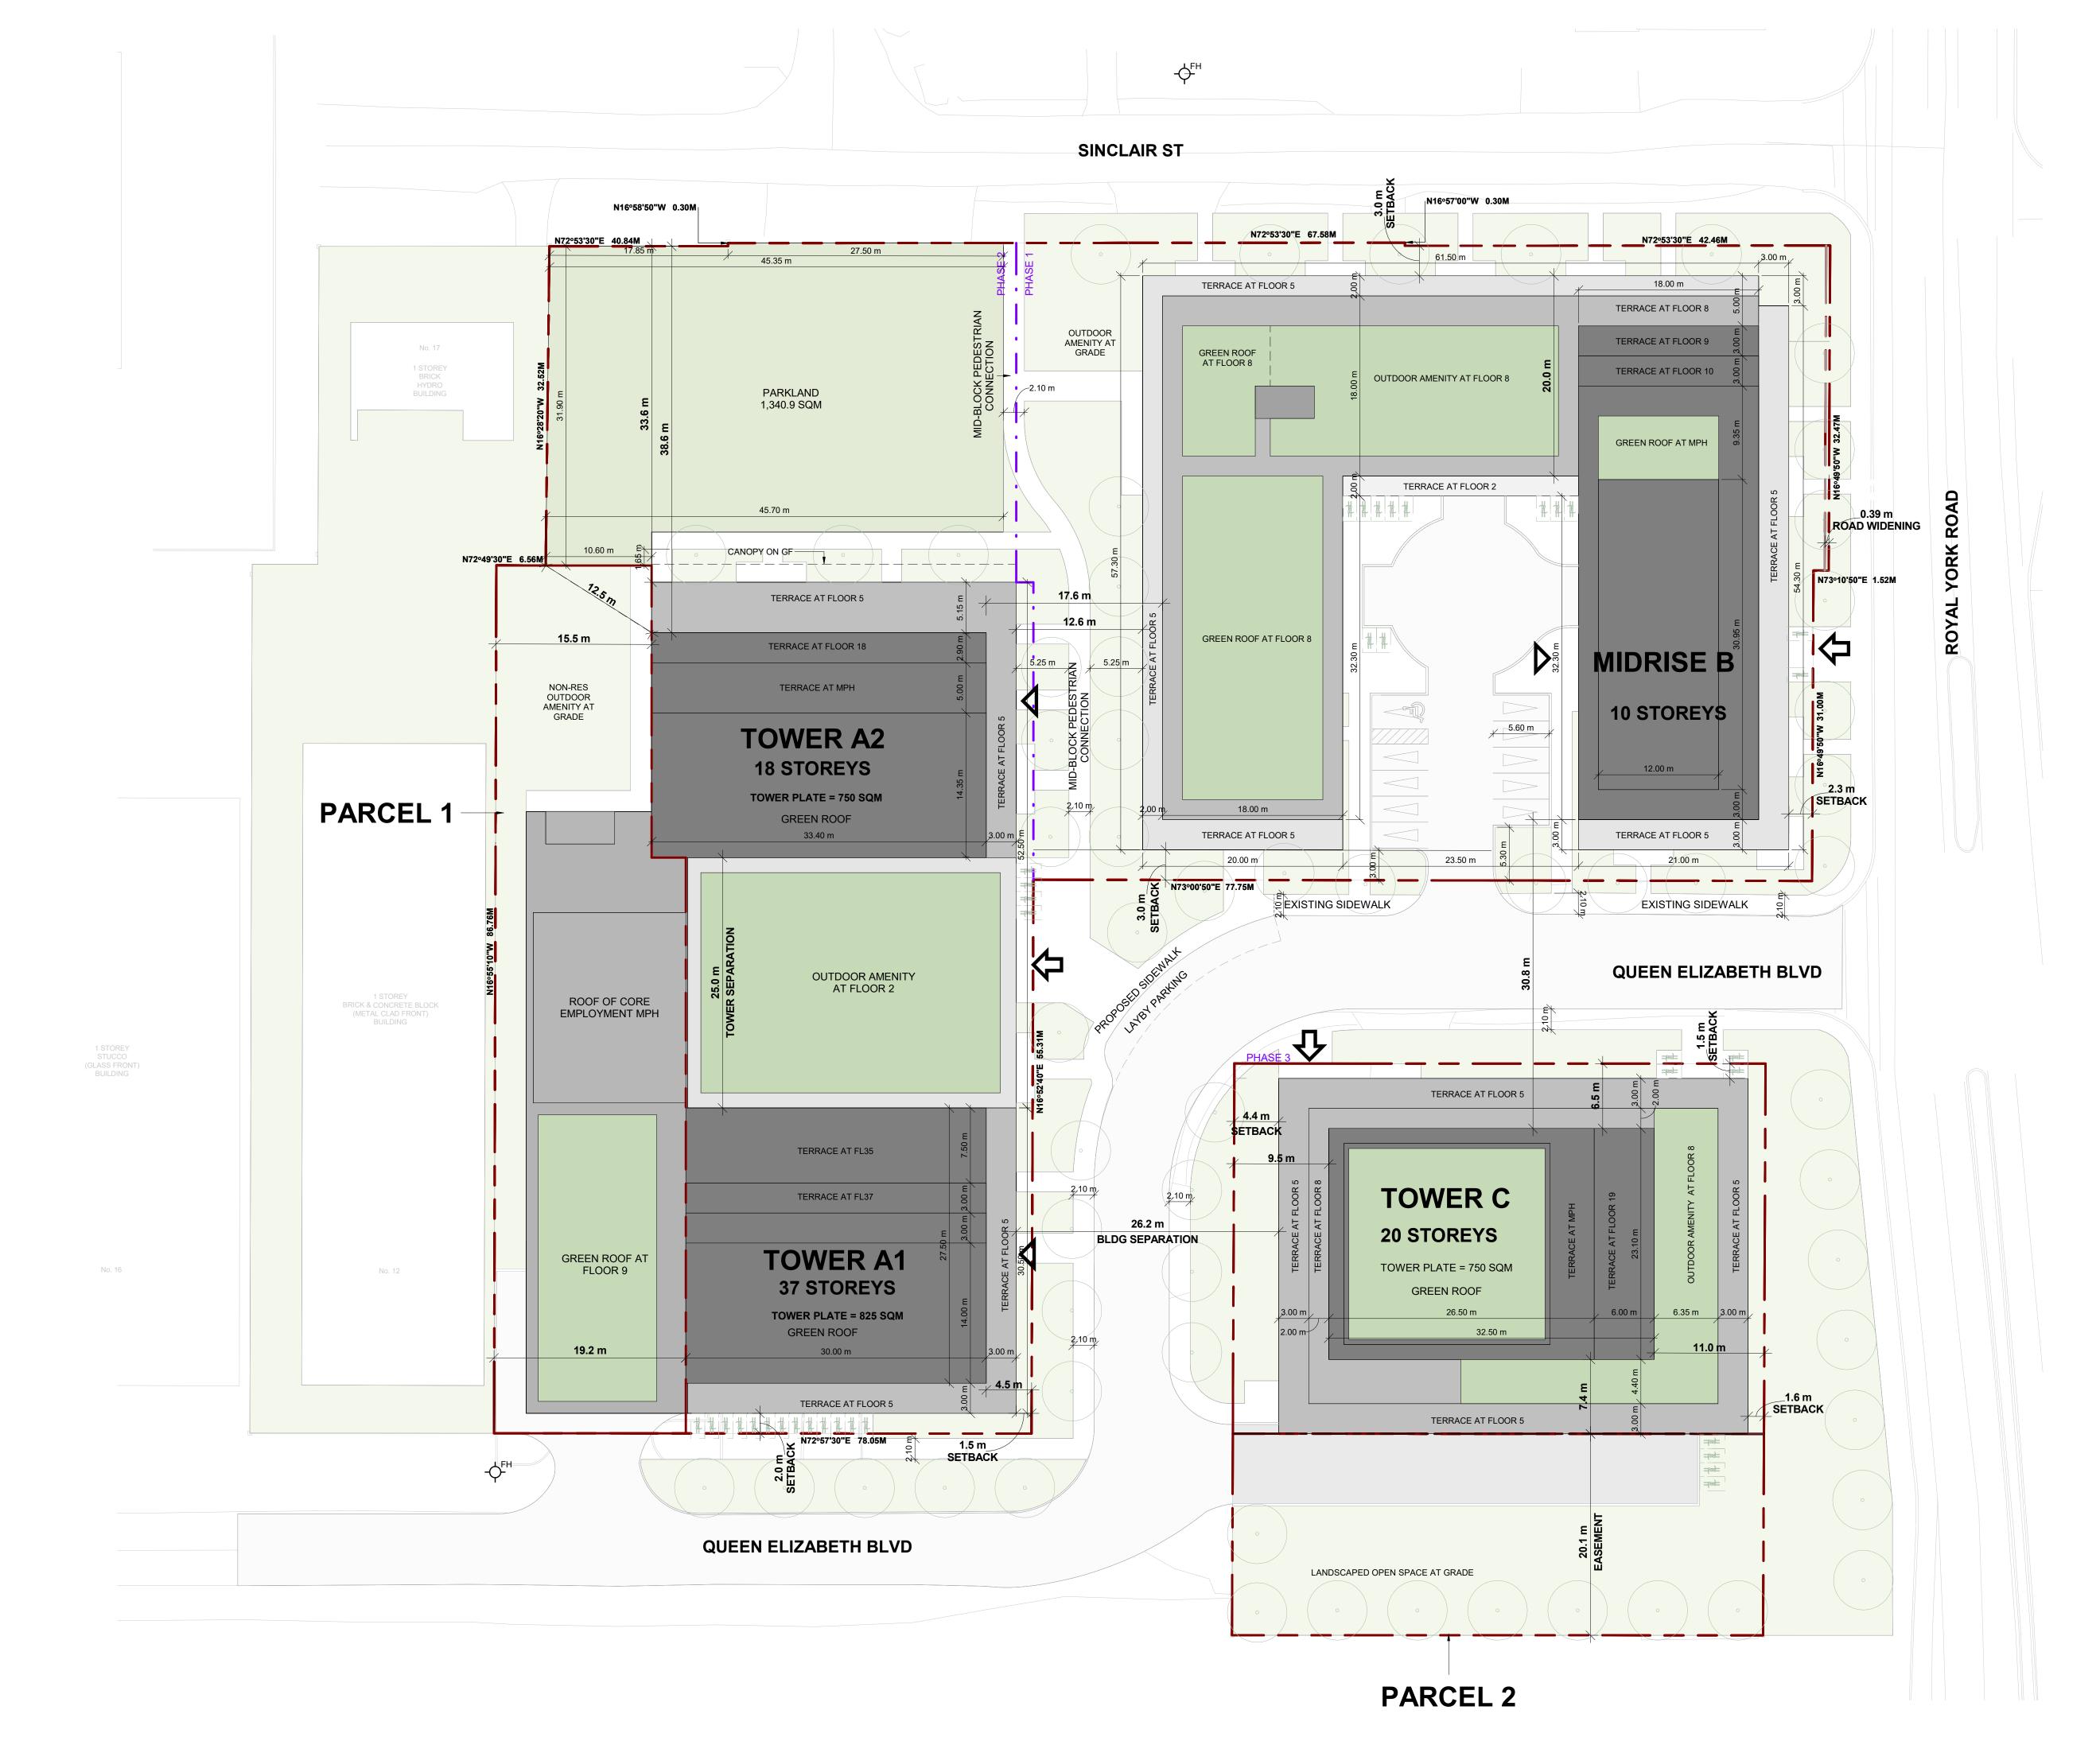


TURNER FLEISCHER Turner Fleischer Architects Inc. 67 Lesmill Road Toronto, ON, M3B 2T8 T 416 425 2222 turnerfleischer.com This drawing, as an instrument of service, is provided by and is the property of Turner Fleischer Architects Inc. The contractor must verify and accept responsibility for all dimensions and conditions on site and must notify Turner Fleischer Architects Inc. of any variations from the supplied information. This drawing is not to be scaled. The architect is not responsible for the accuracy of survey, structural, mechanical, electrical, etc., information shown on this drawing. Refer to the appricable codes and requirements of authorities having jurisdiction. The contractor working from drawings not specifically marked 'For Construction' must assume full responsibility and bear costs for any corrections or damages resulting from his work. The site plan prepared by Turner Fleischer is reliant on a legal survey showing the boundaries of the lands together with the current location of any existing buildings, features or encroachment prepared by Genesis Land Surveying Inc, dated Nov 10, 2021 as provided by Queenscorp (Royal York) Inc.. LEGEND PRIMARY RESIDENTIAL ENTRANCE 分 SECONDARY RESIDENTIAL ENTRANCE ▲ TOWNHOUSE ENTRANCE EXIT EXIT \checkmark SIAMESE CONNECTION \triangleleft CONVEX MIRROR (M) (G) GAS/HYDRO METER WITHOUT PREJUDICE 9 2024-06-04 REISSUED FOR SETTLEMENT OFFER MNZ 8 2024-05-16 REISSUED FOR SETTLEMENT OFFER MNZ 7 2024-04-30 ISSUED FOR SETTLEMENT OFFER MNZ 6 2024-04-23 ISSUED FOR DRAFT SETTLEMENT OFFER MNZ 5 2024-04-101 ISSUED FOR MEDIATION MNZ 4 2024-03-19 ISSUED FOR MEDIATION MNZ 3 2024-02-21 ISSUED FOR REZONING APPLICATION MNZ 2 2022-12-16 ISSUED FOR REZONING APPLICATION AYU 1 2022-05-02 ISSUED FOR REZONING APPLICATION AYU # DATE DESCRIPTION BY Queenscorp (Royal York) Inc. Queen Elizabeth Blvd + Royal York Rd, Toronto, ON 2, 7 and 10 Queen Elizabeth Boulevard, 506, 514, 516, 520, 522 Royal York Rd and 3, 5, 15 Sinclair Street RAWING SITE PLAN / ROOF PLAN PROJECT NO. 21.191 PROJECT DATE 2024-06-04 DRAWN BY RYT CHECKED BY MNZ SCALE As indicated RZ005 9



2024-06-05 6:21:21 PN

TURNER FLEISCHER **Turner Fleischer Architects Inc.** 67 Lesmill Road Toronto, ON, M3B 2T8 T 416 425 2222 turnerfleischer.com This drawing, as an instrument of service, is provided by and is the property of Turner Fleischer Architects Inc. The contractor must verify and accept responsibility for all dimensions and conditions on site and must notify Turner Fleischer Architects Inc. of any variations from the supplied information. This drawing is not to be scaled. The architect is not responsible for the accuracy of survey, structural, mechanical, electrical, etc., information shown on this drawing. Refer to the appropriate consultant's drawings before proceeding with the work. Construction must conform to all applicable codes and requirements of authorities having jurisdiction. The contractor working from drawings not specifically marked 'For Construction' must assume full responsibility and bear costs for any corrections or damages resulting from his work. The site plan prepared by Turner Fleischer is reliant on a legal survey showing the boundaries of the lands together with the current location of any existing buildings, features or encroachment prepared by Genesis Land Surveying Inc, dated Nov 10, 2021 as provided by Queenscorp (Royal York) Inc.. LEGEND PRIMARY RESIDENTIAL ENTRANCE SECONDARY RESIDENTIAL ENTRANCE ▲ TOWNHOUSE ENTRANCE EXIT EXIT Ŷ SIAMESE CONNECTION (M) (G) GAS/HYDRO METER WITHOUT PREJUDICE 9 2024-06-04 REISSUED FOR SETTLEMENT OFFER MNZ 8 2024-05-16 REISSUED FOR SETTLEMENT OFFER MNZ 7 2024-04-30 ISSUED FOR SETTLEMENT OFFER MNZ 6 2024-04-23 ISSUED FOR DRAFT SETTLEMENT OFFER REVIEW MNZ 5 2024-04-01 ISSUED FOR MEDIATION MNZ 4 2024-03-19 ISSUED FOR MEDIATION MNZ 3 2024-02-21 ISSUED FOR MEDIATION MNZ 2 2022-12-16 ISSUED FOR REZONING APPLICATION AYU 1 2022-05-02 ISSUED FOR REZONING APPLICATION AYU # DATE DESCRIPTION BY Queenscorp (Royal York) Inc. ROJEC Queen Elizabeth Blvd + Royal York Rd, Toronto, ON 2, 7 and 10 Queen Elizabeth Boulevard, 506, 514, 516, 520, 522 Royal York Rd and 3, 5, 15 Sinclair Street DRAWING PHASING PLAN PROJECT NO. 21.191 PROJECT DATE 2024-06-04 DRAWN BY RYT CHECKED BY MNZ SCALE As indicated

RZ005A 9

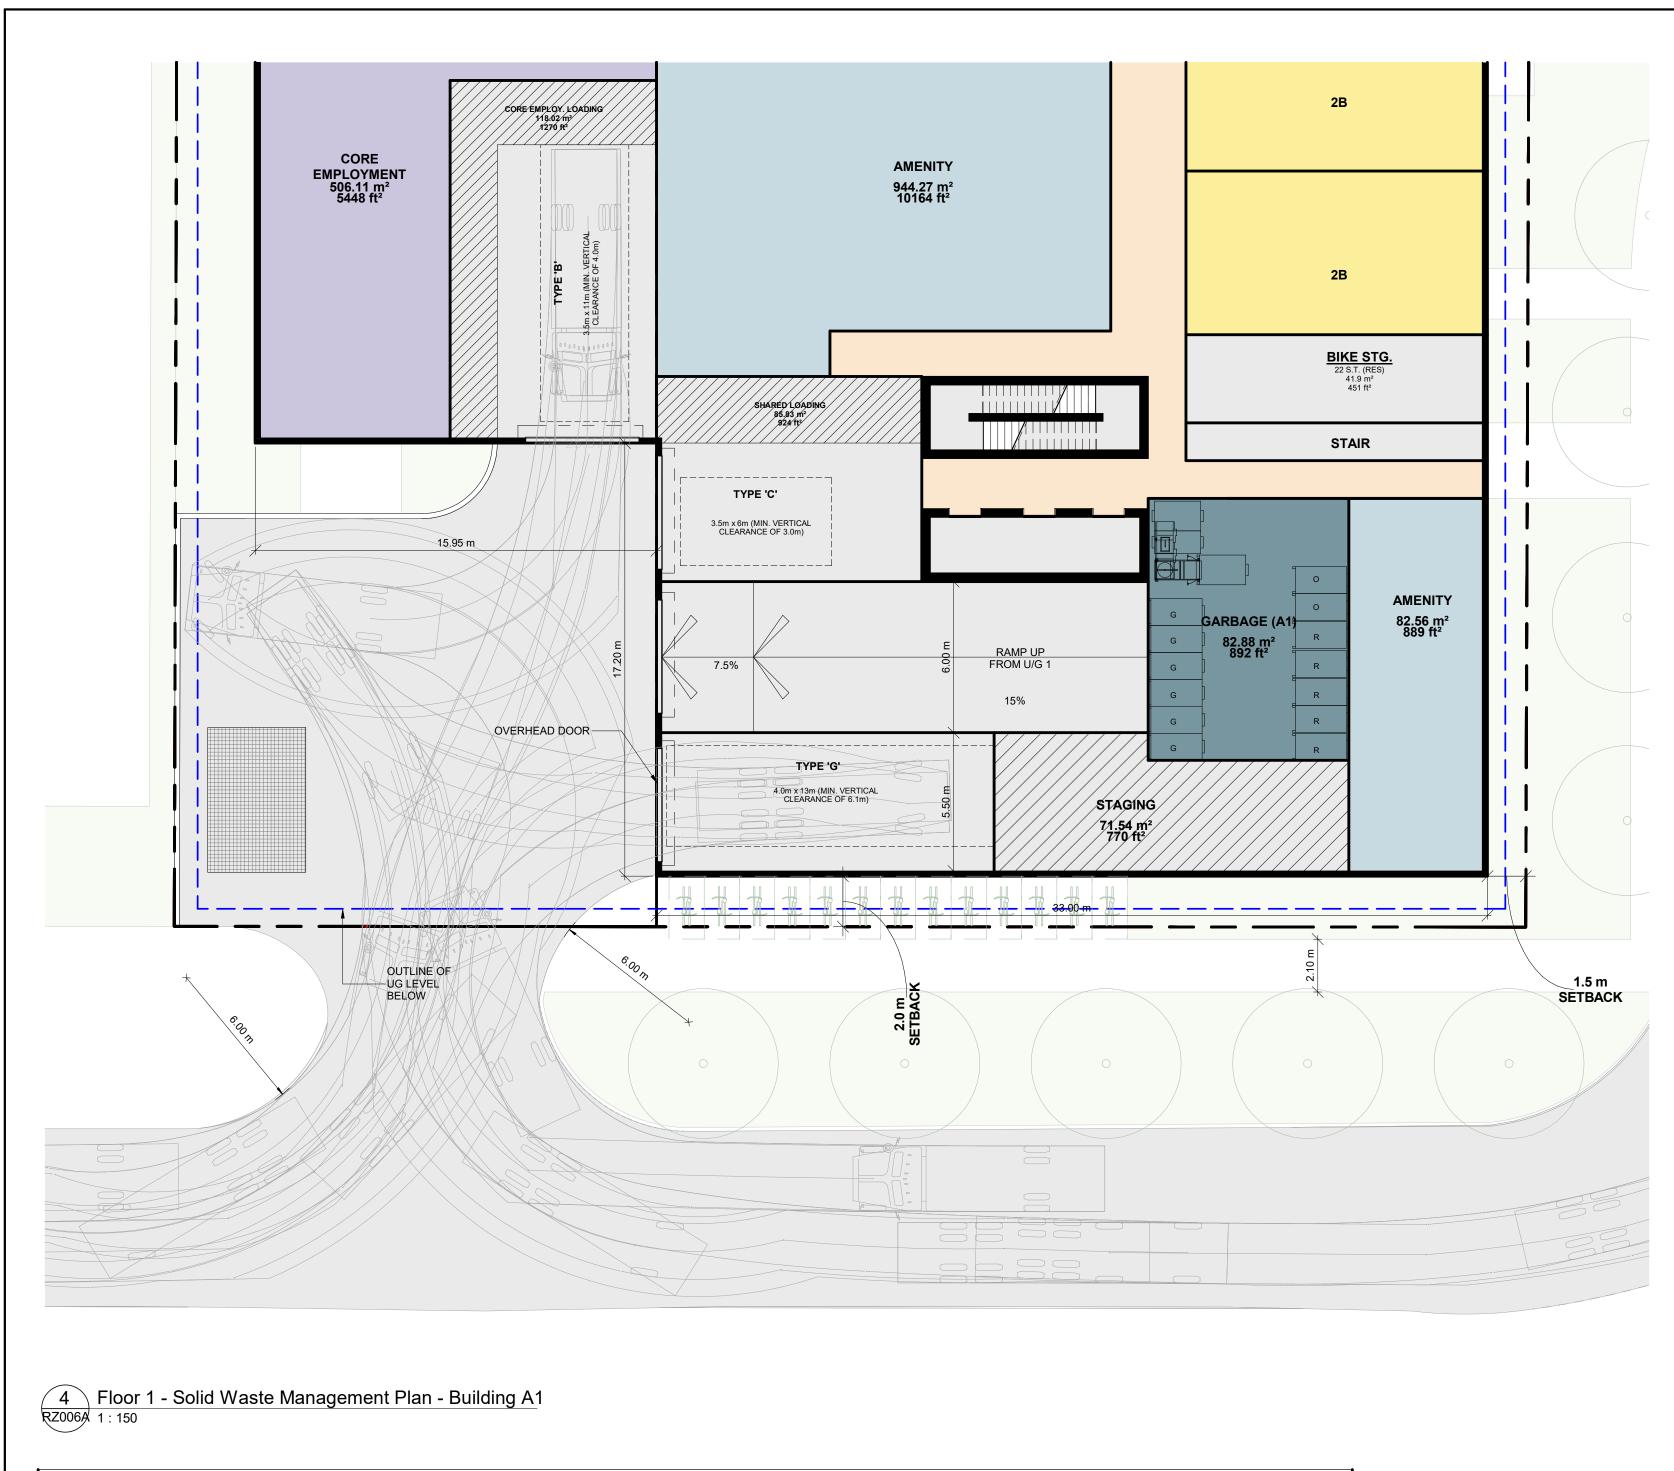

RESIDENTIAL SOLID WASTE MANAGEMENT NOTES:

- ALL ACCESS DRIVEWAYS TO BE USED BY THE COLLECTION VEHICLE WILL BE LEVEL (+/-8%), AT LEAST 4.5 METERS WIDE THROUGHOUT THE SITE AND 6 METERS WIDE AT ENTRANCES 1. AND EXITS, AND WILL HAVE A MINIMUM OVERHEAD TRAVELING CLEARANCE OF 4.4 METERS INCLUDING WHEN TRAVELING THROUGH OVER HEAD DOORS.
- TYPE G LOADING SPACE WILL BE AT LEAST 4 METRES WIDE, 13 METRES LONG, WITH AN UNOBSTRUCTED VERTICAL CLEARANCE OF 6.1 METRES, IS LEVEL (+/-2%), AND IS CONSTRUCTED OF AT LEAST 200MM OF REINFORCED CONCRETE.
- A TRAINED ON-SITE STAFF MEMBER WILL BE AVAILABLE TO MANEUVER BIN FOR THE COLLECTION DRIVER AND ALSO ACT AS A FLAG MAN WHEN THE TRUCK IS REVERSING. IN THE 3. EVENT THE ON-SITE STAFF IS UNAVAILABLE AT THE TIME THE CITY COLLECTION VEHICLES ARRIVE AT THE SITE, THE COLLECTION VEHICLE WILL LEAVE THE SITE AND NOT RETURN UNTIL THE NEXT SCHEDULED COLLECTION DAY.
- SHARING OF TYPE G LOADING SPACE RESIDENTIAL USE OF LOADING SPACE FOR PURPOSES OF MOVING WILL BE SCHEDULED ACCORDING TO GARBAGE PICK UP TIMES. SHOULD THE 4 TYPE G SPACE BE NEEDED FOR USE BY COMMERCIAL SECTORS, THE COMMERCIAL COMPONENT MUST ARRANGE THIS USE SUCH THAT IT DOES NOT CONFLICT WITH ANY RESIDENTIAL USES.
- IF THE LOADING AREA / EGRESS ROUTES ARE OVER SUPPORTED STRUCTURES, IE. OVER AN UNDERGROUND GARAGE OR A MECHANICAL SHAFT, THE FACILITY MUST CONFORM TO THE 5. FOLLOWING:
- DESIGN CODE- ONTARIO BUILDING CODE. ii. DESIGN LOAD- CITY BULK LIFT VEHICLE IN ADDITION BUILDING CODE REQUIREMENTS.
- iii. IMPACT FACTOR- 5% FOR MAXIMUM VEHICULAR SPEEDS TO 15 KM/H AND 30% FOR HIGHER SPEEDS.
- iv. CITY COLLECTION VEHICLE IS REQUIRED TO DRIVE ONTO OR OVER A SUPPORTED STRUCTURE (SUCH AS AN UNDERGROUND PARKING GARAGE). THE UNDERGROUND PARKING GARAGE ROOF SLAB IS TO BE DESIGNED TAKING INTO ACCOUNT THE COLLECTION VEHICLE WEIGHT. THE CITY MUST PROVIDE, PRIOR TO COMMENCEMENT OF CITY SOLID WASTE PICK UP, A LETTER CERTIFIED BY A QUALIFIED ENGINEER THAT THE STRUCTURE CAN SAFELY SUPPORT A FULLY LOADED COLLECTION VEHICLE WEIGHING 35,000 KILOGRAMS.
- PRIVATE CONTRACTOR MUST COLLECT ALL SOLID WASTE FROM THE RETAIL COMPONENT. 6.
- WASTE BINS TO BE JOCKEYED ON COLLECTION DAY, IF REQUIRED. STAFF JOCKEYING THE BINS DURING SOLID WASTE PICK UP AND THE REQUIRED STAGING AREA IS TO BE LOCATED IN CLOSE PROXIMITY TO THE LOADING AREA TO AVOID ANY DELAYS DURING PICK UP. 8.
- NON-RESIDENTIAL COMPONENT WILL ONLY SCHEDULE USE OF THE TYPE G LOADING SPACE ON OPPOSITE DAYS FROM THE COLLECTION DAYS OF THE RESIDENTIAL COMPONENT TO ENSURE THAT THE TYPE G LOADING SPACE WILL BE VACANT FOR CITY WASTE COLLECTION. IF LOADING SPACE IS TO BE SHARED, THE COMMERCIAL BINS MUST BE LABELLED "RETAIL WASTE ONLY"



1 U/G 1 - Solid Waste Management Plan - Building A2 RZ006A 1:150

DESIDENTIAL WASTE MANACEMENT CALCULATIONS

TOWER A - 641 RESIDENTIAL UNITS		
RESIDENTIAL WASTE STORAGE AREA REQUIRED:	NUMBER OF BINS REQUIRED:	LOADING SPACE(S) REQUIRED:
 1a) MINIMUM 25 m² FOR THE FIRST 50 UNITS 1b) .26 m² FOR EACH ADDITIONAL UNIT OVER 50 2) MINIMUM OF 10 m² FOR OVERSIZED ITEMS, AND ITEMS ELEGIBLE FOR SPECIAL COLLECTION SERVICES 3) MINIMUM OF 1 m² PER 100 UNITS FOR HOUSEHOLD HAZARDOUS WASTE STORAGE AND/OR ADDITIONAL DIVERSION PROGRAMS 1) NUMBER OF UNITS = 641: 1a) 25m²; WITH 591 UNITS OVER 50 1b) 591 UNITS * .26m² = 153.66m² => 1a) + 1b) = 25m² + 153.66m² = 178.66m² 2) OVERSIZED ITEMS, AND ITEMS ELEGIBLE FOR SPECIAL COLLECTION SERVICES: 10m² + 178.66m² = 188.66m² 3) HOUSEHOLD HAZARDOUS WASTE STORAGE AND/OR ADDITIONAL DIVERSION PROGRAMS: 1 m² PER 100 UNITS + 188.66m² = 7.00m² + 188.66m² = 195.66m² TOTAL WASTE STORAGE AREA REQUIRED: = 195.66m² WASTE STORAGE AREA PROVIDED: RESIDENTIAL: 252.12m² 	GARBAGE WASTE BINS: (@ 1 BIN PER 50 UNITS = 641/50 = 12.82 (ROUND UP TO 13) = 13 BINS RECYCLING BINS: (@ 1 BIN PER 50 UNITS = 641/50 = 12.82 (ROUND UP TO 13) = 13 BINS ORGANIC BINS: (@ 1 BIN PER 100 UNITS = 641/100 = 6.41 (ROUND UP TO 7) = 7 BINS TOTAL NUMBER OF BINS REQUIRED: = 13 GARBAGE + 13 RECYLCING + 7 ORGANIC = 33 BINS NUMBER OF BINS PROVIDED: GARBAGE WASTE BINS (G): 13 RECYCLING BINS (R): 13 ORGANIC BINS (O): 7 TOTAL: 33	 BUILDING CONTAINING DWELLING UNITS: 400 DWELLING UNITS OR MORE = 1 TYPE "G" AND TYP "C" TYPE "C" REQUIREMENT MAY BE SATISFIED BY PROVIDING ONE OF THE FOLLOWING: i) TYPE "A"; TYPE "B"; OR A SECOND TYPE "G" LOADING SPACE STANDARDS: i) TYPE "A" LOADING SPACE: MIN. LENGTH OF 170M; MIN. WIDTH OF 3.5M; MIN. VERTICAL CLEARANCE OF 4.4M. ii) TYPE "B" LOADING SPACE: MIN. VERTICAL CLEARANCE OF 4.0M. iii) TYPE "C" LOADING SPACE: MIN. VERTICAL CLEARANCE OF 4.0M. iii) TYPE "C" LOADING SPACE: MIN. VERTICAL CLEARANCE OF 4.0M. iii) TYPE "C" LOADING SPACE: MIN. VERTICAL CLEARANCE OF 3.0M. iv) TYPE "G" LOADING SPACE: MIN. VERTICAL CLEARANCE OF 3.0M. iv) TYPE "G" LOADING SPACE: MIN. VERTICAL CLEARANCE OF 6.1M. LOADING SPACE(S) PROVIDED: RESIDENTIAL: 1 TYPE "G" AND

STAGING AREA REQUIRED:

- 1a) MINUMUM 5m² FOR THE FIRST 50 UNITS 1b) 0.10m² FOR EACH ADDITIONAL UNIT OVER 50
- NUMBER OF UNITS = 641: 1)
- 1a) 5m²; WITH 591 UNITS OVER 50
- 1b) 591 UNITS * .10m² = 59.10m² = 1a) + 1b) = 5m² + 59.10m² = 64.10m²
- TOTAL STAGING AREA REQUIRED:
- 64.10m²
- STAGING AREA PROVIDED: 71.54m²



This drawing, as an instrument of service, is provided by and is the property of Turner Fleischer Architects Inc. The contractor must verify and accept responsibility for all dimensions and conditions on site and must notify Turner Fleischer Architects Inc. of any variations from the supplied information. This drawing is not to be scaled. The architect is not responsible for the accuracy of survey, structural, mechanical, electrical, etc., information shown on this drawing. Refer to the appropriate consultant's drawings before proceeding with the work. Construction must conform to al applicable codes and requirements of authorities having jurisdiction. The contractor working from drawings not specifically marked 'For Construction' must assume full responsibility and bear costs for any corrections or damages resulting from his work.

Turner Fleischer Architects Inc.

67 Lesmill Road Toronto, ON, M3B 2T8 T 416 425 2222 turnerfleischer.com

WITHOUT PREJUDICE

9	2024-06-04	REISSUED FOR SETTLEMENT OFFER	MNZ
8	2024-05-16	REISSUED FOR SETTLEMENT OFFER	MNZ
7	2024-04-30	ISSUED FOR SETTLEMENT OFFER	MNZ
2	2022-12-16	ISSUED FOR REZONING APPLICATION	AYU
1	2022-05-02	ISSUED FOR REZONING APPLICATION	AYU
#	DATE	DESCRIPTION	BY

Queenscorp (Royal York) Inc.

Queen Elizabeth Blvd + Royal York Rd, Toronto, ON

2, 7 and 10 Queen Elizabeth Boulevard, 506, 514, 516, 520, 522 Royal York Rd and 3, 5, 15 Sinclair Street DRAWING

RESIDENTIAL SOLID WASTE MANAGEMENT - BUILDING A

PROJECT NO. 21.191 PROJECT DATE 2024-06-04 DRAWN BY RYT CHECKED BY MNZ SCALE As indicated

RZ006A 9



- CLEARANCE OF 4.4 METERS INCLUDING WHEN TRAVELING THROUGH OVER HEAD DOORS.
- SCHEDULED COLLECTION DAY.
- MECHANICAL SHAFT, THE FACILITY MUST CONFORM TO THE FOLLOWING:
- i. DESIGN CODE- ONTARIO BUILDING CODE. ii. DESIGN LOAD- CITY BULK LIFT VEHICLE IN ADDITION BUILDING CODE REQUIREMENTS.
- VEHICLE WEIGHING 35,000 KILOGRAMS.
- PRIVATE CONTRACTOR MUST COLLECT ALL SOLID WASTE FROM THE RETAIL COMPONENT
- DURING PICK UP.

RESIDENTIAL WASTE MANAGEMENT CALCULA	TIONS
AS PER CITY OF TORONTO REQUIREMENTS FO REDEVELOPMENTS (MAY 2022)	OR GARE

TOWER B - 262 RESIDENTIAL UNITS

RESIDENTIAL WASTE STORAGE AREA REQUIRED:

- 1a) MINIMUM 25 m² FOR THE FIRST 50 UNITS 1b) .26 m² FOR EACH ADDITIONAL UNIT OVER 50 MINIMUM OF 10 m² FOR OVERSIZED ITEMS, AND
- ITEMS ELEGIBLE FOR SPECIAL COLLECTION SERVICES MINIMUM OF 1 m² PER 100 UNITS FOR
- HOUSEHOLD HAZARDOUS WASTE STORAGE AND/OR ADDITIONAL DIVERSION PROGRAMS
- NUMBER OF UNITS = 262: 1a) 25m²;
- WITH 212 UNITS OVER 50 1b) 212 UNITS * .26m² = 55.12m²
- = 1a) + 1b) = 25m² + 55.12m² = 80.12m² OVERSIZED ITEMS, AND ITEMS ELEGIBLE FOR
- SPECIAL COLLECTION SERVICES: 10m² + 80.12m² = 90.12m²
- HOUSEHOLD HAZARDOUS WASTE STORAGE AND/OR ADDITIONAL DIVERSION PROGRAMS: 1 m² PER 100 UNITS + 90.12m² = 3.00m² + 90.12m² =93.12m²

TOTAL WASTE STORAGE AREA REQUIRED: = 93.12m²

WASTE STORAGE AREA PROVIDED: RESIDENTIAL: 163.89m²

STAGING AREA REQUIRED:

- 1a) MINUMUM 5m² FOR THE FIRST 50 UNITS 1b) 0.10m² FOR EACH ADDITIONAL UNIT OVER 50
- NUMBER OF UNITS = 262: 1a) 5m²;
- WITH 212 UNITS OVER 50 1b) 212 UNITS * .10m² = 21.20m²

= 1a) + 1b) = 5m² + 21.20m² = 26.20m² TOTAL STAGING AREA REQUIRED:

26.20m²

STAGING AREA PROVIDED: 36.70m²

Turner Fleischer Architects Inc.

TURNER

FLEISCHER

67 Lesmill Road Toronto, ON, M3B 2T8 T 416 425 2222

turnerfleischer.com This drawing, as an instrument of service, is provided by and is the property of Turner Fleischer Architects Inc. The contractor must verify and accept responsibility for all dimensions and conditions on site and must notify Turner Fleischer Architects Inc. of any variations from the supplied information. This drawing is not to be scaled. The architect is not responsible for the accuracy of survey, structural, mechanical, electrical, etc., information shown on this drawing. Refer to the appropriate consultant's drawings before proceeding with the work. Construction must conform to al applicable codes and requirements of authorities having jurisdiction. The contractor working from drawings not specifically marked 'For Construction' must assume full responsibility and bear costs for any corrections or damages resulting from his work.

RESIDENTIAL SOLID WASTE MANAGEMENT NOTES:

ALL ACCESS DRIVEWAYS TO BE USED BY THE COLLECTION VEHICLE WILL BE LEVEL (+/-8%), AT LEAST 4.5 METERS WIDE THROUGHOUT THE SITE AND 6 METERS WIDE AT ENTRANCES AND EXITS, AND WILL HAVE A MINIMUM OVERHEAD TRAVELING

TYPE G LOADING SPACE WILL BE AT LEAST 4 METRES WIDE. 13 METRES LONG, WITH AN UNOBSTRUCTED VERTICAL CLEARANCE OF 6.1 METRES, IS LEVEL (+/-2%), AND IS CONSTRUCTED OF AT LEAST 200MM OF REINFORCED CONCRETE.

A TRAINED ON-SITE STAFF MEMBER WILL BE AVAILABLE TO MANEUVER BIN FOR THE COLLECTION DRIVER AND ALSO ACT AS A FLAG MAN WHEN THE TRUCK IS REVERSING. IN THE EVENT THE ON-SITE STAFF IS UNAVAILABLE AT THE TIME THE CITY COLLECTION VEHICLES ARRIVE AT THE SITE, THE COLLECTION VEHICLE WILL LEAVE THE SITE AND NOT RETURN UNTIL THE NEXT

SHARING OF TYPE G LOADING SPACE - RESIDENTIAL USE OF LOADING SPACE FOR PURPOSES OF MOVING WILL BE SCHEDULED ACCORDING TO GARBAGE PICK UP TIMES. SHOULD THE TYPE G SPACE BE NEEDED FOR USE BY COMMERCIAL SECTORS, THE COMMERCIAL COMPONENT MUST ARRANGE THIS USE SUCH THAT IT DOES NOT CONFLICT WITH ANY RESIDENTIAL USES.

5. IF THE LOADING AREA / EGRESS ROUTES ARE OVER SUPPORTED STRUCTURES, IE. OVER AN UNDERGROUND GARAGE OR A

iii. IMPACT FACTOR- 5% FOR MAXIMUM VEHICULAR SPEEDS TO 15 KM/H AND 30% FOR HIGHER SPEEDS. iv. CITY COLLECTION VEHICLE IS REQUIRED TO DRIVE ONTO OR OVER A SUPPORTED STRUCTURE (SUCH AS AN UNDERGROUND PARKING GARAGE). THE UNDERGROUND PARKING GARAGE ROOF SLAB IS TO BE DESIGNED TAKING INTO ACCOUNT THE COLLECTION VEHICLE WEIGHT. THE CITY MUST PROVIDE, PRIOR TO COMMENCEMENT OF CITY SOLID WASTE PICK UP, A LETTER CERTIFIED BY A QUALIFIED ENGINEER THAT THE STRUCTURE CAN SAFELY SUPPORT A FULLY LOADED COLLECTION

WASTE BINS TO BE JOCKEYED ON COLLECTION DAY, IF REQUIRED. STAFF JOCKEYING THE BINS DURING SOLID WASTE PICK UP AND THE REQUIRED STAGING AREA IS TO BE LOCATED IN CLOSE PROXIMITY TO THE LOADING AREA TO AVOID ANY DELAYS

NON-RESIDENTIAL COMPONENT WILL ONLY SCHEDULE USE OF THE TYPE G LOADING SPACE ON OPPOSITE DAYS FROM THE COLLECTION DAYS OF THE RESIDENTIAL COMPONENT TO ENSURE THAT THE TYPE G LOADING SPACE WILL BE VACANT FOR CITY WASTE COLLECTION. IF LOADING SPACE IS TO BE SHARED, THE COMMERCIAL BINS MUST BE LABELLED "RETAIL WASTE ONLY"

BAGE, RECYCLING, AND ORGANIC COLLECTION SERVICES FOR NEW DEVELOPMENTS AND

NUMBER OF BINS REQUIRED: GARBAGE WASTE BINS: @ 1 BIN PER 50 UNITS = 262/50 = 5.24 (ROUND UP TO 6) = 6 BINS **RECYCLING BINS:** @ 1 BIN PER 50 UNITS = 262/50 = 5.24 (ROUND UP TO 6) = 6 BINS ORGANIC BINS: @ 1 BIN PER 100 UNITS = 262/100 = 2.62 (ROUND UP TO 3) = 3 BINS TOTAL NUMBER OF BINS REQUIRED: = 6 GARBAGE + 6 RECYLCING + 3 ORGANIC = 15 BINS NUMBER OF BINS PROVIDED:

GARBAGE WASTE BINS (G): 6 RECYCLING BINS (R): ORGANIC BINS (O): TOTAL: 15

LOADING SPACE(S) REQUIRED: BUILDING CONTAINING DWELLING UNITS: 31 TO 399 DWELLING UNITS = 1 TYPE "G" LOADING SPACE STANDARDS: TYPE "G" LOADING SPACE: MIN. LENGTH OF 13.0M; MIN. WIDTH OF 4.0M; MIN. VERTICAL CLEARANCE OF 6.1M

LOADING SPACE(S) PROVIDED: RESIDENTIAL: 1 TYPE "G" TOTAL LOADING SPACES:

WITHOUT PREJUDICE

2024-06-04 REISSUED FOR SETTLEMENT OFFER 2024-05-16 REISSUED FOR SETTLEMENT OFFER 2024-04-30 ISSUED FOR SETTLEMENT OFFER 2022-12-16 ISSUED FOR REZONING APPLICATION 2022-05-02 ISSUED FOR REZONING APPLICATION DATE DESCRIPTION

Queenscorp (Royal York) Inc.


Queen Elizabeth Blvd + Royal York Rd, Toronto, ON

2, 7 and 10 Queen Elizabeth Boulevard, 506, 514, 516, 520, 522 Royal York Rd and 3, 5, 15 Sinclair Street

RESIDENTIAL SOLID WASTE MANAGEMENT - BUILDING B

PROJECT NO. 21.191 PROJECT DATE 2024-06-04 DRAWN BY RYT CHECKED BY MNZ SCALE As indicated

RZ006B 9

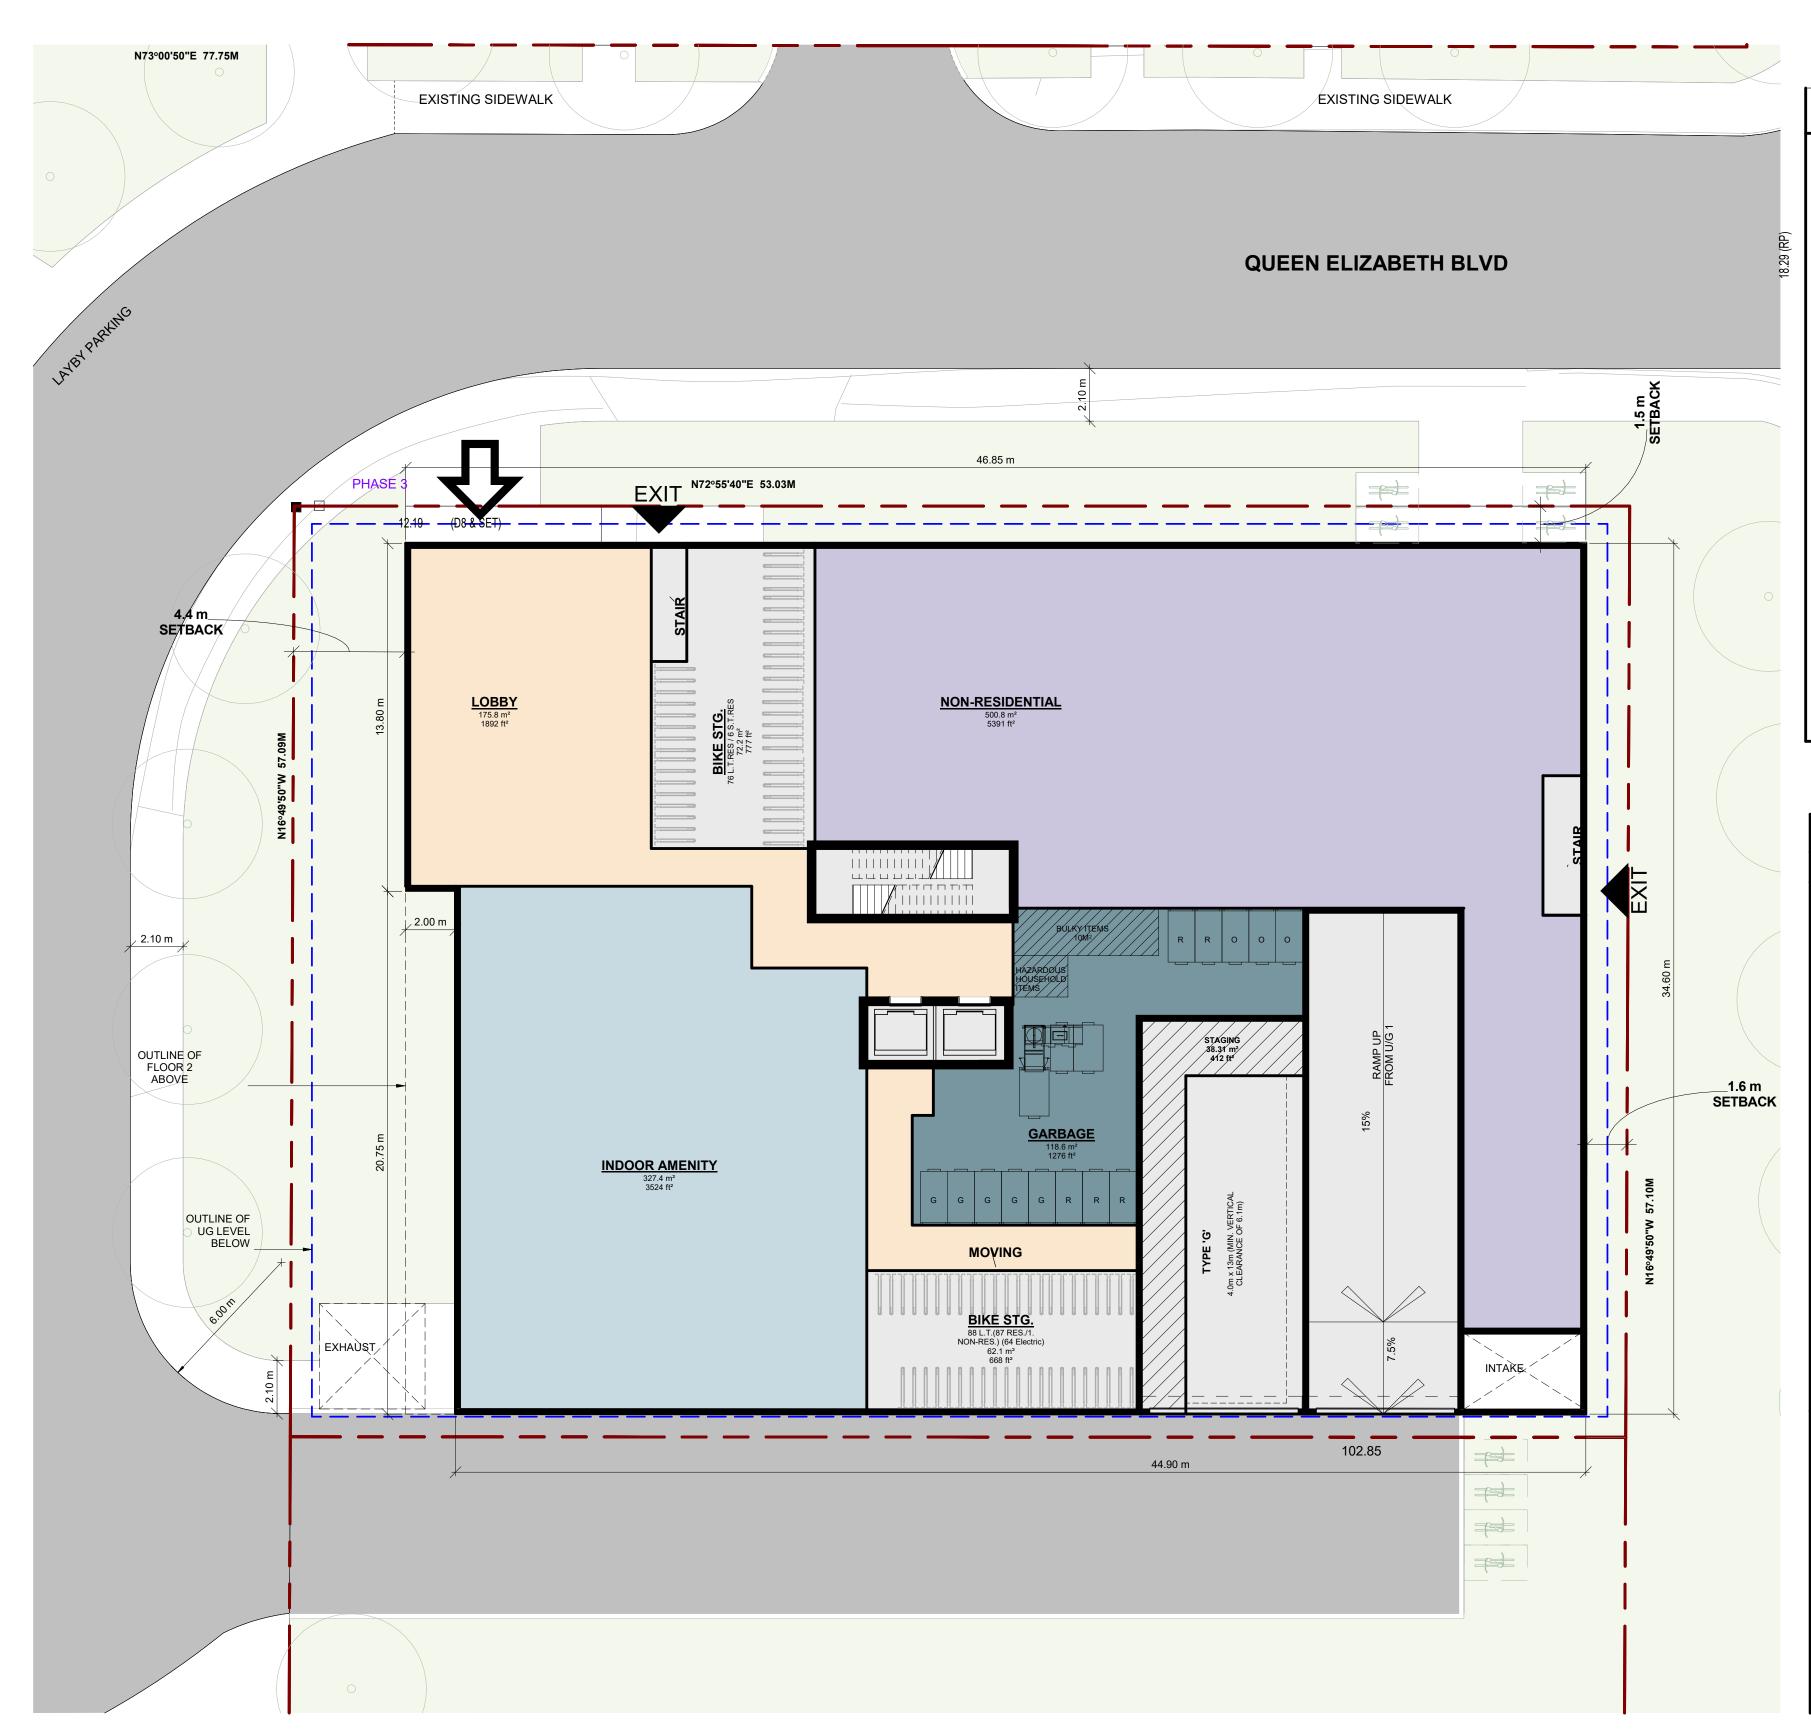

3 Floor 1 - Solid Waste Management Plan - Building C RZ0060 1:150

RESIDENTIAL SOLID WASTE MANAGEMENT NOTES:

- CLEARANCE OF 4.4 METERS INCLUDING WHEN TRAVELING THROUGH OVER HEAD DOORS.
- SCHEDULED COLLECTION DAY.
- MECHANICAL SHAFT, THE FACILITY MUST CONFORM TO THE FOLLOWING:
- i. DESIGN CODE- ONTARIO BUILDING CODE. ii. DESIGN LOAD- CITY BULK LIFT VEHICLE IN ADDITION BUILDING CODE REQUIREMENTS. VEHICLE WEIGHING 35,000 KILOGRAMS.
- PRIVATE CONTRACTOR MUST COLLECT ALL SOLID WASTE FROM THE RETAIL COMPONENT.
- DURING PICK UP.

RESIDENTIAL WASTE MANAGEMENT CALCULATIONS **REDEVELOPMENTS (MAY 2022)**

TOWER C - 224 RESIDENTIAL UNITS

- RESIDENTIAL WASTE STORAGE AREA REQUIRED:
- MINIMUM 25 m² FOR THE FIRST 50 UNITS a) .26 m² FOR EACH ADDITIONAL UNIT OVER 50 MINIMUM OF 10 m² FOR OVERSIZED ITEMS, AND ITEMS ELEGIBLE FOR SPECIAL COLLECTION
- SERVICES MINIMUM OF 1 m² PER 100 UNITS FOR HOUSEHOLD HAZARDOUS WASTE STORAGE AND/OR ADDITIONAL DIVERSION PROGRAMS
- NUMBER OF UNITS = 224:
- 1a) 25m²; WITH 174 UNITS OVER 50
- 1b) 174 UNITS * $.26m^2 = 45.24m^2$ = 1a) + 1b) = 25m² + 45.24m² = 70.24m²
- OVERSIZED ITEMS, AND ITEMS ELEGIBLE FOR SPECIAL COLLECTION SERVICES: $10m^2 + 70.24m^2 = 80.24m^2$
- HOUSEHOLD HAZARDOUS WASTE STORAGE AND/OR ADDITIONAL DIVERSION PROGRAMS: 1 m² PER 100 UNITS + 80.24m² = 3.00m² + 80.24m² =83.24m²

OTAL WASTE STORAGE AREA REQUIRED: = 83.24m²

WASTE STORAGE AREA PROVIDED: RESIDENTIAL: 118.6m²

STAGING AREA REQUIRED:

- 1a) MINUMUM 5m² FOR THE FIRST 50 UNITS 1b) 0.10m² FOR EACH ADDITIONAL UNIT OVER 50
- NUMBER OF UNITS = 224:
- 1a) 5m²; WITH 174 UNITS OVER 50
- b) 174 UNITS * .10m² = 17.40m² = 1a) + 1b) = 5m² + 17.40m² = 22.40m²

TOTAL STAGING AREA REQUIRED: 22.40m²

STAGING AREA PROVIDED: 38.31m²

Turner Fleischer Architects Inc.

TURNER

FLEISCHER

This drawing, as an instrument of service, is provided by and is the property of Turner Fleischer Architects Inc. The contractor must verify and accept responsibility for all dimensions and conditions on site and must notify Turner Fleischer Architects Inc. of any variations from the supplied information. This drawing is not to be scaled. The architect is not responsible for the accuracy of survey, structural, mechanical, electrical, etc., information shown on this drawing. Refer to the appropriate consultant's drawings before proceeding with the work. Construction must conform to al applicable codes and requirements of authorities having jurisdiction. The contractor working from drawings not specifically marked 'For Construction' must assume full responsibility and bear costs for any corrections or damages resulting from his work.

67 Lesmill Road Toronto, ON, M3B 2T8

T 416 425 2222 turnerfleischer.com

ALL ACCESS DRIVEWAYS TO BE USED BY THE COLLECTION VEHICLE WILL BE LEVEL (+/-8%), AT LEAST 4.5 METERS WIDE THROUGHOUT THE SITE AND 6 METERS WIDE AT ENTRANCES AND EXITS, AND WILL HAVE A MINIMUM OVERHEAD TRAVELING

TYPE G LOADING SPACE WILL BE AT LEAST 4 METRES WIDE, 13 METRES LONG, WITH AN UNOBSTRUCTED VERTICAL CLEARANCE OF 6.1 METRES, IS LEVEL (+/-2%), AND IS CONSTRUCTED OF AT LEAST 200MM OF REINFORCED CONCRETE.

A TRAINED ON-SITE STAFF MEMBER WILL BE AVAILABLE TO MANEUVER BIN FOR THE COLLECTION DRIVER AND ALSO ACT AS A FLAG MAN WHEN THE TRUCK IS REVERSING. IN THE EVENT THE ON-SITE STAFF IS UNAVAILABLE AT THE TIME THE CITY COLLECTION VEHICLES ARRIVE AT THE SITE, THE COLLECTION VEHICLE WILL LEAVE THE SITE AND NOT RETURN UNTIL THE NEXT

SHARING OF TYPE G LOADING SPACE - RESIDENTIAL USE OF LOADING SPACE FOR PURPOSES OF MOVING WILL BE SCHEDULED ACCORDING TO GARBAGE PICK UP TIMES. SHOULD THE TYPE G SPACE BE NEEDED FOR USE BY COMMERCIAL SECTORS, THE COMMERCIAL COMPONENT MUST ARRANGE THIS USE SUCH THAT IT DOES NOT CONFLICT WITH ANY RESIDENTIAL USES.

IF THE LOADING AREA / EGRESS ROUTES ARE OVER SUPPORTED STRUCTURES, IE. OVER AN UNDERGROUND GARAGE OR A

iii. IMPACT FACTOR- 5% FOR MAXIMUM VEHICULAR SPEEDS TO 15 KM/H AND 30% FOR HIGHER SPEEDS. iv. CITY COLLECTION VEHICLE IS REQUIRED TO DRIVE ONTO OR OVER A SUPPORTED STRUCTURE (SUCH AS AN UNDERGROUND PARKING GARAGE). THE UNDERGROUND PARKING GARAGE ROOF SLAB IS TO BE DESIGNED TAKING INTO ACCOUNT THE COLLECTION VEHICLE WEIGHT. THE CITY MUST PROVIDE, PRIOR TO COMMENCEMENT OF CITY SOLID WASTE PICK UP, A LETTER CERTIFIED BY A QUALIFIED ENGINEER THAT THE STRUCTURE CAN SAFELY SUPPORT A FULLY LOADED COLLECTION

WASTE BINS TO BE JOCKEYED ON COLLECTION DAY, IF REQUIRED. STAFF JOCKEYING THE BINS DURING SOLID WASTE PICK UP AND THE REQUIRED STAGING AREA IS TO BE LOCATED IN CLOSE PROXIMITY TO THE LOADING AREA TO AVOID ANY DELAYS

NON-RESIDENTIAL COMPONENT WILL ONLY SCHEDULE USE OF THE TYPE G LOADING SPACE ON OPPOSITE DAYS FROM THE COLLECTION DAYS OF THE RESIDENTIAL COMPONENT TO ENSURE THAT THE TYPE G LOADING SPACE WILL BE VACANT FOR CITY WASTE COLLECTION. IF LOADING SPACE IS TO BE SHARED, THE COMMERCIAL BINS MUST BE LABELLED "RETAIL WASTE ONLY"

AS PER CITY OF TORONTO REQUIREMENTS FOR GARBAGE, RECYCLING, AND ORGANIC COLLECTION SERVICES FOR NEW DEVELOPMENTS AND

NUMBER OF BINS REQUIRED: GARBAGE WASTE BINS: @ 1 BIN PER 50 UNITS = 224/50 = 4.48 (ROUND UP TO 5)

= 5 BINS RECYCLING BINS:

@ 1 BIN PER 50 UNITS = 224/50 = 4.48 (ROUND UP TO 5) = 5 BINS

ORGANIC BINS: @ 1 BIN PER 100 UNITS = 224/100 = 2.24 (ROUND UP TO 3)

= 3 BINS TOTAL NUMBER OF BINS REQUIRED:

= 5 GARBAGE + 5 RECYLCING + 3 ORGANIC = 13 BINS

NUMBER OF BINS PROVIDED:

GARBAGE WASTE BINS (G): 5 RECYCLING BINS (R): ORGANIC BINS (O): TOTAL: 13

OADING SPACE(S) REQUIRED: BUILDING CONTAINING DWELLING UNITS: 31 TO 399 DWELLING UNITS = 1 TYPE "G"

LOADING SPACE STANDARDS: TYPE "G" LOADING SPACE: MIN. LENGTH OF 13.0M: MIN. WIDTH OF 4.0M; MIN. VERTICAL CLEARANCE OF 6.1M.

LOADING SPACE(S) PROVIDED: RESIDENTIAL: 1 TYPE "G"

TOTAL LOADING SPACES:

WITHOUT PREJUDICE

2024-06-04 REISSUED FOR SETTLEMENT OFFER
 2024-05-16
 REISSUED FOR SETTLEMENT OFFER

 2024-04-30
 ISSUED FOR SETTLEMENT OFFER

 2
 2022-12-16
 ISSUED FOR REZONING APPLICATION

 1
 2022-05-02
 ISSUED FOR REZONING APPLICATION

 #
 DATE
 DESCRIPTION

Queenscorp (Royal York) Inc.

Queen Elizabeth Blvd + Royal York Rd, Toronto, ON


2, 7 and 10 Queen Elizabeth Boulevard, 506, 514, 516, 520, 522 Royal York Rd and 3, 5, 15 Sinclair Street

RESIDENTIAL SOLID WASTE MANAGEMENT - BUILDING C

PROJECT NO. 21.191 PROJECT DATE 2024-06-04 DRAWN BY RYT CHECKED BY MNZ

SCALE As indicated

RZ006C 9

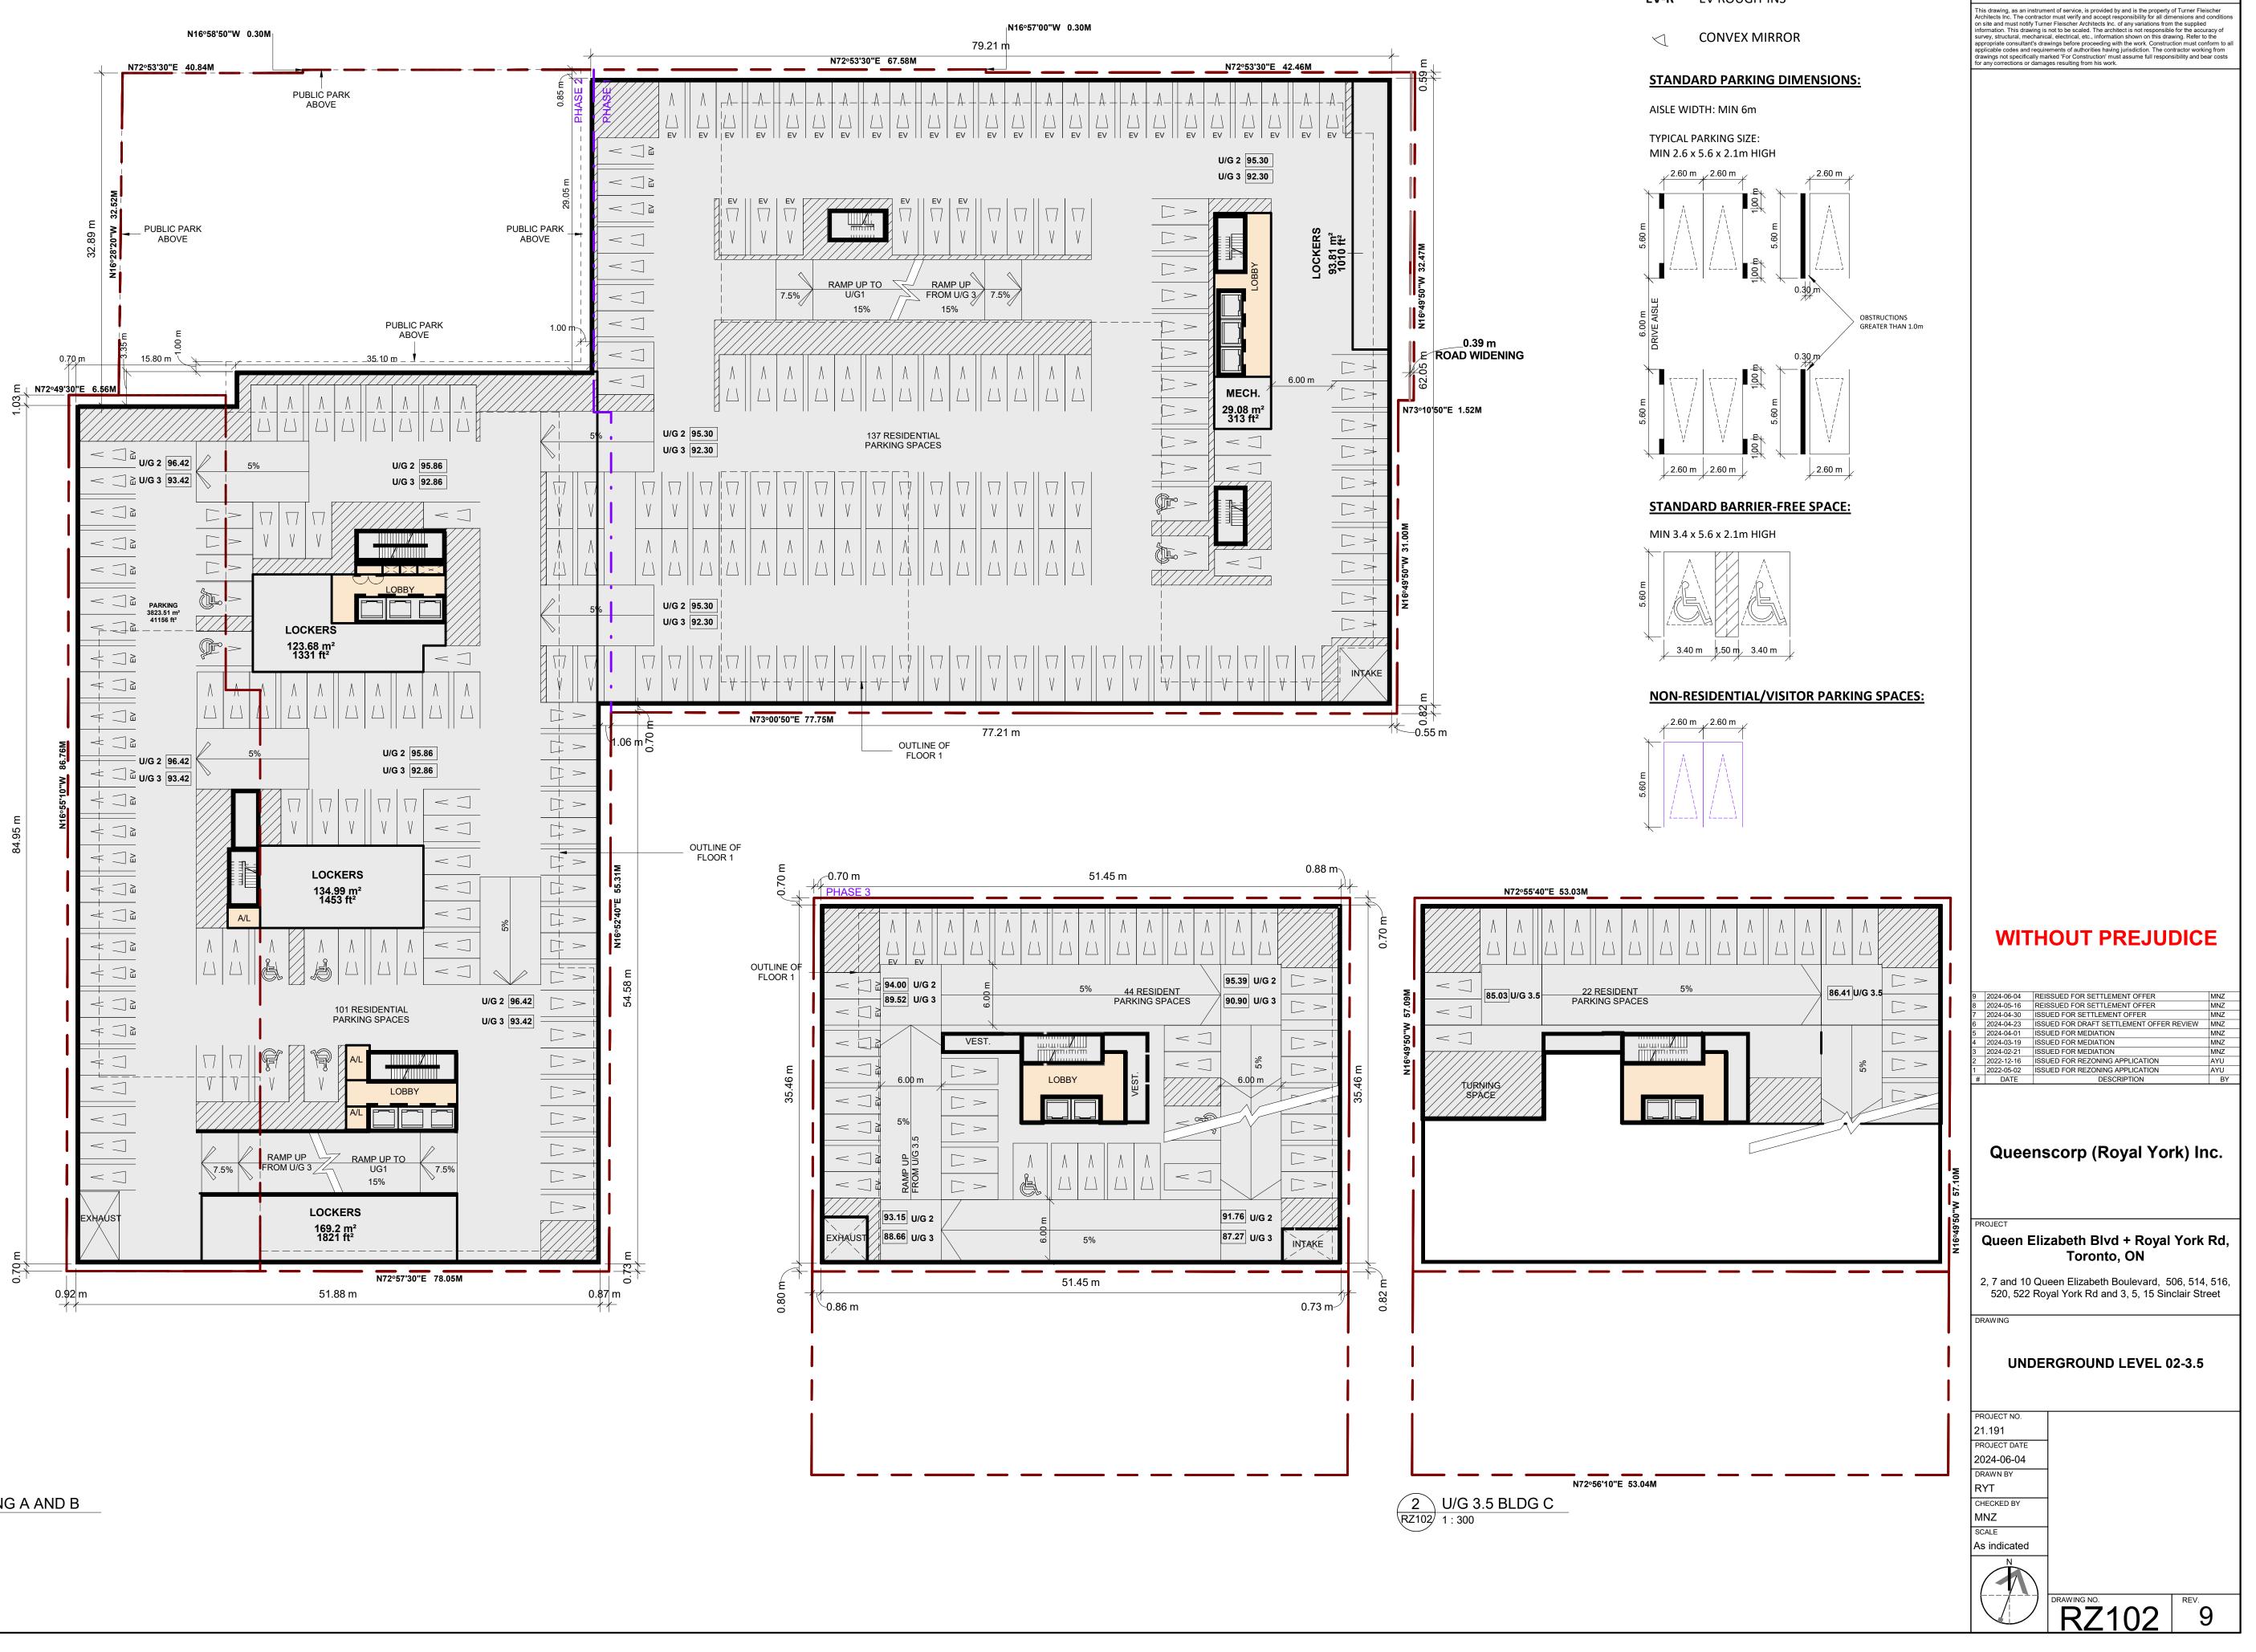

TURNER FLEISCHER

Turner Fleischer Architects Inc.

67 Lesmill Road


Toronto, ON, M3B 2T8 T 416 425 2222 turnerfleischer.com

PARKING LEGEND

EV

EVSE PARKING

EV-R EV ROUGH-INS

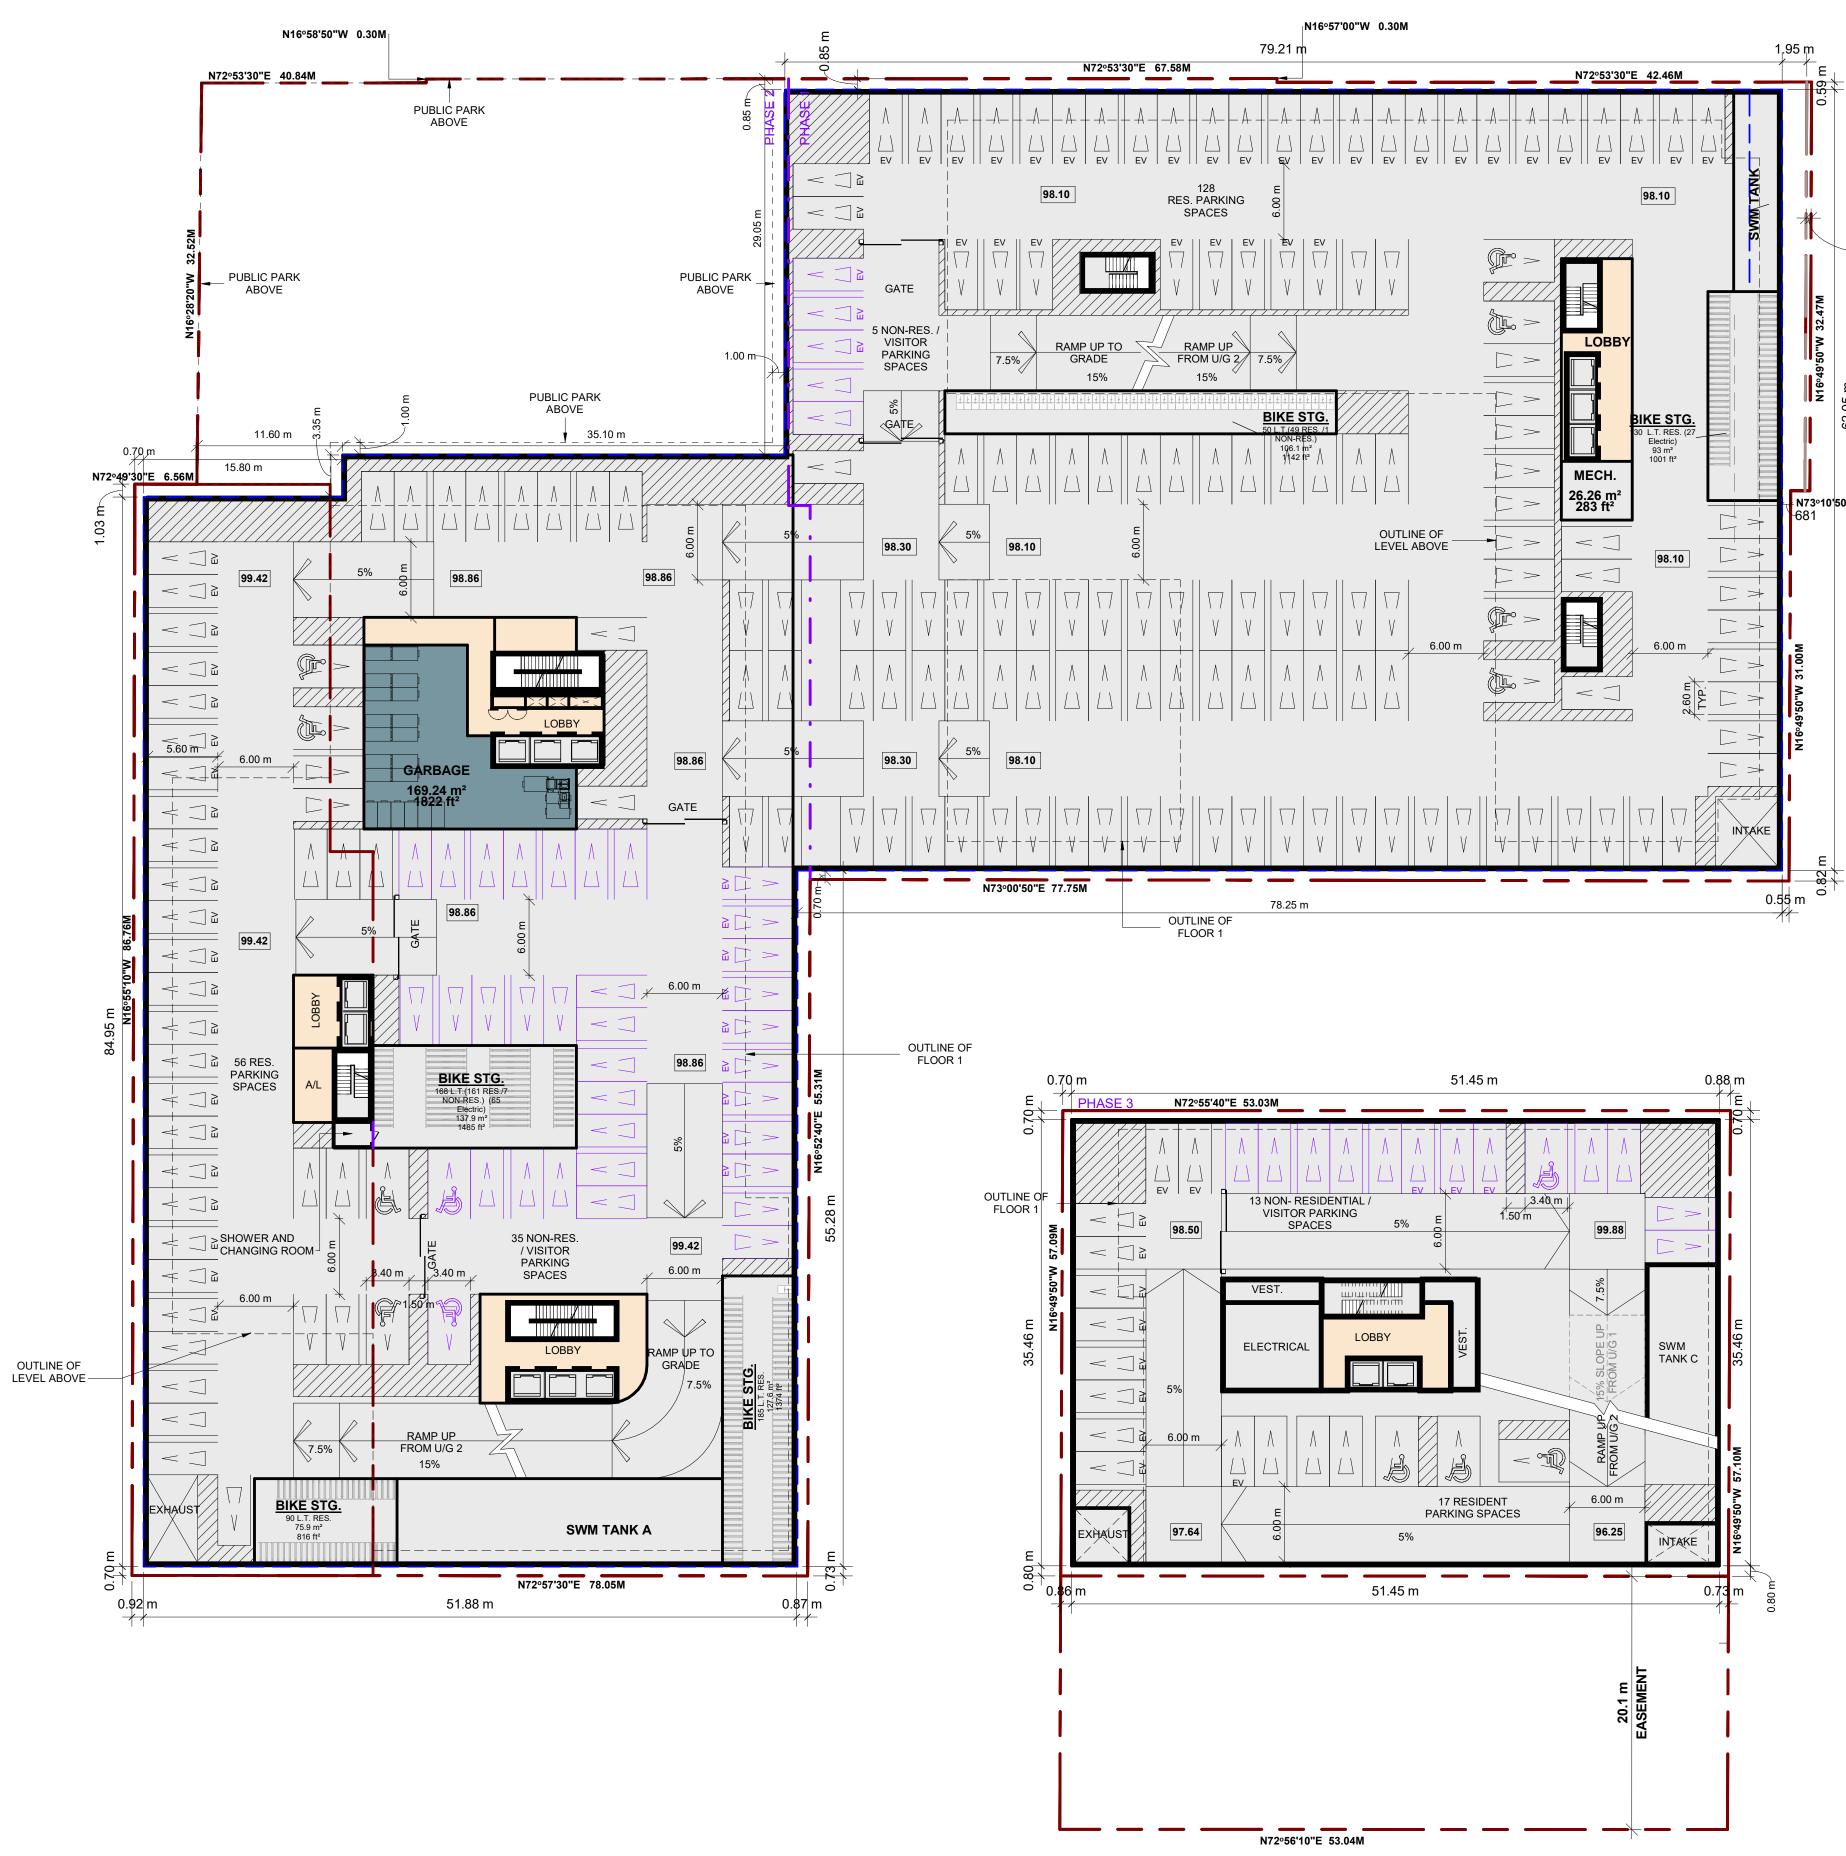

PARKING LEGEND

EV	EVSE PARKING


EV-R EV ROUGH-INS


CONVEX MIRROR \triangleleft

STANDARD PARKING DIMENSIONS:


AISLE WIDTH: MIN 6m

TYPICAL PARKING SIZE:

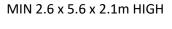


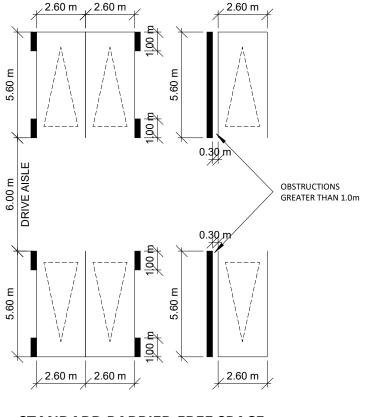


STANDARD BARRIER-FREE SPACE:

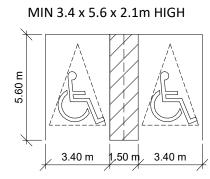

NON-RESIDENTIAL/VISITOR PARKING SPACES:

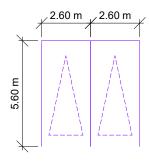

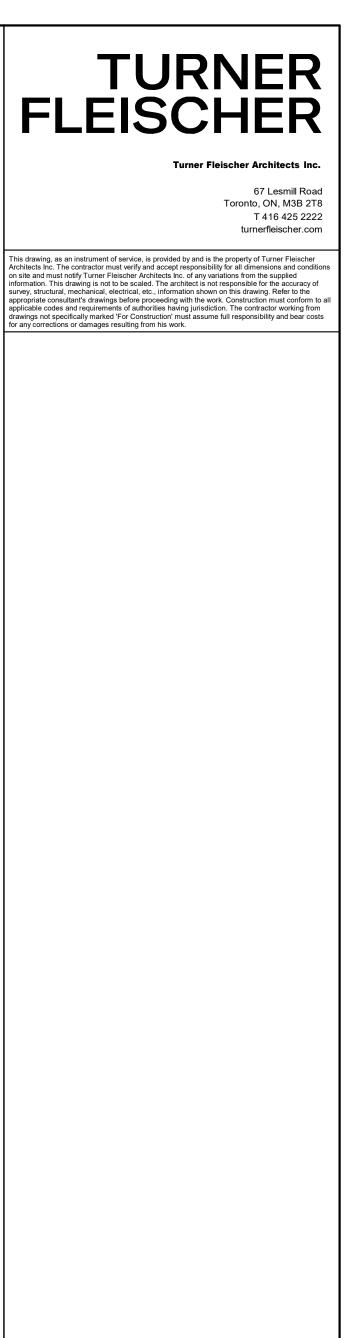

WITHOUT PREJUDICE

9	2024-06-04	REISSUED FOR SETTLEMENT OFFER	MNZ
8	2024-05-16	REISSUED FOR SETTLEMENT OFFER	MNZ
7	2024-04-30	ISSUED FOR SETTLEMENT OFFER	MNZ
6	2024-04-23	ISSUED FOR DRAFT SETTLEMENT OFFER REVIEW	MNZ
5	2024-04-01	ISSUED FOR MEDIATION	MNZ
4	2024-03-19	ISSUED FOR MEDIATION	MNZ
3	2024-02-21	ISSUED FOR MEDIATION	MNZ
2	2022-12-16	ISSUED FOR REZONING APPLICATION	AYU
1	2022-05-02	ISSUED FOR REZONING APPLICATION	AYU
#	DATE	DESCRIPTION	BY

Queenscorp (Royal York) Inc.

Queen Elizabeth Blvd + Royal York Rd, Toronto, ON

2, 7 and 10 Queen Elizabeth Boulevard, 506, 514, 516, 520, 522 Royal York Rd and 3, 5, 15 Sinclair Street AWING

UNDERGROUND LEVEL 01

PROJECT NO. 21.191 PROJECT DATE 2024-06-04 DRAWN BY RYT CHECKED BY MNZ SCALE As indicated

RZ103 PRZ103

__0.39 m ROAD WIDENING

N73º10'50"E 1.52M







PARCEL 2

__0.39 m ROAD WIDENING

 \mathbf{O}

0

Ř

TURNER FLEISCHER **Turner Fleischer Architects Inc.**

> 67 Lesmill Road Toronto, ON, M3B 2T8 T 416 425 2222

turnerfleischer.com This drawing, as an instrument of service, is provided by and is the property of Turner Fleischer Architects Inc. The contractor must verify and accept responsibility for all dimensions and conditions on site and must notify Turner Fleischer Architects Inc. of any variations from the supplied information. This drawing is not to be scaled. The architect is not responsible for the accuracy of survey, structural, mechanical, electrical, etc., information shown on this drawing. Refer to the appropriate consultant's drawings before proceeding with the work. Construction must conform to all applicable codes and requirements of authorities having jurisdiction. The contractor working from drawings not specifically marked 'For Construction' must assume full responsibility and bear costs for any corrections or damages resulting from his work.

WITHOUT PREJUDICE

9	2024-06-04	REISSUED FOR SETTLEMENT OFFER	MNZ
8	2024-05-16	REISSUED FOR SETTLEMENT OFFER	MNZ
7	2024-04-30	ISSUED FOR SETTLEMENT OFFER	MNZ
6	2024-04-23	ISSUED FOR DRAFT SETTLEMENT OFFER REVIEW	MNZ
5	2024-04-01	ISSUED FOR MEDIATION	MNZ
4	2024-03-19	ISSUED FOR MEDIATION	MNZ
3	2024-02-21	ISSUED FOR MEDIATION	MNZ
2	2022-12-16	ISSUED FOR REZONING APPLICATION	AYU
1	2022-05-02	ISSUED FOR REZONING APPLICATION	AYU
#	DATE	DESCRIPTION	BY

Queenscorp (Royal York) Inc.

Queen Elizabeth Blvd + Royal York Rd, Toronto, ON

2, 7 and 10 Queen Elizabeth Boulevard, 506, 514, 516, 520, 522 Royal York Rd and 3, 5, 15 Sinclair Street DRAWING

MEZZANINE

RZ151A 9



Turner Fleischer Architects Inc.

TURNER FLEISCHER

67 Lesmill Road Toronto, ON, M3B 2T8 T 416 425 2222

turnerfleischer.com This drawing, as an instrument of service, is provided by and is the property of Turner Fleischer Architects Inc. The contractor must verify and accept responsibility for all dimensions and conditions on site and must notify Turner Fleischer Architects Inc. of any variations from the supplied information. This drawing is not to be scaled. The architect is not responsible for the accuracy of survey, structural, mechanical, electrical, etc., information shown on this drawing. Refer to the appropriate consultant's drawings before proceeding with the work. Construction must conform to all applicable codes and requirements of authorities having jurisdiction. The contractor working from drawings not specifically marked 'For Construction' must assume full responsibility and bear costs for any corrections or damages resulting from his work.

__0.39 m

R

WITHOUT PREJUDICE

9	2024-06-04	REISSUED FOR SETTLEMENT OFFER	MNZ
8	2024-05-16	REISSUED FOR SETTLEMENT OFFER	MNZ
7	2024-04-30	ISSUED FOR SETTLEMENT OFFER	MNZ
6	2024-04-23	ISSUED FOR DRAFT SETTLEMENT OFFER REVIEW	MNZ
5	2024-04-01	ISSUED FOR MEDIATION	MNZ
4	2024-03-19	ISSUED FOR MEDIATION	MNZ
3	2024-02-21	ISSUED FOR MEDIATION	MNZ
2	2022-12-16	ISSUED FOR REZONING APPLICATION	AYU
1	2022-05-02	ISSUED FOR REZONING APPLICATION	AYU
#	DATE	DESCRIPTION	BY

Queenscorp (Royal York) Inc.

Queen Elizabeth Blvd + Royal York Rd, Toronto, ON

2, 7 and 10 Queen Elizabeth Boulevard, 506, 514, 516, 520, 522 Royal York Rd and 3, 5, 15 Sinclair Street RAWING

FLOOR 02 / OFFICE 02

RZ152 9



TURNER FLEISCHER Turner Fleischer Architects Inc.

> 67 Lesmill Road Toronto, ON, M3B 2T8 T 416 425 2222

turnerfleischer.com This drawing, as an instrument of service, is provided by and is the property of Turner Fleischer Architects Inc. The contractor must verify and accept responsibility for all dimensions and conditions on site and must notify Turner Fleischer Architects Inc. of any variations from the supplied information. This drawing is not to be scaled. The architect is not responsible for the accuracy of survey, structural, mechanical, electrical, etc., information shown on this drawing. Refer to the appropriate consultant's drawings before proceeding with the work. Construction must conform to all applicable codes and requirements of authorities having jurisdiction. The contractor working from drawings not specifically marked 'For Construction' must assume full responsibility and bear costs for any corrections or damages resulting from his work.

WITHOUT PREJUDICE

9	2024-06-04	REISSUED FOR SETTLEMENT OFFER	MNZ
8	2024-05-16	REISSUED FOR SETTLEMENT OFFER	MNZ
7	2024-04-30	ISSUED FOR SETTLEMENT OFFER	MNZ
6	2024-04-23	ISSUED FOR DRAFT SETTLEMENT OFFER REVIEW	MNZ
5	2024-04-01	ISSUED FOR MEDIATION	MNZ
4	2024-03-19	ISSUED FOR MEDIATION	MNZ
3	2024-02-21	ISSUED FOR MEDIATION	MNZ
2	2022-12-16	ISSUED FOR REZONING APPLICATION	AYU
1	2022-05-02	ISSUED FOR REZONING APPLICATION	AYU
#	DATE	DESCRIPTION	BY

Queenscorp (Royal York) Inc.

Queen Elizabeth Blvd + Royal York Rd, Toronto, ON

2, 7 and 10 Queen Elizabeth Boulevard, 506, 514, 516, 520, 522 Royal York Rd and 3, 5, 15 Sinclair Street DRAWING

FLOOR 03

RZ153 9

PROJECT NO. 21.191 PROJECT DATE 2024-06-04 DRAWN BY RYT CHECKED BY SCALE 1:300

Ř

__0.39 m

ROAD WIDENING

Goutline of Governments of Selection Selection



TURNER FLEISCHER Turner Fleischer Architects Inc.

> 67 Lesmill Road Toronto, ON, M3B 2T8 T 416 425 2222

turnerfleischer.com This drawing, as an instrument of service, is provided by and is the property of Turner Fleischer Architects Inc. The contractor must verify and accept responsibility for all dimensions and conditions on site and must notify Turner Fleischer Architects Inc. of any variations from the supplied information. This drawing is not to be scaled. The architect is not responsible for the accuracy of survey, structural, mechanical, electrical, etc., information shown on this drawing. Refer to the appropriate consultant's drawings before proceeding with the work. Construction must conform to all applicable codes and requirements of authorities having jurisdiction. The contractor working from drawings not specifically marked 'For Construction' must assume full responsibility and bear costs for any corrections or damages resulting from his work.

N

__0.39 m

WITHOUT PREJUDICE

9	2024-06-04	REISSUED FOR SETTLEMENT OFFER	MNZ
8	2024-05-16	REISSUED FOR SETTLEMENT OFFER	MNZ
7	2024-04-30	ISSUED FOR SETTLEMENT OFFER	MNZ
6	2024-04-23	ISSUED FOR DRAFT SETTLEMENT OFFER REVIEW	MNZ
5	2024-04-01	ISSUED FOR MEDIATION	MNZ
4	2024-03-19	ISSUED FOR MEDIATION	MNZ
3	2024-02-21	ISSUED FOR MEDIATION	MNZ
2	2022-12-16	ISSUED FOR REZONING APPLICATION	AYU
1	2022-05-02	ISSUED FOR REZONING APPLICATION	AYU
#	DATE	DESCRIPTION	BY

Queenscorp (Royal York) Inc.

Queen Elizabeth Blvd + Royal York Rd, Toronto, ON

2, 7 and 10 Queen Elizabeth Boulevard, 506, 514, 516, 520, 522 Royal York Rd and 3, 5, 15 Sinclair Street RAWING

FLOOR 04 / OFFICE 03

RZ154 9



PARCEL 2

Turner Fleischer Architects Inc.

TURNER FLEISCHER

Floor 8 above

___0.39 m

ROAD WIDENING

 \mathbf{n}

N

67 Lesmill Road Toronto, ON, M3B 2T8 T 416 425 2222

turnerfleischer.com This drawing, as an instrument of service, is provided by and is the property of Turner Fleischer Architects Inc. The contractor must verify and accept responsibility for all dimensions and conditions on site and must notify Turner Fleischer Architects Inc. of any variations from the supplied information. This drawing is not to be scaled. The architect is not responsible for the accuracy of survey, structural, mechanical, electrical, etc., information shown on this drawing. Refer to the appropriate consultant's drawings before proceeding with the work. Construction must conform to all applicable codes and requirements of authorities having jurisdiction. The contractor working from drawings not specifically marked 'For Construction' must assume full responsibility and bear costs for any corrections or damages resulting from his work.

WITHOUT PREJUDICE

ISSUED FOR SETTLEMENT OFFER	
	MNZ
ISSUED FOR SETTLEMENT OFFER	MNZ
SUED FOR SETTLEMENT OFFER	MNZ
SUED FOR DRAFT SETTLEMENT OFFER REVIEW	MNZ
SUED FOR MEDIATION	MNZ
SUED FOR MEDIATION	MNZ
SUED FOR MEDIATION	MNZ
SUED FOR REZONING APPLICATION	AYU
SUED FOR REZONING APPLICATION	AYU
DESCRIPTION	BY
	DESCRIPTION

Queenscorp (Royal York) Inc.

Queen Elizabeth Blvd + Royal York Rd, Toronto, ON

2, 7 and 10 Queen Elizabeth Boulevard, 506, 514, 516, 520, 522 Royal York Rd and 3, 5, 15 Sinclair Street RAWING

FLOOR 05 / OFFICE 04

RZ155 9



PARCEL 2

Turner Fleischer Architects Inc.

TURNER FLEISCHER

67 Lesmill Road Toronto, ON, M3B 2T8 T 416 425 2222 turnerfleischer.com

This drawing, as an instrument of service, is provided by and is the property of Turner Fleischer Architects Inc. The contractor must verify and accept responsibility for all dimensions and conditions on site and must notify Turner Fleischer Architects Inc. of any variations from the supplied information. This drawing is not to be scaled. The architect is not responsible for the accuracy of survey, structural, mechanical, electrical, etc., information shown on this drawing. Refer to the appropriate consultant's drawings before proceeding with the work. Construction must conform to all applicable codes and requirements of authorities having jurisdiction. The contractor working from drawings not specifically marked 'For Construction' must assume full responsibility and bear costs for any corrections or damages resulting from his work.

N

 \mathbf{n}

Floor 8 above

___0.39 m

ROAD WIDENING

WITHOUT PREJUDICE

	-		_
9	2024-06-04	REISSUED FOR SETTLEMENT OFFER	MNZ
8	2024-05-16	REISSUED FOR SETTLEMENT OFFER	MNZ
7	2024-04-30	ISSUED FOR SETTLEMENT OFFER	MNZ
6	2024-04-23	ISSUED FOR DRAFT SETTLEMENT OFFER REVIEW	MNZ
5	2024-04-01	ISSUED FOR MEDIATION	MNZ
4	2024-03-19	ISSUED FOR MEDIATION	MNZ
3	2024-02-21	ISSUED FOR MEDIATION	MNZ
2	2022-12-16	ISSUED FOR REZONING APPLICATION	AYU
1	2022-05-02	ISSUED FOR REZONING APPLICATION	AYU
#	DATE	DESCRIPTION	BY

Queenscorp (Royal York) Inc.

Queen Elizabeth Blvd + Royal York Rd, Toronto, ON

2, 7 and 10 Queen Elizabeth Boulevard, 506, 514, 516, 520, 522 Royal York Rd and 3, 5, 15 Sinclair Street RAWING

FLOOR 06 / OFFICE 04 ABOVE

PROJECT NO. 21.191 PROJECT DATE 2024-06-04 DRAWN BY RYT CHECKED BY SCALE 1:300

RZ156 9



PARCEL 2

Floor 8 above

___0.39 m

ROAD WIDENING

 \mathbf{n}

N

Turner Fleischer Architects Inc.

TURNER FLEISCHER

67 Lesmill Road Toronto, ON, M3B 2T8 T 416 425 2222

turnerfleischer.com This drawing, as an instrument of service, is provided by and is the property of Turner Fleischer Architects Inc. The contractor must verify and accept responsibility for all dimensions and conditions on site and must notify Turner Fleischer Architects Inc. of any variations from the supplied information. This drawing is not to be scaled. The architect is not responsible for the accuracy of survey, structural, mechanical, electrical, etc., information shown on this drawing. Refer to the appropriate consultant's drawings before proceeding with the work. Construction must conform to all applicable codes and requirements of authorities having jurisdiction. The contractor working from drawings not specifically marked 'For Construction' must assume full responsibility and bear costs for any corrections or damages resulting from his work.

WITHOUT PREJUDICE

SUED FOR SETTLEMENT OFFER	
	MNZ
SUED FOR SETTLEMENT OFFER	MNZ
ED FOR SETTLEMENT OFFER	MNZ
ED FOR DRAFT SETTLEMENT OFFER REVIEW	MNZ
ED FOR MEDIATION	MNZ
ED FOR MEDIATION	MNZ
ED FOR MEDIATION	MNZ
ED FOR REZONING APPLICATION	AYU
ED FOR REZONING APPLICATION	AYU
DESCRIPTION	BY
	DESCRIPTION

Queenscorp (Royal York) Inc.

Queen Elizabeth Blvd + Royal York Rd, Toronto, ON

2, 7 and 10 Queen Elizabeth Boulevard, 506, 514, 516, 520, 522 Royal York Rd and 3, 5, 15 Sinclair Street RAWING

FLOOR 07 / OFFICE 05

RZ157 9



PARCEL 2

Turner Fleischer Architects Inc.

TURNER FLEISCHER

67 Lesmill Road Toronto, ON, M3B 2T8 T 416 425 2222

turnerfleischer.com This drawing, as an instrument of service, is provided by and is the property of Turner Fleischer Architects Inc. The contractor must verify and accept responsibility for all dimensions and conditions on site and must notify Turner Fleischer Architects Inc. of any variations from the supplied information. This drawing is not to be scaled. The architect is not responsible for the accuracy of survey, structural, mechanical, electrical, etc., information shown on this drawing. Refer to the appropriate consultant's drawings before proceeding with the work. Construction must conform to all applicable codes and requirements of authorities having jurisdiction. The contractor working from drawings not specifically marked 'For Construction' must assume full responsibility and bear costs for any corrections or damages resulting from his work.

WITHOUT PREJUDICE

SUED FOR SETTLEMENT OFFER	
	MNZ
SUED FOR SETTLEMENT OFFER	MNZ
ED FOR SETTLEMENT OFFER	MNZ
ED FOR DRAFT SETTLEMENT OFFER REVIEW	MNZ
ED FOR MEDIATION	MNZ
ED FOR MEDIATION	MNZ
ED FOR MEDIATION	MNZ
ED FOR REZONING APPLICATION	AYU
ED FOR REZONING APPLICATION	AYU
DESCRIPTION	BY
	DESCRIPTION

Queenscorp (Royal York) Inc.

Queen Elizabeth Blvd + Royal York Rd, Toronto, ON

2, 7 and 10 Queen Elizabeth Boulevard, 506, 514, 516, 520, 522 Royal York Rd and 3, 5, 15 Sinclair Street RAWING

FLOOR 08 / OFFICE 06

RZ158 9

PROJECT NO. 21.191 PROJECT DATE 2024-06-04 DRAWN BY RYT CHECKED BY SCALE 1:300

 \mathbf{n}

N

Outline of Floor 9 above

__0.39 m

ROAD WIDENING



PARCEL 2

TURNER FLEISCHER **Turner Fleischer Architects Inc.**

This drawing, as an instrument of service, is provided by and is the property of Turner Fleischer Architects Inc. The contractor must verify and accept responsibility for all dimensions and conditions on site and must notify Turner Fleischer Architects Inc. of any variations from the supplied information. This drawing is not to be scaled. The architect is not responsible for the accuracy of survey, structural, mechanical, electrical, etc., information shown on this drawing. Refer to the appropriate consultant's drawings before proceeding with the work. Construction must conform to all applicable codes and requirements of authorities having jurisdiction. The contractor working from drawings not specifically marked 'For Construction' must assume full responsibility and bear costs for any corrections or damages resulting from his work.

67 Lesmill Road Toronto, ON, M3B 2T8 T 416 425 2222 turnerfleischer.com

Outline of Floor

__0.39 m ROAD WIDENING

WITHOUT PREJUDICE

9	2024-06-04	REISSUED FOR SETTLEMENT OFFER	MNZ
8	2024-05-16	REISSUED FOR SETTLEMENT OFFER	MNZ
7	2024-04-30	ISSUED FOR SETTLEMENT OFFER	MNZ
6	2024-04-23	ISSUED FOR DRAFT SETTLEMENT OFFER REVIEW	MNZ
5	2024-04-01	ISSUED FOR MEDIATION	MNZ
4	2024-03-19	ISSUED FOR MEDIATION	MNZ
3	2024-02-21	ISSUED FOR MEDIATION	MNZ
2	2022-12-16	ISSUED FOR REZONING APPLICATION	AYU
1	2022-05-02	ISSUED FOR REZONING APPLICATION	AYU
#	DATE	DESCRIPTION	BY

Queenscorp (Royal York) Inc.

Queen Elizabeth Blvd + Royal York Rd, Toronto, ON

2, 7 and 10 Queen Elizabeth Boulevard, 506, 514, 516, 520, 522 Royal York Rd and 3, 5, 15 Sinclair Street ORAWING

FLOOR 09

PROJECT NO. 21.191 PROJECT DATE 2024-06-04 DRAWN BY RYT CHECKED BY SCALE 1:300

RZ159 9



PARCEL 2

Turner Fleischer Architects Inc.

TURNER FLEISCHER

67 Lesmill Road Toronto, ON, M3B 2T8 T 416 425 2222

turnerfleischer.com This drawing, as an instrument of service, is provided by and is the property of Turner Fleischer Architects Inc. The contractor must verify and accept responsibility for all dimensions and conditions on site and must notify Turner Fleischer Architects Inc. of any variations from the supplied information. This drawing is not to be scaled. The architect is not responsible for the accuracy of survey, structural, mechanical, electrical, etc., information shown on this drawing. Refer to the appropriate consultant's drawings before proceeding with the work. Construction must conform to all applicable codes and requirements of authorities having jurisdiction. The contractor working from drawings not specifically marked 'For Construction' must assume full responsibility and bear costs for any corrections or damages resulting from his work.

__0.39 m ROAD WIDENING

 \mathbf{n}

WITHOUT PREJUDICE

9	2024-06-04	REISSUED FOR SETTLEMENT OFFER	MNZ
-			
8	2024-05-16	REISSUED FOR SETTLEMENT OFFER	MNZ
7	2024-04-30	ISSUED FOR SETTLEMENT OFFER	MNZ
6	2024-04-23	ISSUED FOR DRAFT SETTLEMENT OFFER REVIEW	MNZ
5	2024-04-01	ISSUED FOR MEDIATION	MNZ
4	2024-03-19	ISSUED FOR MEDIATION	MNZ
3	2024-02-21	ISSUED FOR MEDIATION	MNZ
2	2022-12-16	ISSUED FOR REZONING APPLICATION	AYU
1	2022-05-02	ISSUED FOR REZONING APPLICATION	AYU
#	DATE	DESCRIPTION	BY

Queenscorp (Royal York) Inc.


Queen Elizabeth Blvd + Royal York Rd, Toronto, ON

2, 7 and 10 Queen Elizabeth Boulevard, 506, 514, 516, 520, 522 Royal York Rd and 3, 5, 15 Sinclair Street DRAWING

FLOOR 10

PROJECT NO. 21.191 PROJECT DATE 2024-06-04 DRAWN BY RYT CHECKED BY MNZ SCALE 1:300

REV. 9

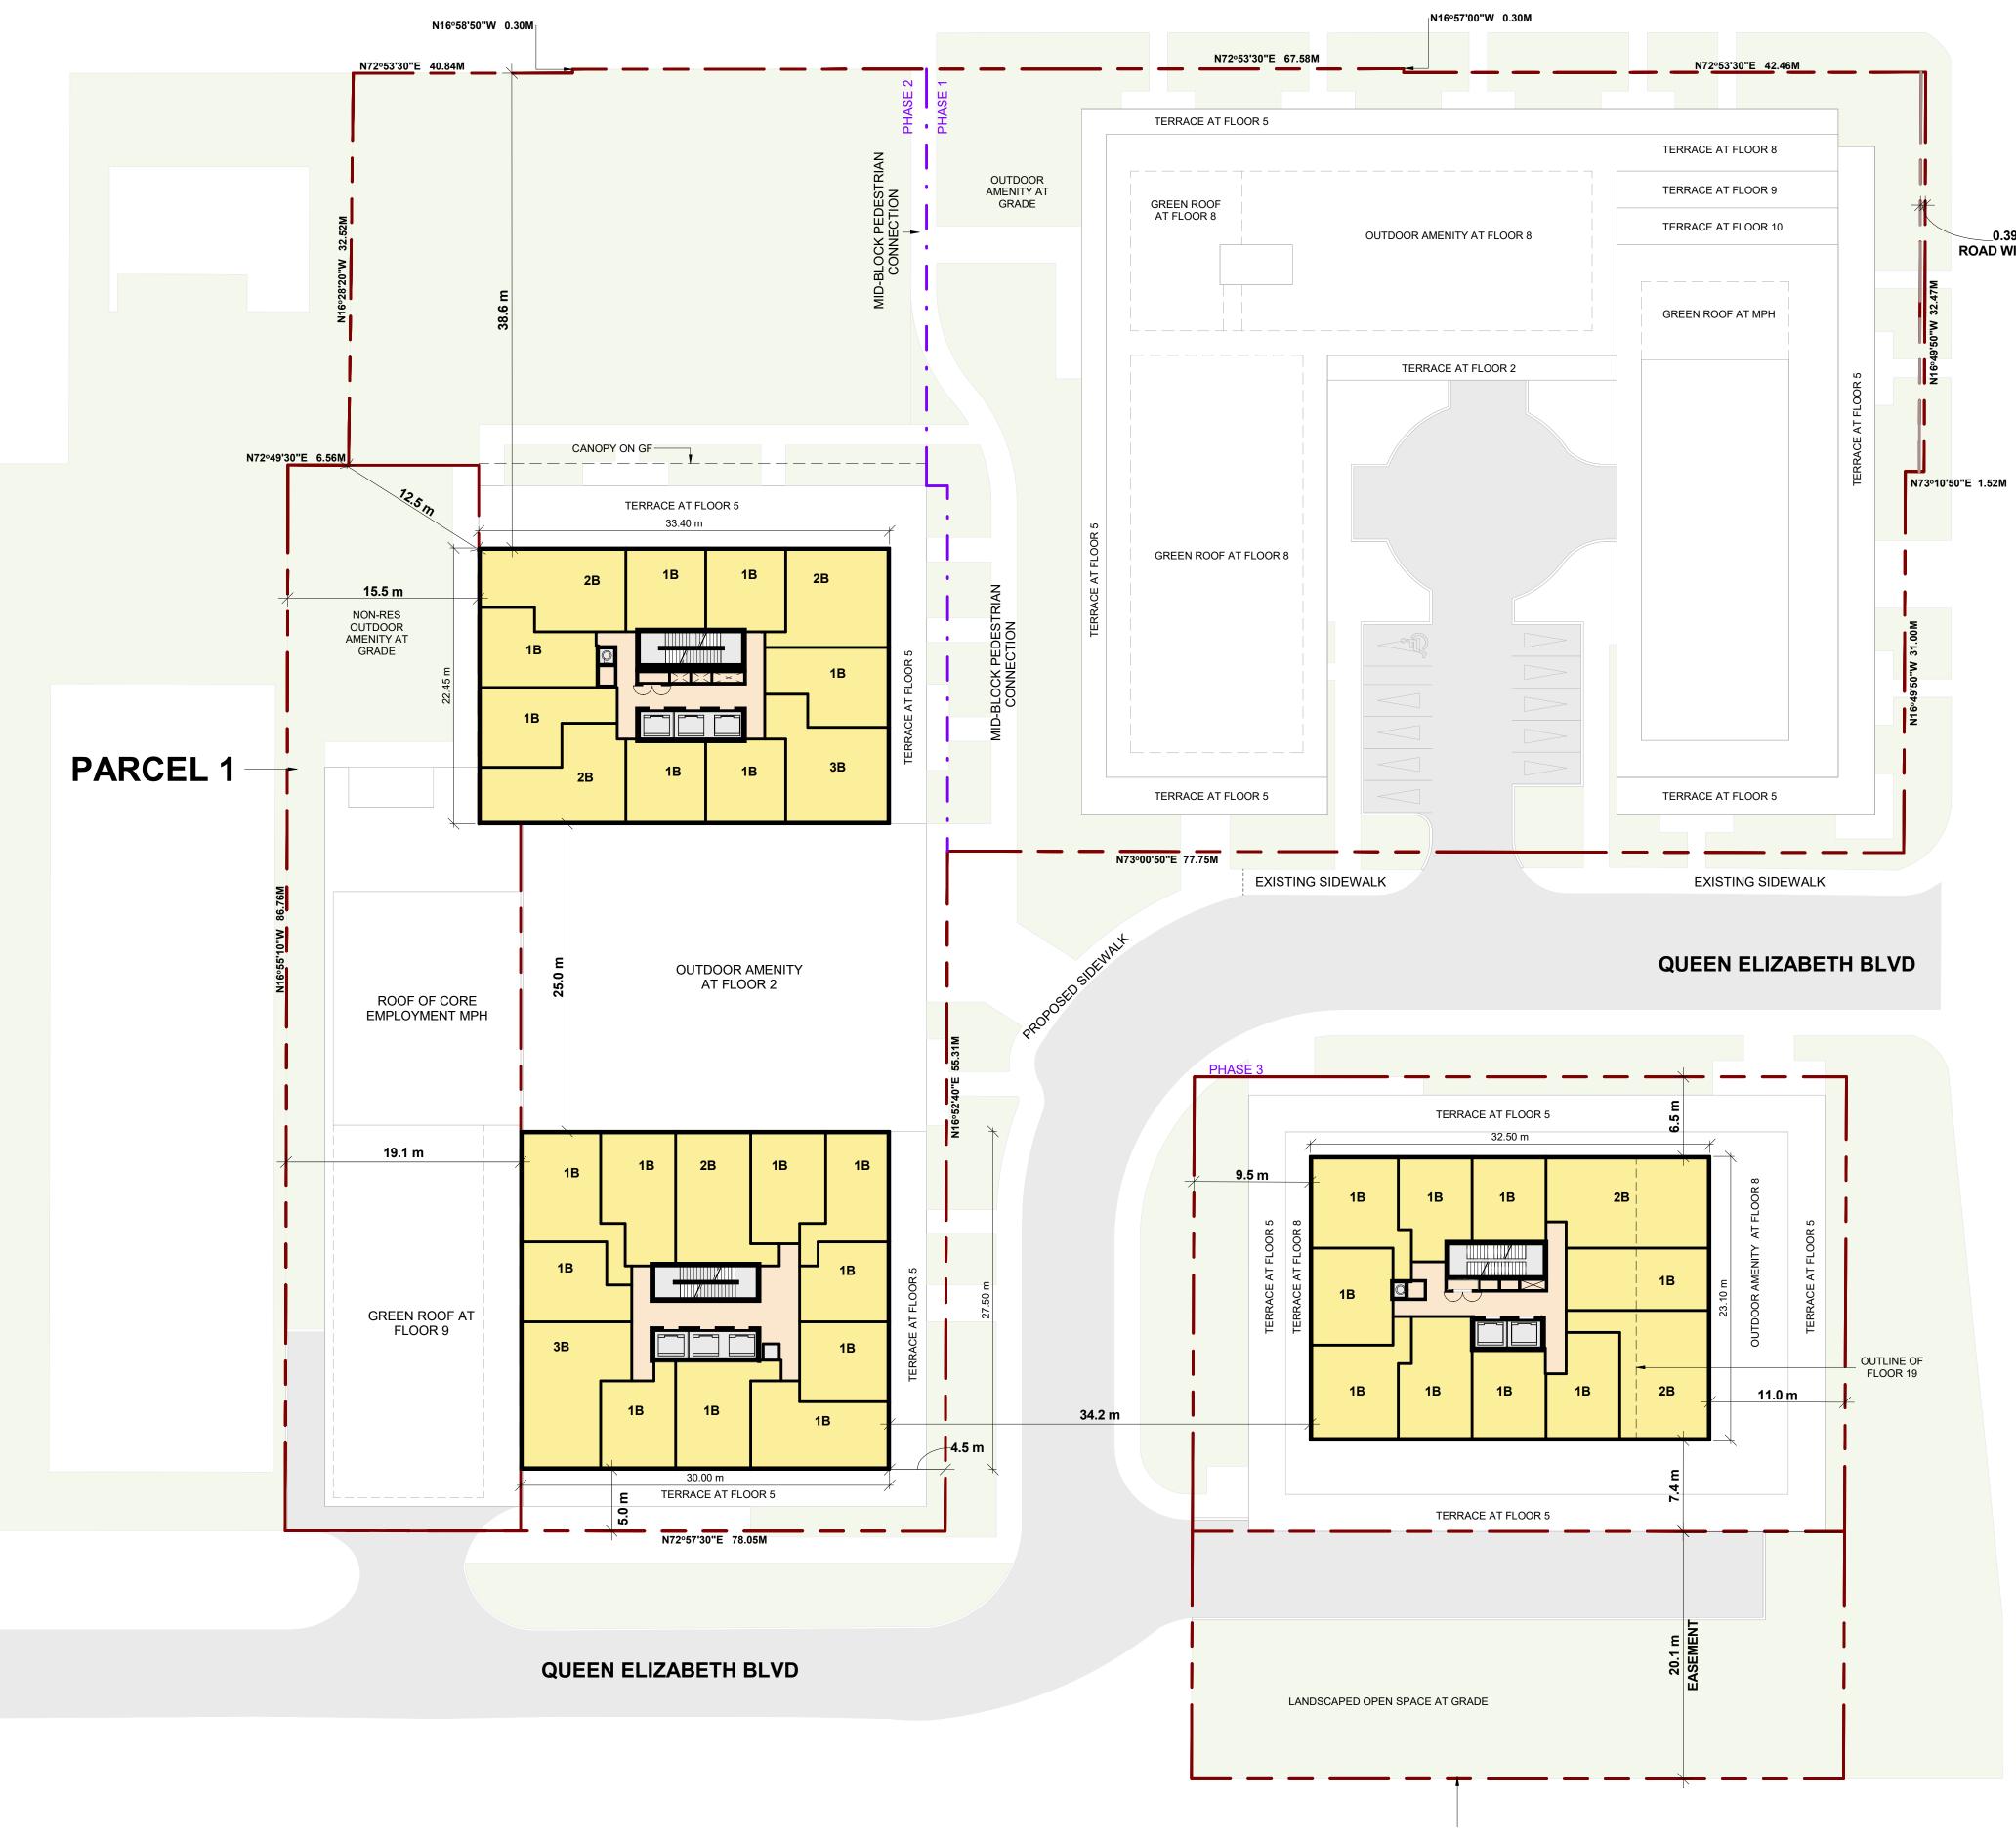



PARCEL 2

Turner Fleischer Architects Inc.

TURNER FLEISCHER

67 Lesmill Road Toronto, ON, M3B 2T8 T 416 425 2222

turnerfleischer.com This drawing, as an instrument of service, is provided by and is the property of Turner Fleischer Architects Inc. The contractor must verify and accept responsibility for all dimensions and conditions on site and must notify Turner Fleischer Architects Inc. of any variations from the supplied information. This drawing is not to be scaled. The architect is not responsible for the accuracy of survey, structural, mechanical, electrical, etc., information shown on this drawing. Refer to the appropriate consultant's drawings before proceeding with the work. Construction must conform to all applicable codes and requirements of authorities having jurisdiction. The contractor working from drawings not specifically marked 'For Construction' must assume full responsibility and bear costs for any corrections or damages resulting from his work.

__0.39 m ROAD WIDENING

WITHOUT PREJUDICE

9	2024-06-04	REISSUED FOR SETTLEMENT OFFER	MNZ
8	2024-05-16	REISSUED FOR SETTLEMENT OFFER	MNZ
7	2024-04-30	ISSUED FOR SETTLEMENT OFFER	MNZ
6	2024-04-23	ISSUED FOR DRAFT SETTLEMENT OFFER REVIEW	MNZ
5	2024-04-01	ISSUED FOR MEDIATION	MNZ
4	2024-03-19	ISSUED FOR MEDIATION	MNZ
3	2024-02-21	ISSUED FOR MEDIATION	MNZ
2	2022-12-16	ISSUED FOR REZONING APPLICATION	AYU
1	2022-05-02	ISSUED FOR REZONING APPLICATION	AYU
#	DATE	DESCRIPTION	BY

Queenscorp (Royal York) Inc.

Queen Elizabeth Blvd + Royal York Rd, Toronto, ON

2, 7 and 10 Queen Elizabeth Boulevard, 506, 514, 516, 520, 522 Royal York Rd and 3, 5, 15 Sinclair Street DRAWING

F11-18 (BLDG-C) _ F11-17 (BLDG-A1) _ F11-34 (BLDG-A2)

RZ161 9



TURNER FLEISCHER Turner Fleischer Architects Inc.

> 67 Lesmill Road Toronto, ON, M3B 2T8 T 416 425 2222

turnerfleischer.com This drawing, as an instrument of service, is provided by and is the property of Turner Fleischer Architects Inc. The contractor must verify and accept responsibility for all dimensions and conditions on site and must notify Turner Fleischer Architects Inc. of any variations from the supplied information. This drawing is not to be scaled. The architect is not responsible for the accuracy of survey, structural, mechanical, electrical, etc., information shown on this drawing. Refer to the appropriate consultant's drawings before proceeding with the work. Construction must conform to all applicable codes and requirements of authorities having jurisdiction. The contractor working from drawings not specifically marked 'For Construction' must assume full responsibility and bear costs for any corrections or damages resulting from his work.

 \mathbf{n}

WITHOUT PREJUDICE

I			
9	2024-06-04	REISSUED FOR SETTLEMENT OFFER	MNZ
8	2024-05-16	REISSUED FOR SETTLEMENT OFFER	MNZ
7	2024-04-30	ISSUED FOR SETTLEMENT OFFER	MNZ
6	2024-04-23	ISSUED FOR DRAFT SETTLEMENT OFFER REVIEW	MNZ
5	2024-04-01	ISSUED FOR MEDIATION	MNZ
4	2024-03-19	ISSUED FOR MEDIATION	MNZ
3	2024-02-21	ISSUED FOR MEDIATION	MNZ
2	2022-12-16	ISSUED FOR REZONING APPLICATION	AYU
1	2022-05-02	ISSUED FOR REZONING APPLICATION	AYU
#	DATE	DESCRIPTION	BY


Queenscorp (Royal York) Inc.

Queen Elizabeth Blvd + Royal York Rd, Toronto, ON

2, 7 and 10 Queen Elizabeth Boulevard, 506, 514, 516, 520, 522 Royal York Rd and 3, 5, 15 Sinclair Street ORAWING

F19-20 (BLDG-C) _ F18 (BLDG-A2) _ F35-36 (BLDG-A1)

REV. 9

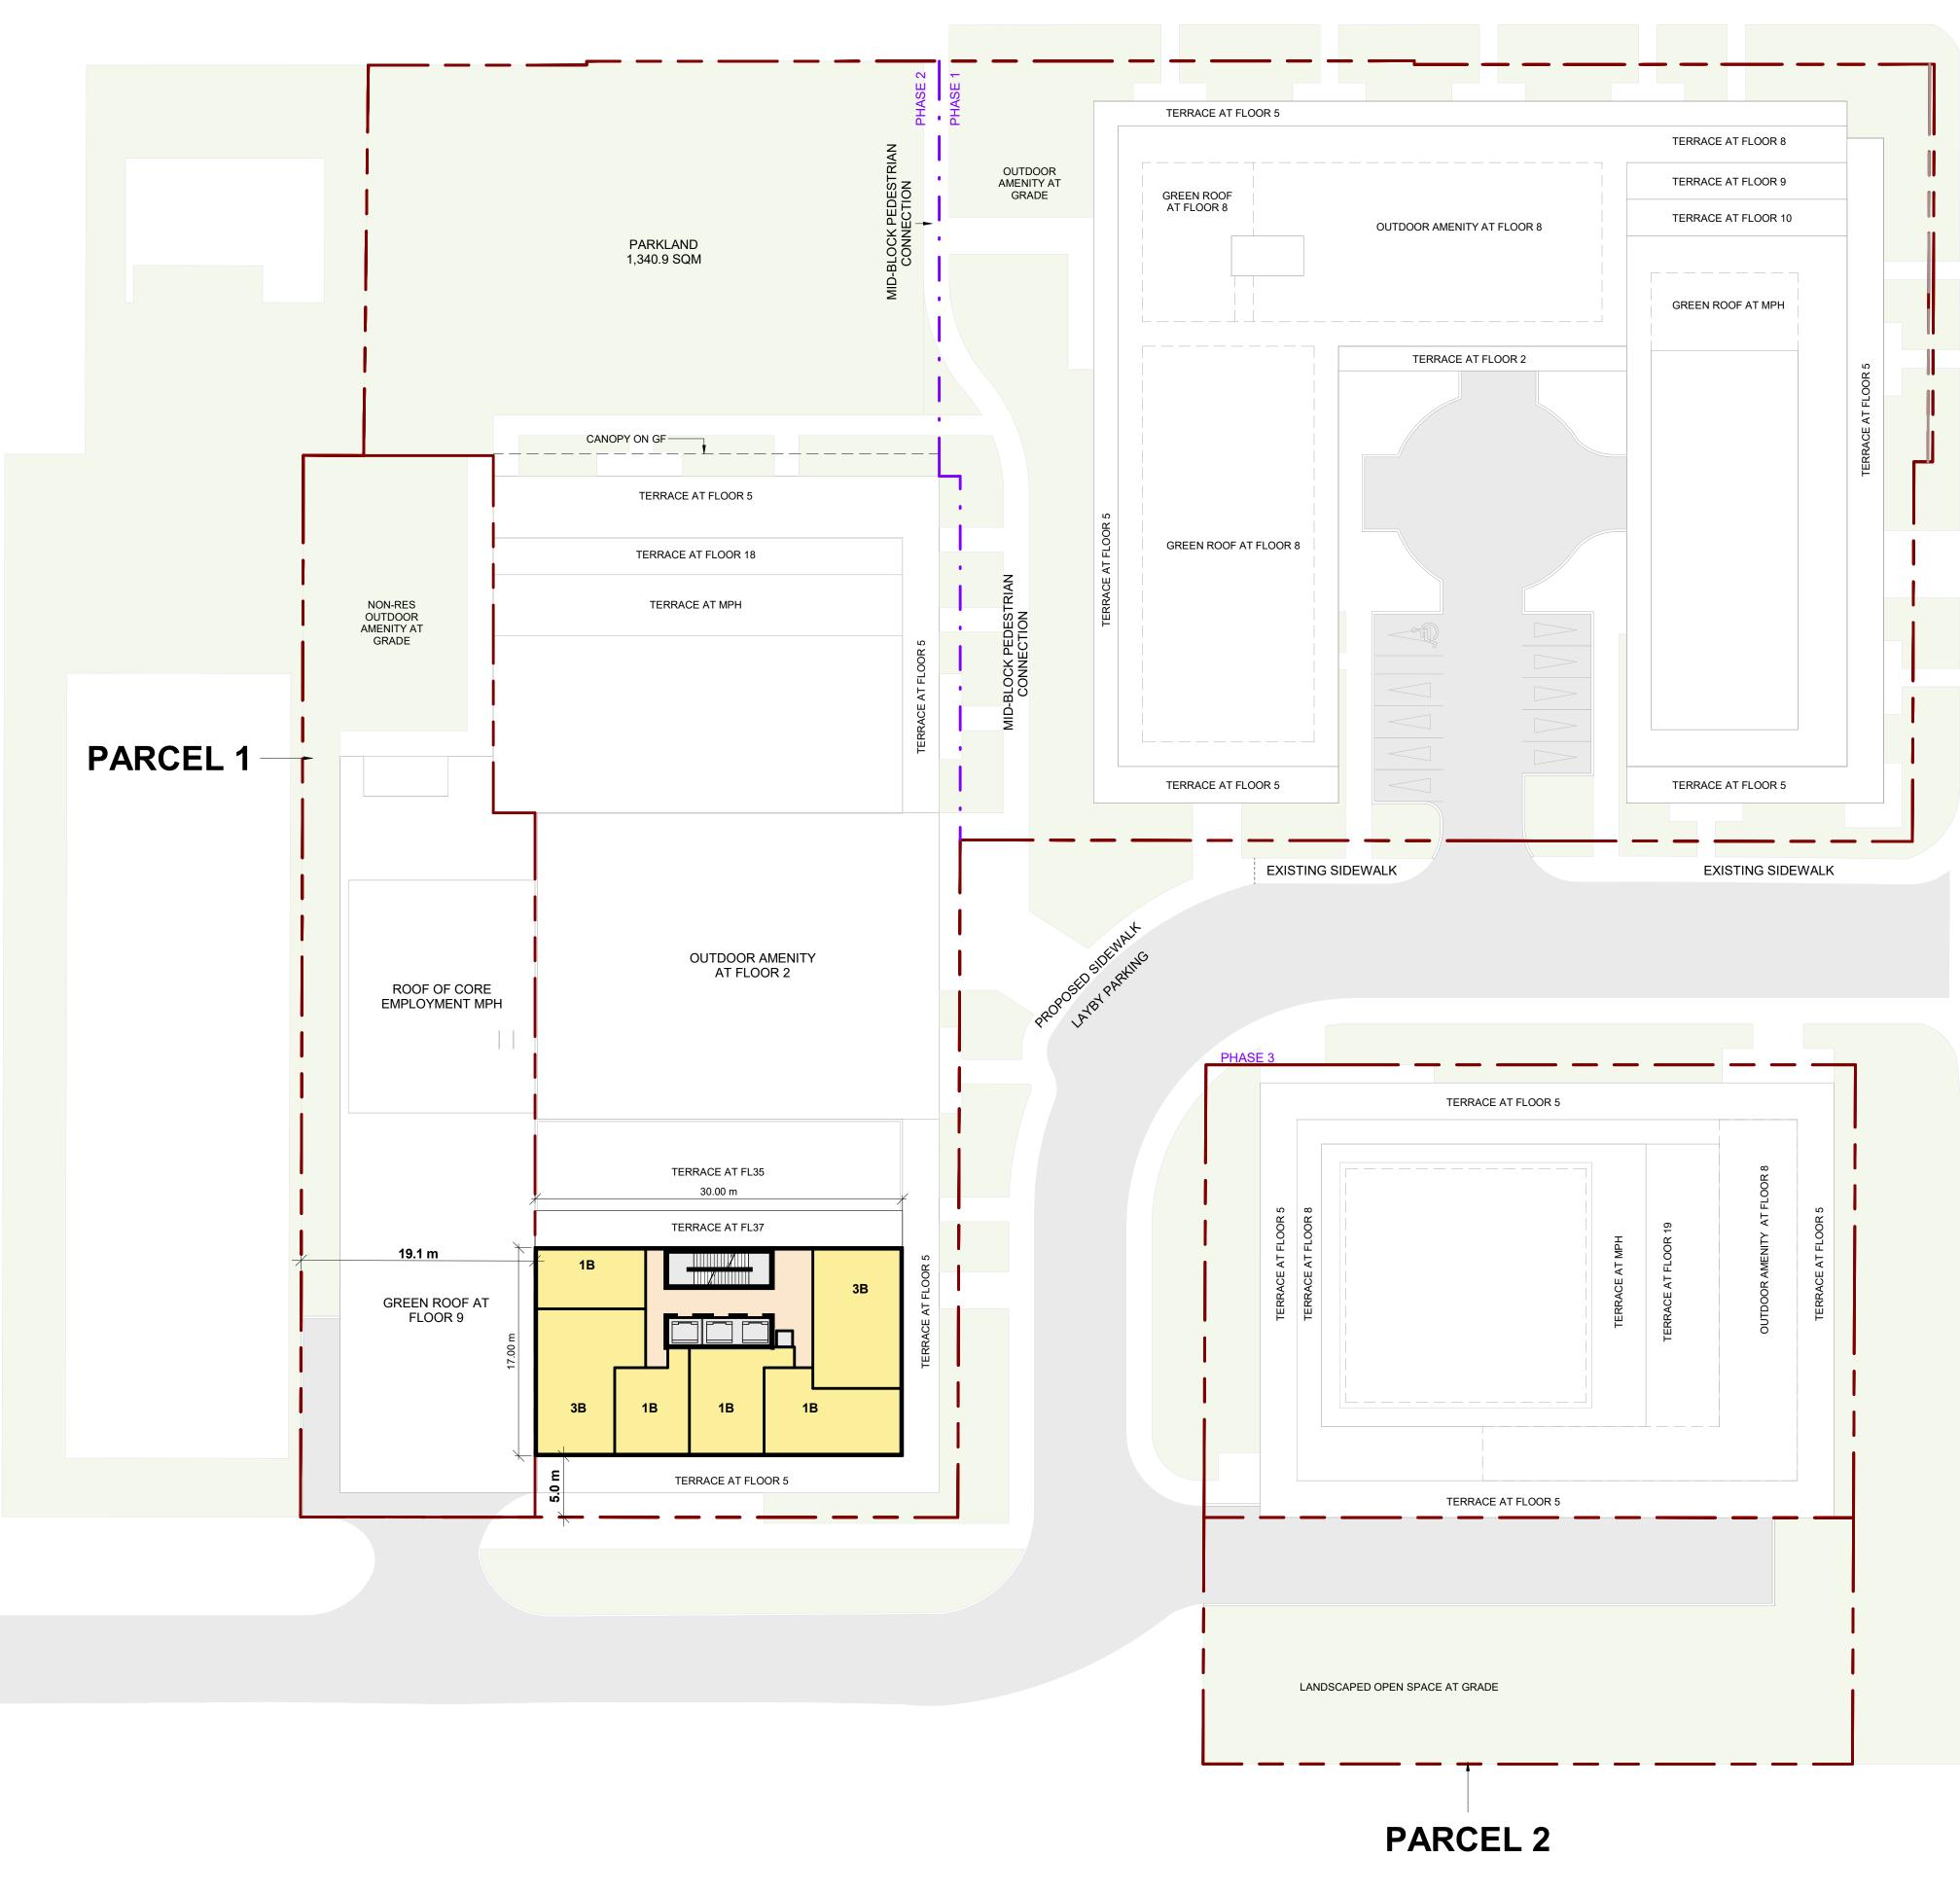



This drawing, as an instrument of service, is provided by and is the property of Turner Fleischer Architects Inc. The contractor must verify and accept responsibility for all dimensions and conditions on site and must notify Turner Fleischer Architects Inc. of any variations from the supplied information. This drawing is not to be scaled. The architect is not responsible for the accuracy of survey, structural, mechanical, electrical, etc., information shown on this drawing. Refer to the appropriate consultant's drawings before proceeding with the work. Construction must conform to all applicable codes and requirements of authorities having jurisdiction. The contractor working from drawings not specifically marked 'For Construction' must assume full responsibility and bear costs for any corrections or damages resulting from his work.

Turner Fleischer Architects Inc.

67 Lesmill Road Toronto, ON, M3B 2T8 T 416 425 2222 turnerfleischer.com

WITHOUT PREJUDICE

9	2024-06-04	REISSUED FOR SETTLEMENT OFFER	MNZ
8	2024-05-16	REISSUED FOR SETTLEMENT OFFER	MNZ
7	2024-04-30	ISSUED FOR SETTLEMENT OFFER	MNZ
6	2024-04-23	ISSUED FOR DRAFT SETTLEMENT OFFER REVIEW	MNZ
5	2024-04-01	ISSUED FOR MEDIATION	MNZ
4	2024-03-19	ISSUED FOR MEDIATION	MNZ
3	2024-02-21	ISSUED FOR MEDIATION	MNZ
2	2022-12-16	ISSUED FOR REZONING APPLICATION	AYU
1	2022-05-02	ISSUED FOR REZONING APPLICATION	AYU
#	DATE	DESCRIPTION	BY

Queenscorp (Royal York) Inc.

PROJECT


Queen Elizabeth Blvd + Royal York Rd, Toronto, ON


2, 7 and 10 Queen Elizabeth Boulevard, 506, 514, 516, 520, 522 Royal York Rd and 3, 5, 15 Sinclair Street


FLOOR 37

PROJECT NO. 21.191 PROJECT DATE 2024-06-04 DRAWN BY RYT CHECKED BY MNZ SCALE 1 : 300

DRAWING NO. REV. 9

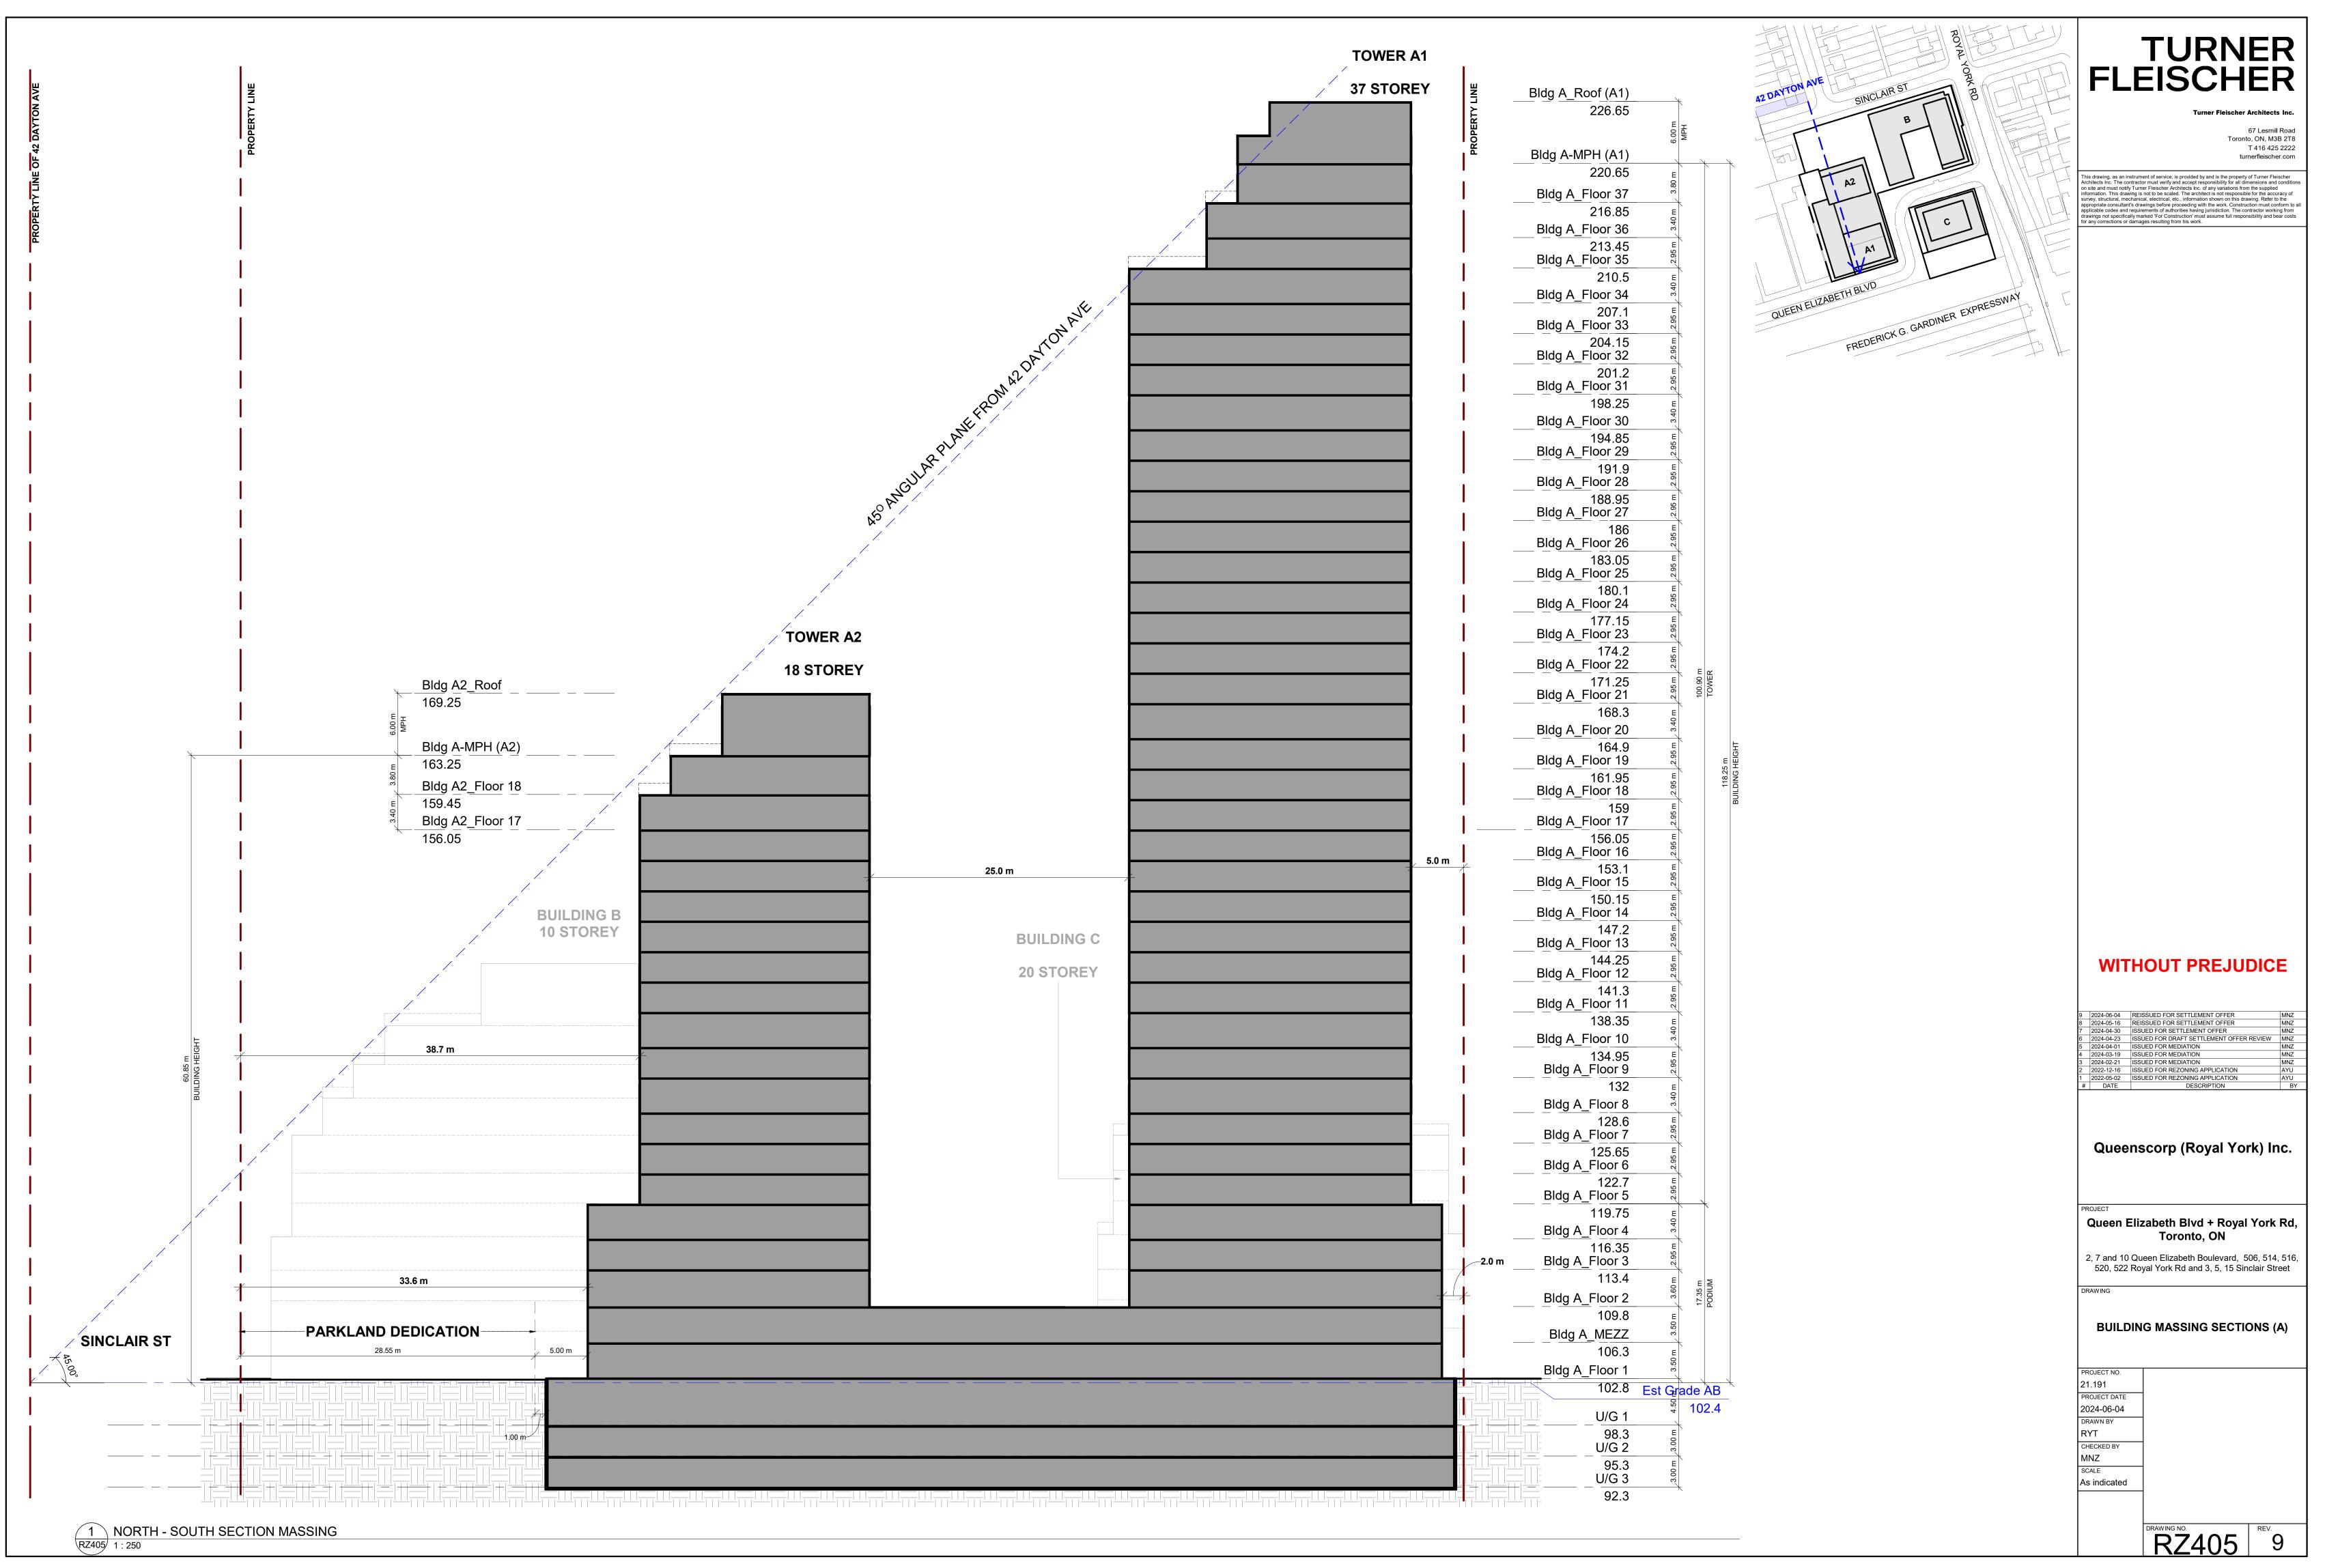


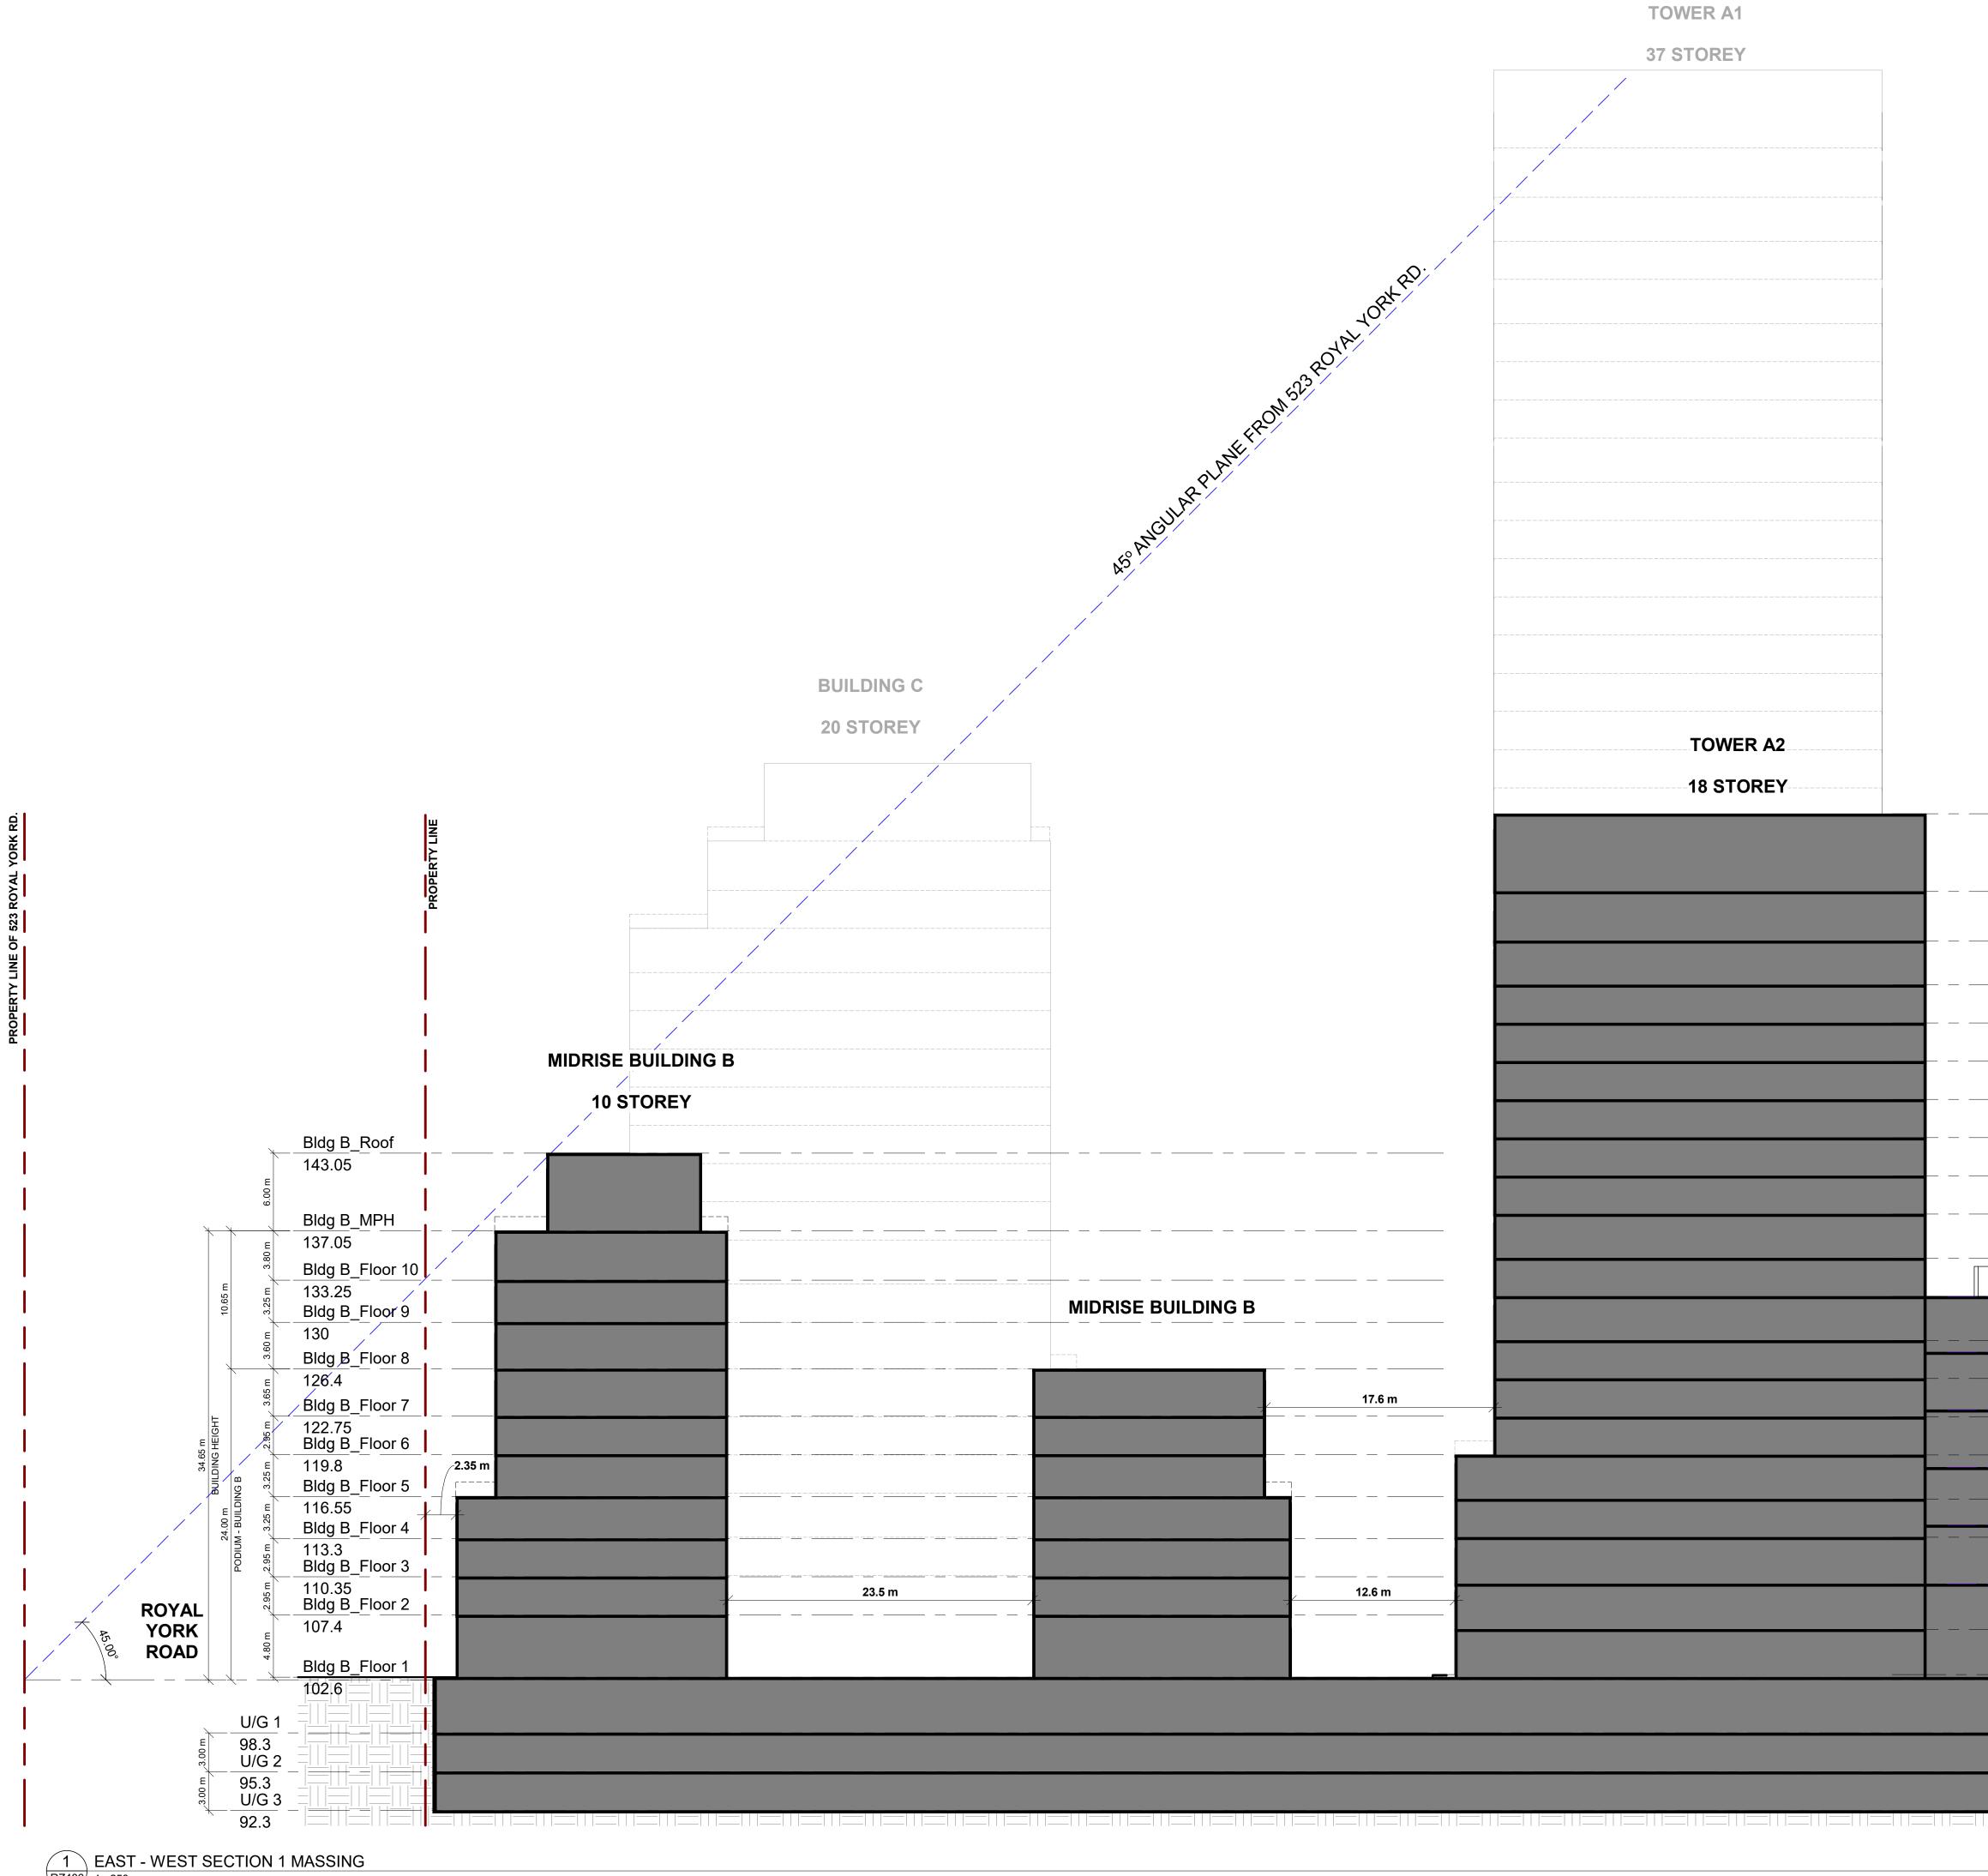

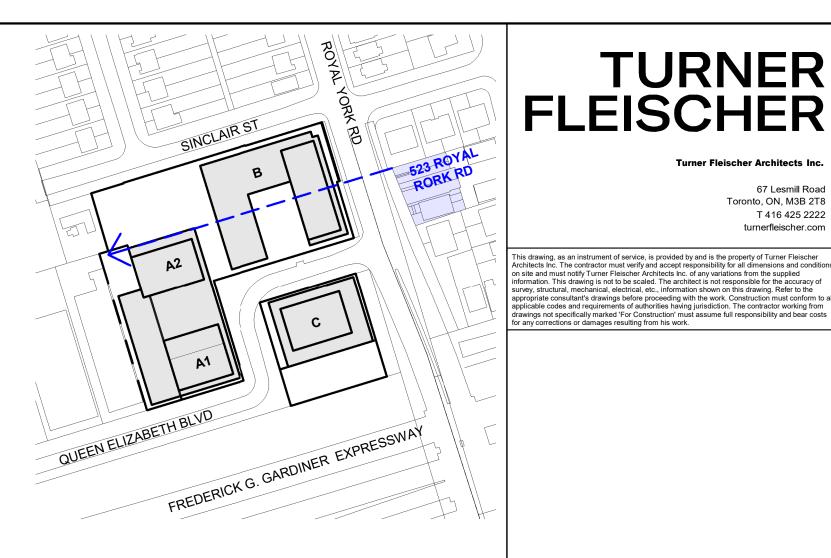



67 Lesmill Road Toronto, ON, M3B 2T8 T 416 425 2222 turnerfleischer.com

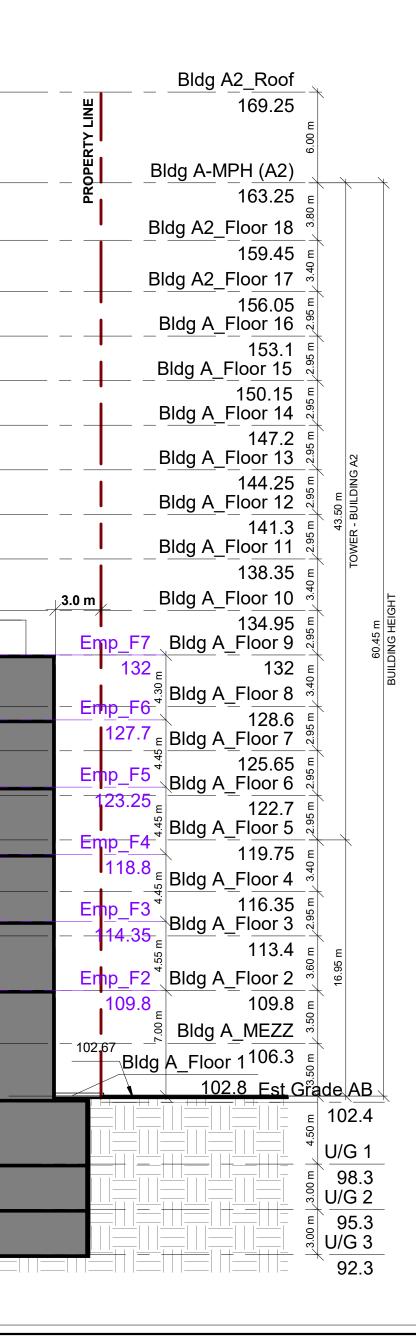

WITHOUT PREJUDICE

9	2024-06-04	REISSUED FOR SETTLEMENT OFFER	MNZ
8	2024-05-16	REISSUED FOR SETTLEMENT OFFER	MNZ
7	2024-04-30	ISSUED FOR SETTLEMENT OFFER	MNZ
6	2024-04-23	ISSUED FOR DRAFT SETTLEMENT OFFER REVIEW	MNZ
5	2024-04-01	ISSUED FOR MEDIATION	MNZ
4	2024-03-19	ISSUED FOR MEDIATION	MNZ
3	2024-02-21	ISSUED FOR MEDIATION	MNZ
2	2022-12-16	ISSUED FOR REZONING APPLICATION	AYU
1	2022-05-02	ISSUED FOR REZONING APPLICATION	AYU
#	DATE	DESCRIPTION	BY

Queenscorp (Royal York) Inc.


Queen Elizabeth Blvd + Royal York Rd, Toronto, ON


2, 7 and 10 Queen Elizabeth Boulevard, 506, 514, 516, 520, 522 Royal York Rd and 3, 5, 15 Sinclair Street

BUILDING MASSING SECTIONS (B & A)

RZ406 9

PROJECT NO. 21.191 PROJECT DATE 2024-06-04 DRAWN BY RYT CHECKED BY MNZ SCALE As indicated

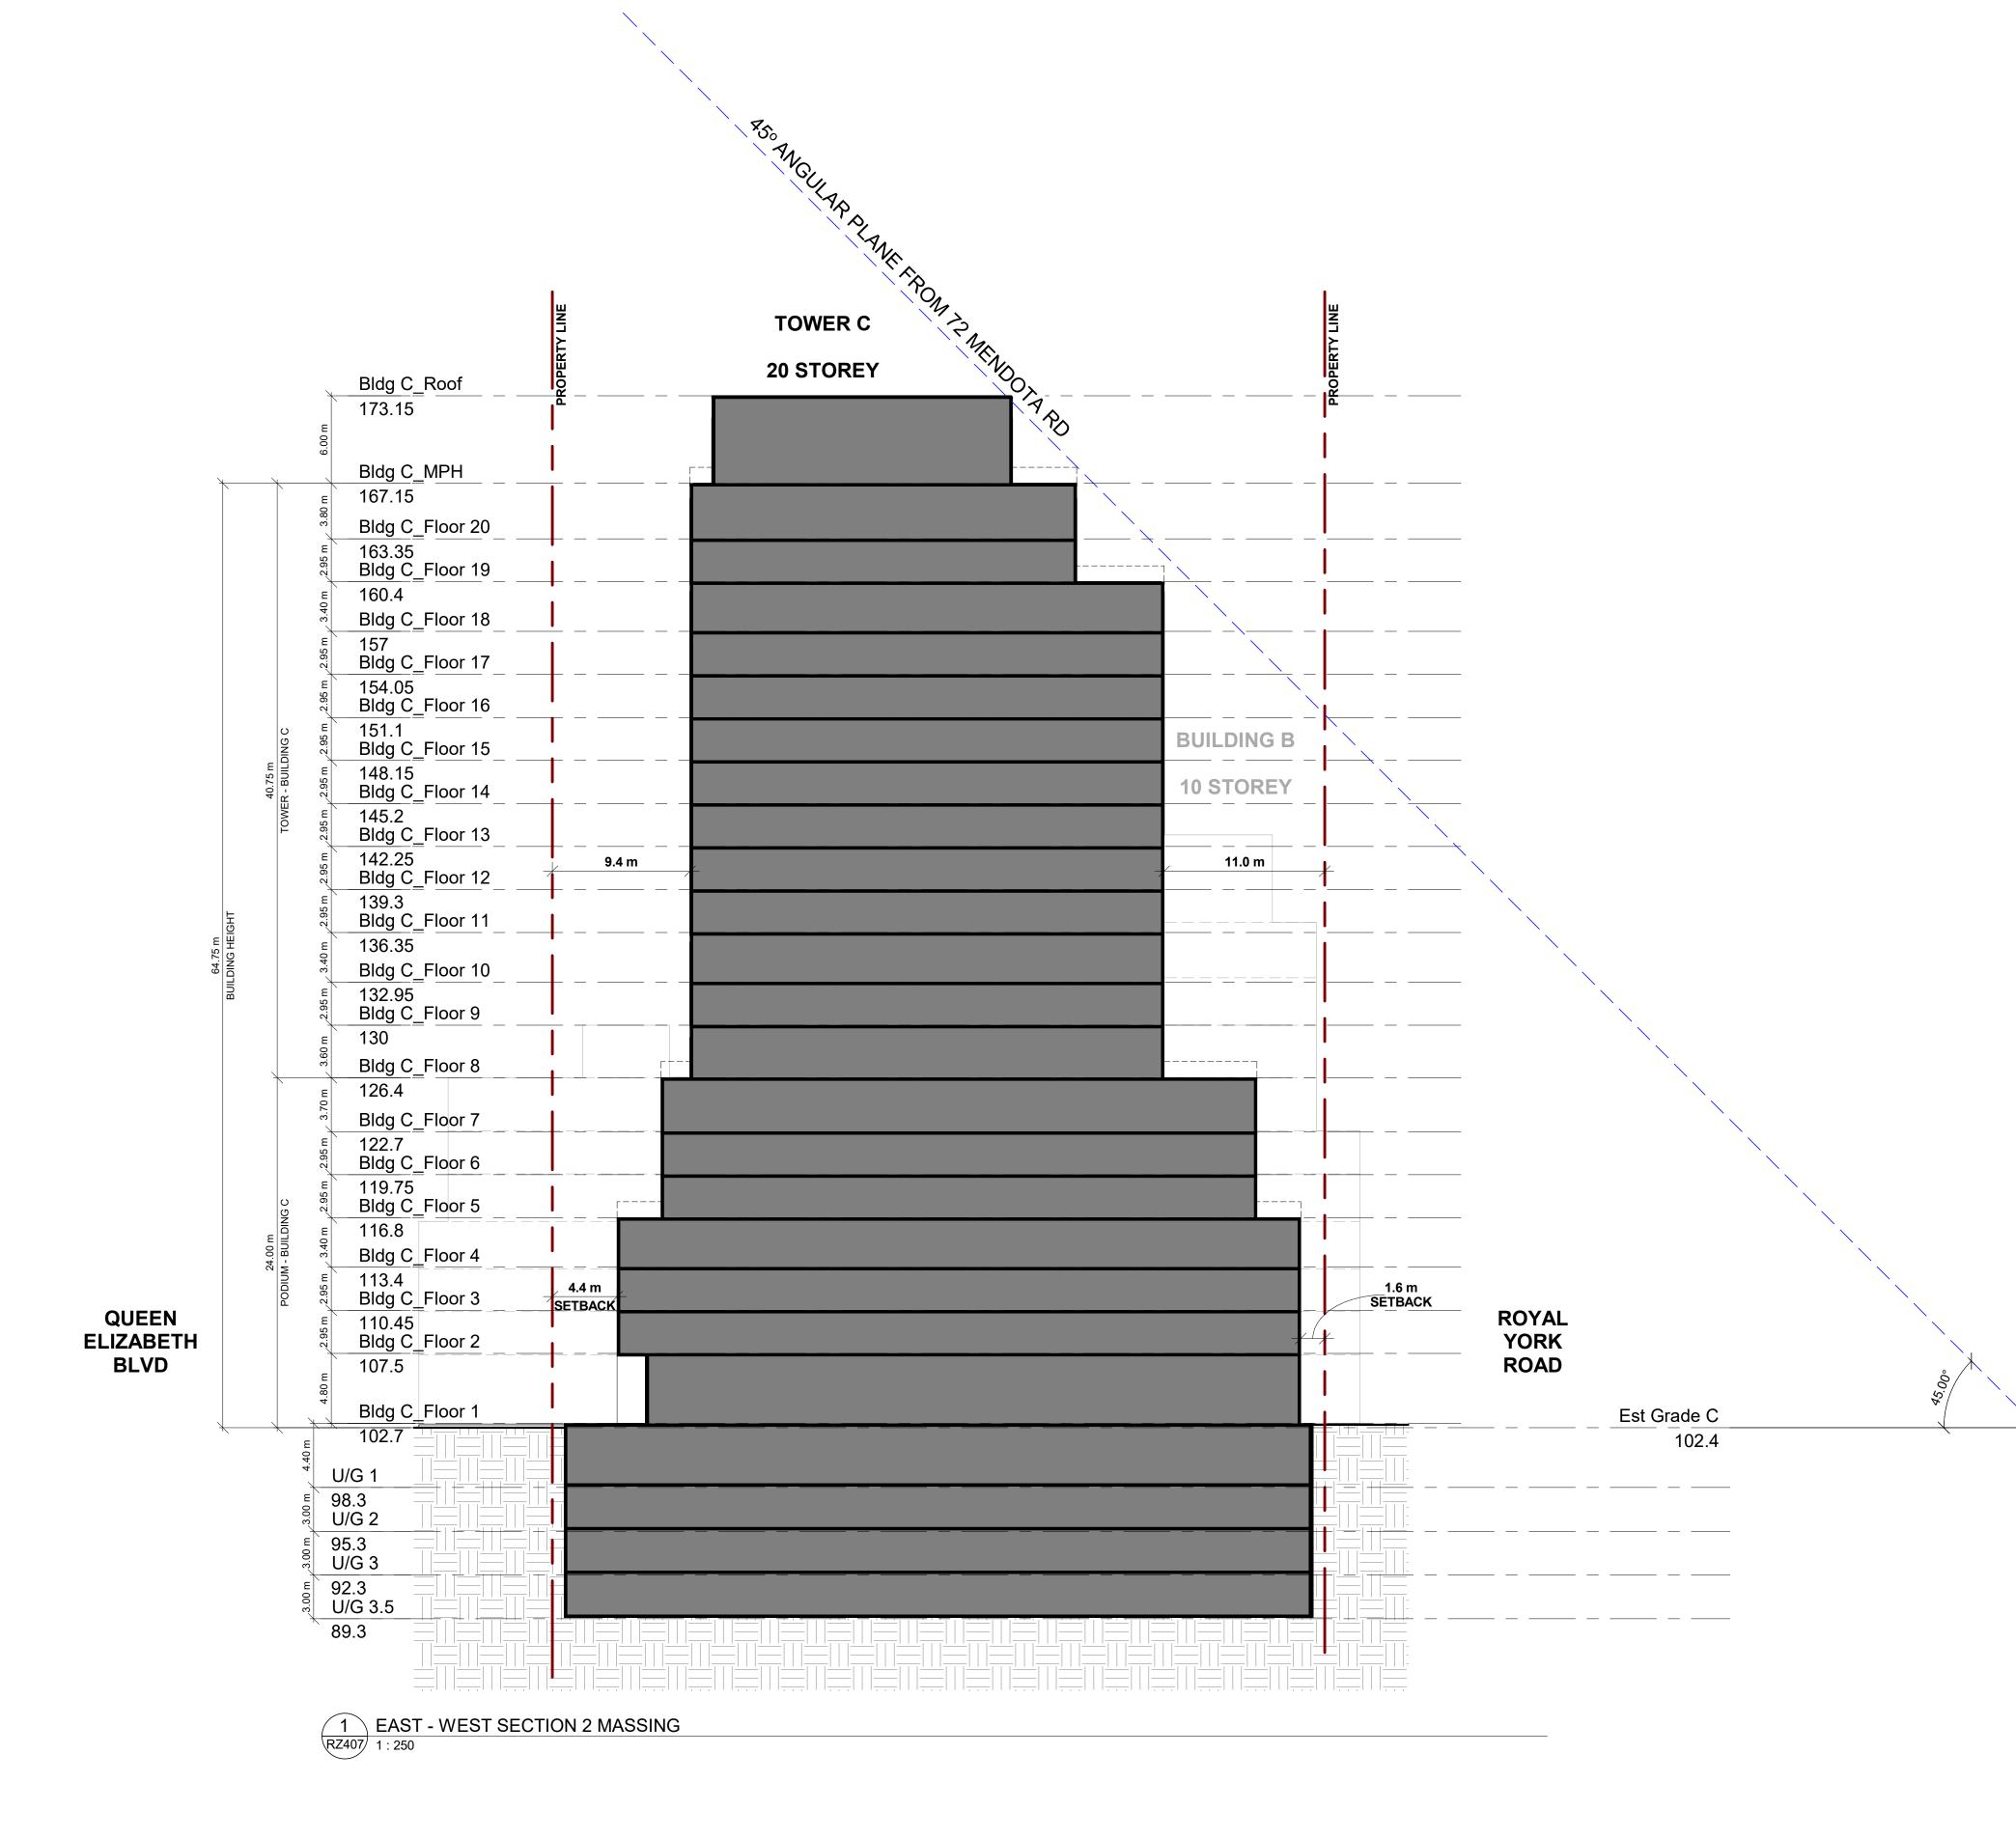

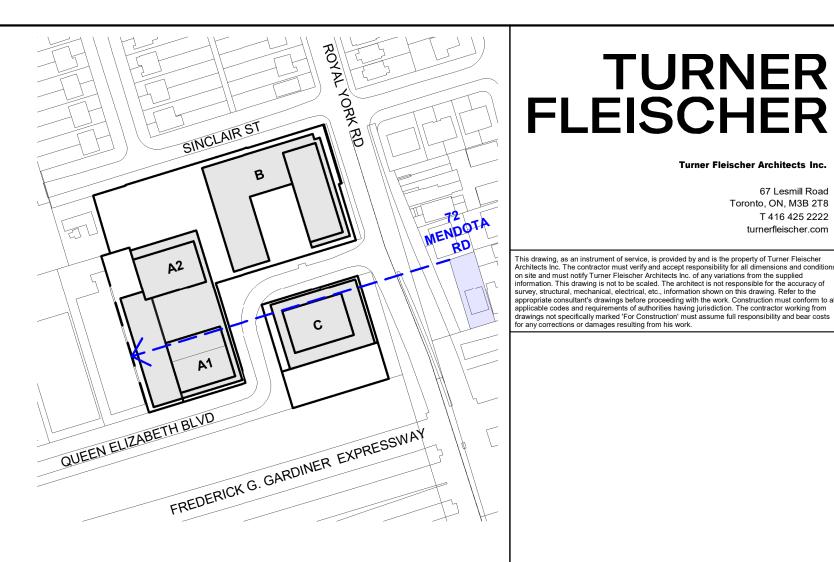

67 Lesmill Road Toronto, ON, M3B 2T8 T 416 425 2222 turnerfleischer.com

WITHOUT PREJUDICE

1 #	2022-05-02 DATE	ISSUED FOR REZONING APPLICATION DESCRIPTION	AYU BY
4			-
2	2022-12-16	ISSUED FOR REZONING APPLICATION	AYU
3	2024-02-21	ISSUED FOR MEDIATION	MNZ
4	2024-03-19	ISSUED FOR MEDIATION	MNZ
5	2024-04-01	ISSUED FOR MEDIATION	MNZ
6	2024-04-23	ISSUED FOR DRAFT SETTLEMENT OFFER REVIEW	MNZ
7	2024-04-30	ISSUED FOR SETTLEMENT OFFER	MNZ
8	2024-05-16	REISSUED FOR SETTLEMENT OFFER	MNZ
9	2024-06-04	REISSUED FOR SETTLEMENT OFFER	MNZ

Queenscorp (Royal York) Inc.

Queen Elizabeth Blvd + Royal York Rd, Toronto, ON

2, 7 and 10 Queen Elizabeth Boulevard, 506, 514, 516, 520, 522 Royal York Rd and 3, 5, 15 Sinclair Street AWING

BUILDING MASSING SECTIONS (C)

RZ407 9

PROJECT NO. 21.191 PROJECT DATE 2024-06-04 DRAWN BY RYT CHECKED BY MNZ SCALE As indicated