
CSG Yonge Manor Limited & CSG Hillsdale Limited
100 Scarsdale Road
Toronto, ON M3B 2R8
Contact Name: Dan Halbert
Phone Number: 416-449-3300
Email: dhalbert@glencorp.com

Hillsdale Ave E + Yonge St Manor Rd E

PROPOSED MIXED-USE DEVELOPMENT Toronto, Ontario

20.222P01

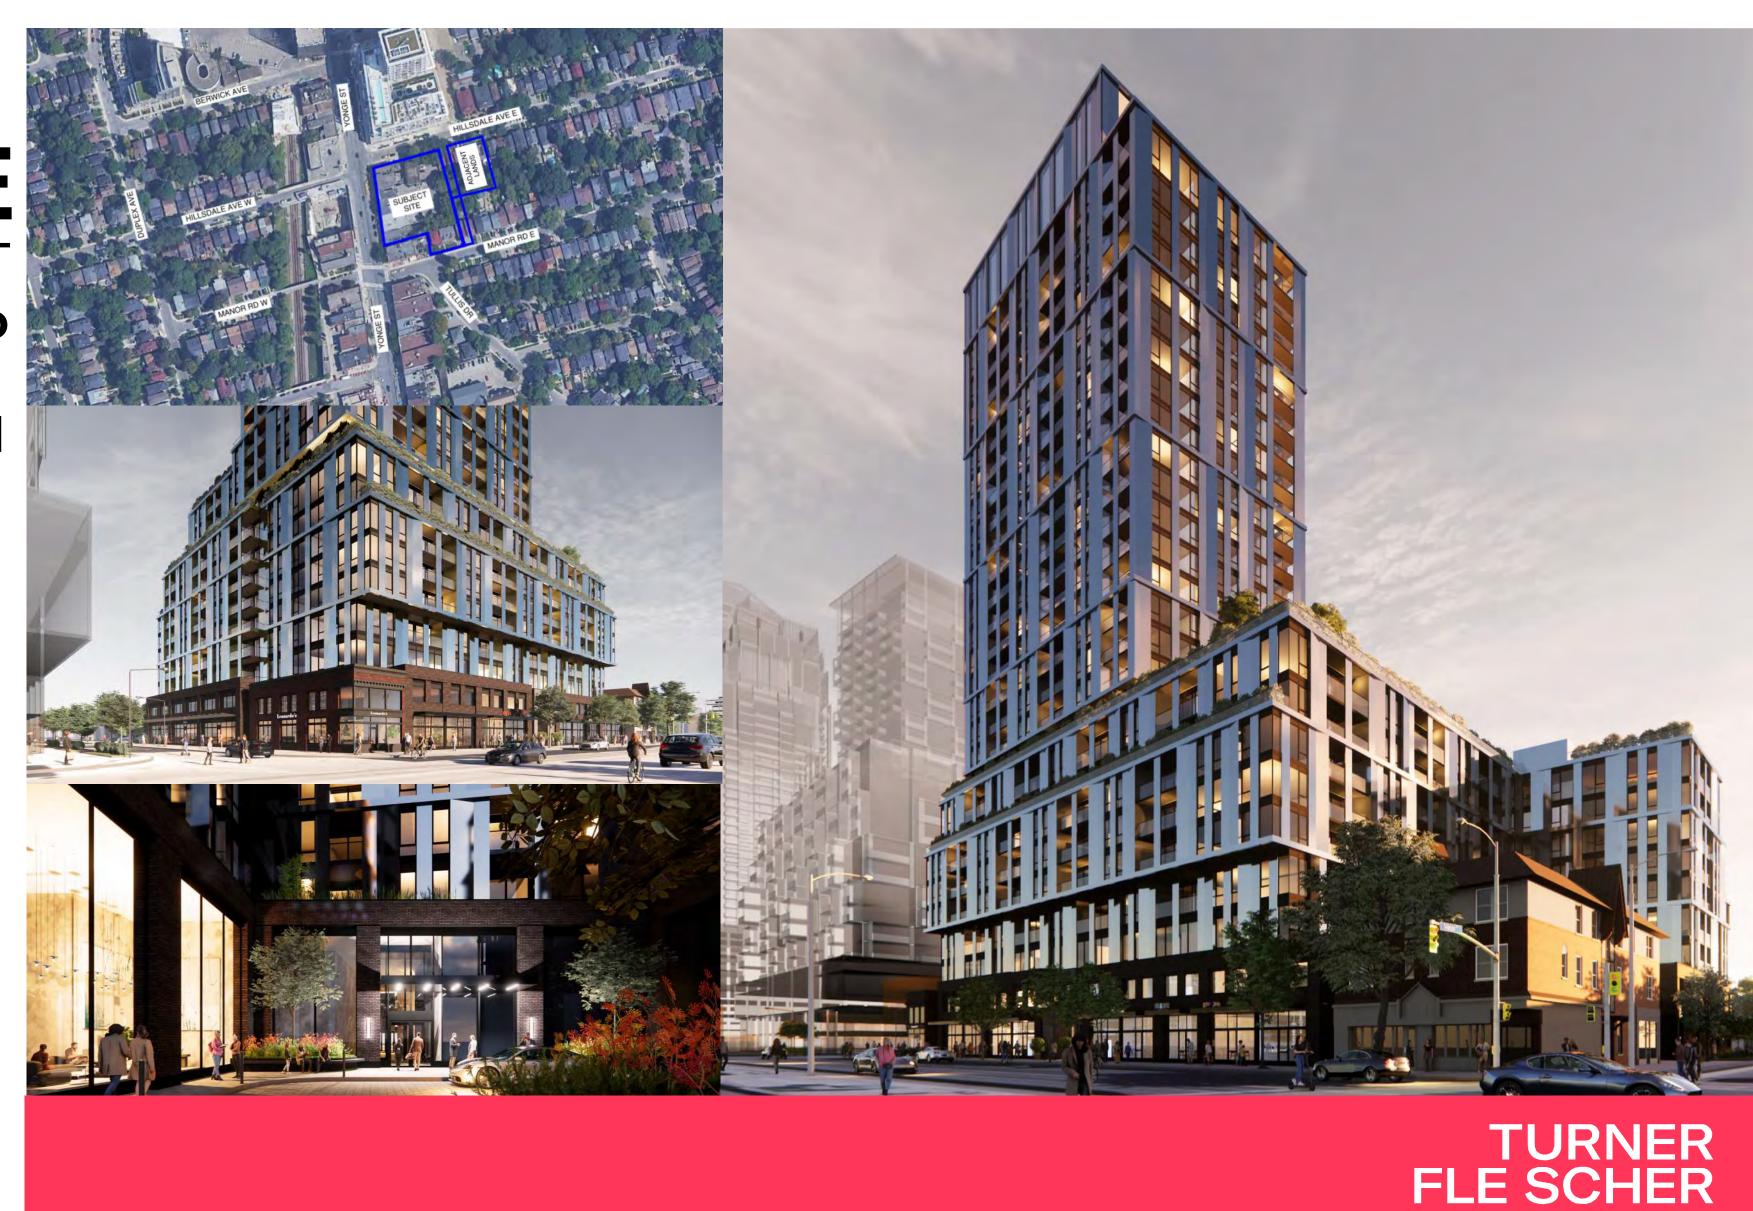

WITHOUT PREJUDICE SET #2 2024-10-02

Planning Consultant

Armstrong 125 Villarboit Crescent Vaughan, ON L4K 4K2 Amanda Kosloski 416-444-3300 x3008 amanda@amstrongplan.ca **Traffic Consultant**

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Heritage Consultant


ERA Architects 625 Church Street #600 Toronto, ON M4Y 2G1 Sharon Hong 416-963-4497 sharonh@eraarch.com

Civil Consultant

WSP Canada Inc. 100 Commerce Valley Drive West Thornhill, ON L3T 0A1 Igor Birchenko 289-982-4270 igor.birchenko@wsp.com

Landscape Consultant

Landscape Planning 95 Mural Street, Suite 207 Richmond Hill, ON L4B 3G2 Shannon Gallant 905-669-6838 sgallant@landscapeplan.ca

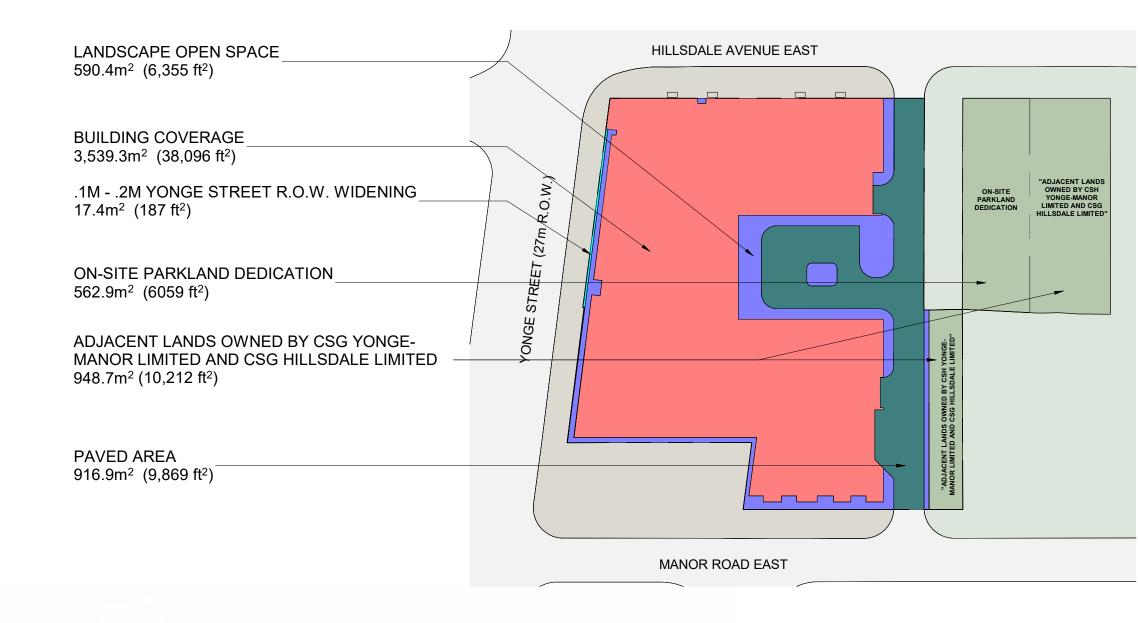

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20.222P01 - 2111 Yonge Street

TORONTO, ONTARIO

PROJECT SUMMARY

CITY OF TORONTO ZONING BY-LAW NO.569-2013

LAND USE	m²	ft ²	%
BUILDING COVERAGE (GROUND FLOOR)	3,539.3	38,096	62.9%
LANDSCAPED OPEN SPACE	590.4	6,355	10.5%
PAVED AREA	916.9	9,869	16.3%
.1M2M YONGE STREET R.O.W. CONVEYANCE	17.4	187	0.3%
ON-SITE PARKLAND DEDICATION	562.9	6,059	10.0%
TOTAL SITE AREA	5,626.9	60,567	100%
ADJACENT LANDS OWNED BY CSG YONGE-MANOR LIMITED AND CSG HILLSDALE LIMITED	948.7	10,212	9%
TOTAL PARK AREA	948.7	10,212	9%

GROSS FLOOR AREA SUMMARY

PARCEL	USE	GFA		FSI
		m²	ft²	
9	RETAIL	1,892.4	20,370	0.34
26 STOREY BUILDING	TOTAL NON-RESIDENTIAL	1,892.4	20,370	0.34
REY B	RESIDENTIAL (INCLUDING RENTAL REPLACEMENT UNITS)	33,632.6	362,018	5.98
5	INDOOR AMENITY			
56 5	TOTAL RESIDENTIAL	33,632.6	362,018	5.98
233	TOTAL	35,525.0	382,388	6.31

TOTAL FLOOR AREA SUMMARY

FLOORS	TFA	
	m²	ft²
U/G 1 - U/G 2	9,594.6	103,275
FLOOR 1 - FLOOR 26	38,767.0	417,285
TOTAL	48,361.6	520,560

GROSS FLOOR AREA DEFINITION

CITY OF TORONTO ZONING BY-LAW NO.569-2013

Gross Floor Area Calculations for a Mixed Use / Apartment Building in the Commercial Residential Zone Category: Gross floor areas means the sum of the total area of each floor level of a building, above and below the ground, measured from the exterior of the main wall of each floor level excluding:

(A)parking, loading and bicycle parking below-ground;
(B)required loading spaces at the ground level and required bicycle parking spaces at or above-ground;
(C)storage rooms, washrooms, electrical, utility, mechanical and ventilation rooms in the basement;
(D)shower and change facilities required by this By-law for required bicycle parking spaces;
(E)amenity space required by this By-law;
(F)elevator shafts; (G)garbage shafts; (H)mechanical penthouse; and (I)exit stairwells in the **building**.

ELECTRIC VEHICLE INFRASTRUCTURE

Residential and Non-residential Uses:

Parking spaces must be equipped with an energized outlet, which is clearly marked and identified for electric vehicle charging, in accordance with Zoning By-law 569-2013, as amended:

A) all residential parking spaces provided for dwelling units located in an apartment building, mixed use building, multiple dwelling unit building, excluding visitor parking spaces, must include an energized outlet capable of providing Level 2 charging or higher to the parking space; and,

B) in cases other than those set out in (A) above, 25 percent of the residential and non-residential parking spaces in a building must include an energized outlet capable of providing Level 2 charging or higher.

GROSS FLOOR AREA (GFA) BREAKDOWN

FLOOR # OF U		FUNITS		RETAIL	TOTAL RETAIL		RESIDENTIAL					TOTAL RESIDENTIAL [GFA] (TFA - EXC								
TEOON	# Or Oil		RET	AIL	G	ALLERIA	RETAIL	SERVICE	TOTALK	- IAIL	SALEA	BLE	RENTAL REF	PLACEMENT	NON-SALE	ABLE	TOTAL NESID	ENTIAL	towal (in the	,200,010
	#		m²	ft²	m²	ft²	m²	ft²	m²	ft²	m²	ft²	m²	ft²	m²	ft²	m²	ft²	m²	ft²
U/G 2															30.9	333	30.9	333	30.9	
U/G 1											193.6	2,084			30.8	332	224.4	2,415	224.4	
1		4	1,783.9	19,202		فنفضاة	108.5	1,168	1,892.4	20,370	241.8	2,603			458.2	4,932	700.0	7,535	2,592.4	
MEZZANIN	E										241.9	2,604					241.9	2,604	241.9	
2		39							. 1		2,420.5	26,054			482.7	5,196	2,903.2	31,250	2,903.2	
3		38									1,937.6	20,856	394.4	4,245	487.4	5,246	2,819.4	30,348	2,819.4	
4		30											2,552.7	27,477	373.7	4,022	2,926.4	31,500	2,926.4	
5		36									2,444.8	26,316			403.7	4,345	2,848.5	30,661	2,848.5	
6		36									2,416.9	26,015			403.7	4,345	2,820.6	30,361	2,820.6	
7		36									2,274.6	24,484			370.5	3,988	2,645.1	28,472	2,645.1	
8		36									2,195.1	23,628			370.7	3,990	2,565.8	27,618	2,565.8	1.3
9	18	4									316.8	3,410			101.4	1,091	418.2	4,501	418.2	
10		16									899.3	9,680			121.2	1,305	1,020.5	10,985	1,020.5	
11		16							-		889.7	9,577			121.2	1,305	1,010.9	10,881	1,010.9	- 2
12		12							l. n		695.8	7,490			54.1	582	749.9	8,072	749.9	
13		12									647.7	6,972			54.1	582	701.8	7,554	701.8	
14		12									638.6	6,874			54.1	582	692.7	7,456	692.7	
15		12									638.6	6,874			54.1	582	692.7	7,456	692.7	
16		12									638.6	6,874			54.1	582	692.7	7,456	692.7	
17		12									638.6	6,874			54.1	582	692.7	7,456	692.7	
18		12									638.6	6,874			54.1	582	692.7	7,456	692.7	
19		12									638.6	6,874			54.1	582	692.7	7,456	692.7	
20		12									638.6	6,874			54.1	582	692.7	7,456	692.7	
21		12									638.6	6,874			54.1	582	692.7	7,456	692.7	
22		12								1	638.6	6,874			54.1	582	692.7	7,456	692.7	
23		12									638.6	6,874			54.1	582	692.7	7,456	692.7	
24		12							4		638.6	6,874			54.1	582	692.7	7,456	692.7	
25		12									638.6	6,874			54.1	582	692.7	7,456	692.7	
26		12	The state of the s								638.6	6,874			54.1	582	692.7	7,456	692.7	
MPH																				
							70												EXCESS INDOOR (INCLUDED I	
TOTAL		471	1,783.9	19,202			108.5	1,168	1,892.4	20,370	26,117.9	281,131	2,947.1	31,722	4,567.6	49,165	33,632.6	330,296	35,525.0	38

GROSS FLOOR AREA BREAKDOWN

AMENITY BREAKDOWN

OUTDOOR AM	IENITY	INDOOR AMENITY			
m²	ft²	m²	ft²		
		297.5	3,202		
942.0	10,140	644.5	6,93		
942.0	10,140	942.0	10,140		

5 2024-10-02 WITHOUT PREJUDICE SET #2
4 2024-03-18 WITHOUT PREJUDICE SET
2 2023-11-08 REZONING RESUBMISSION
1 2023-08-15 ISSUED FOR REZONING
DATE DESCRIPTION

Hillsdale Ave E + Yonge St + Manor Rd E

Toronto, Ontario

STATISTICS

PROJECT NO. 20.222P01 PROJECT DATE 2023-03-10 DRAWN BY TKA CHECKED BY RMM

: 750

AMENITY AREAS - REQUIRED & PROVIDED

	ТУРЕ	REQ	UIRED	PROVIDED			
9		RATIO	m2	ft2	RATIO	m2	ft2
ILDIN	INDOOR AMENITY	2.0 m2/UNIT	942.0	10,140	2.0 m2 / UNIT	942.0	10,140
OREY BU	OUTDOOR AMENITY	TOTAL AMENITY REQUI			2.0 m2 / UNIT	942.0	10,140
26 STOREY	TOTAL AMENITY	4.0 m2/ UNIT	1,884.0	20,279	4.0 m2 / UNIT	1,884.0	20,279

^{*} AMENITY REQUIRED AS PER CITY OF TORONTO ZONING BY-LAW NO. 569-2013

UNIT MIX - PROVIDED (RENTAL REPLACEMENT UNITS INCLUDED)

FLOOR	O TIDED (III			UNIT TYP					A	AVERAGE	UNIT SIZE
	STUDIO	1B	1B+D	2В	2B+D	3В	3B+D	4B	TOTAL	m²	ft²
1						4			4	60.5	651
2		6	16	8	5	4			39	62.1	668
3		10	11	9	2	6			38	61.4	661
4		15		7		4	1	3	30	85.1	916
5		4	12	5	7	8			36	67.9	731
6		4	14	3	8	7	1		36	67.1	723
7		5	11	12	3	5			36	63.2	680
8		5	13	11	3	4			36	61.0	656
9				1		3			4	79.2	853
10		7	5	2		2			16	56.2	605
11		7	5	2		2			16	55.6	599
12		4	4	2		2			12	58.0	624
13		4	5	2	1				12	54.0	581
14		4	5	3					12	53.2	573
15		4	5	3					12	53.2	573
16		4	5	3					12	53.2	573
17		4	5	3					12	53.2	573
18		4	5	3					12	53.2	573
19		4	5	3					12	53.2	573
20		4	5	3					12	53.2	573
21		4	5	3					12	53.2	573
22		4	5	3					12	53.2	573
23		4	5	3					12	53.2	573
24		4	5	3					12	53.2	573
25		4	5	3					12	53.2	573
26		4	5	3					12	53.2	573
SUBTOTAL		123	161	103	29	51	1	3	471		
TOTAL UNITS		2	84	1:	32	5	2	3	7/2	55.5 597	
UNIT MIX		26.11%	34.18%	21.87%	6.16%	10.83%	0.21%	0.64%	100.0%	33.3	337
TOTAL UNIT MIX		60.	30%	28.	03%	11.0	04%	1%	100.070		

EVSE PARKING - REQUIRED

	USE	RA	TIO	TOTAL
SC CTODEV		100%	25%	
6 STOREY	RESIDENTIAL	239		239
BUILDING	VISITOR / RETAIL		3	3
	TOTAL PROVIDED	239	3	242

^{*} EVSE PARKING RATES PER TORONTO ZONING BY-LAW 569-2013 / TGS VERSION 4

EVSE PARKING - PROVIDED

	FLOOR	l t	TOTAL	
		RESIDENTIAL	VISITOR / RETAIL	
26 STOREY BUILDING	U/G LEVEL 1	106	3	109
BUILDING	U/G LEVEL 2	133		133
	TOTAL PROVIDED	239	3	242

^{*} EVSE PARKING RATES PER TORONTO ZONING BY-LAW 569-2013 / TGS VERSION 4

PARKING SPACE RATES (RENTAL REPLACEMENT UNITS INCLUDED)

USE	RATIO (MIN.)	UNITS / GFA (m²)	SPACES (MIN.)
STUDIO UNITS (MAX)	0.30 / UNIT		
1B & 1B+D UNITS (MAX)	0.50 / UNIT	284	142
2B & 2B+D UNITS (MAX) 3B, 3B+D, 4B UNITS (MAX)	0.80 / UNIT	132	105
	1.00 / UNIT	55	55
TOTAL RESIDENTIAL (MA	X)		302
VISITOR (2.0 + .01 PER DWELLING UNIT) (MIN)	0.01 / UNIT	471	7
RETAIL (CAN BE SHARED I VISITOR) (MAX)	3.5 SPACES / 100 M2	1,892	67
And the second second second second second second second	ED PARKING SPACES IS THE CUMULATIVE MININ PARKING SPACES IS THE CUMULATIVE MAXIMUN		
TOTAL REQUIRED (CUMU	LATIVE MINIMUM)	1	7
TOTAL PERMITTED (CUM	ULATIVE MAXIMUM)		376

^{*} VEHICULAR PARKING RATIOS AS PER CITY OF TORONTO ZONING BY-LAW 89-2022 PER TABLE 200.5.10.1

VEHICULAR PARKING - PROVIDED

FLOOR	DECIDENTIAL	RESIDENTIAL	VISITOR / RETAIL	TOTAL
	RESIDENTIAL	PRIVATE PARKING SPACES	(SHARED TOTAL)	
FLOOR 1				
U/G LEVEL 1	102	4	12	118
U/G LEVEL 2	133			133
TOTAL PROVIDED	235	4	12	251

^{*} VEHICULAR PARKING RATIOS AS PER CITY OF TORONTO ZONING BY-LAW 89-2022

ACCESSIBLE PARKING - REQUIRED

USE	RATIO (MIN.)	MIN. B/F REQ'D
RESIDENTIAL (BY-LAW 1048 2022)	5 + 1 PER 50 EFFECTIVE PARKING SPACES	10
	TOTAL RESIDENTIAL	10
VISITOR / RETAIL	LESS THAN 13 EFFECTIVE SPACES (1)	1
TOTAL NON-RESIDENTIAL		1
ТО	TAL ACCESSIBLE PARKING SPACES REQUIRED	11

^{*} VEHICULAR PARKING RATIOS AS PER CITY OF TORONTO ZONING BY-LAW 89-2022 AS AMENDED.

ACCESSIBLE PARKING - PROVIDED

FLOOR	SPA	ACES	TOTAL
ATTACK TO STATE OF THE PARTY OF	RESIDENTIAL	VISITOR / RETAIL	
FLOOR 1			
U/G LEVEL 1	5	1	6
U/G LEVEL 2	5		5
TOTAL PROVIDED	10	1	11

^{*} ACCESSIBLE PARKING INCLUDED IN "VEHICULAR PARKING - PROVIDED"

BICYCLE DADKING - DECLIDED (DENTAL DEDLACEMENT LINITS INCLUDED)

USE	RESIDENTIAL		NON-RESIDENTIAL		TOTAL
USE	RATIO	SPACES	RATIO	SPACES	IOIAL
SHORT TERM	0.20 / UNIT	95	TOTAL RETAIL AREA LESS THAN	2000m ² - NO BICYCLE	9
LONG TERM	0.90 / UNIT	424	PARKING SPACE IS	REQUIRED	42
TOTAL REQUIRED		519	Charles and the second		51

^{*} BICYCLE PARKING RATIOS AS PER CITY OF TORONTO ZONING BY-LAWS 569-2013 & 89-2022 AS AMENDED.

BICYCLE PARKING - PROVIDED

		RESIDENTIAL		N	ON-RESIDENTIA	AL	TOTAL
FLOOR	SHORT TERM	LONG TERM	SUB-TOTAL	SHORT TERM	LONG TERM	SUB-TOTAL	IOIA
FLOOR 1	95	26	121				121
U/G LEVEL 1		120	120				120
U/G LEVEL 2		286	286				286
TOTAL PROVIDED	95	424	519				519

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5 2024-10-02 WITHOUT PREJUDICE SET #2
4 2024-03-18 WITHOUT PREJUDICE SET
5 2023-11-08 REZONING RESUBMISSION
6 2023-08-15 ISSUED FOR REZONING
7 DATE DESCRIPTION

Hillsdale Ave E + Yonge St + Manor Rd E

Toronto, Ontario

STATISTICS

PROJECT NO. 20.222P01 PROJECT DATE 2023-03-10 CHECKED BY

SPA003 REV. 5

UNIT MIX - PROVIDED (RENTAL REPLACEMENT UNITS EXCLUDED)

FLOOR				UNIT TYP	E					AVERAGE	UNIT SIZE
	STUDIO	1B	1B+D	2В	2B+D	3В	3B+D	4B	TOTAL	m²	ft²
1						4			4	60.5	651
2		6	16	8	5	4			39	62.1	668
3		4	11	9	2	5			31	62.5	673
4											
5		4	12	5	7	8			36	67.9	731
6		4	14	3	8	7			36	67.1	723
7		5	11	12	3	5			36	63.2	680
8		5	13	11	3	4			36	61.0	656
9				1		3			4	79.2	853
10		7	5	2		2			16	56.2	605
11		7	5	2		2			16	55.6	599
12		4	4	2		2			12	58.0	624
13	L.	4	5	2	1				12	54.0	581
14		4	5	3					12	53.2	573
15		4	5	3					12	53.2	573
16		4	5	3					12	53.2	573
17		4	5	3					12	53.2	573
18		4	5	3					12	53.2	573
19		4	5	3					12	53.2	573
20		4	5	3					12	53.2	573
21		4	5	3					12	53.2	573
22		4	5	3					12	53.2	573
23		4	5	3					12	53.2	573
24		4	5	3					12	53.2	573
25		4	5	3					12	53.2	573
26		4	5	3					12	53.2	573
SUBTOTAL		102	161	96	29	46			434		
TOTAL UNITS	- 2	2	63	1	25	4	16		434	60.2	648
JNIT MIX		23.50%	37.10%	22.12%	6.68%	10.60%	5.		100.0%	00.2	040
TOTAL UNIT MIX	1	60.	60%	28.	80%	10.	60%		100.076		

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5 | 2024-10-02 | WITHOUT PREJUDICE SET #2 | # | DATE | DESCRIPTION

Hillsdale Ave E + Yonge St + Manor Rd E


Toronto, Ontario

STATISTICS

PROJECT NO.
20.222P01
PROJECT DATE 2023-03-10
DRAWN BY
NMU
CHECKED BY
RMM
SCALE

SPA004 SPA004

DITUDING / LINIT ADDRESS	EVISTING LIMIT TYPE	EXISTING UNIT AREA	EXISTING UNIT AREA	PROPOSED UNIT	PROPOSED	PROPOSED	PROPOSED	DIFFE	RENCE
BUILDING / UNIT ADDRESS	EXISTING UNIT TYPE	m ²	ft ²	NUMBER	UNIT TYPE	UNIT AREA	UNIT AREA		
	HOUSES	***				m ²	ft ²	m²	1
41 HILLSDALE AVENUE EAST	4B	162.0	1744	UNIT 28	4B	162.0	1744	0.0	
9 HILLSDALE AVENUE EAST (UNIT 2)	2B	102.0	1098	UNIT 30	2B	102.0	1098	0.0	
9 HILLSDALE AVENUE EAST (UNIT 1)	1B + BASEMENT	121.0	1302	UNIT 13	1B+D	122.0	1313	1.0	
37 HILLSDALE AVENUE EAST	3B	119.2	1283	UNIT 2	3B	125.9	1355	6.7	
35 HILLSDALE AVENUE EAST	3B+D	119.3	1284	UNIT 12	3B+D	119.5	1286	0.2	
31 HILLSDALE AVENUE EAST	3B	114.5	1233	FL 3 - UNIT 7	3B	114.5	1233	0.0	
12 MANOR ROAD EAST	4B	127.8	1376	UNIT 9	4B	127.9	1377	0.1	
14 MANOR ROAD EAST	3B	108.4	1167	UNIT 27	3B	108.6	1169	0.2	
16 MANOR ROAD EAST	3B	108.6	1169	UNIT 14	3B	109.0	1173	0.4	
18 MANOR ROAD EAST	3B	134.2	1445	UNIT 29	3B	134.2	1445	0.0	
20 MANOR ROAD EAST	4B	134.2	1445	UNIT 11	4B	134.3	1446	0.1	
HOUSES (TOTAL ARE	A)	1351.4	14546	TOTAL AF	REA	1359.9	14638	8.6	9
	4-PLEX							. 9.00	
11 HILLSDALE AVENUE EAST	2B	92.0	990	UNIT 17	2B	93.1	1002	1.1	
11 HILLSDALE AVENUE EAST (UP)	2B	98.8	1063	UNIT 26	2B	99.9	1075	1.1	
9 HILLSDALE AVENUE EAST	2B	92.0	990	UNIT 24	2B	93.0	1001	1.0	
9 HILLSDALE AVENUE EAST (UP)	2B	98.8	1063	UNIT 25	2B	99.0	1066	0.2	
4-PLEX (TOTAL AREA	N)	381.5	4106	TOTAL AF	REA	385.0	4144	3.5	
30 350 (120)	YONGE APARTMENTS	5.5.516	-						
1 HILLSDALE AVENUE EAST (1)	1B	50.6	545	UNIT 16	1B	51.0	549	0.4	
1 HILLSDALE AVENUE EAST (2)	1B	52.0	560	UNIT 15	1B	52.5	565	0.5	
1 HILLSDALE AVENUE EAST (3)	1B	39.6	426	FL 3 - UNIT 4	1B	43.2	465	3.6	
2079 (1)	1B	56.1	604	UNIT 19	1B	56.5	608	0.4	
2085 (1)	1B	55.6	598	UNIT 10	1B	56.2	605	0.6	
2085 (2)	1B	55.8	601	UNIT 5	1B	55.8	601	0.0	
2093 (1)	1B	54.6	588	UNIT 3	1B	56.2	605	1.6	
2093 (2)	1B	41.9	451	UNIT 7	1B	42.0	452	0.1	
2093 (3)	1B	60.0	646	UNIT 18	1B	60.9	656	0.9	
2093 (4)	1B	39.5	425	FL 3 - UNIT 2	1B	40.4	435	0.9	1
2099 (3)	1B	56.9	612	UNIT 6	1B	56.9	612	0.0	
2099 (4)	1B	36.2	390	FL 3 - UNIT 3	1B	38.4	413	2.2	
2101 (1)	1B	50.8	547	UNIT 22	1B	50.9	548	0.1	
2101 (2)	1B	41.6	448	UNIT 20	1B	42.0	452	0.4	
2101 (3)	1B	55.3	595	FL 3 - UNIT 1	1B	60.9	656	5.6	
2101 (4)	1B	39.8	428	FL 3 - UNIT 5	1B	43.2	465	3.4	
2105 (1)	1B	63.0	678	UNIT 1	1B	63.0	678	0.0	
2105 (2)	1B	63.7	686	UNIT 8	1B	64.0	689	0.3	1
2107 (1)	2B	78.9	849	UNIT 21	2B	79.0	850	0.1	
2107 (2)	1B	53.9	580	UNIT 4	1B	53.9	580	0.0	
2107 (3)	2B	81.0	872	UNIT 23	2B	81.0	872	0.0	
2107 (4)	1B	53.9	580	FL 3 - UNIT 6	1B	53.9	580	0.0	
HOUSES (TOTAL ARE	A)	1180.7	12709	TOTAL AF	REA	1201.8	12936	21.1	2
TOTAL AREA		2913.5	31361	COMBINED TO	TAL AREA	2946.7	31718	33.2	35

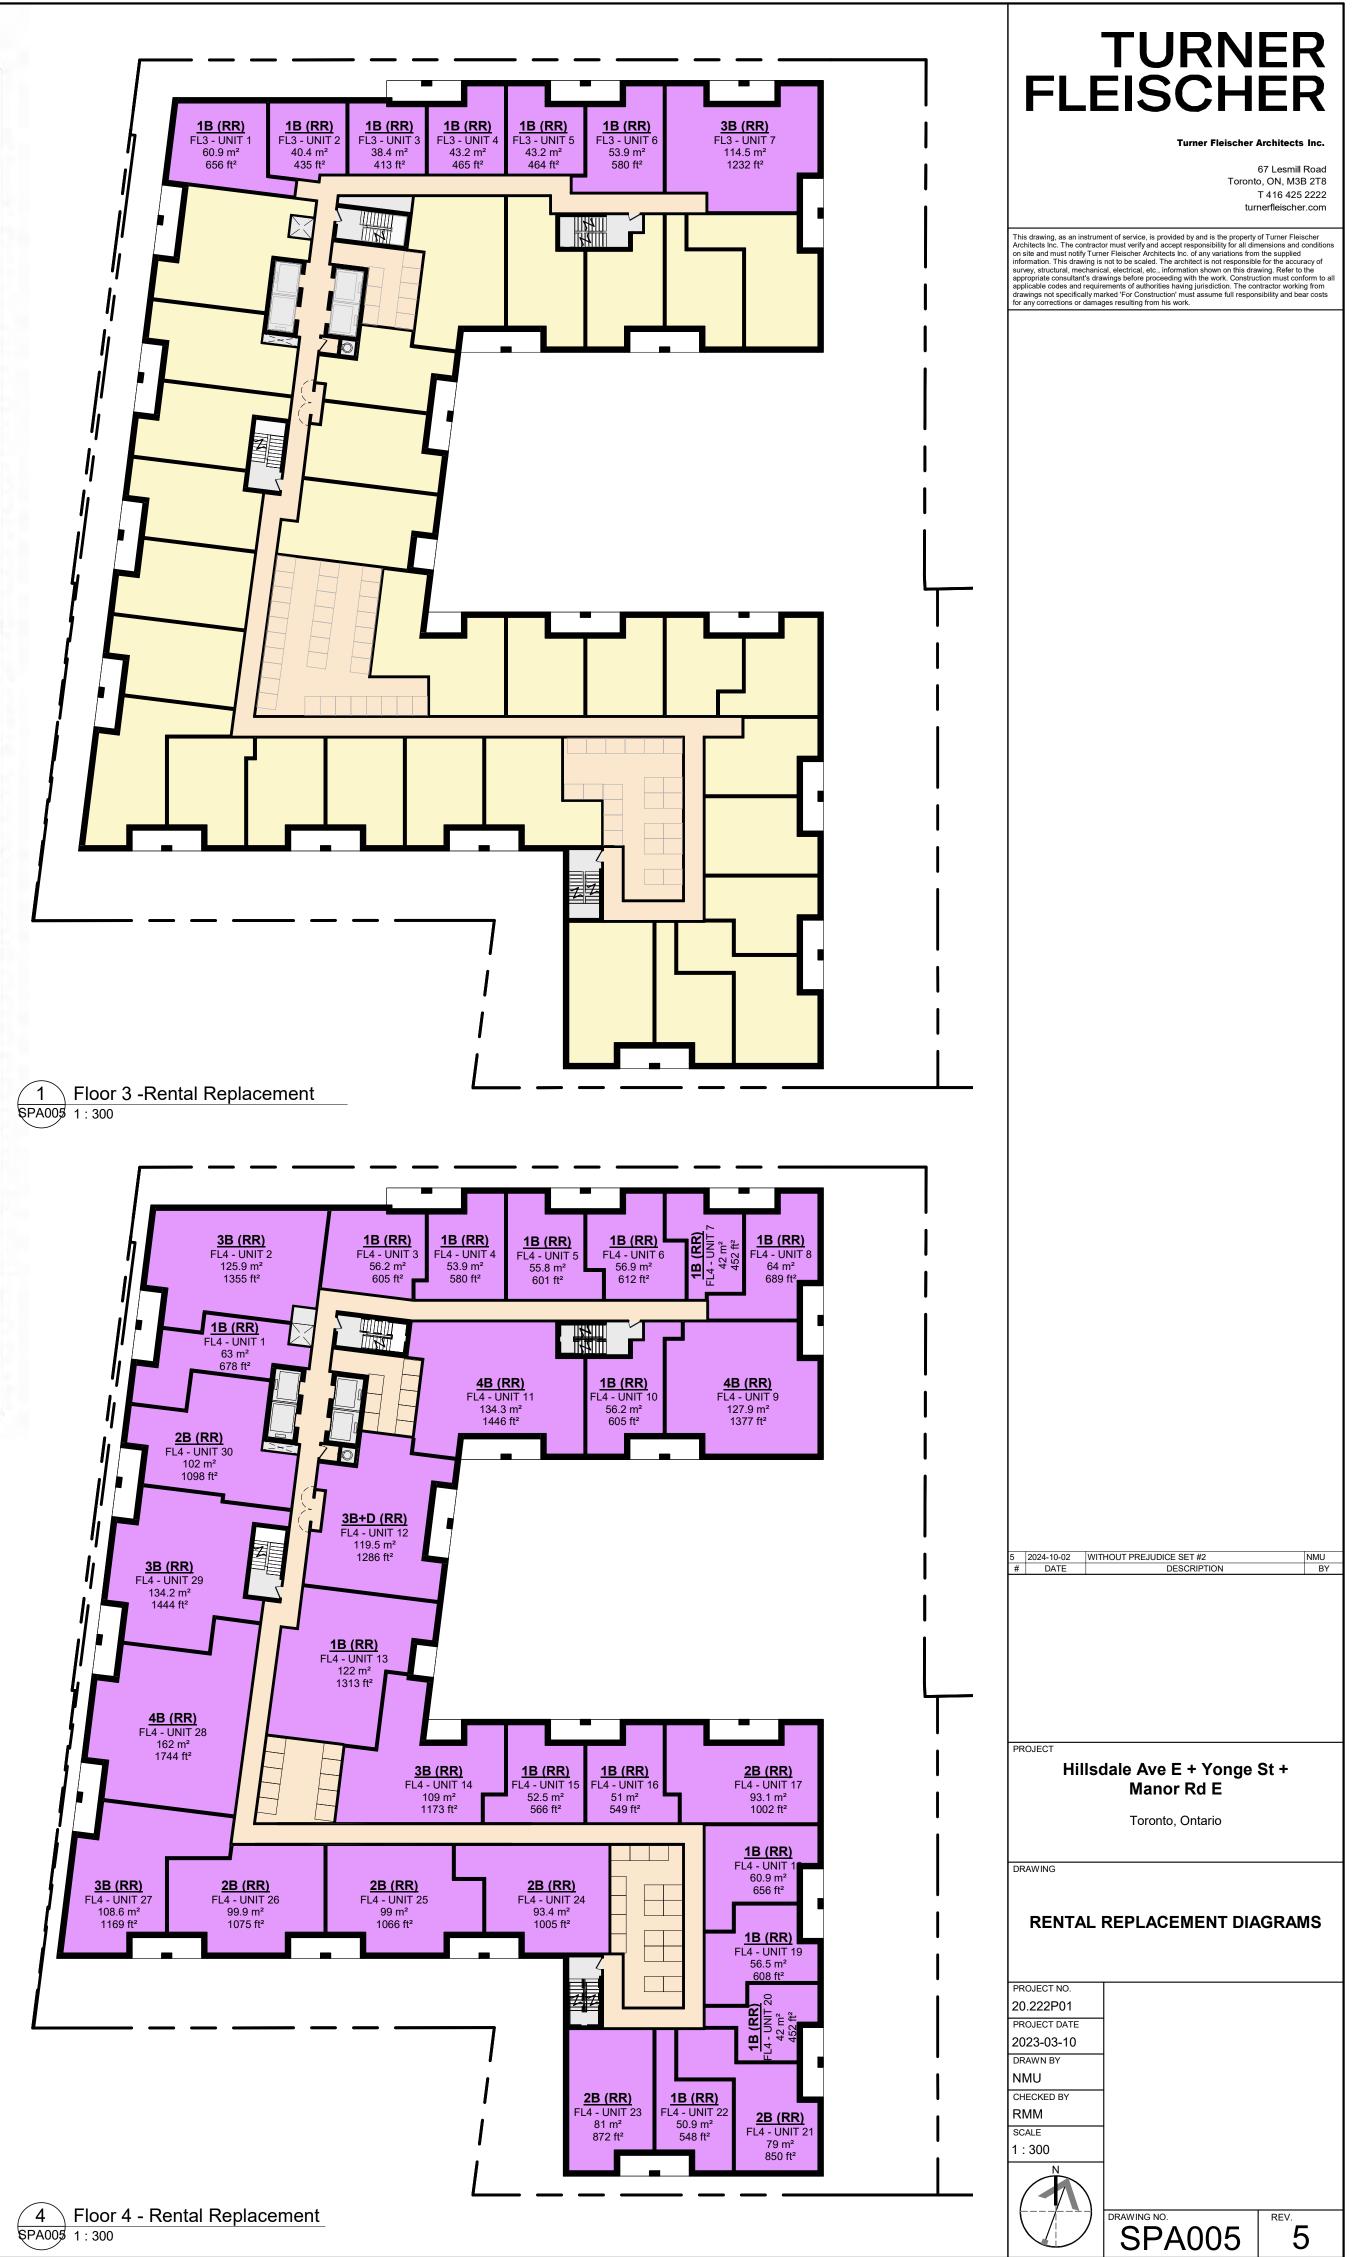

MG CC. 77. 77 77 700

Checklist – Toronto Green Standard Version 4.0 2022 TGS Version 4.0 Checklist: Mid to High Rise Residential and all New Non-Residential Development

Business Telephone Number: 416-444-3300 x3008

Registered Owner (First, Last Name): CSG Yonge-Manor Ltd + CSG Hillsdale Ltd

TGS Version 4.0 Checklist: Mid to High Rise Residential and

Complete in conjunction with the full Toronto Green Standard Version 4.0 (TGS V4.0) and Specifications.

Tier 1 performance measures are required by the City and must be included as part of your approved development application. Tier 2 and 3 higher performance levels are voluntary and associated with financial incentives. To determine eligibility for incentives go to

Performance Level: ☐ Tier 1 (Required) ☐ Tier 2 ☐ Tier 3

Application Information: Site Plan Control Zoning Bylaw Amendment Draft Plan of Subdivision

Date Received (yyyy-mm-dd): Community Planner (First, Last Name): L Is this checklist revised from an earlier submission? \Box Yes \Box No Gross Floor Area (m²); 35525.0 Number of Storeys; 26 Number of Units; 471 Non Residential Gross Floor Area (m²); 1892.4 Proposal Description: (Include a narrative of your project highlighting green attributes or performances measures): Mixed Use building with retail at grade fronting Yonge Street and Hillsdale Avenue East with 8-storey podium and 18-storey tower (total height 26-storeys).

Business Email: amanda@armstrongplan.ca

Project Name: 2111 Yonge Street Applicant/Agent

Property and Applicant Information:

Address of Subject Land (Street Number and Name)

Name(First, Last Name): Amanda Kosloski for Armstrong Planning

2079-2111 Yonge Street, 9-11, 21 and 31 Hillsdale Avenue East and 12-18 Manor Road East

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Checklist – Toronto Green Standard Version 4.0 2022

all New Non-Residential Development

Section	Development Feature	Tier 1 Performance Measure (See full standards and specifications for details and definitions)	Documentation Required for Site Plan Approval (Sections marked with an asterisk" are required for Rezoning or Subdivision applications)	Plans and Drawing:
*WQ 1.1	Water Balance, Quality Control & Quantity Control	Design the site to achieve all Water Balance, Water Quality and Water Quantity control targets required by the Wet Weather Flow Management Guidelines	 ☑ Stormwater Management Report ☐ Notations on Plans (Landscape, Grading, Roof and Details) indicate green infrastructure features and locations consistent with Stormwater Report 	Plan Numbers:
'WQ 1.2	Green Streets	Capture and control stormwater runoff from new streets in accordance with the City's green infrastructure standards and specifications for the Right-of-Way	☐ Stormwater Management Report ☐ Landscape and Planting Plan, Public Utilities Plan consistent with Stormwater Report ☐ Notations indicate locations, feature type, location, dimensions and details	Plan Numbers:
WQ 1.3	On-site Green Infrastructure	Landscaped site area includes at least one of the following features: Enhanced Green Roof Enhanced landscape using pollinator plants Bioretention facility Reforested Area	 Notations on the Roof Plan, Landscape and Planting Plans to indicate features size, type, location and plant lists □ Plan list identifies pollinator species if applicable □ Green Infrastructure Statistics Template □ Green Roof Statistics Template ☑ Stormwater Management Report references 	Plan Numbers:

Checklist – Toronto Green Standard Version 4.0 2022 TGS Version 4.0 Checklist: Mid to High Rise Residential and

all New Non-Residential Development

Section	Development Feature	Tier 1 Performance Measure (See full standards and specifications for details and definitions)	Documentation Required for Site Plan Approval (Sections marked with an asterisk* are required for Rezoning or Subdivision applications)	Plans and Drawings
SW 1.3	Bulky Waste	Provide 10m2 for bulky and special collection items (Residential)	☑ Notations on Plans indicate area and	Plan Numbers:
		collection fierts (kesidefilidi)	location for bulky items collection	SPA008, SPA151
SW 1.4	Compaction	Waste storage room with space for containers and the compactor unit	☑ Notations on Plans indicate area and	Plan Numbers:
		(Residential)	location of waste storage rooms and compactor unit	SPA008, SPA151
SW 4.1	Construction	Manage construction and demolition	Documentation in accordance with O.	Plan Numbers:
	Waste Management	waste in accordance with O. Reg. 103/94	Reg. 103/94	

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Checklist – Toronto Green Standard Version 4.0 2022 TGS Version 4.0 Checklist: Mid to High Rise Residential and all New Non-Residential Development

TGS Documentation includes the submission of the completed Tier 1 TGS Checklist and the Statistics Template updated with each planning submission. All sections must be completed for SPA. The TGS Statistics Template is provided on the Project Statistics Plan with each submission in

ection	Development Feature	Tier 1 Performance Measure (See full standards and specifications for details and definitions)	Documentation Required for Site Plan Approval (Sections marked with an asterisk are required for Rezoning or Subdivision applications)	Plans and Drawings
Q 1.1	Single- Occupant Vehicle Trips	Reduce single occupancy vehicles trips by 25%	☐ Transportation Impact Study (TIS) includes TDM analysis (if applicable)	Plan Numbers:
Q 1.2	Electric Vehicle	Parking spaces equipped with an	☑ TGS V4.0 Statistics Template	Plan Numbers:
	Infrastructure	ture Energized Outlet in accordance with Zoning Bylaw 569-2013 as amended	☑ Project parking statistics include number and location of EV spaces	SPA003, SPA101, SPA
			☑ Notations indicate location of EV spaces, performance level and EVEMS on Parking	
Q 2.1	Bicycle Parking			Plan Numbers:
	Rates	with Zoning Bylaw 569-2013	Project statistics include rates, number and type (long-term/short-term) of bicycle parking spaces	SPA003, SPA101, SPA
		Summary table includes number, type and % of net floor area occupied by bicycle parking for each parking floor or at-grade		
Q 2.2		Long-term bicycle parking, secure	✓ Notations on Parking Plans to indicate the	Plan Numbers:
	Bicycle Parking Location	controlled-access in accordance with Zoning Bylaw 569-2013:	number of long-term parking spaces in each secure bicycle parking area	SPA003, SPA101, SP

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Checklist – Toronto Green Standard Version 4.0 2022 TGS Version 4.0 Checklist: Mid to High Rise Residential and all New Non-Residential Development

Section	Development Feature	Tier 1 Performance Measure (See full standards and specifications for details and definitions)	Documentation Required for Site Plan Approval (Sections marked with an asterisk" are required for Rezoning or Subdivision applications)	Plans and Drawing
*EC 1.1	Tree Planting Areas and Soil	Total volume of soil for tree planting	☑ TGS V4.0 Statistics Template	Plan Numbers:
Volume Volume		☑ Soil Volume Template	Landscape Plan	
		Each tree planting area has access to 30m³ of soil	Notations indicate soil volume (depth and area.) species and quantity for each planting area	
			Soil Volume Plan	
*EC 1.2	Trees Along	Trees planted along street frontages with	☑ Notations indicate soil volume (soil depth)	Plan Numbers:
Street Frontages	access to 30 m ³ of soil/tree	and area) species and quantity for each planting area	Landscape Plan	
		☑ Planting details, Soil Volume Plan		
			☑ Public Utilities Plan	
EC 1.3	Parking Lots	1 shade tree planted parking lots area for every 5 parking spaces	□ Notations indicate soil volume (depth and area), species and quantity on the Planting Plan/Soil Volume Plan for parking areas	Plan Numbers:
EC 1.4	Watering Program	Four-year Watering program for private trees	Notations on the Planting Plan include watering program methods and watering schedule	Plan Numbers:
EC 2.1	Green & Cool Paving	Treat 75% of non-roof hardscape to reduce the urban heat island	☐ TGS V4.0 Statistics Template	Plan Numbers:
	, Gying	150055 HIS OBOTHIS HIS HIS HIS	☐ Materials list includes SRI of high albedo paving	
			Notations indicate location of treated hardscape and soft landscaping	

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Low Emissions Transportation

Statistics Template – Toronto Green Standard Version 4.0 Mid to High Rise Residential and

all New Non-Residential Development The Toronto Green Standard Version 4.0 Statistics Template is submitted with Site Plan Control Applications and stand-alone Zoning Bylaw Amendment applications. Complete the table and copy it directly onto the Site Plan submitted as part of the application.

For Zoning Bylaw Amendment applications: complete General Project Description and Section 1. For Site Plan Control applications: complete General Project Description, Section 1 and Section 2. For further information, please visit www.toronto.ca/greendevelopment

General Project Description		Proposed	
Total Gross Floor Area	35,525.0m2		
Breakdown of project components (m²):			
Residential	33,632.6m2		
Retail	1,892.4m2		
Commercial			
Industrial			
Institutional/Other			
Total number of residential units	471		

Section 1: For Stand Alone Zoning Bylaw Amendment Applications and Site Plan Control Applications

Number of Parking Spaces	7	242	100%
Number of EV Parking Spaces (Residential)	239	239	100%
Number of EV Parking Spaces (non-residential)	3	3	100%
Cycling Infrastructure	Required	Proposed	Proposed %
Number of long-term bicycle parking spaces (all-uses)	424	424	100%
Number of long-term bicycle parking located on:			
a) first storey of building		26	
b) second storey of building			
c) first level below-ground		120	
d) second level below-ground		286	
e) other levels below-ground			



Required Proposed Proposed %

Checklist – Toronto Green Standard Version 4.0 2022 TGS Version 4.0 Checklist: Mid to High Rise Residential and all New Non-Residential Development

Section	Development Feature	Tier 1 Performance Measure (See full standards and specifications for details and definitions)	Documentation Required for Site Plan Approval (Sections marked with an asterisk* are required for Rezoning or Subdivision applications)	Plans and Drawings
*AQ 2.3	Short-term Bicycle Parking Location	Short-term bicycle parking, highly visible and publicly accessible location in accordance with Zoning Bylaw 569-2013	Notations on Parking Plans or Site Plan indicate location and the number of short- term spaces in each bicycle parking area	Plan Numbers: SPA003, SPA151
AQ 2,4	Electric Bike Infrastructure	15% of parking spaces equipped with Energized Outlet (120 V)	Notations on Parking Plan includes location and performance level on parking plans	Plan Numbers: SPA003, SPA101, SPA102
'AQ 2.5	Shower & Change Facilities	Shower and change facilities in accordance with Zoning Bylaw 569-2013	☐ Notations indicate location and number of shower and change facilities	Plan Numbers:
AQ 2.6	Publically Accessible Bike Parking	At least 10 additional publicly accessible, short-term bicycle parking spaces, at-grade on the site or within the public boulevard	✓ Notations on Plans include location and number of spaces	Plan Numbers: SPA003, SPA151
AQ 3.1	Connectivity	Pedestrian walkways	✓ Notations on Site Plan, Landscape Plans and Details	Plan Numbers: SPA151
AQ 3.2	Sidewalk Space	Minimum 2.1 meter pedestrian clearway	☑ Notations on Plans and Details	Plan Numbers: SPA151

Landscape includes 50% native plants TGS V4.0 Statistics Template

☐ Green Roof required under the Green ☐ Green Roof Statistics Template on roof plan.

Space with one or a combination - Notations include SRI of cool roof on roof

Green & Cool At least one or a combination of the TGS V4.0 Statistics Template

Ravine & Natural Natural Heritage System and the Ravine TGS V4.0 Statistics Template

and native flowering species

following:

Roof By-Law or.

Green Roof ☐ Solar PV ☐ Cool Roof Ravine & Natural Stewardship Plan implemented for

Feature Protected Area planted with 100%

Green Roof Bylaw does not apply.

provide 100% of Available Roof

Native and

Page 3 of 9

Plan Numbers:

Plan Numbers:

Plan Numbers:

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Checklist – Toronto Green Standard Version 4.0 2022 TGS Version 4.0 Checklist: Mid to High Rise Residential and all New Non-Residential Development

Checklist – Toronto Green Standard Version 4.0 2022 TGS Version 4.0 Checklist: Mid to High Rise Residential and all New Non-Residential Development

Covered outdoor waiting areas

Greenhouse Gas Demonstrate an annual Greenhouse Emissions Limits Gas Intensity (GHGI) that meets the Workbook prior to NOAC

Building Energy Design the building to achieve the TEUI __ Energy (Modelling) Report and Energy

and TEDI targets by building type OR Workbook prior to NOAC

Tier 1: Buildings Energy, Emissions and Resilience

TGS performance limits

25% improvement above OBC, SB-10,

Section	Development Feature	Tier 1 Performance Measure (See full standards and specifications for details and definitions)	Documentalion Required for Site Plan Approval (Sections marked with an asterisk* are required for Rezoning or Subdivision applications)	Plans and Drawings
EC 5.1	Bird-Friendly Glazing	85% of all exterior glazing within the first 16m treated including fly-through and High Hazard Areas, to reduce bird collisions	☐ TGS V4.0 Statistics Template ☐ Bird Friendly Statistics Template ☐ Notations on Elevation Plans include treatment area, and material legend showing type, density and colour of visual markers, and High Hazard Areas	Plan Numbers:
EC 5.2	Rooftop Vegetation	Glazing 4 m above rooftop vegetation is treated to reduce bird collisions	☐ Notations include required treated area, type of treatment, surface, density and colour of visual markers	Plan Numbers:
EC 5.3	Grate Porosity	Maximum porosity of ventilation grates is 20mm X 20mm or 10mm x50mm	Notations indicate location and porosity of ground level grates	Plan Numbers:
EC 5.4	Exterior Lighting	Dark Sky compliant fixtures	☐ Notations indicate Dark Sky compliant fixtures ☐ Lighting Plan	Plan Numbers:

Section	Development Feature	Tier 1 Performance Measure (See full standards and specifications for details and definitions)	Documentation Required for Site Plan Approval (Sections marked with an asterisk are required for Rezoning or Subdivision applications)	Plans and Drawings
*SW 1.1	Waste Collection	Waste sorting system for garbage, recycling and organics	☑ TGS V4.0 Statistics Template	Plan Numbers:
		recycling and organics	☑ Notations on Floor Plans indicate type and location of waste sorting system	SPA008, SPA151
*SW 1.2	Waste Storage	Waste Storage Waste storage rooms	▶ Notations on Floor Plans or Parking Plans	Plan Numbers:
	Space		indicate area and location of waste starage rooms	SPA008, SPA151

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Cycling Infrastructure

Feature setbacks

Protected Area: native plants

Protected Area:

Statistics Template – Toronto Green Standard Version 4.0 Mid to High Rise Residential and all New Non-Residential Development

Required Proposed Proposed %

Plant list includes common name, scientific

☐ Notations include green roof locations

plan and location of solar panels

☐ Stewardship Plan (if applicable)

identified on elevations and roof plans

☐ Notations indicate Stewardship Plan area

☐ Plant list identifies native or non-native

species and plants from regionally appropriate seed source

name, size, quantity, stock type, native or non-native and flowering species ☐ Notations indicate potable or non-potable irrigation system on Landscape Plan

95	95	100%
Required	Proposed	Proposed %
	95 Required	

Section 2: For Site Plan Control Applications

Soil Volume provided within the public boulevard (m³)

Cycling Infrastructure	Required	Proposed	Proposed %
Number of short-term bicycle parking spaces (all uses) at-grade or on first level below grade	95	95	100%
Number of publicly accessible bicycle parking spaces			
Number of energized outlets for electric bicycles			

Tree Canopy	Required	Proposed	Proposed %
Total site area (m²)			
Total Soil Volume (40% of the site area \div 66 m 2 x 30 m 3)			
Total number of trees planted			
Number of surface parking spaces (if applicable)			
Number of shade trees located in surface parking area			
Landscaping & Biodiversity	Required	Proposed	Proposed %

Landscaping & Biodiversity	Required	Proposed	Proposed %
Total non-roof hardscape area (m²)			
Total non-roof hardscape area treated for Urban Heat Island (minimum residential 75% or non-residential 50%) (m²)			
Area of non-roof hardscape treated with: (indicate m²)			
a) high-albedo surface material			
b) open-grid pavement			
c) shade from tree canopy			

Statistics Template – Toronto Green Standard Version 4.0 Mid to High Rise Residential and all New Non-Residential Development

Checklist – Toronto Green Standard Version 4.0 2022

all New Non-Residential Development

Plan Numbers:

Plan Numbers:

Plan Numbers:

Plan Numbers:

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SPA151

TGS Version 4.0 Checklist: Mid to High Rise Residential and

✓ Notations on Plans and Details

☐ Notations on Plans and Details

☐ Lighting Plan

Landscaping & Biodiversity	Required	Proposed	Proposed %
d) shade from high-albedo structures			
e) shade from energy generation structures			
Percentage of Lot Area as Soft Landscaping (non-residential only)			
Total number of plants			
Total number of native plants and % of total plants			
Available Roof Space (m²)			
Available Roof Space provided as Green Roof (m²)			
Available Roof Space provided as Cool Roof (m²)			
Available Roof Space provided as Solar Panels (m²)			

Bird Collision Deterrence	Required	Proposed	Proposed %
Total area of glazing of all elevations within 16m above grade			
Total area of treated glazing (minimum 85% of total area of glazing within 16m above grade) (m²)	85%		100%
Percentage of glazing within 16m above grade treated with:			
a) Visual markers			
b) non-reflective glass			
c) Building integrated structures			

5 2024-10-02 WITHOUT PREJUDICE SET #2 2 2023-11-08 REZONING RESUBMISSION # DATE DESCRIPTION

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Toronto, ON, M3B 2T8

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Hillsdale Ave E + Yonge St + Manor Rd E

TGS CHECKLIST

Toronto, Ontario


PROJECT NO. 20.222P01 PROJECT DATE 2023-03-10 DRAWN BY

SPA006

Page 2 of 3

Page 3 of 3

Author CHECKED BY Checker

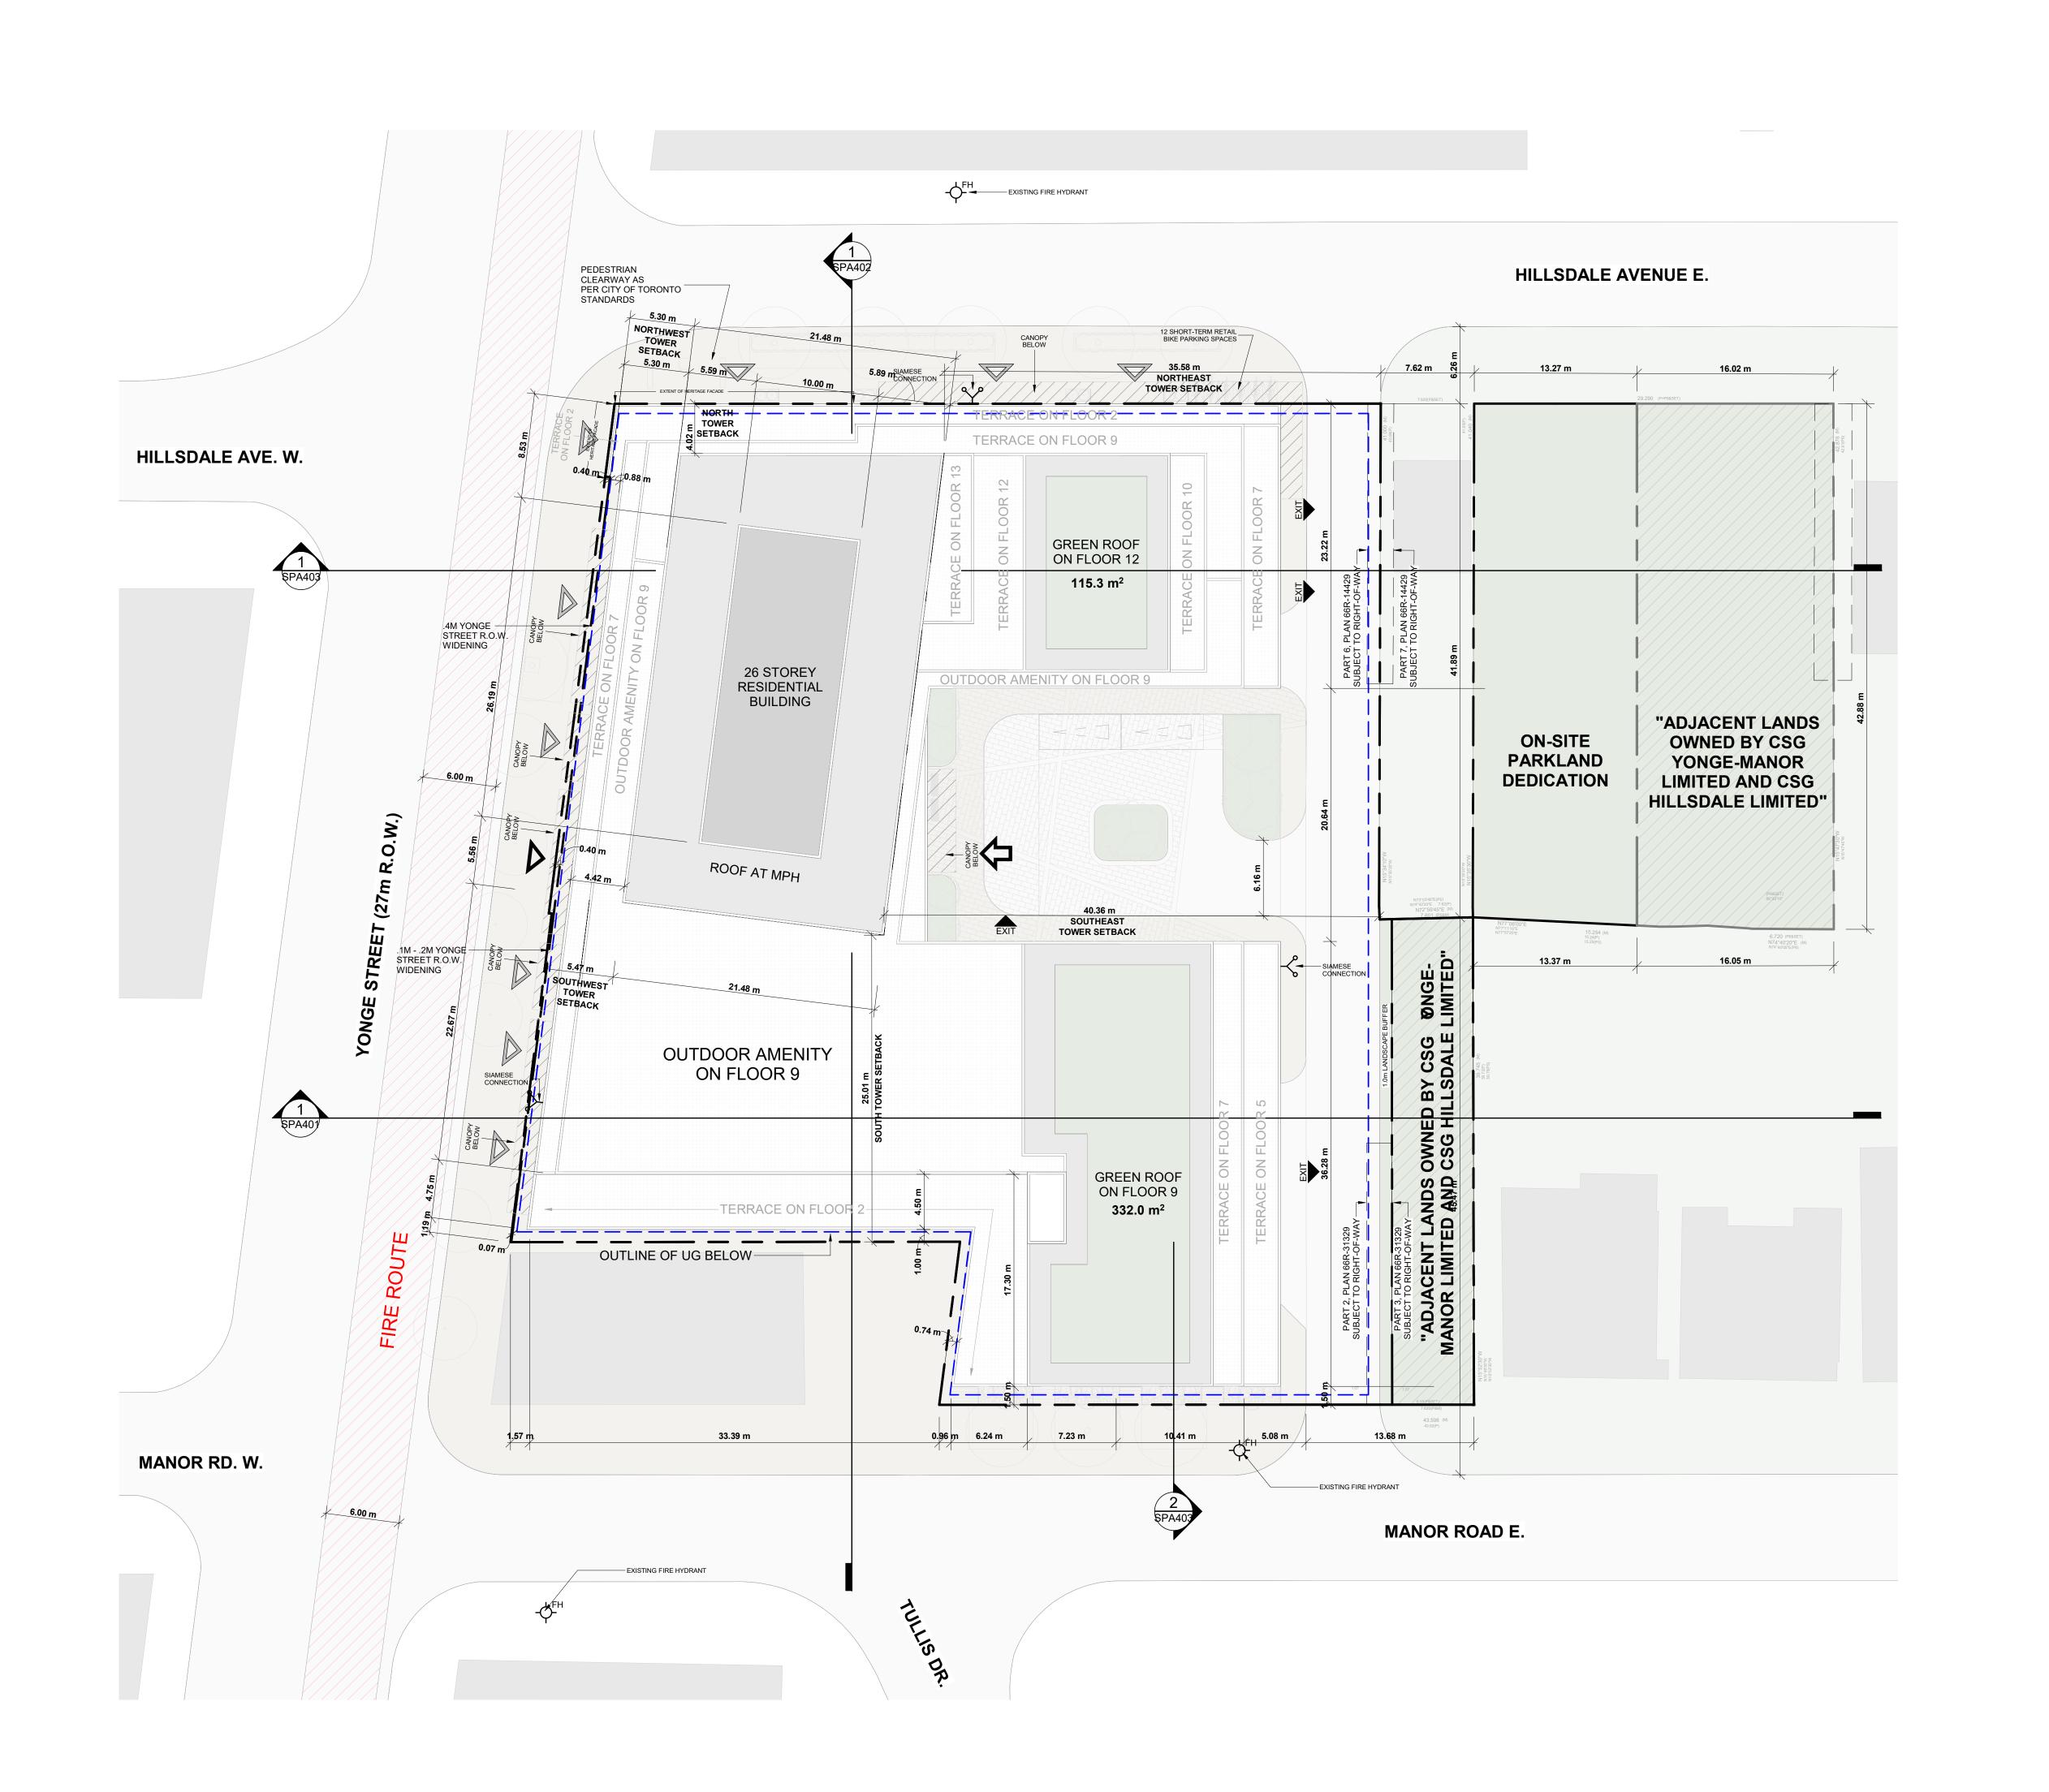

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LEGEND

RESIDENTIAL ENTRANCE

RESIDENTIAL ENTRANCE SECONDARY

RETAIL ENTRANCE

EXIT EXIT

- FIRE HYDRANT

→ SIAMESE CONNECTION

CONVEX MIRROR TRANSFORMER WITH CLEARANCES

A FIRE ROUTE SIGN

000.00 SPOT ELEVATION

GAS/HYDRO METER


Hillsdale Ave E + Yonge St + Manor Rd E


Toronto, Ontario

SITE PLAN / ROOF PLAN

PROJECT NO. 20.222P01 PROJECT DATE 2023-03-10 DRAWN BY NMU CHECKED BY RMM

SPA008 REV.

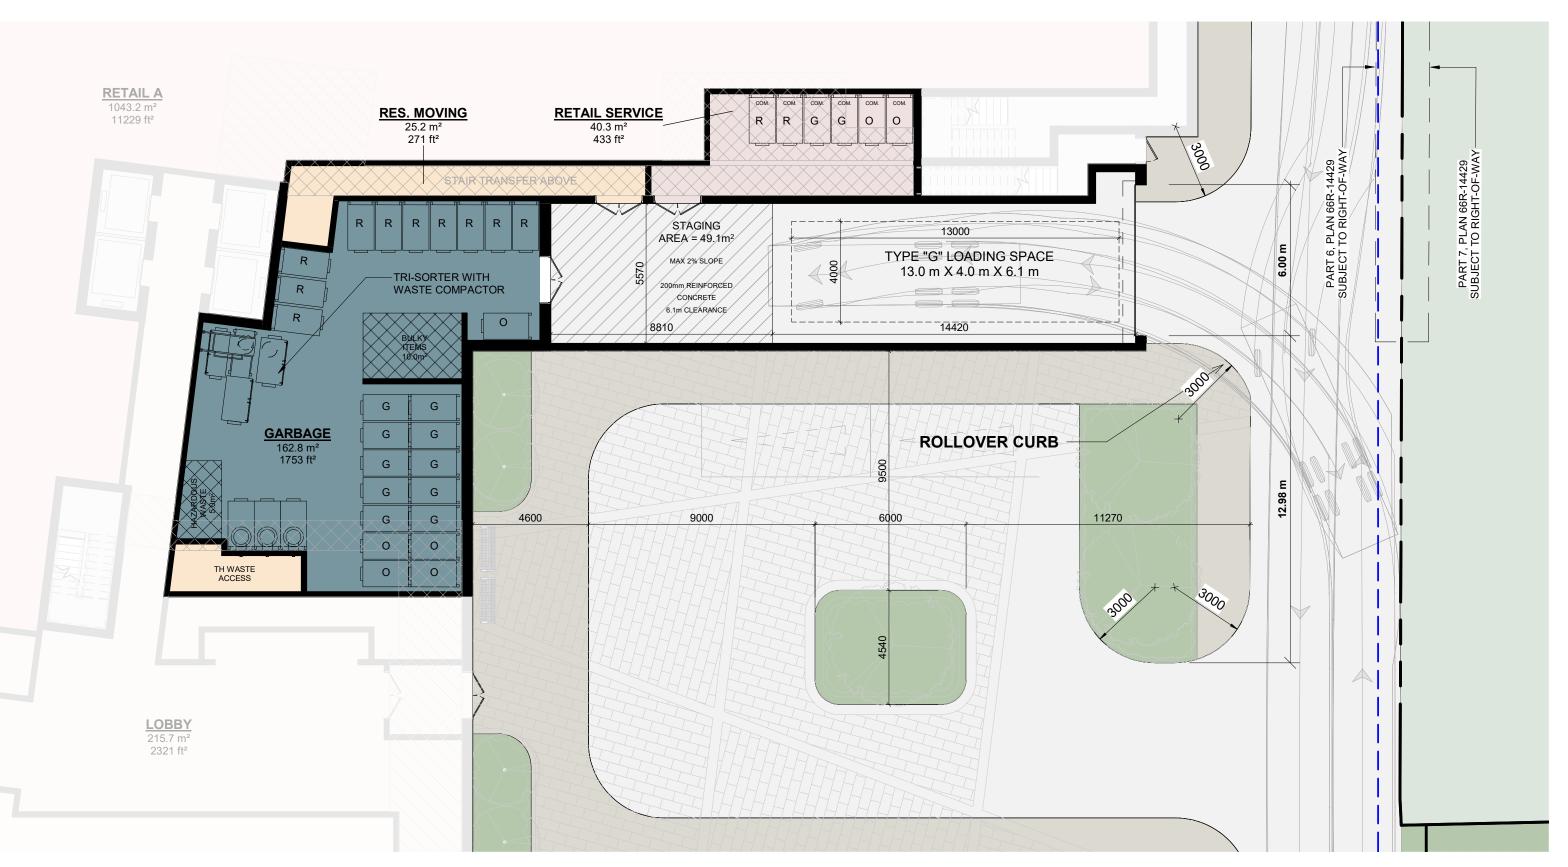

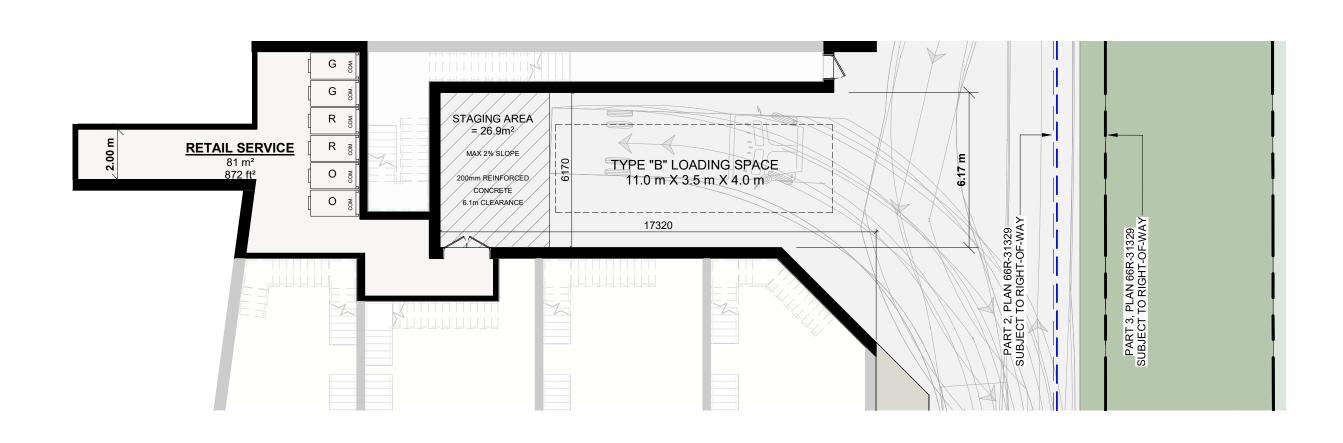


TYPE G LOADING SPACE AND GARBAGE ROOM

TYPE B LOADING SPACE AND RETAIL SERVICE ROOM

RESIDENTIAL SILID WASTE MANAGEMENT STES

1. ALL ACCESS DRIVEWAYS TO BE USED BY THE COLLECTION VEHICLE WILL BE LEVEL (+/-8%), AT LEAST 4.5 METERS WIDE THROUGHOUT THE SITE AND 6 METERS WIDE AT ENTRANCES AND EXITS, AND WILL HAVE A MINIMUM OVERHEAD TRAVELING CLEARANCE OF 4.4 METERS INCLUDING WHEN TRAVELING THROUGH OVERHEAD DOORS.

- 2. TYPE G LOADING SPACE WILL BE AT LEAST 4 METRES WIDE, 13 METRES LONG, WITH AN UNOBSTRUCTED VERTICAL CLEARANCE OF 6.1 METRES, IS LEVEL(+/ -2 %), AND IS CONSTRUCTED OF AT LEAST 200MM OF REINFORCED CONCRETE.
- 3. A TRAINED ON SITE STAFF MEMBER WILL BE AVAILABLE TO MANEUVER BINS FOR THE COLLECTION DRIVER AND ALSO ACT AS A FLAG MAN WHEN THE TRUCK IS REVERSING. IN THE EVENT THAT THE ON SITE STAFF IS UNAVAILABLE AT THE TIME THE CITY COLLECTION VEHICLES ARRIVE AT THE SITE, THE COLLECTION VEHICLE WILL LEAVE THE SITE AND NOT RETURN UNTIL THE NEXT SCHEDULED COLLECTION DAY.
- 4. SHARING OF TYPE G LOADING SPACE RESIDENTIAL USE OF LOADING SPACE FOR PURPOSES OF MOVING WILL BE SCHEDULED ACCORDING TO GARBAGE PICK UP TIMES. SHOULD THE TYPE G SPACE BE NEEDED FOR USE BY COMMERCIAL SECTORS, THE COMMERCIAL COMPONENT MUST ARRANGE THIS USE SUCH THAT IT DOES NOT CONFLICT WITH ANY RESIDENTIAL USES.
- 5. IF THE LOADING AREA / EGRESS ROUTES ARE OVER SUPPORTED STRUCTURES, IE.OVER AN UNDERGROUND GARAGE OR A MECHANICAL SHAFT, THE FACILITY MUST CONFORM TO THE FOLLOWING:
- i. DESIGN CODE ONTARIO BUILDING CODE.
- ii. DESIGN LOAD CITY BULK LIFT VEHICLE IN ADDITION BUILDING CODE REQUIREMENTS.
- iii. IMPACT FACTOR 5 % FOR MAXIMUM VEHICULAR SPEEDS TO 15 KM / H AND 30 % FOR HIGHER SPEEDS.
- iv. CITY COLLECTION VEHICLE IS REQUIRED TO DRIVE ONTO OR OVER A SUPPORTED STRUCTURE(SUCH AS AN UNDERGROUND PARKING GARAGE). THE UNDERGROUND PARKING GARAGE ROOF SLAB IS TO BE DESIGNED TAKING INTO ACCOUNT THE COLLECTION VEHICLE WEIGHT. THE CITY MUST PROVIDE, PRIOR TO COMMENCEMENT OF CITY SOLID WASTE PICK UP, A LETTER CERTIFIED BY A QUALIFIED ENGINEER THAT THE STRUCTURE CAN SAFELY SUPPORT A FULLY LOADED COLLECTION VEHICLE WEIGHING 35,000 KILOGRAMS.
- 6. PRIVATE CONTRACTOR MUST COLLECT ALL SOLID WASTE FROM THE RETAIL COMPONENT.
- 7. WASTE BINS TO BE JOCKEYED ON COLLECTION DAY, IF REQUIRED. STAFF JOCKEYING THE BINS DURING SOLID WASTE PICK UP AND THE REQUIRED STAGING AREA IS TO BE LOCATED IN CLOSE PROXIMITY TO THE LOADING AREA TO AVOID ANY DELAYS DURING PICK UP.
- 8. NON RESIDENTIAL COMPONENT WILL ONLY SCHEDULE USE OF THE TYPE G LOADING SPACE ON OPPOSITE DAYS FROM THE COLLECTION DAYS OF THE RESIDENTIAL COMPONENT TO ENSURE THAT THE TYPE G LOADING SPACE WILL BE VACANT FOR CITY WASTE COLLECTION. IF LOADING SPACE IS TO BE SHARED, THE COMMERCIAL BINS MUST BE LABELLED "RETAIL WASTE ONLY"

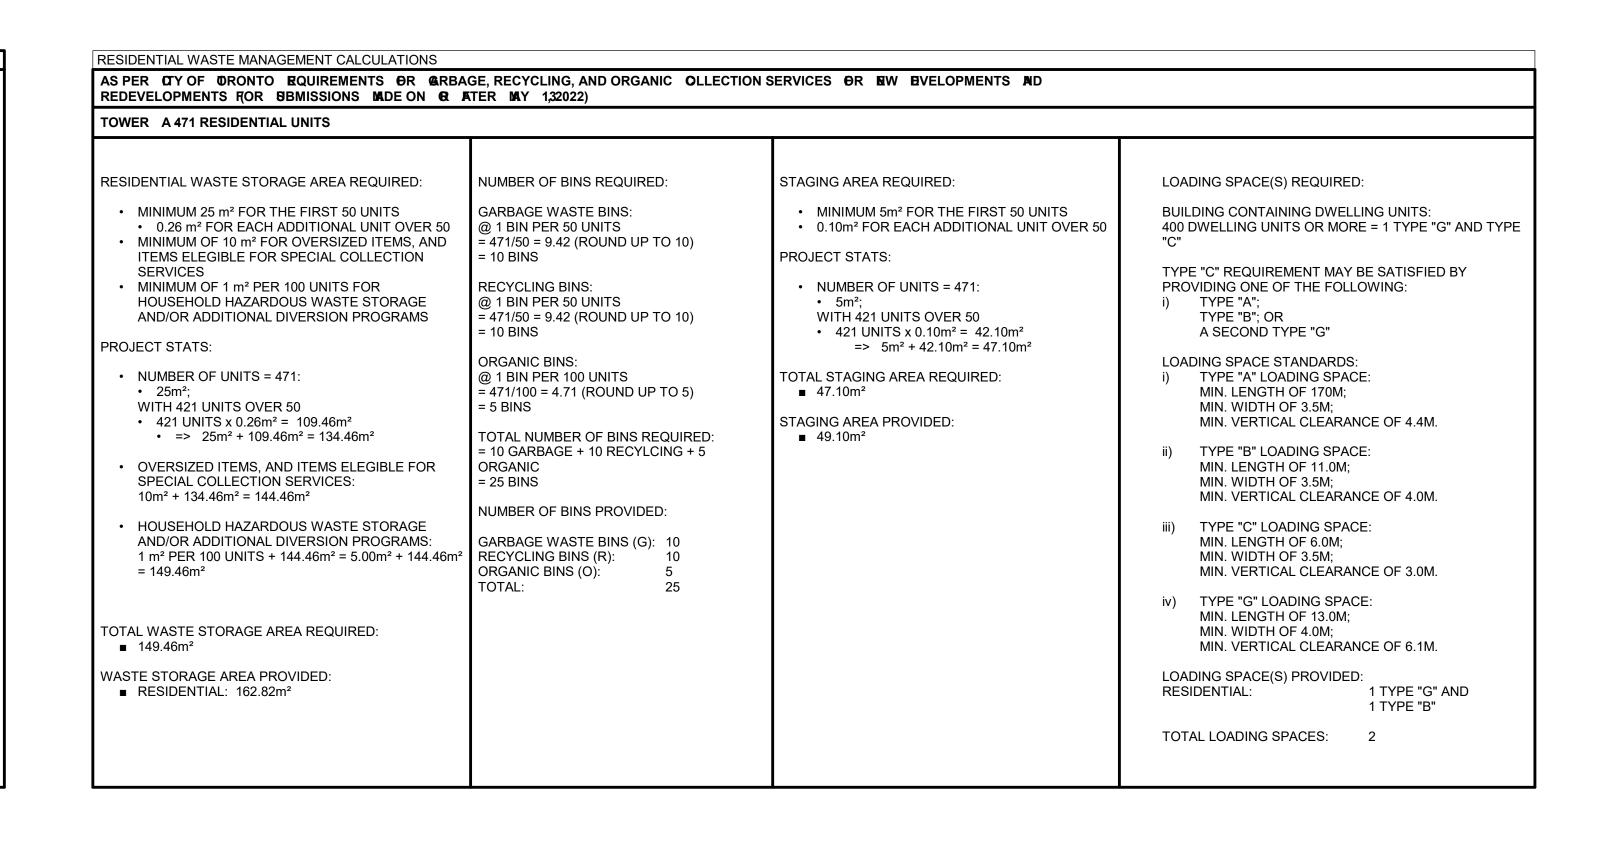

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PROJECT

Hillsdale Ave E + Yonge St +

Manor Rd E

Toronto, Ontario

RESIDENTIAL SOLID WASTE

MANAGEMENT

SPA009

PROJECT NO.

20.222P01


PROJECT DATE

2023-03-10

As indicated

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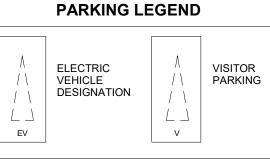
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ELECTRIC VEHICLE INFRASTRCTURE


Residential and Non-residential Uses:
Parking spaces must be equipped with an energized outlet, which is clearly marked and identified for electric vehicle charging, in accordance with Zoning By-law 569-2013, as amended:

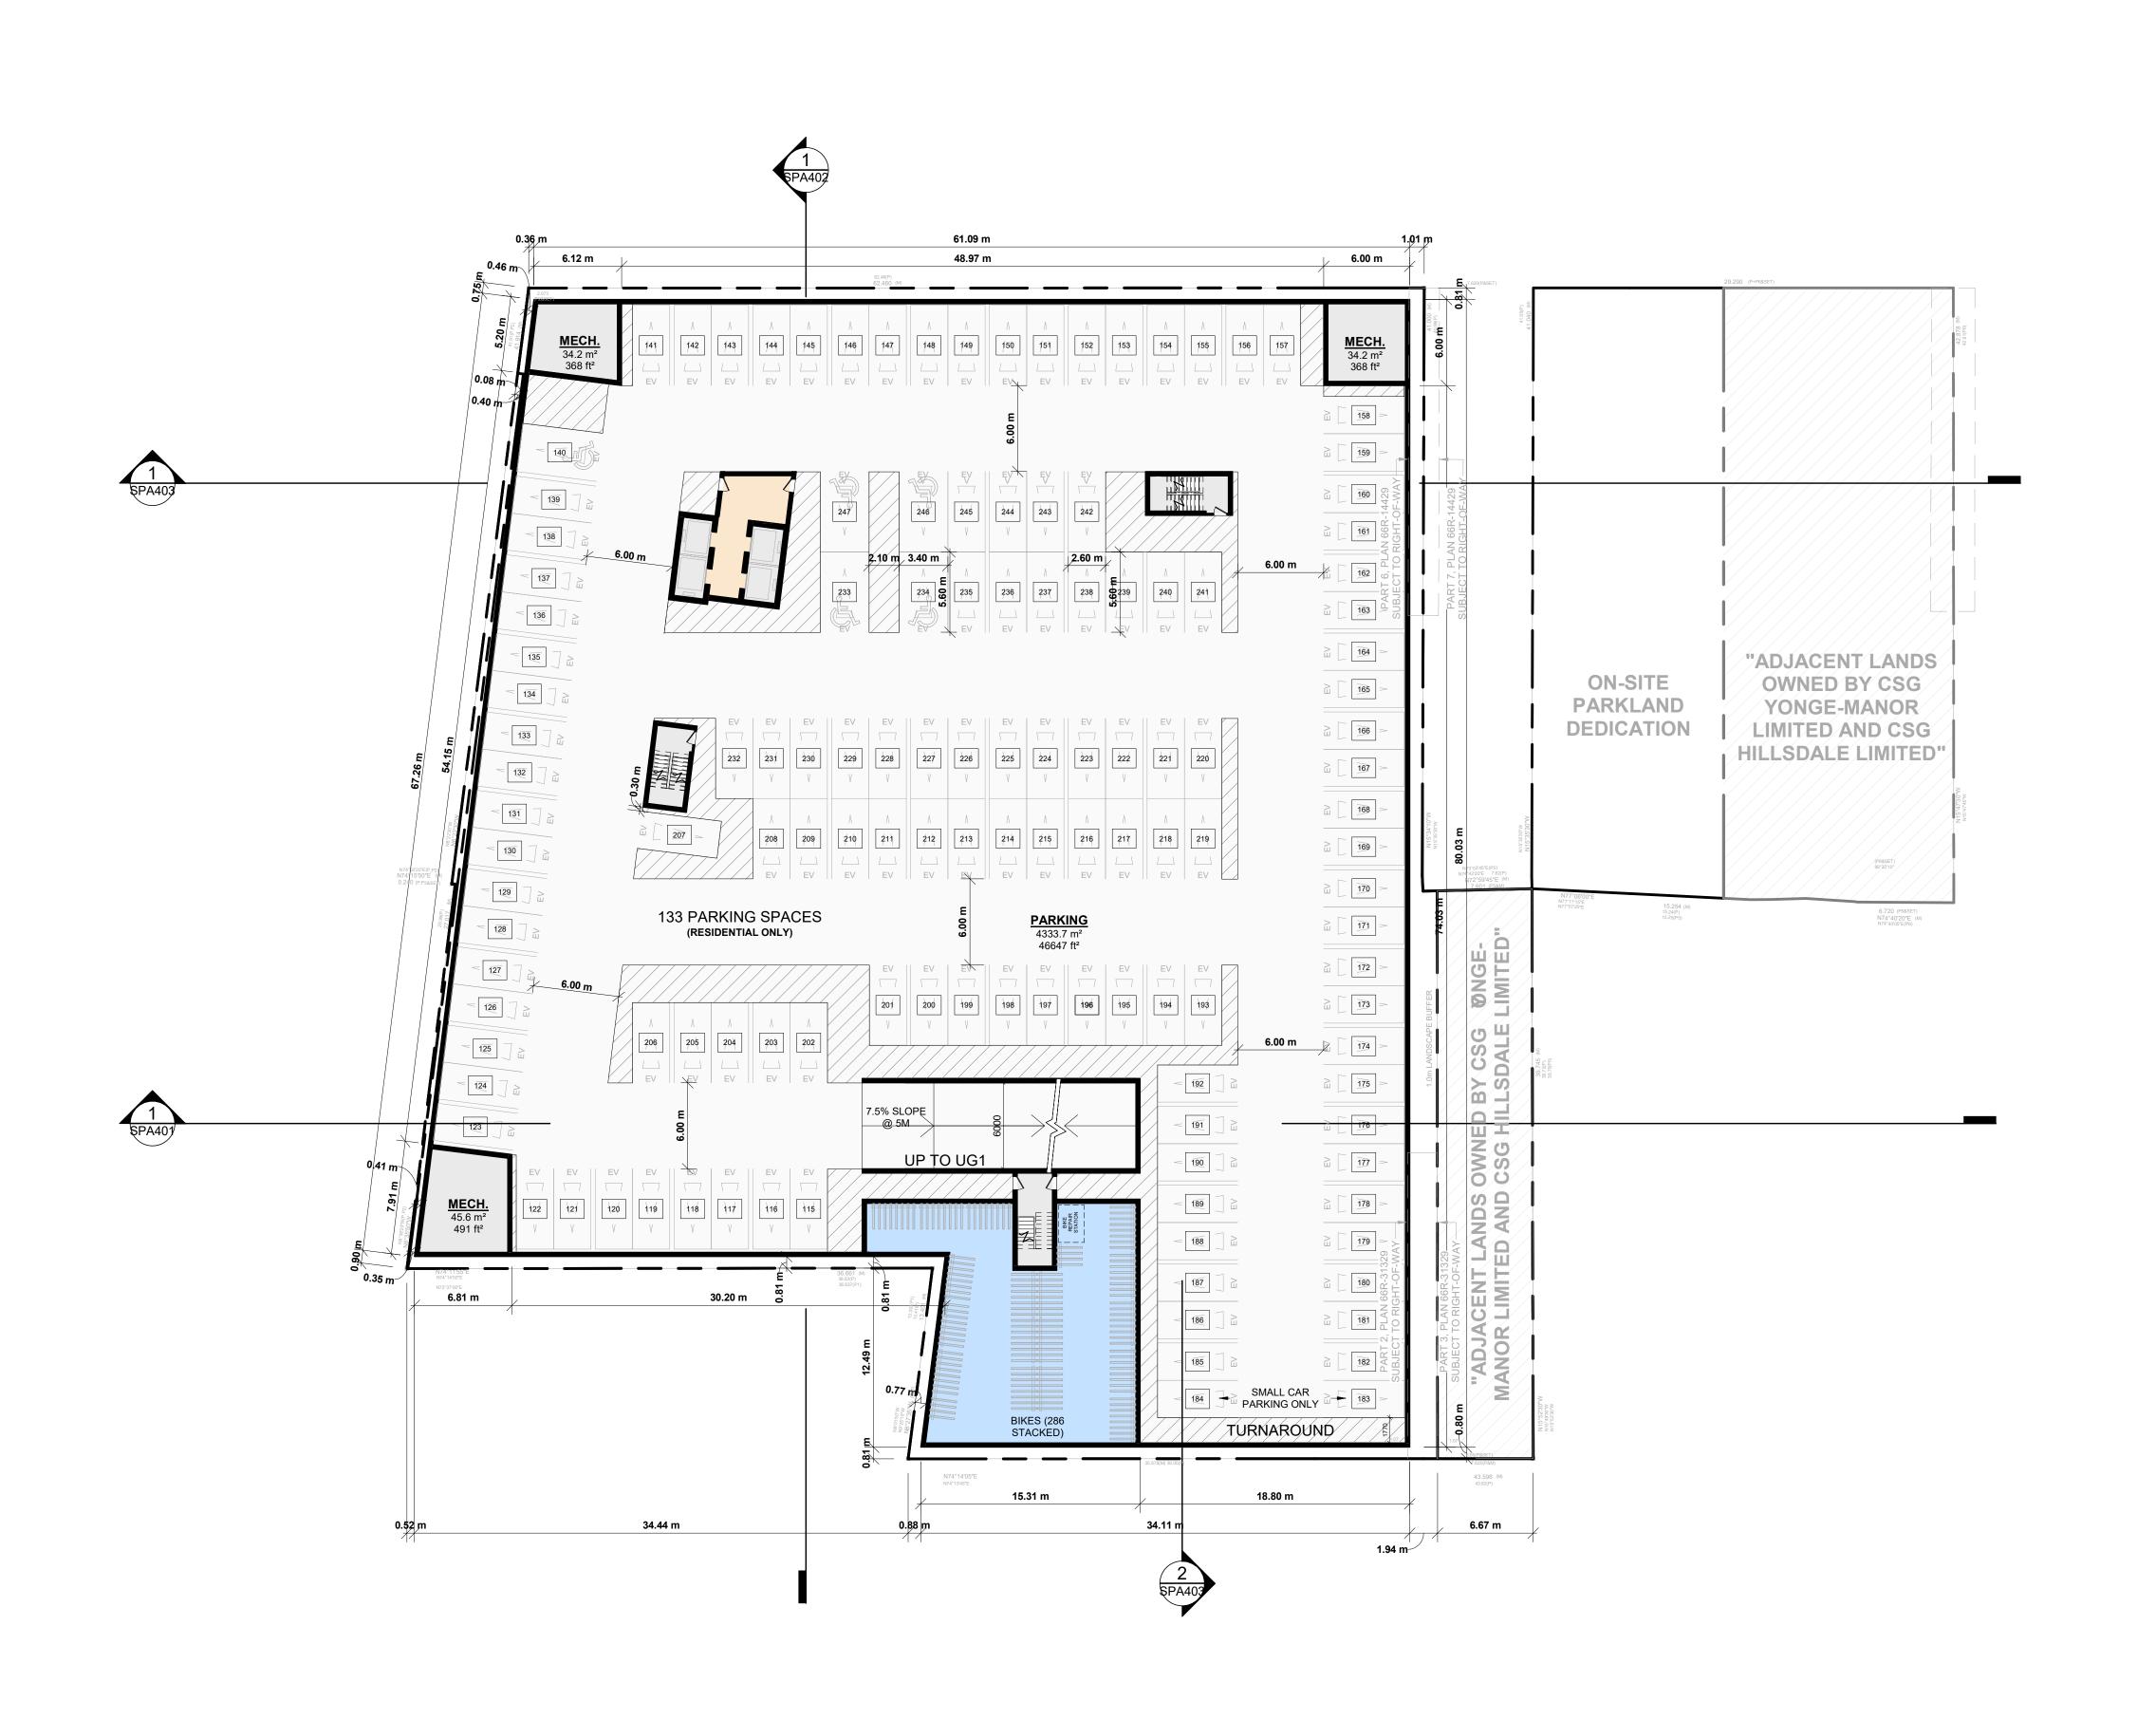A) all residential parking spaces provided for dwelling units located in an apartment building, mixed use building, multiple dwelling unit building, excluding visitor parking spaces, must include an energized outlet capable of providing Level 2 charging or higher to the parking space; and,


B) in cases other than those set out in (A) above, 25 percent of the residential and non-residential parking spaces in a building must include an energized outlet capable of providing Level 2 charging or higher.



TYPICAL PARKING DIMENSIONS

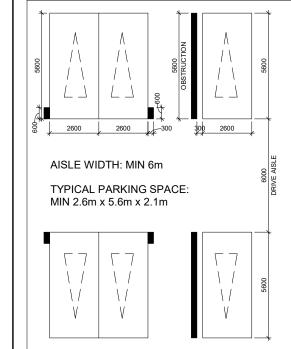

TYPICAL BARRIER FREE SPACE

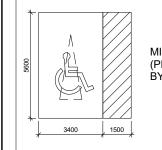

MIN 2.6m x 5.6m x 2.1m (PER TORONTO ZONING BY-LAW 579-2017)

5 2024-10-02 WITHOUT PREJUDICE SET #2
4 2024-03-18 WITHOUT PREJUDICE SET
2 2023-11-08 REZONING RESUBMISSION
1 2023-08-15 ISSUED FOR REZONING
DATE DESCRIPTION

Hillsdale Ave E + Yonge St +
Manor Rd E

Toronto, Ontario


DRAWING

UNDERGROUND LEVEL 02

PROJECT NO.
20.222P01
PROJECT DATE
2023-03-10
DRAWN BY
NMU
CHECKED BY
RMM
SCALE
1:250

DRAWING NO.

SPA101 REV.

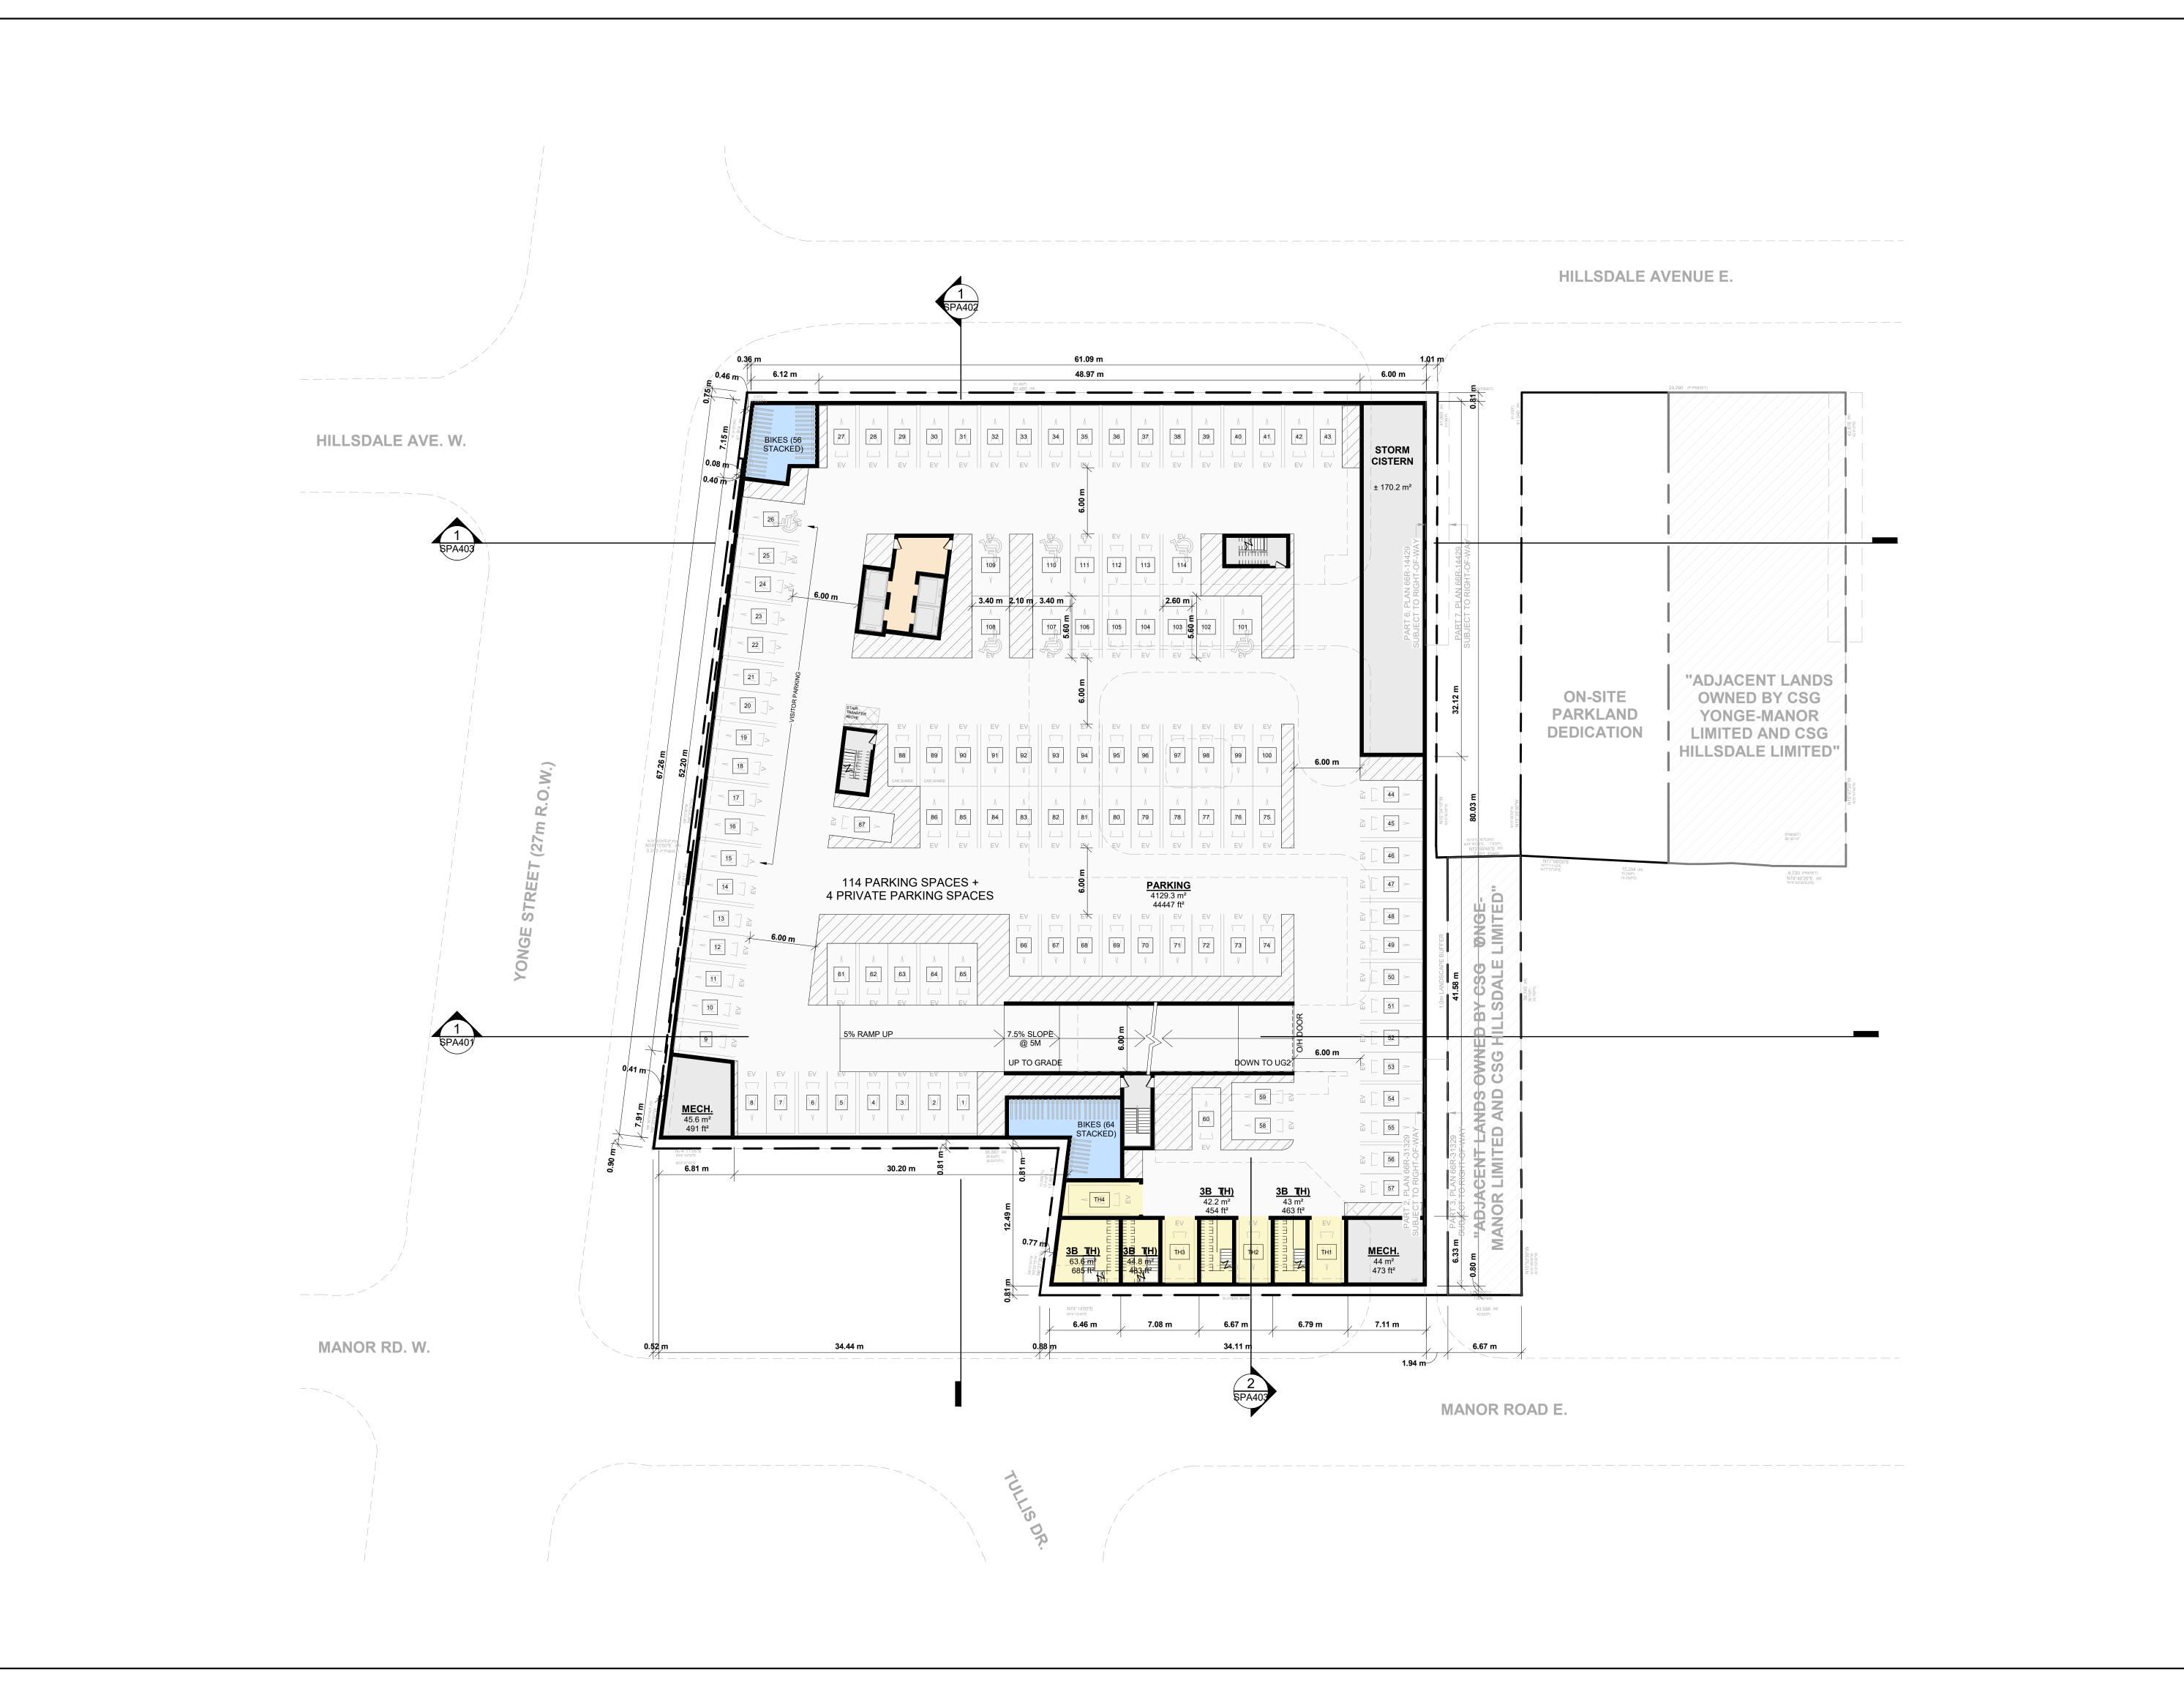

67 Lesmill Road Toronto, ON, M3B 2T8 T 416 425 2222 turnerfleischer.com


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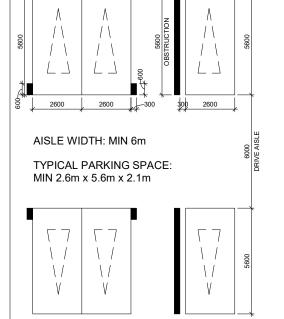
Residential and Non-residential Uses: Parking spaces must be equipped with an energized outlet, which is clearly marked and identified for electric vehicle

charging, in accordance with Zoning By-law 569-2013, as


A) all residential parking spaces provided for dwelling units located in an apartment building, mixed use building, multiple dwelling unit building, excluding visitor parking spaces, must include an energized outlet capable of providing Level 2 charging or higher to the parking space; and,

B) in cases other than those set out in (A) above, 25 percent of the residential and non-residential parking spaces in a building must include an energized outlet capable of providing Level 2 charging or higher.



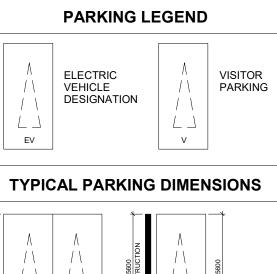

TYPICAL BARRIER FREE SPACE

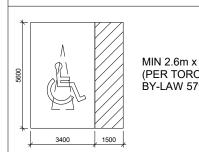

MIN 2.6m x 5.6m x 2.1m (PER TORONTO ZONING BY-LAW 579-2017)

5 2024-10-02 WITHOUT PREJUDICE SET #2
4 2024-03-18 WITHOUT PREJUDICE SET
2 2023-11-08 REZONING RESUBMISSION
1 2023-08-15 ISSUED FOR REZONING
DATE DESCRIPTION


Hillsdale Ave E + Yonge St + Manor Rd E

Toronto, Ontario

UNDERGROUND LEVEL 01

PROJECT NO. 20.222P01 PROJECT DATE 2023-03-10 DRAWN BY NMU CHECKED BY RMM

SPA102 FEV.

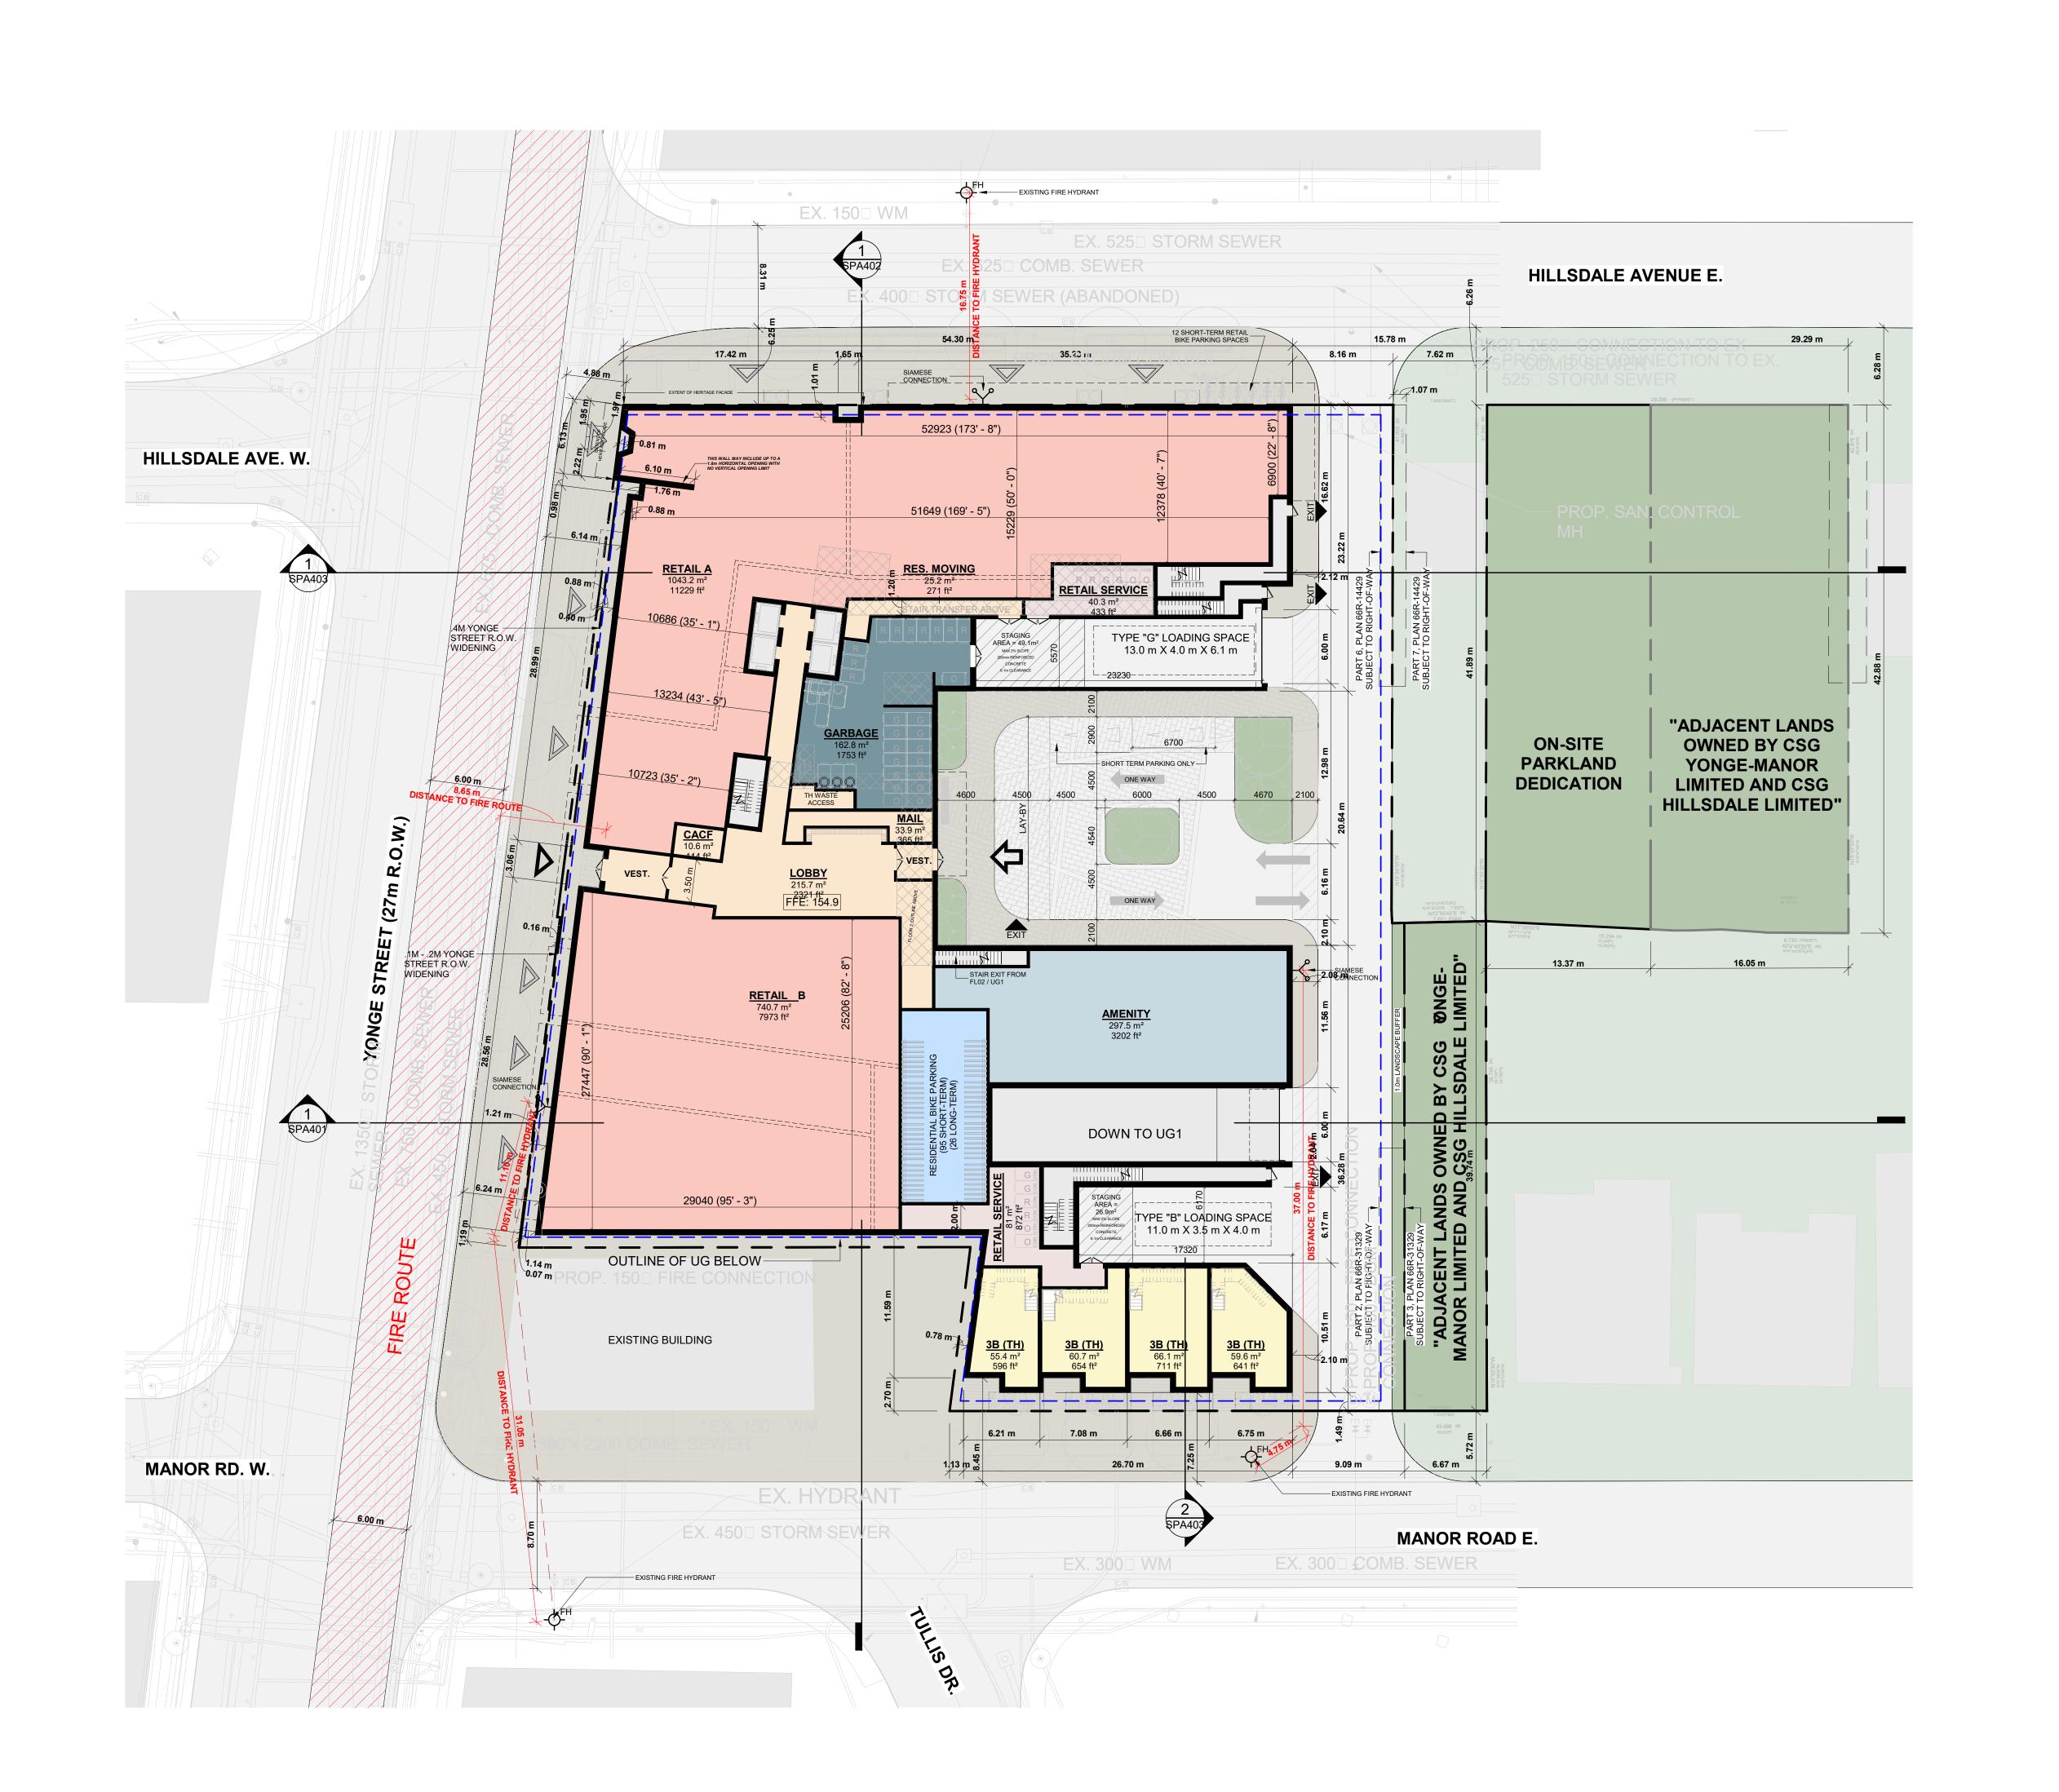

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LEGEND

PRIMARY RESIDENTIAL ENTRANCE

SECONDARY
RESIDENTIAL ENTRANCE

RETAIL ENTRANCE

EXIT EXIT

FIRE HYDRANT

SIAMESE CONNECTION

CONVEX MIRROR

TRANSFORMER WITH

CLEARANCES

A FIRE ROUTE SIGN

⊕000.00 SPOT ELEVATION

(G) GAS/HYDRO METER

5 2024-10-02 WITHOUT PREJUDICE SET #2
4 2024-03-18 WITHOUT PREJUDICE SET
3 2023-12-07 REZONING RESUBMISSION
2 2023-11-08 REZONING RESUBMISSION
1 2023-08-15 ISSUED FOR REZONING
DATE DESCRIPTION

Hillsdale Ave E + Yonge St + Manor Rd E


Toronto, Ontario

FLOOR 01

PROJECT NO.
20.222P01
PROJECT DATE
2023-03-10
DRAWN BY
NMU
CHECKED BY
RMM
SCALE

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SPA151 REV. 5

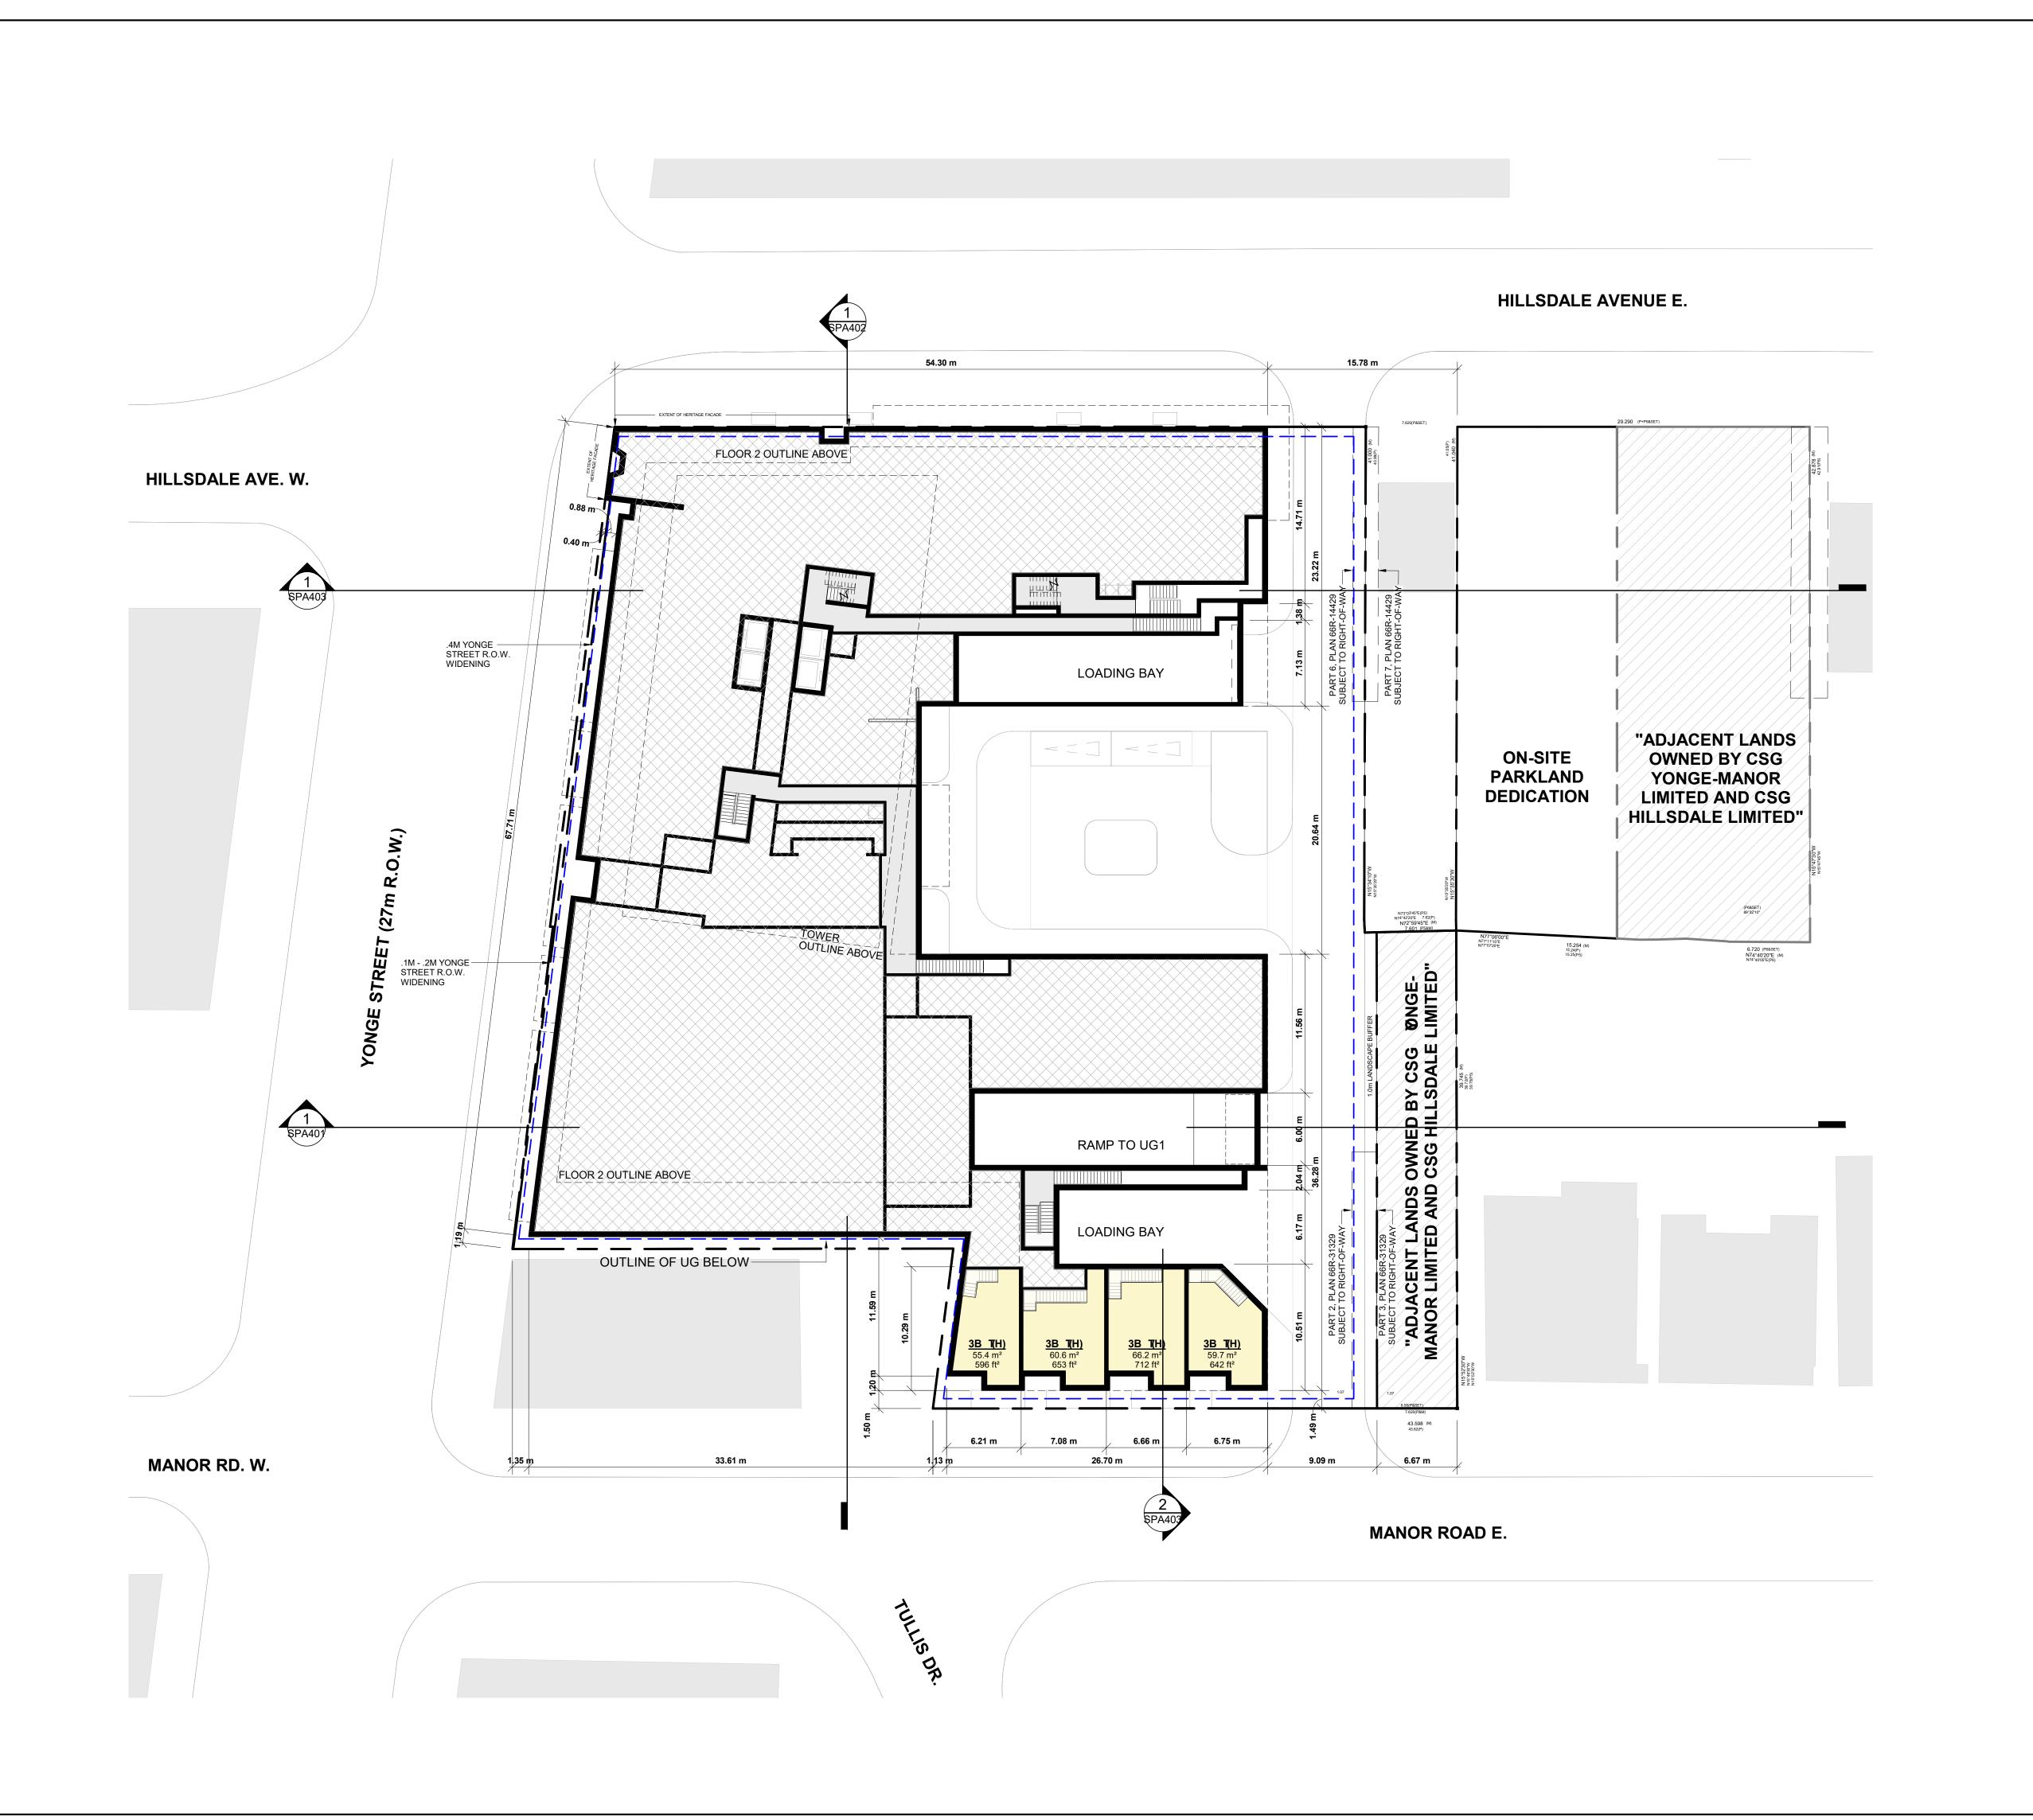

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 2024-10-02
 WITHOUT PREJUDICE SET #2
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 4
 2024-03-18
 WITHOUT PREJUDICE SET
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 2
 2023-11-08
 REZONING RESUBMISSION
 NMI

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 2023-08-15
 ISSUED FOR REZONING
 NMI

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 DATE
 DESCRIPTION
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Hillsdale Ave E + Yonge St +
Manor Rd E

Toronto, Ontario

DRAWING

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PROJECT NO.
20.222P01
PROJECT DATE
2023-03-10
DRAWN BY
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DRAWING NO.
SPA1

SPA152 REV. 5

324-10-11 4:44:



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PROPOSED RENTAL REPLACEMENT AREA

DETAILS TO BE REVIEWED AND CONFIRMED WITH CITY STAFF THROUGH DETAILED DESIGN.

Hillsdale Ave E + Yonge St + Manor Rd E

Toronto, Ontario

FLOOR 02

20.222P01 PROJECT DATE 2023-03-10 DRAWN BY NMU CHECKED BY RMM

PROJECT NO.

SPA153

T REV.



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5 2024-10-02 WITHOUT PREJUDICE SET #2 NMU
4 2024-03-18 WITHOUT PREJUDICE SET NMU
2 2023-11-08 REZONING RESUBMISSION NMU
1 2023-08-15 ISSUED FOR REZONING NMU
DATE DESCRIPTION BY

Hillsdale Ave E + Yonge St +
Manor Rd E

DRAWING

FLOOR 03

Toronto, Ontario

PROJECT NO.
20.222P01
PROJECT DATE
2023-03-10
DRAWN BY
NMU
CHECKED BY
RMM

DRAWING NO.

SPA154 SPA154



67 Les

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 5
 2024-10-02
 WITHOUT PREJUDICE SET #2
 NMU

 4
 2024-03-18
 WITHOUT PREJUDICE SET
 NMU

 2
 2023-11-08
 REZONING RESUBMISSION
 NMU

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 2023-08-15
 ISSUED FOR REZONING
 NMU

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 DATE
 DESCRIPTION
 BY

Hillsdale Ave E + Yonge St +
Manor Rd E

Toronto, Ontario

DRAWING

FLOOR 04

PROJECT NO.
20.222P01
PROJECT DATE
2023-03-10
DRAWN BY
NMU
CHECKED BY
RMM
SCALE
1: 250

DRAWING NO.

SPA155

55 REV. 5



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Hillsdale Ave E + Yonge St + Manor Rd E


Toronto, Ontario

FLOOR 05

PROJECT NO. 20.222P01

PROJECT DATE 2023-03-10 DRAWN BY CHECKED BY RMM l : 250

SPA156 FEV. 5

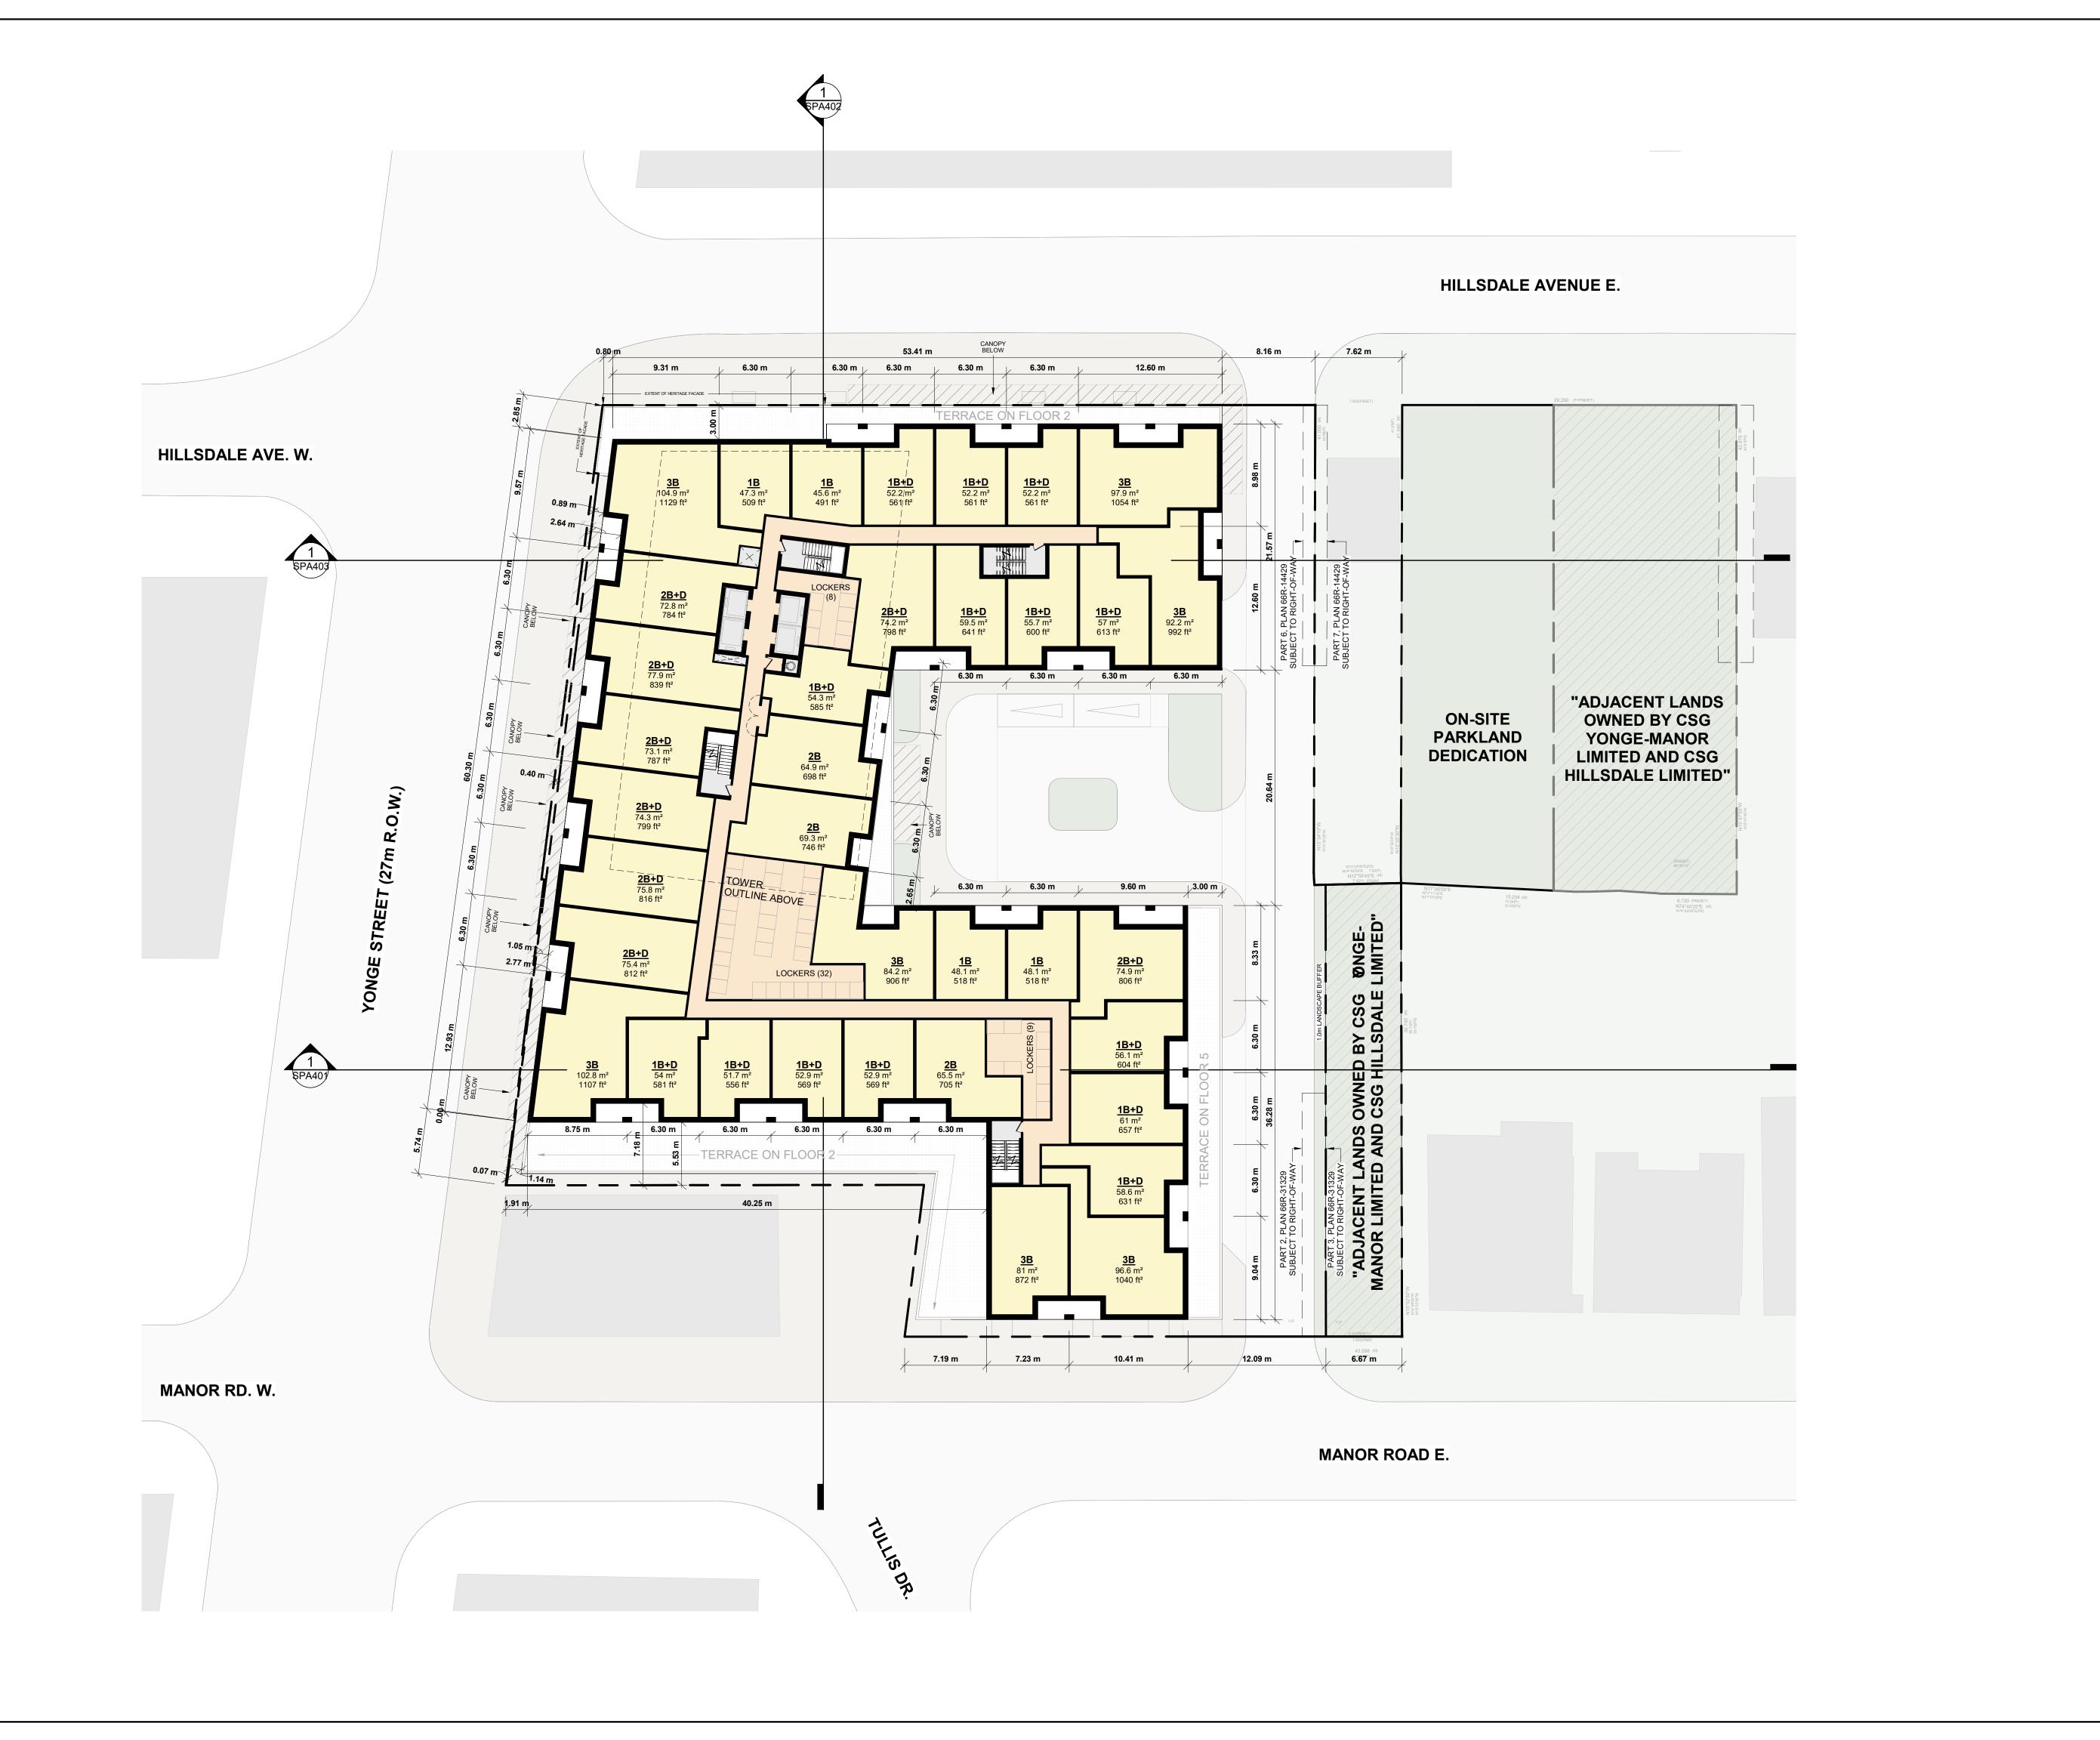

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Hillsdale Ave E + Yonge St + Manor Rd E


Toronto, Ontario

FLOOR 06

PROJECT NO. 20.222P01 PROJECT DATE 2023-03-10 DRAWN BY CHECKED BY RMM l : 250

SPA157

T REV.

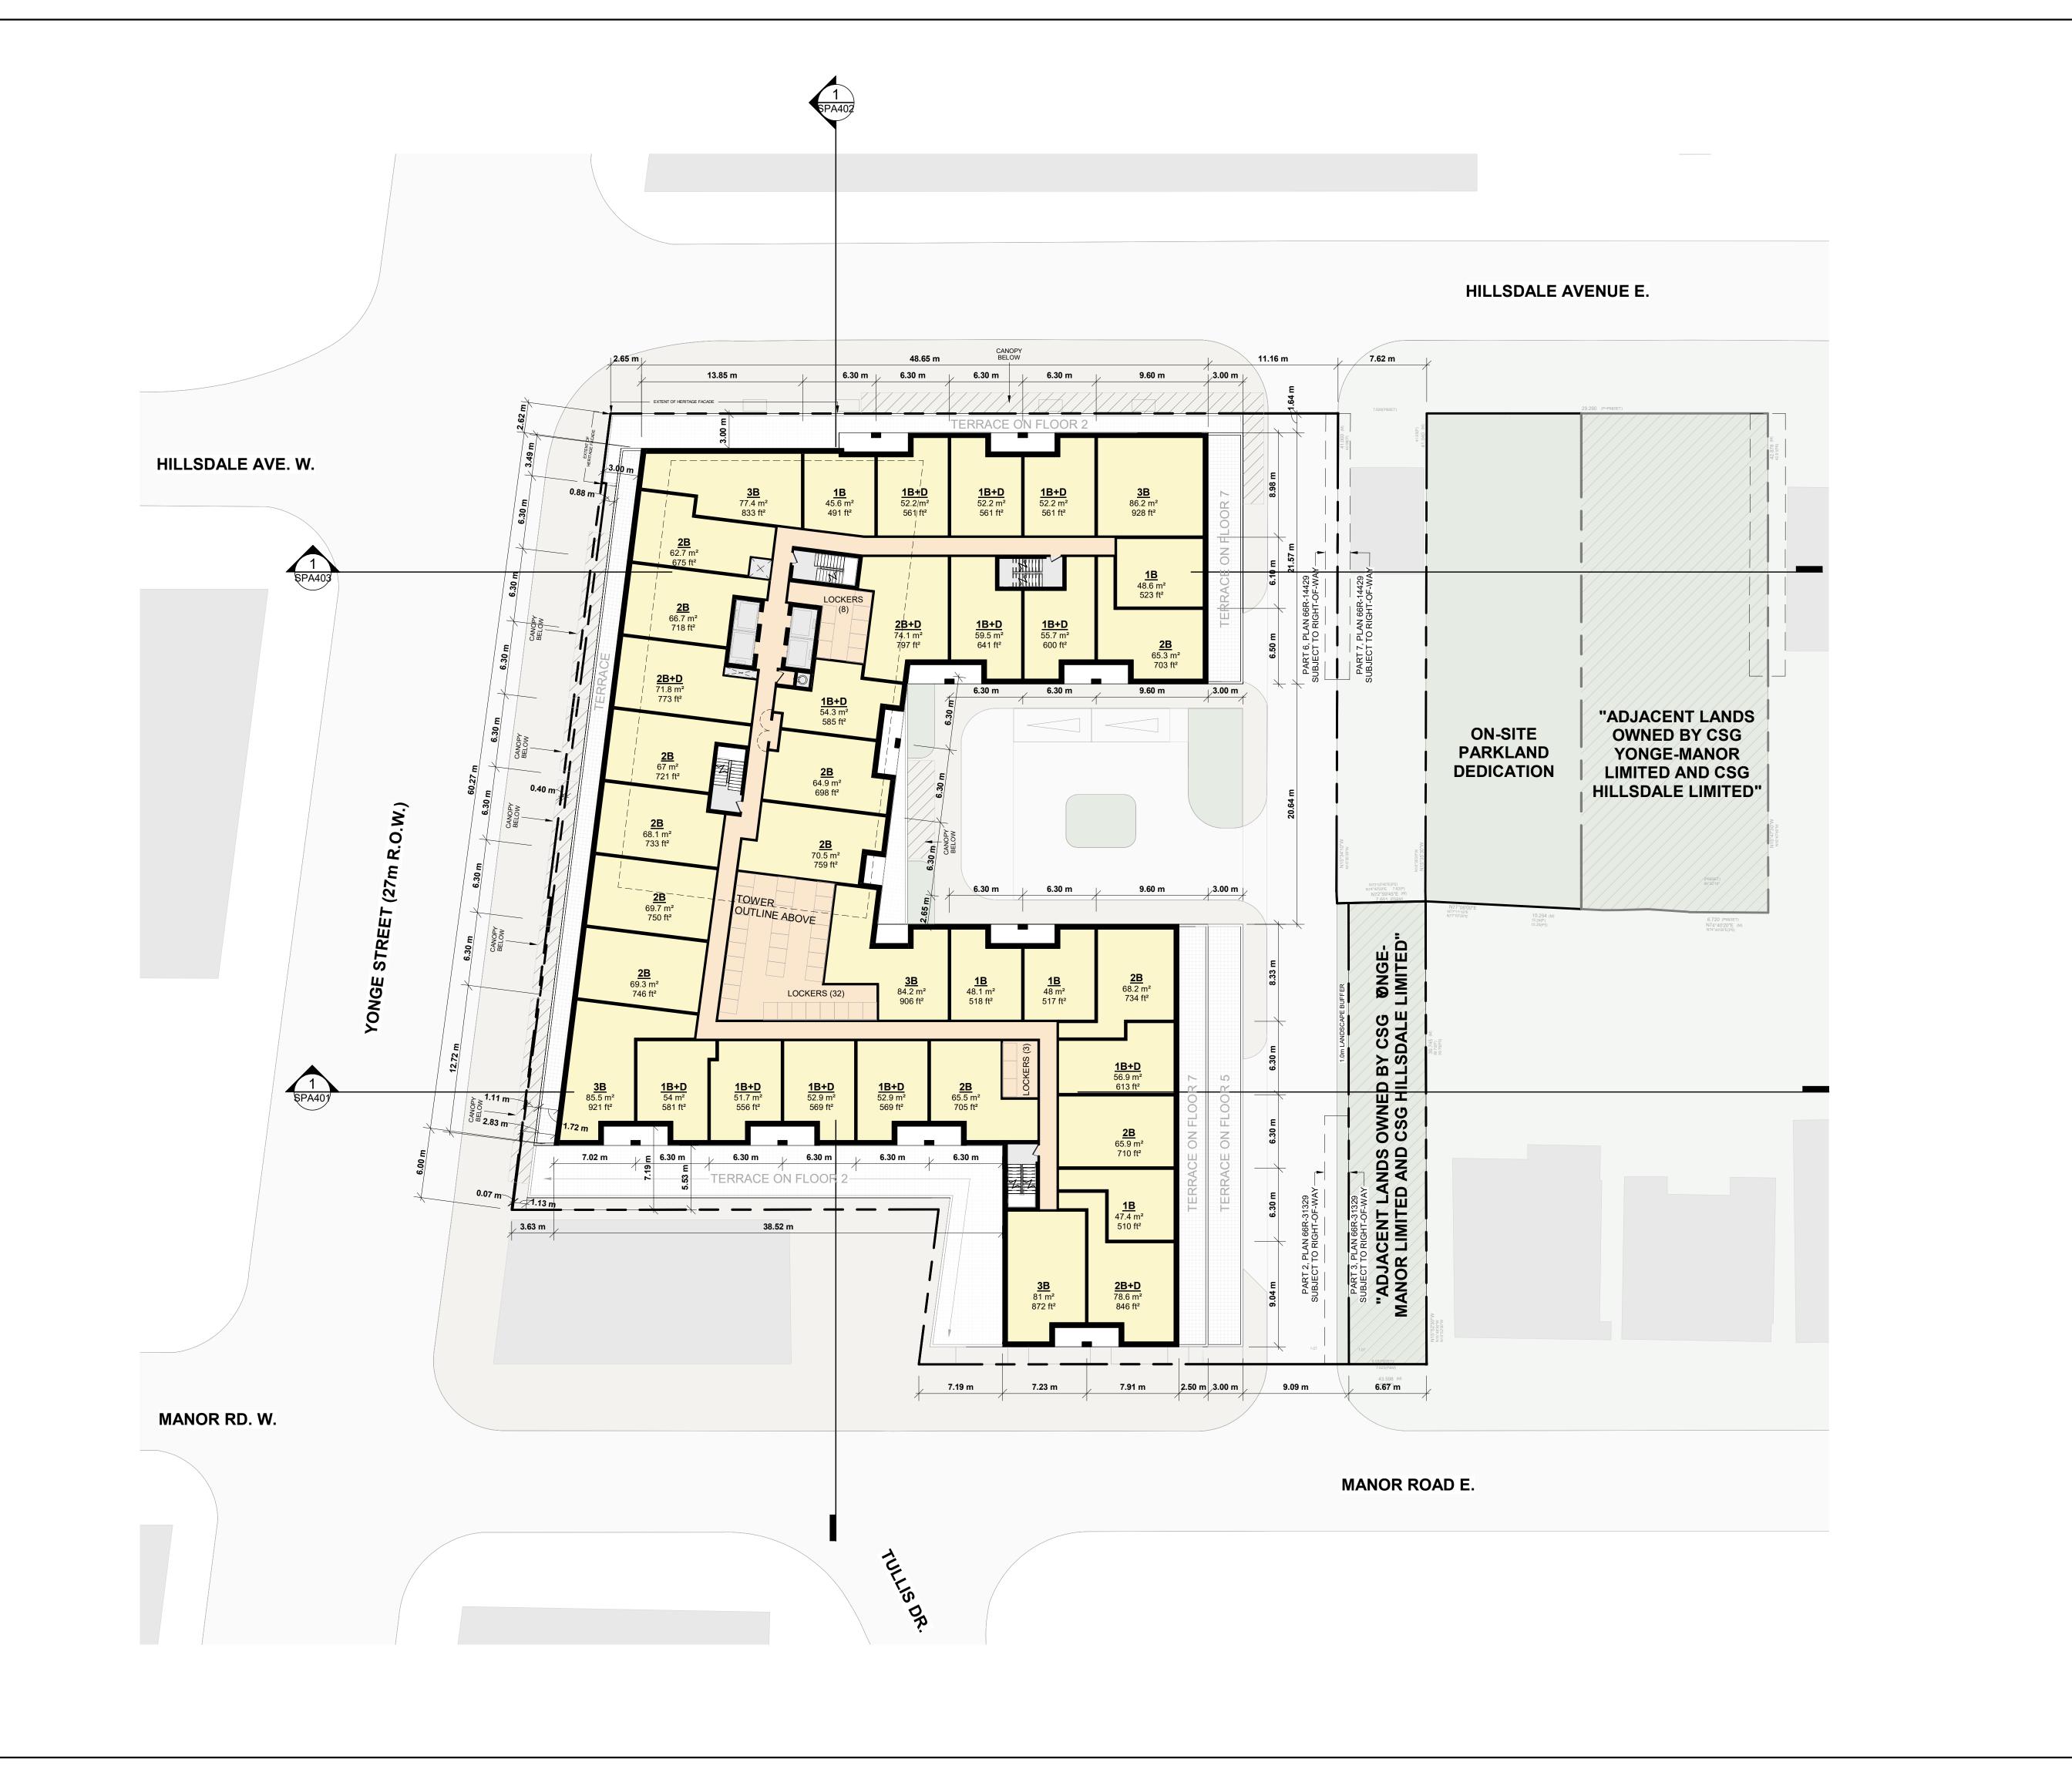

> 67 Lesmill Road Toronto, ON, M3B 2T8

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 5
 2024-10-02
 WITHOUT PREJUDICE SET #2
 NMU

 4
 2024-03-18
 WITHOUT PREJUDICE SET
 NMU

 2
 2023-11-08
 REZONING RESUBMISSION
 NMU

 1
 2023-08-15
 ISSUED FOR REZONING
 NMU

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 DATE
 DESCRIPTION
 BY

Hillsdale Ave E + Yonge St +
Manor Rd E

Toronto, Ontario

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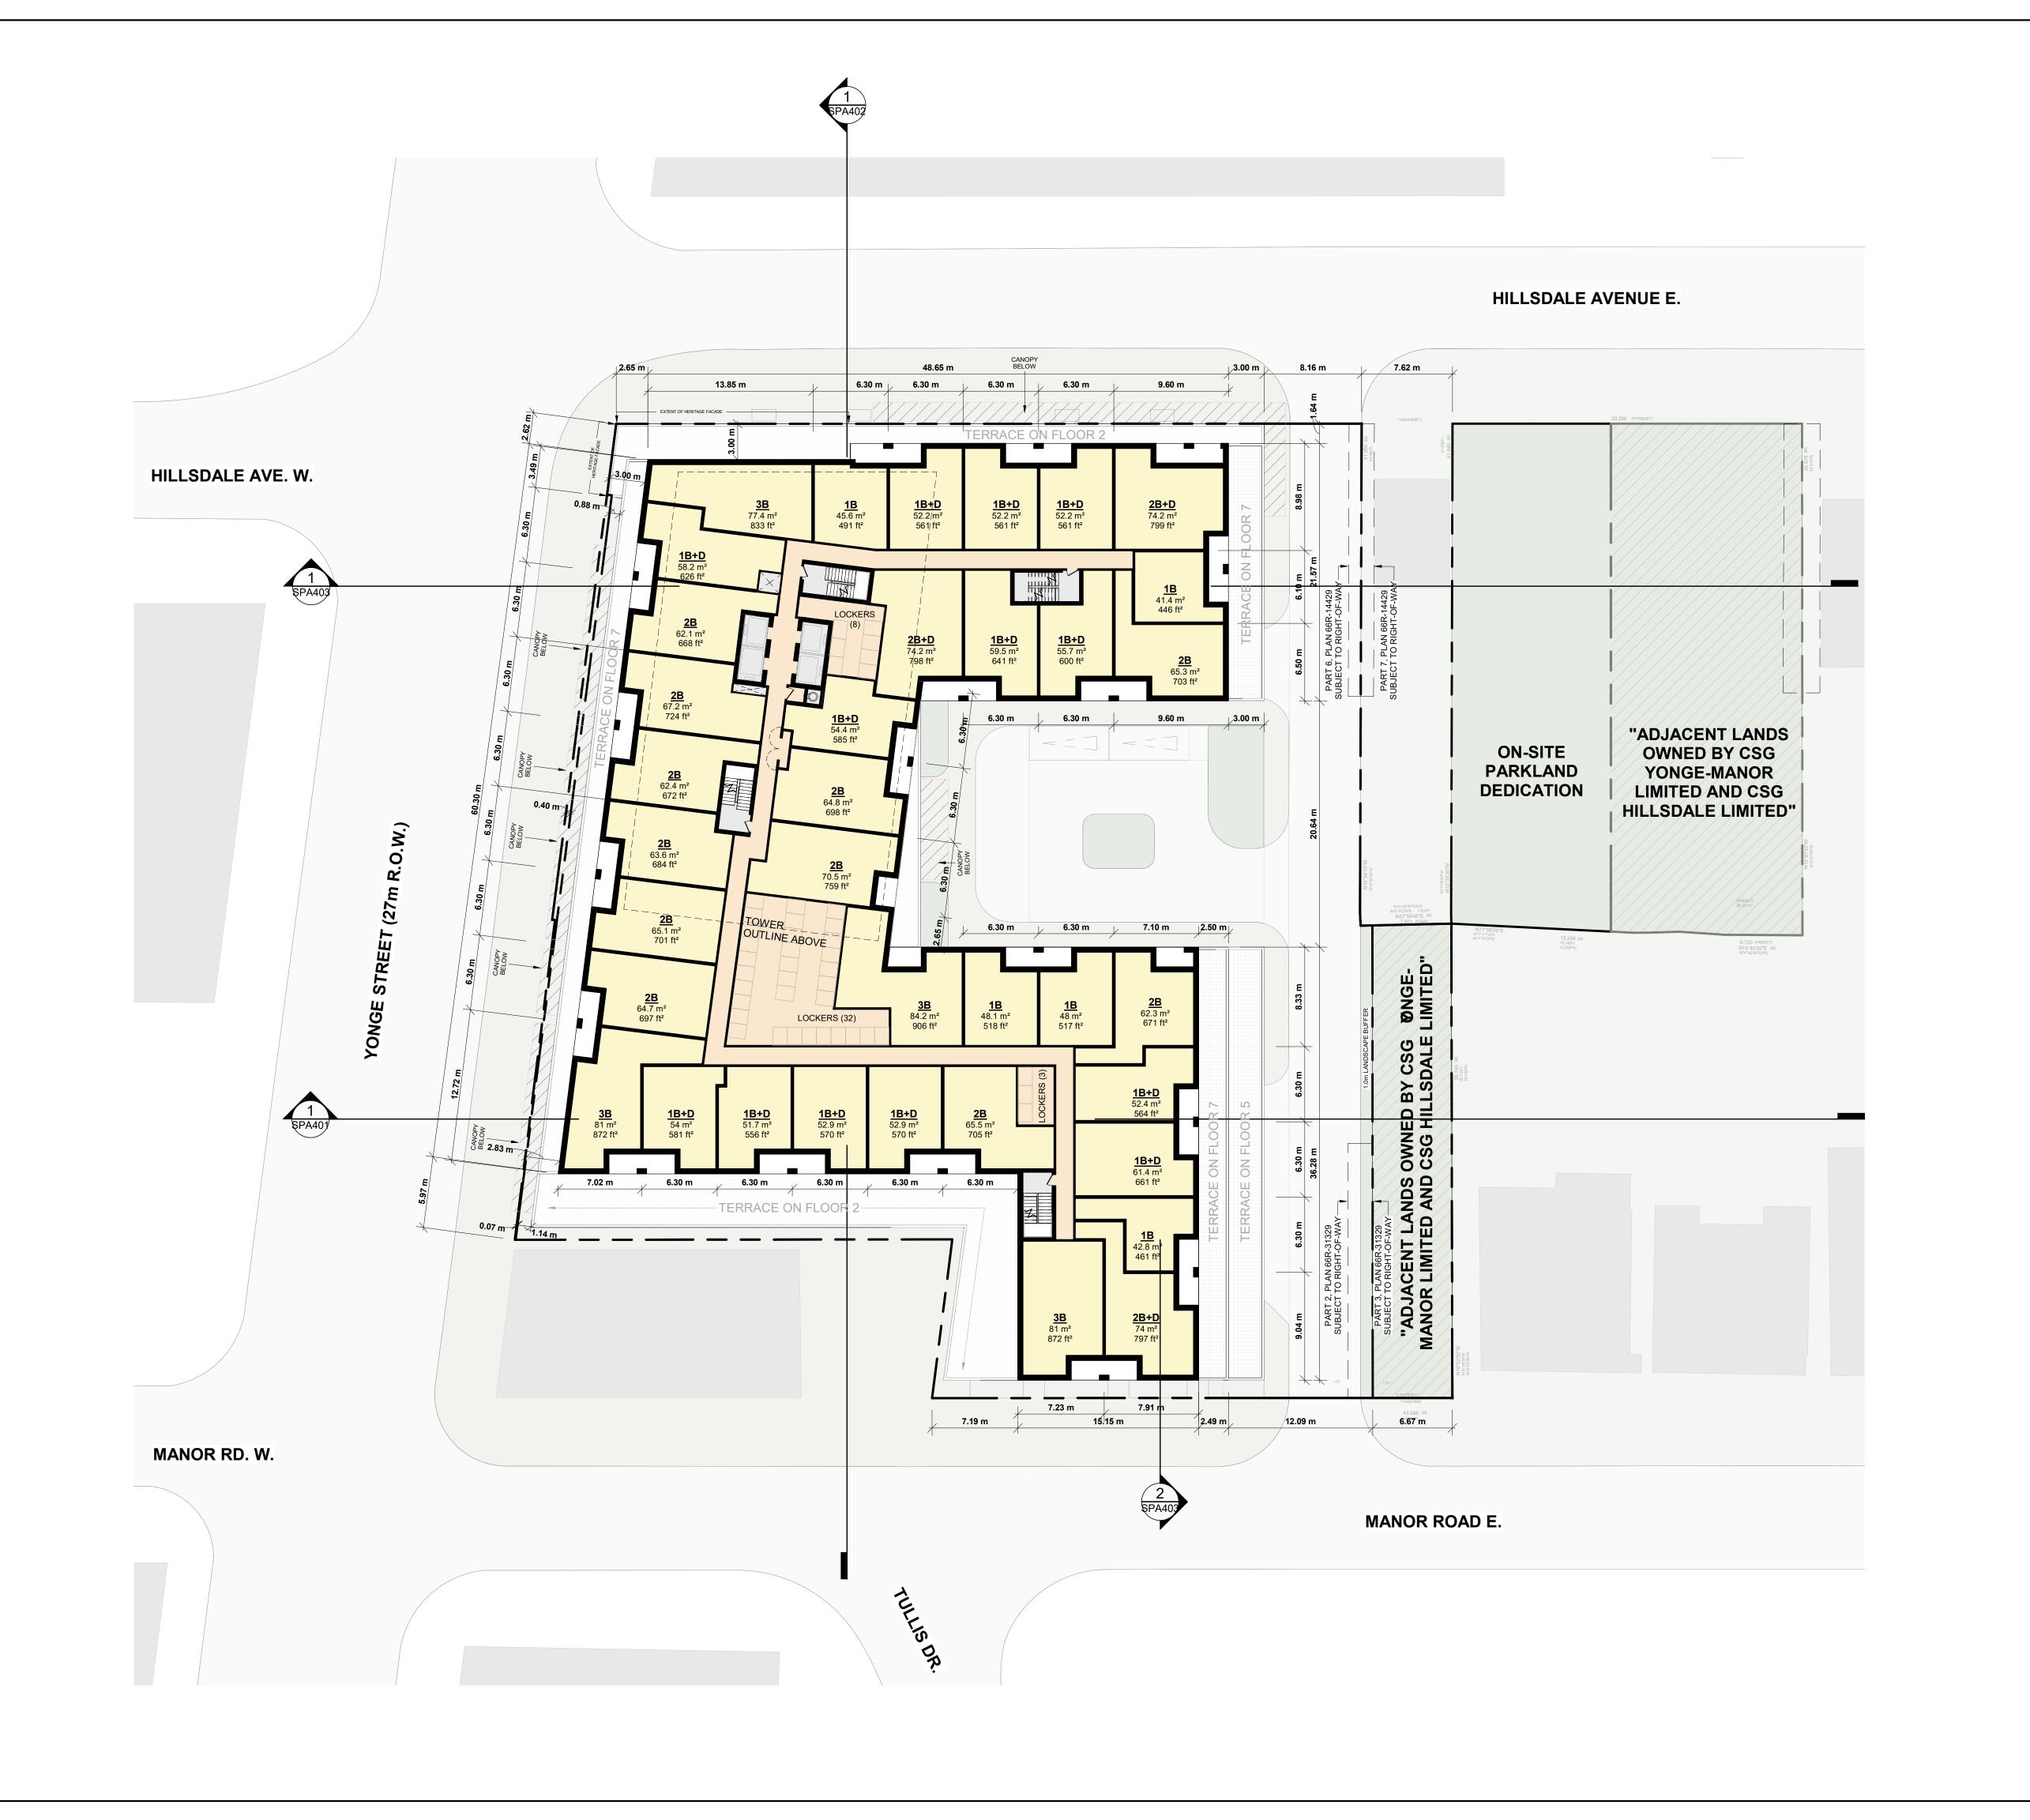
FLOOR 07

PROJECT NO.
20.222P01
PROJECT DATE
2023-03-10
DRAWN BY
TKA

PROJECT DATE
2023-03-10
DRAWN BY
TKA
CHECKED BY
RMM
SCALE
1:250

DRAWING NO.

SPA158 REV. 5



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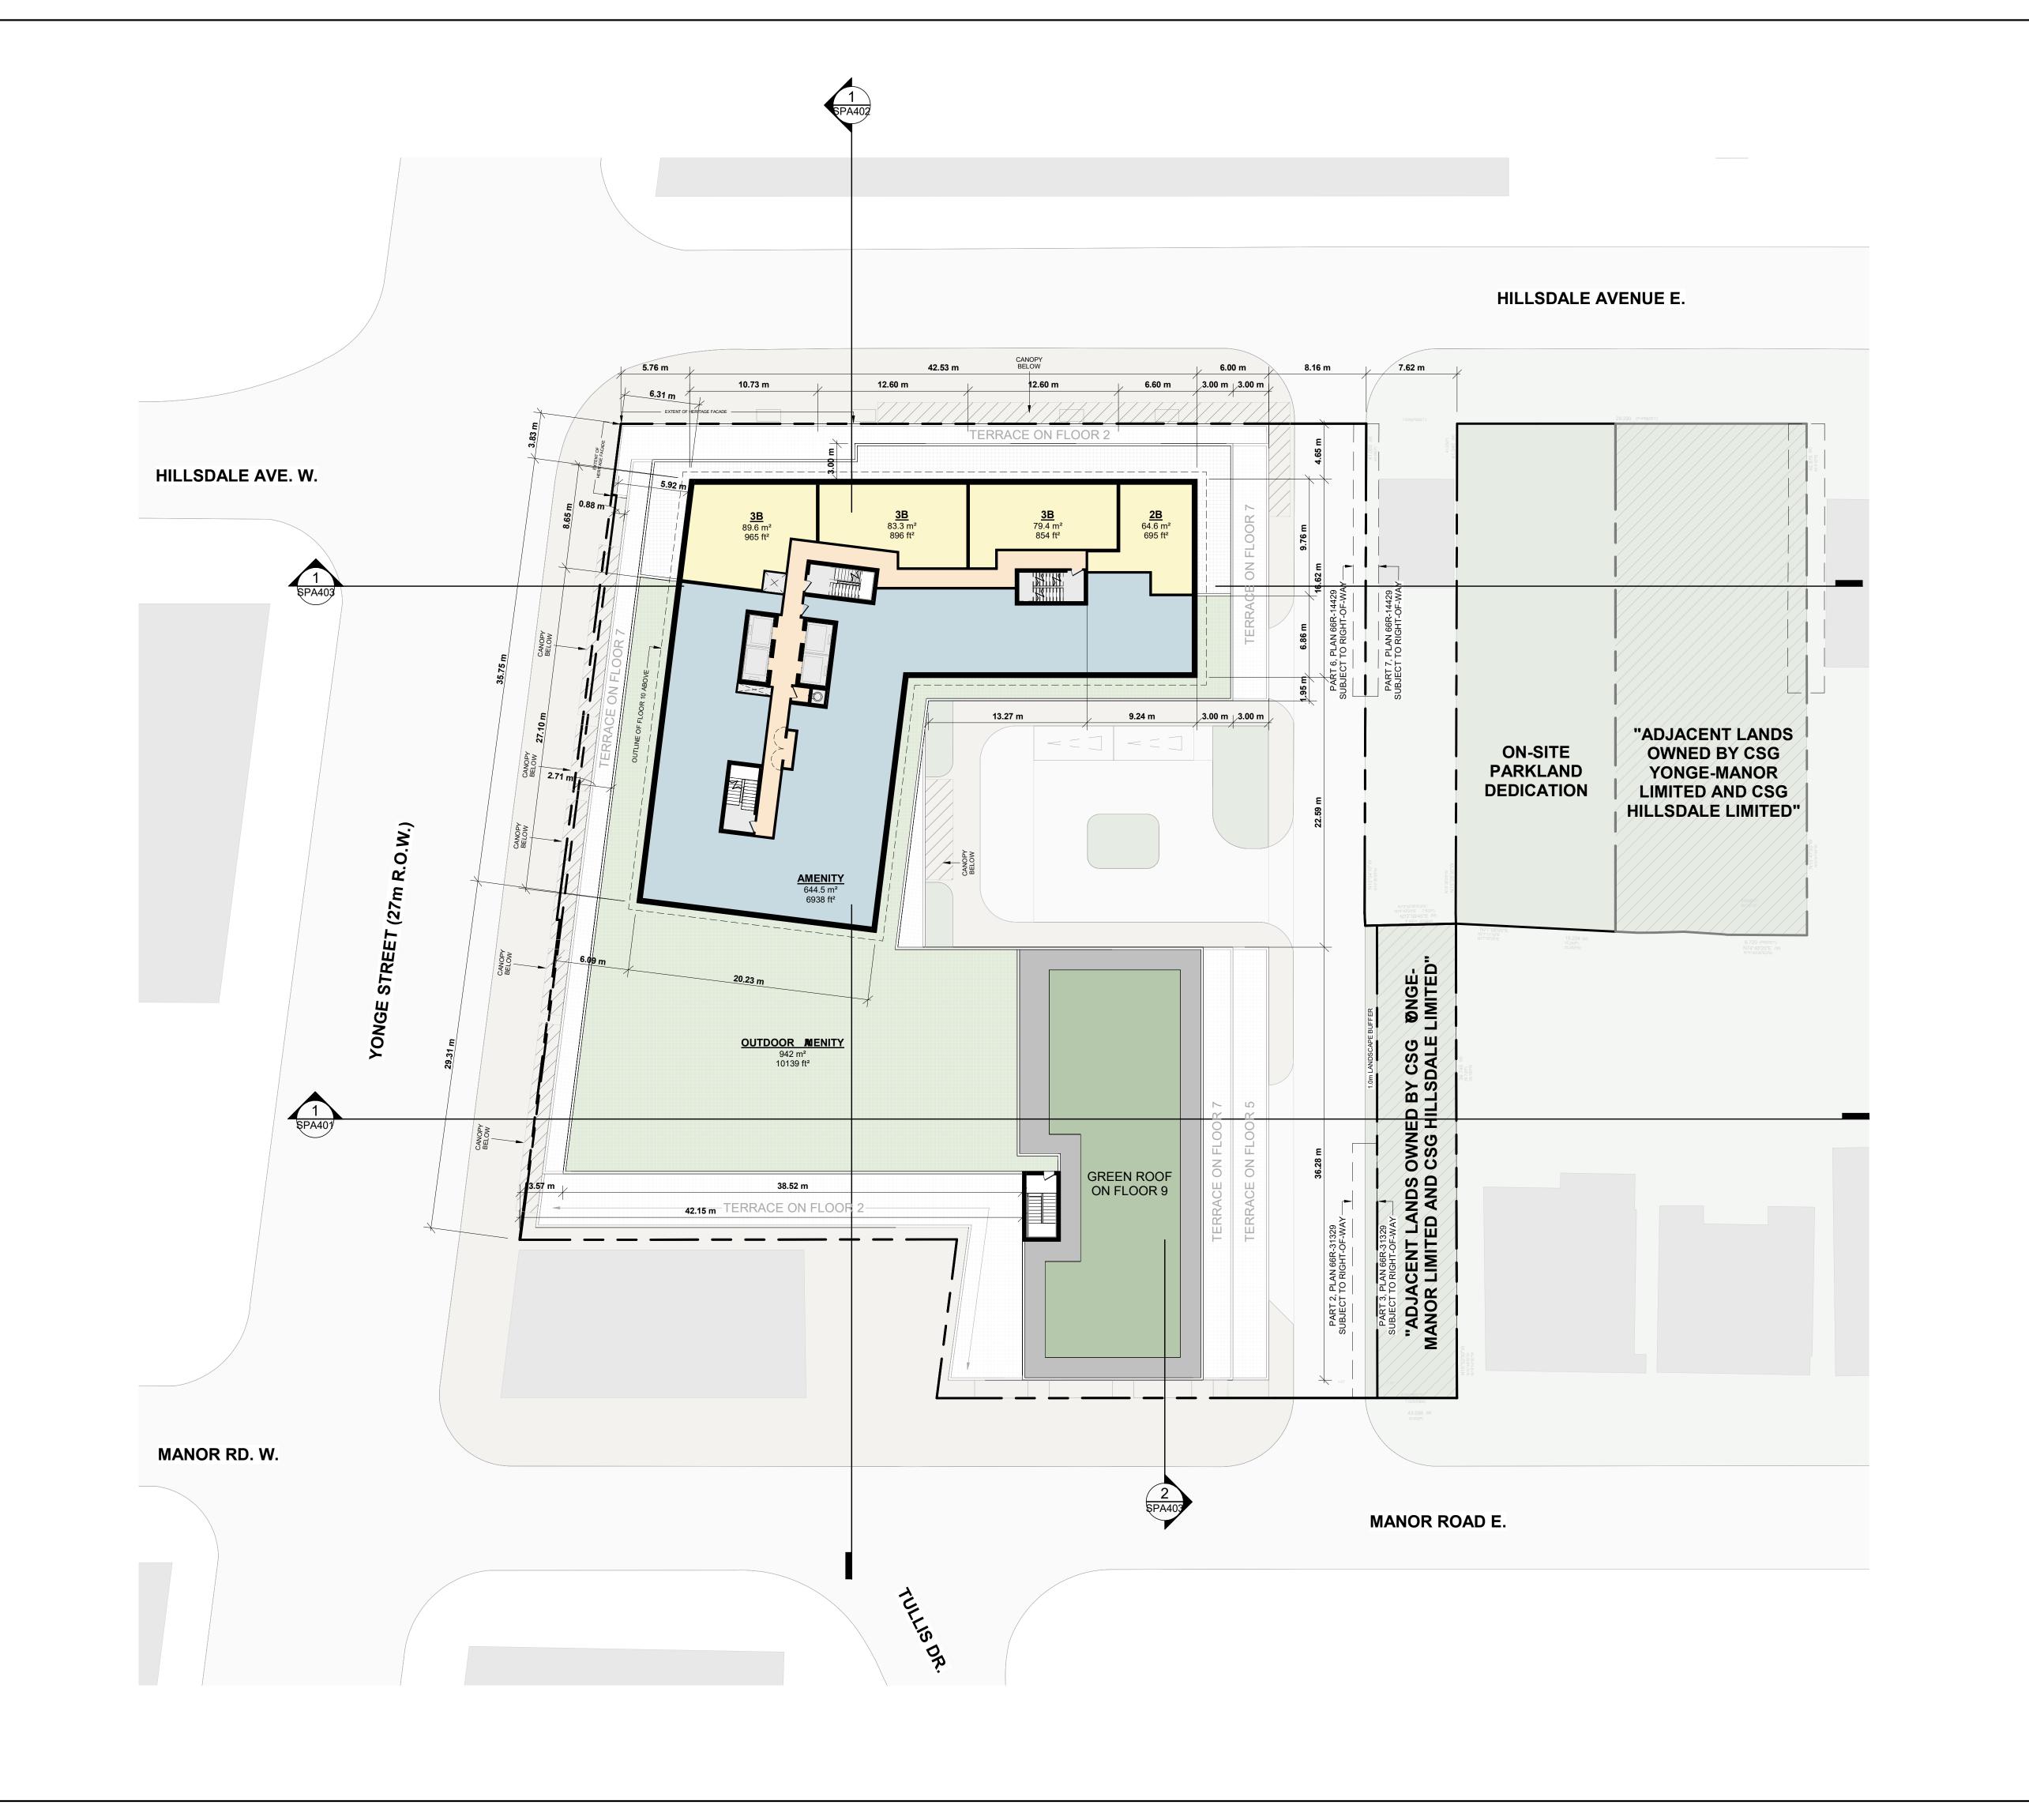
Hillsdale Ave E + Yonge St + Manor Rd E

Toronto, Ontario

FLOOR 08

PROJECT NO. 20.222P01 PROJECT DATE 2023-03-10 DRAWN BY CHECKED BY RMM

SPA159 REV. 5



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5 2024-10-02 WITHOUT PREJUDICE SET #2
4 2024-03-18 WITHOUT PREJUDICE SET
2 2023-11-08 REZONING RESUBMISSION
1 2023-08-15 ISSUED FOR REZONING
DATE DESCRIPTION


Hillsdale Ave E + Yonge St + Manor Rd E

FLOOR 09

Toronto, Ontario

PROJECT NO. 20.222P01
PROJECT DATE 2023-03-10 DRAWN BY TKA
CHECKED BY
RMM

SPA160 REV. 5

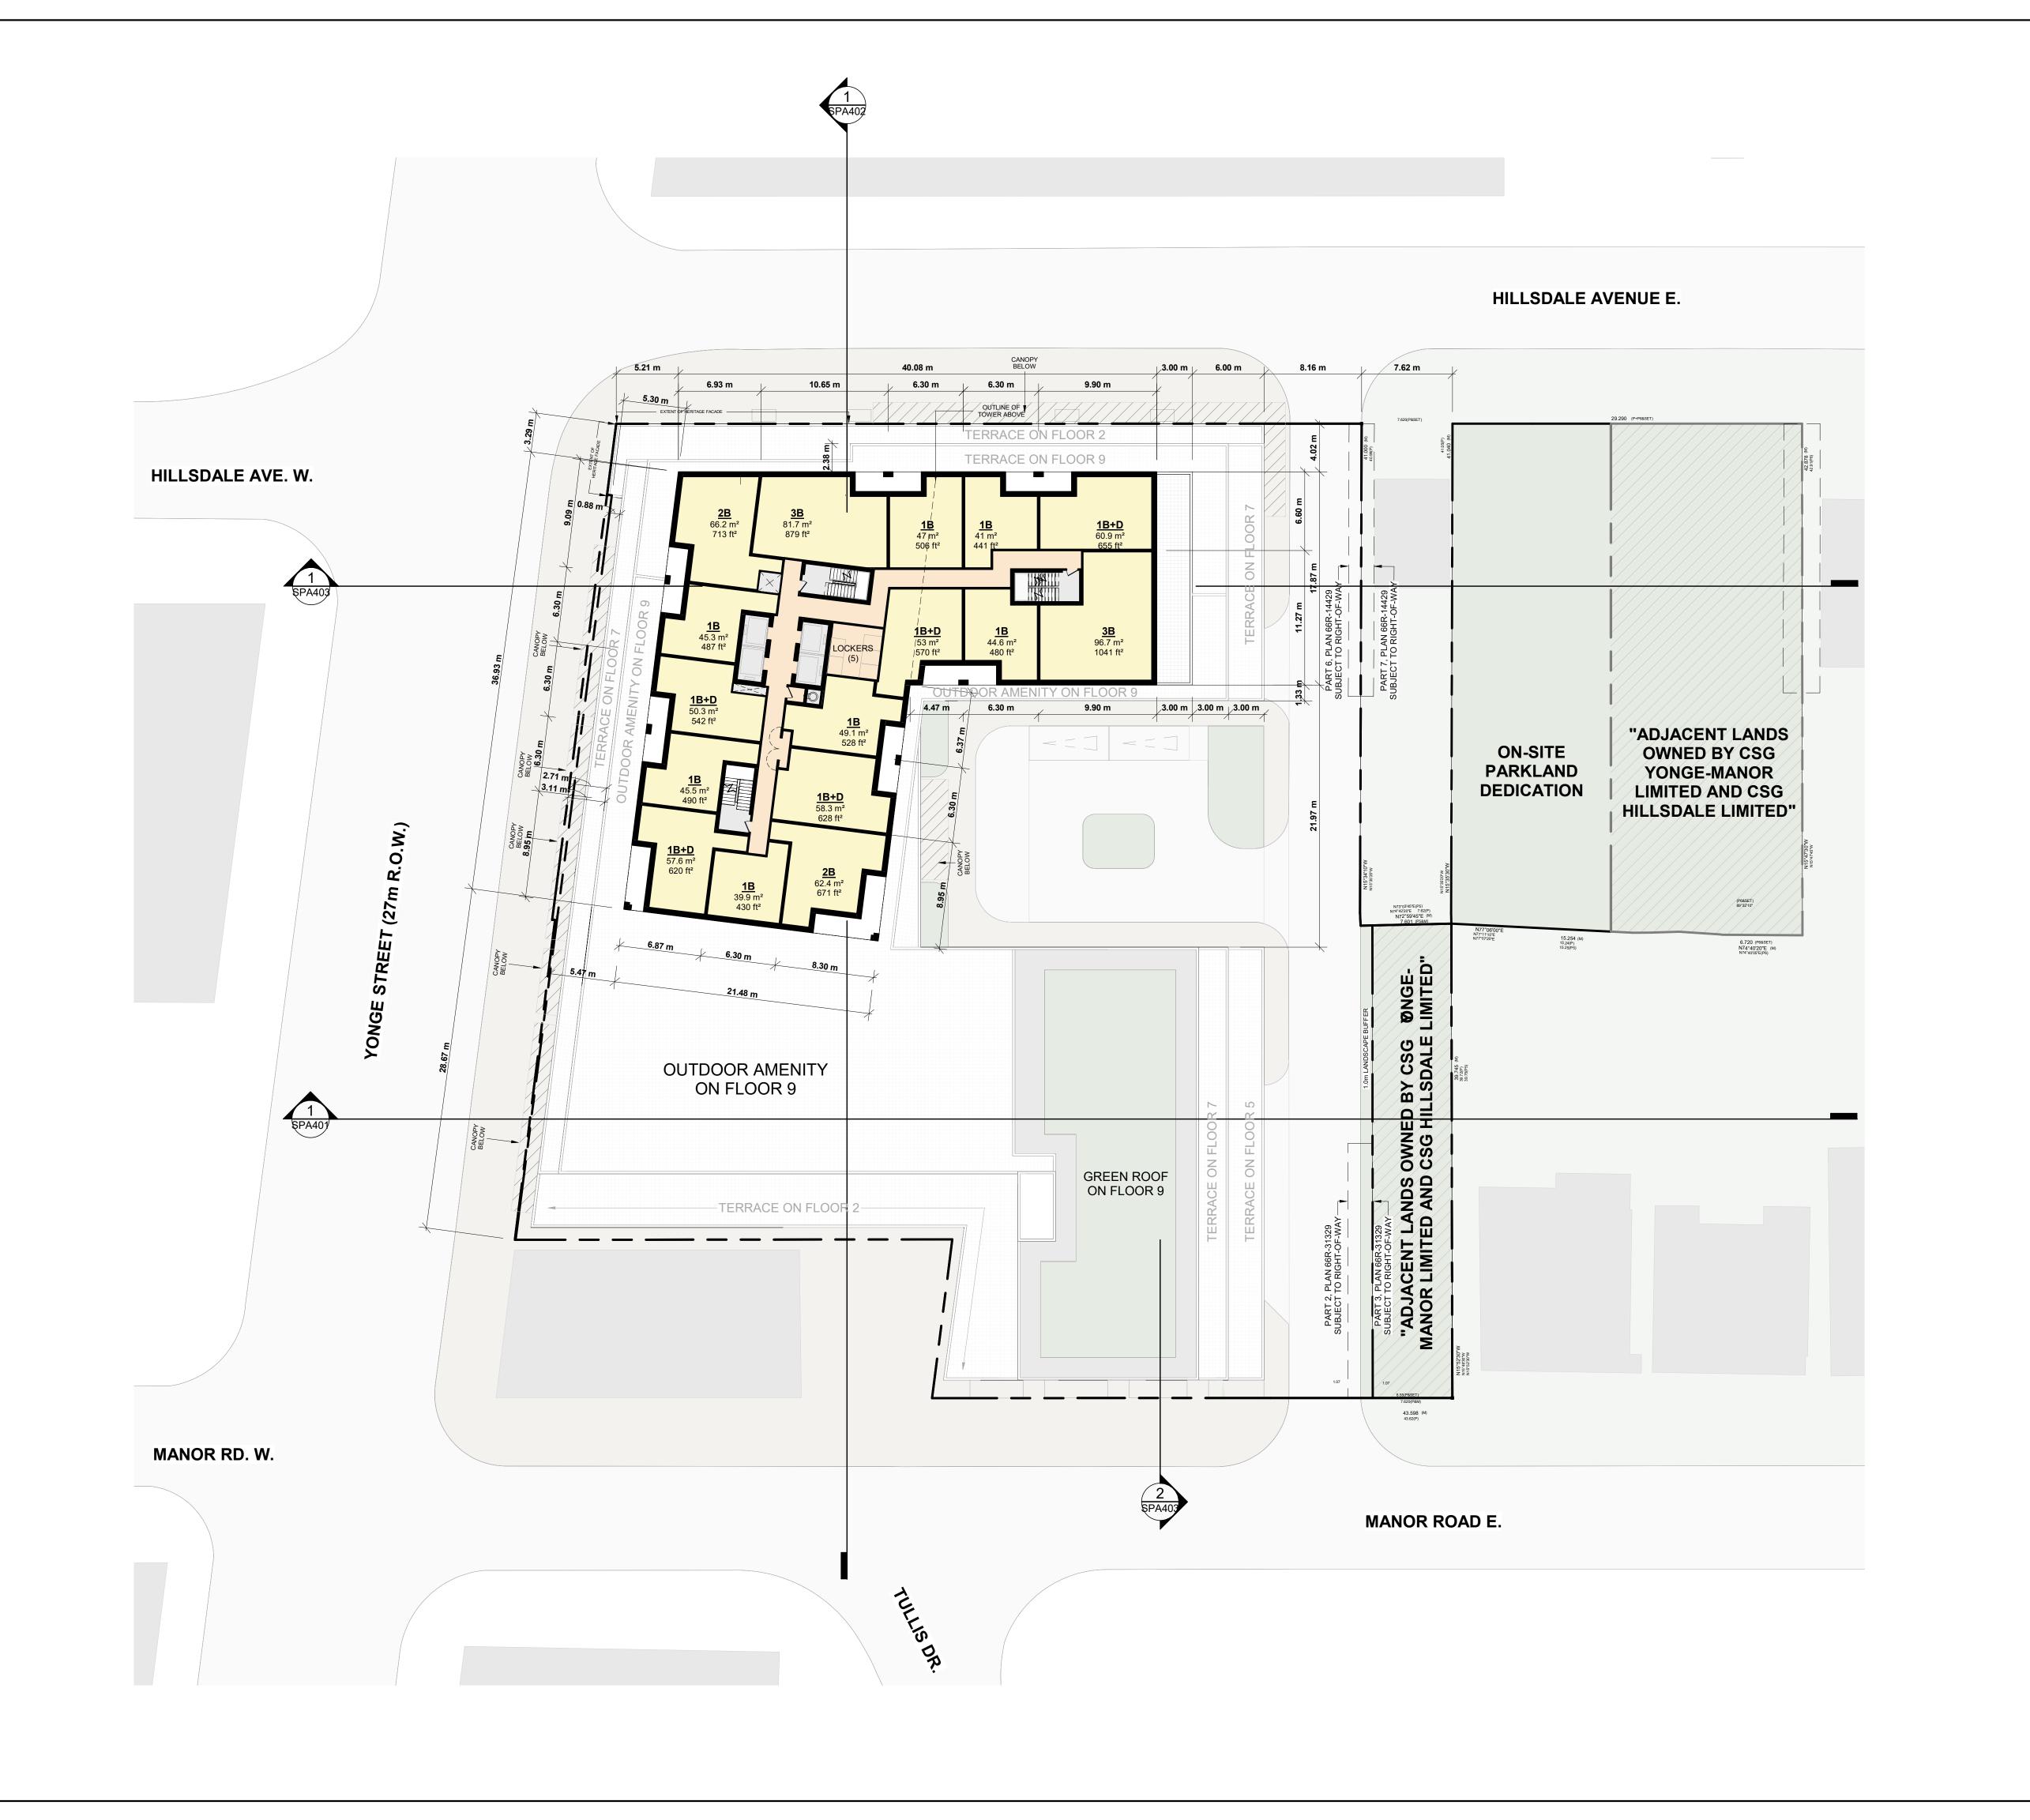

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5 2024-10-02 WITHOUT PREJUDICE SET #2
4 2024-03-18 WITHOUT PREJUDICE SET
DATE DESCRIPTION

Hillsdale Ave E + Yonge St +
Manor Rd E

Manor Rd E

Toronto, Ontario

DRAW

FLOOR 10

PROJECT NO.

20.222P01

PROJECT DATE

2023-03-10

DRAWN BY

TKA


CHECKED BY

RMM

SCALE

DRAWING NO.

SPA161 REV. 5

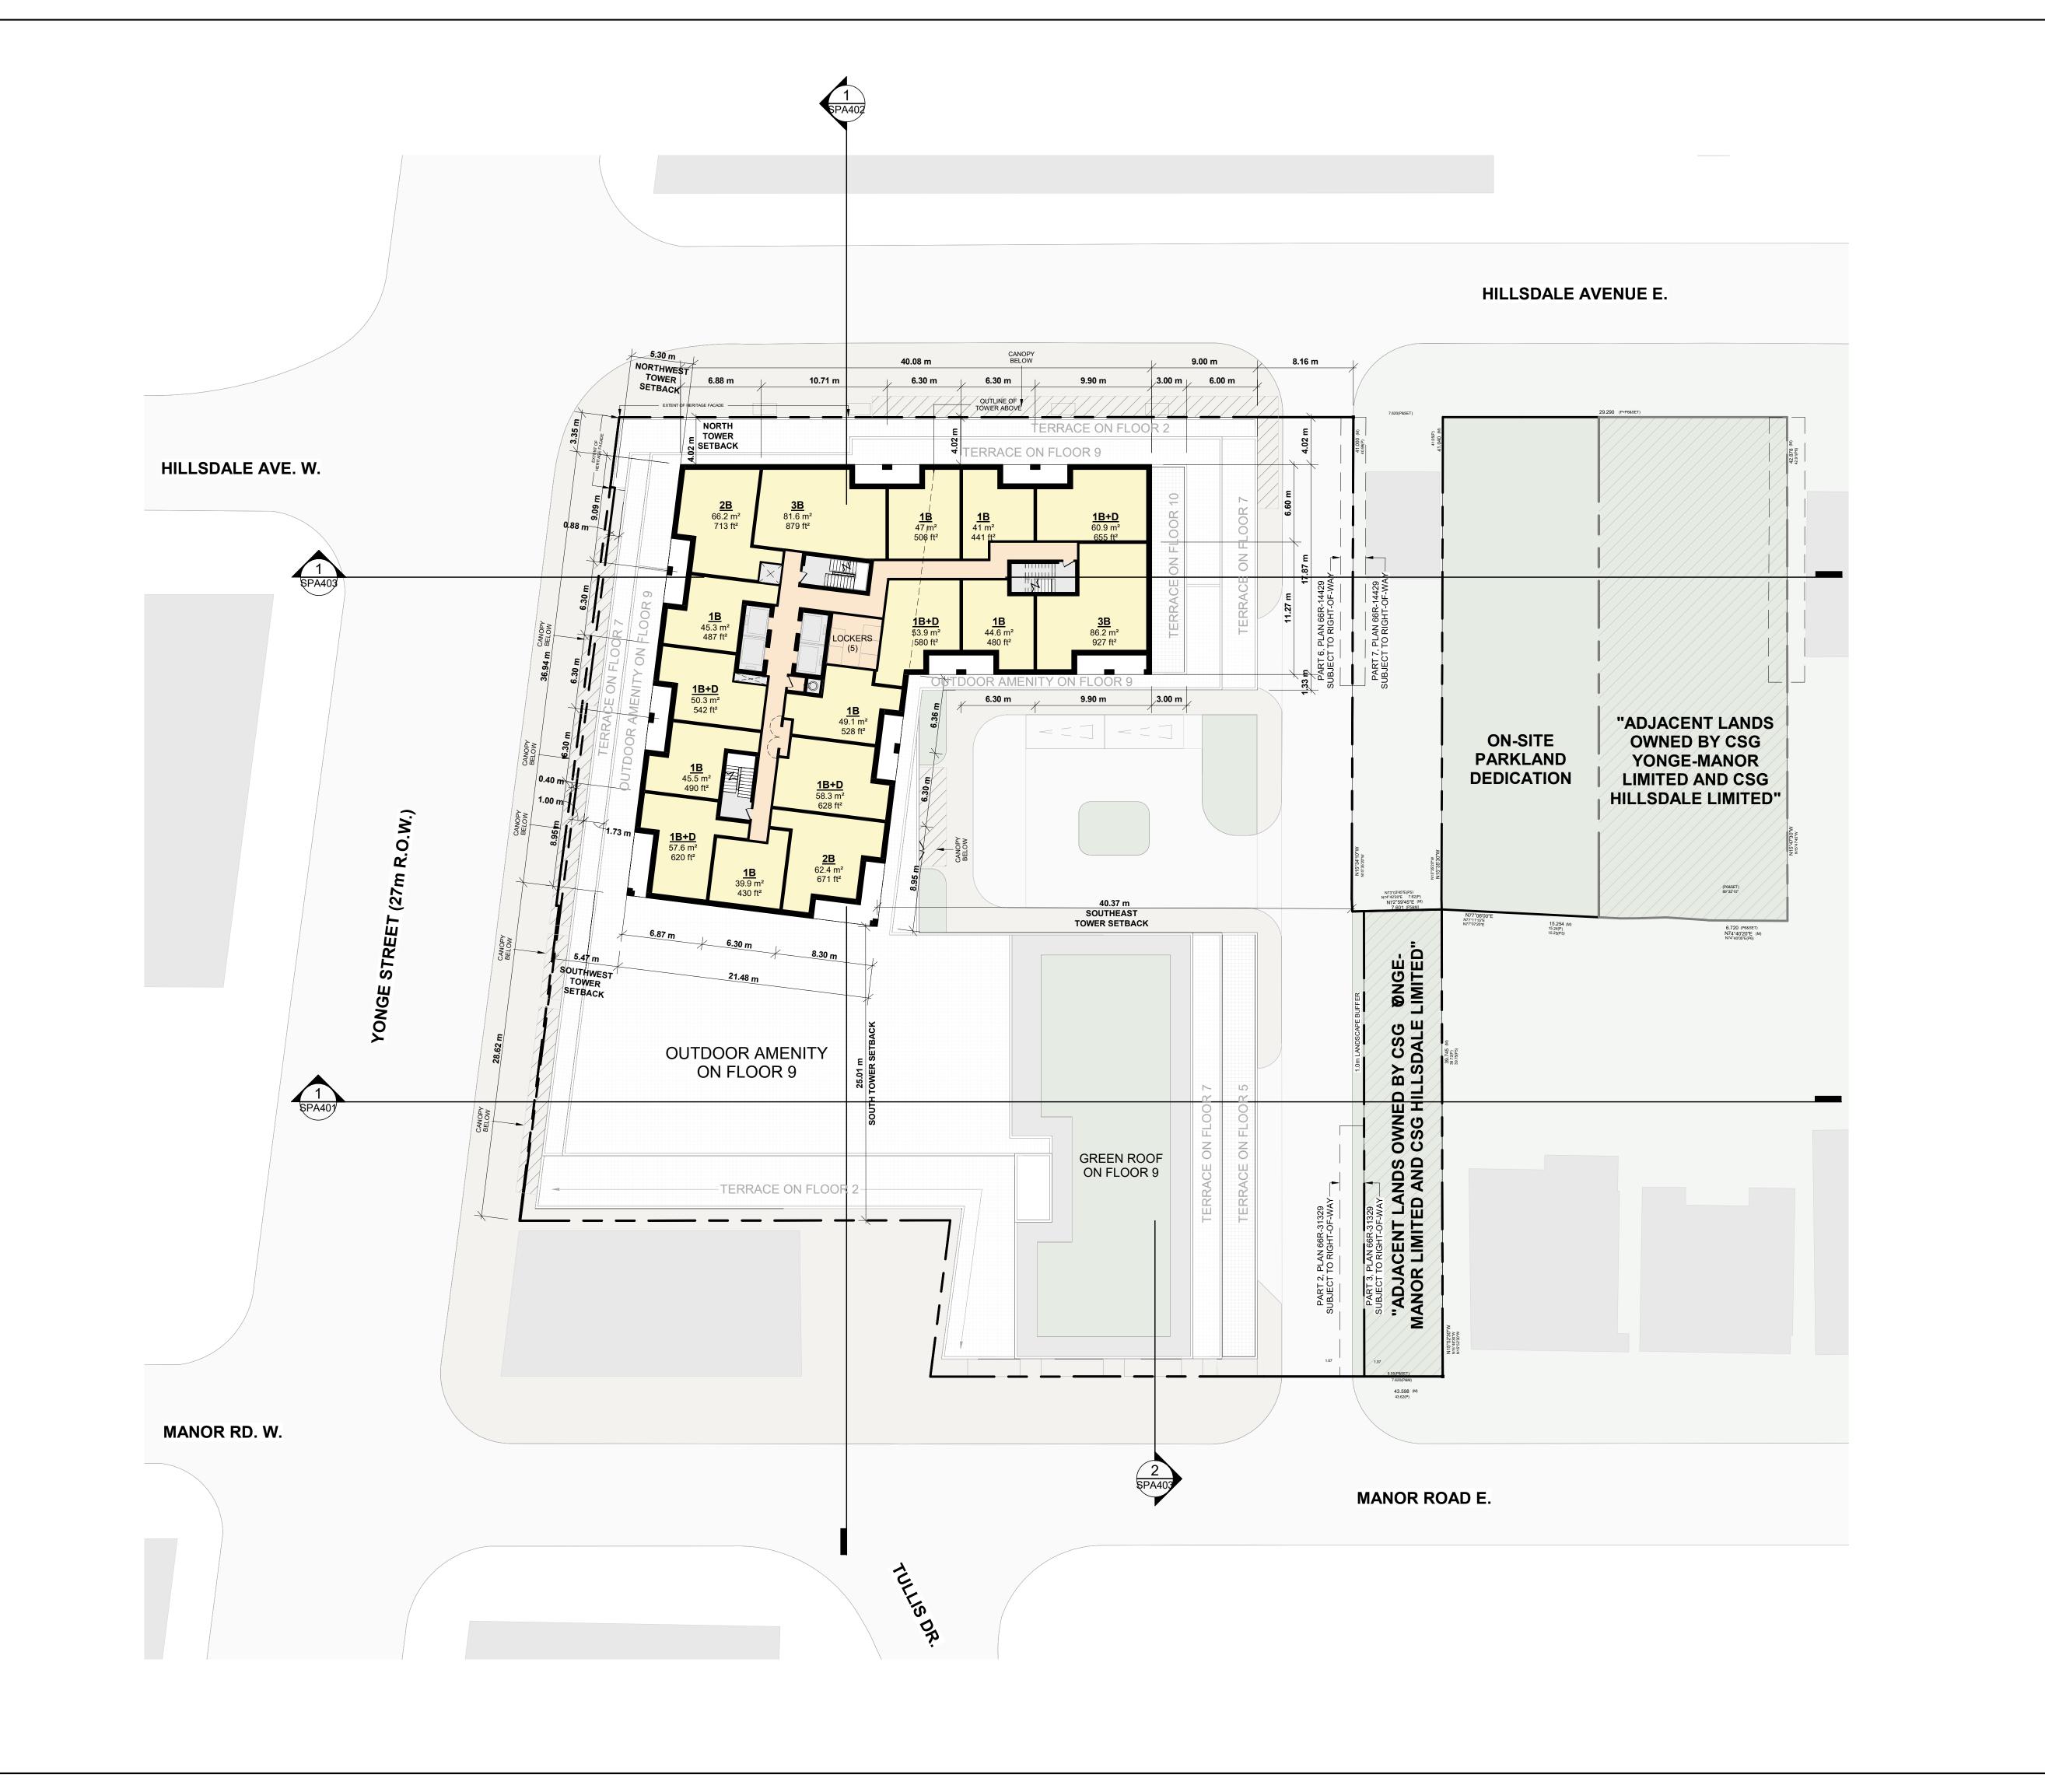

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5 2024-10-02 WITHOUT PREJUDICE SET #2 4 2024-03-18 WITHOUT PREJUDICE SET # DATE DESCRIPTION


Hillsdale Ave E + Yonge St + Manor Rd E


Toronto, Ontario


FLOOR 11

PROJECT NO. 20.222P01
PROJECT DATE 2023-03-10
DRAWN BY
TKA
CHECKED BY
RMM

SPA162 REV. 5

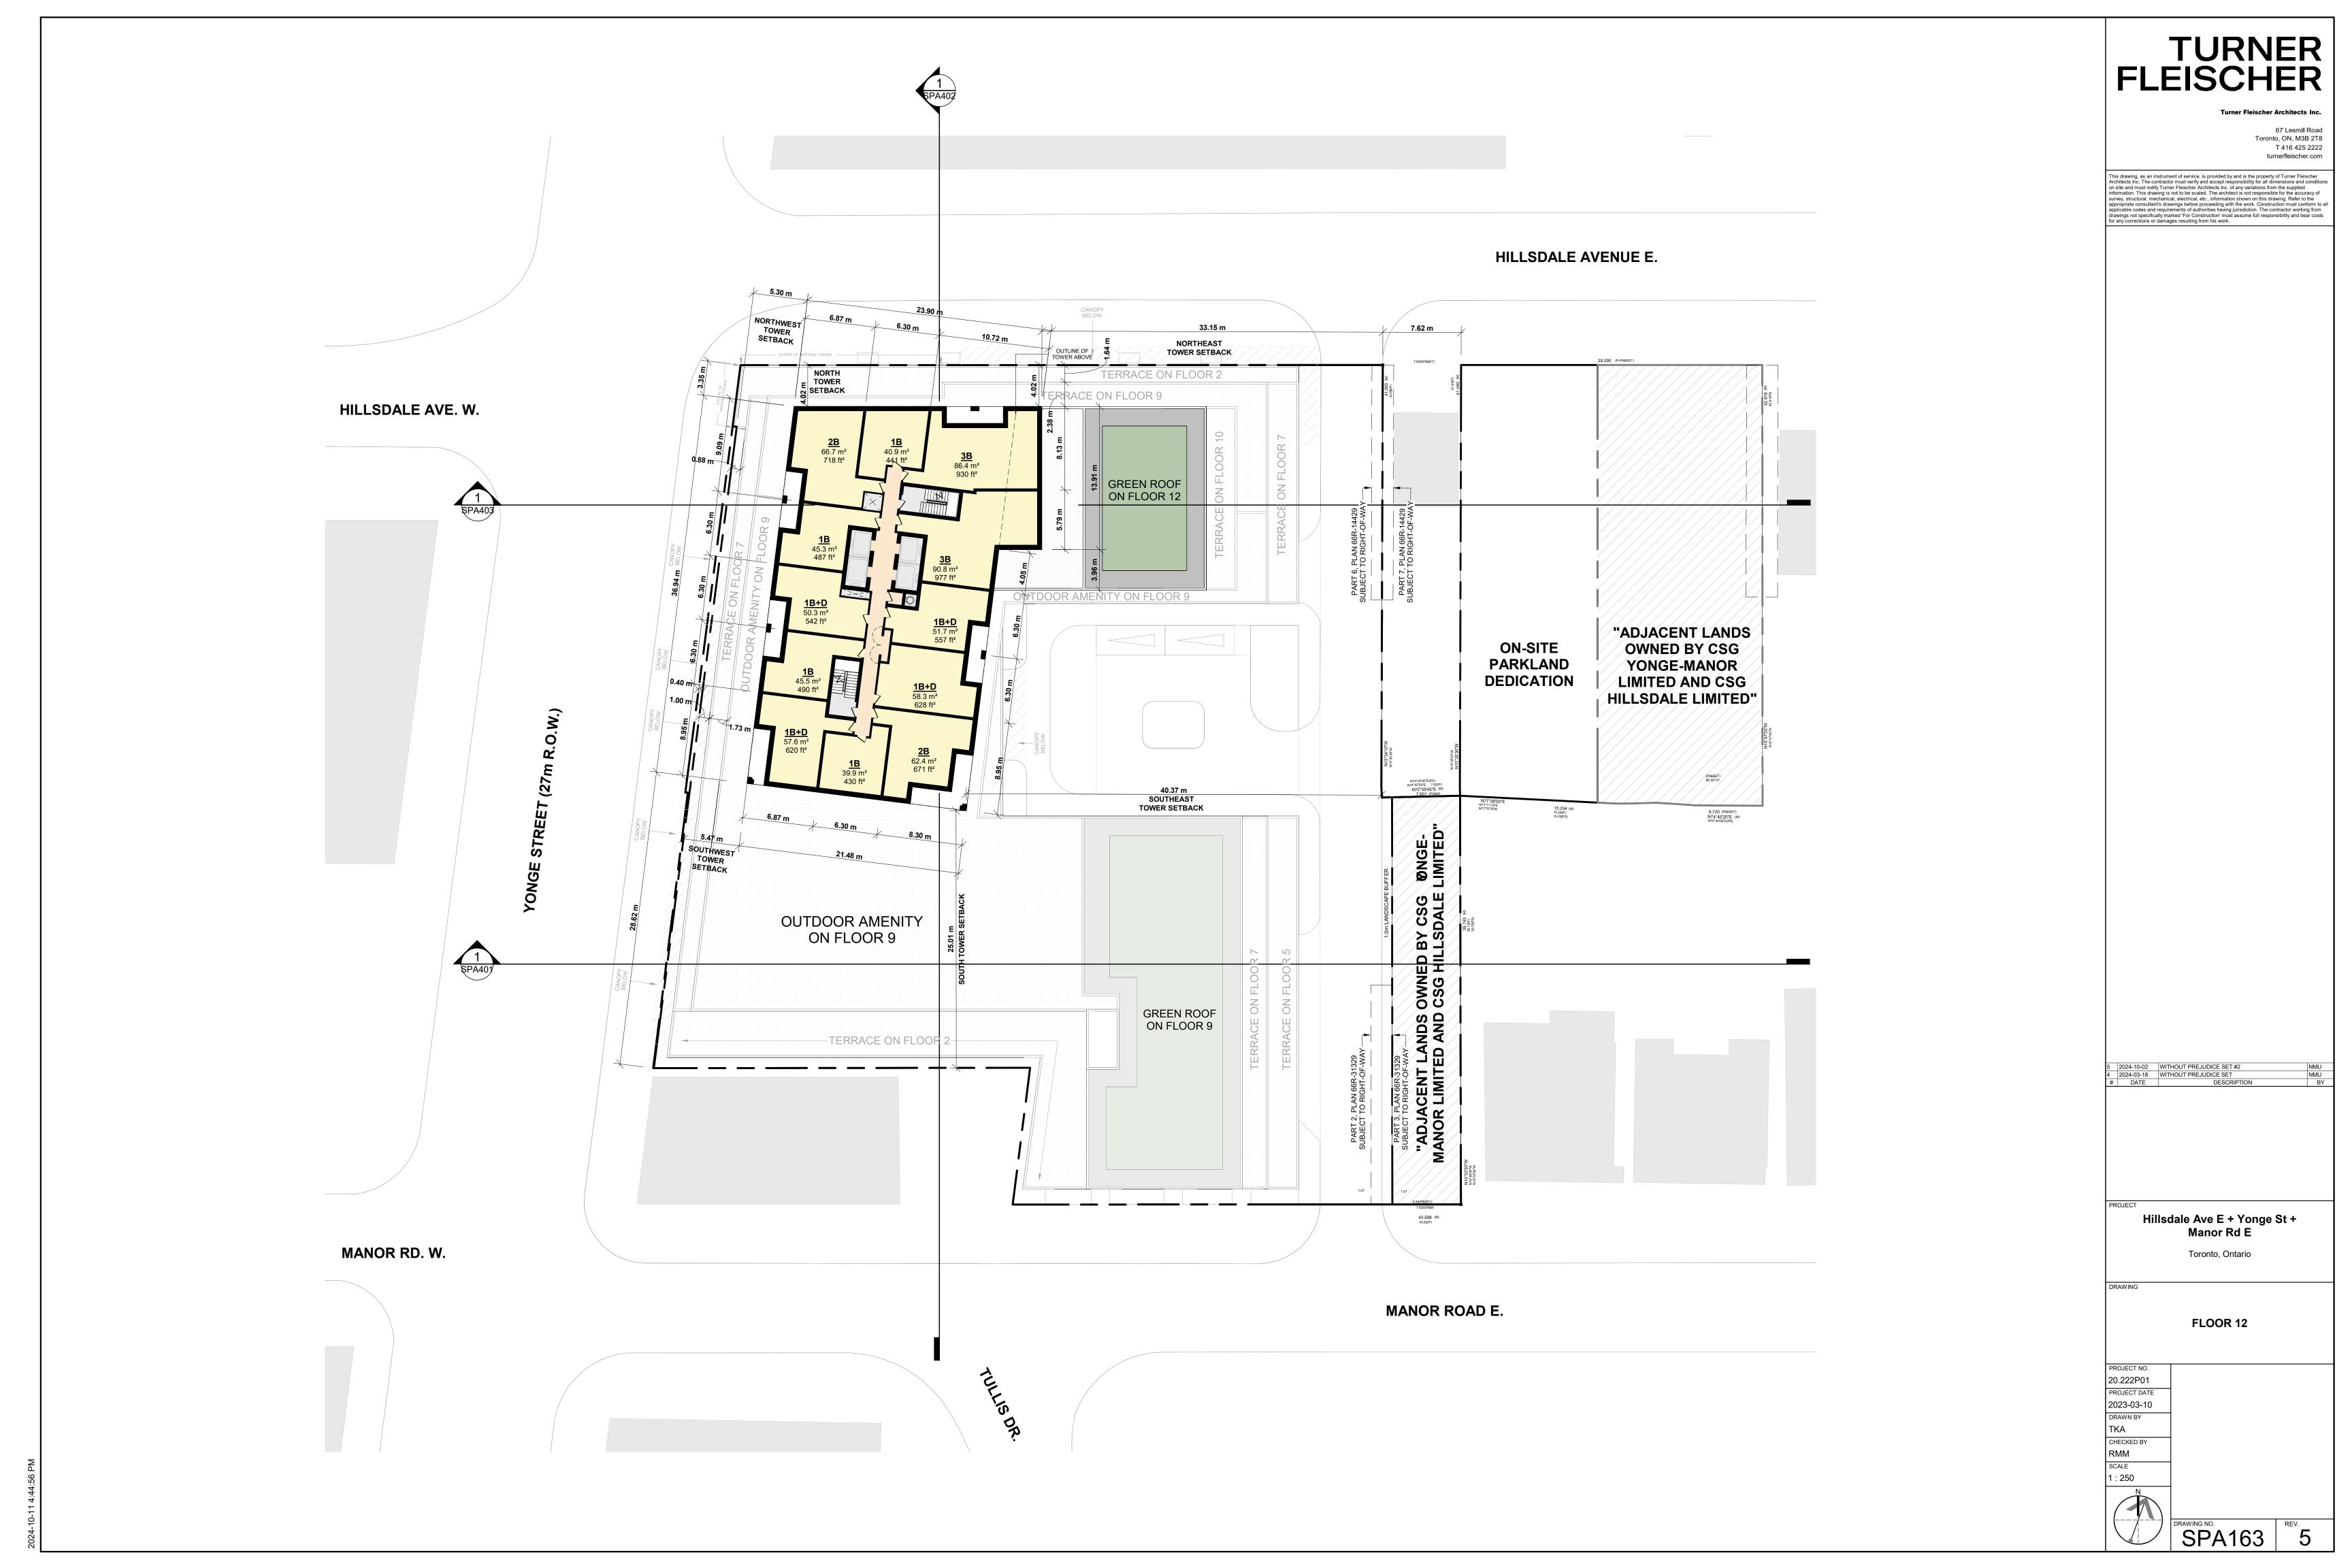

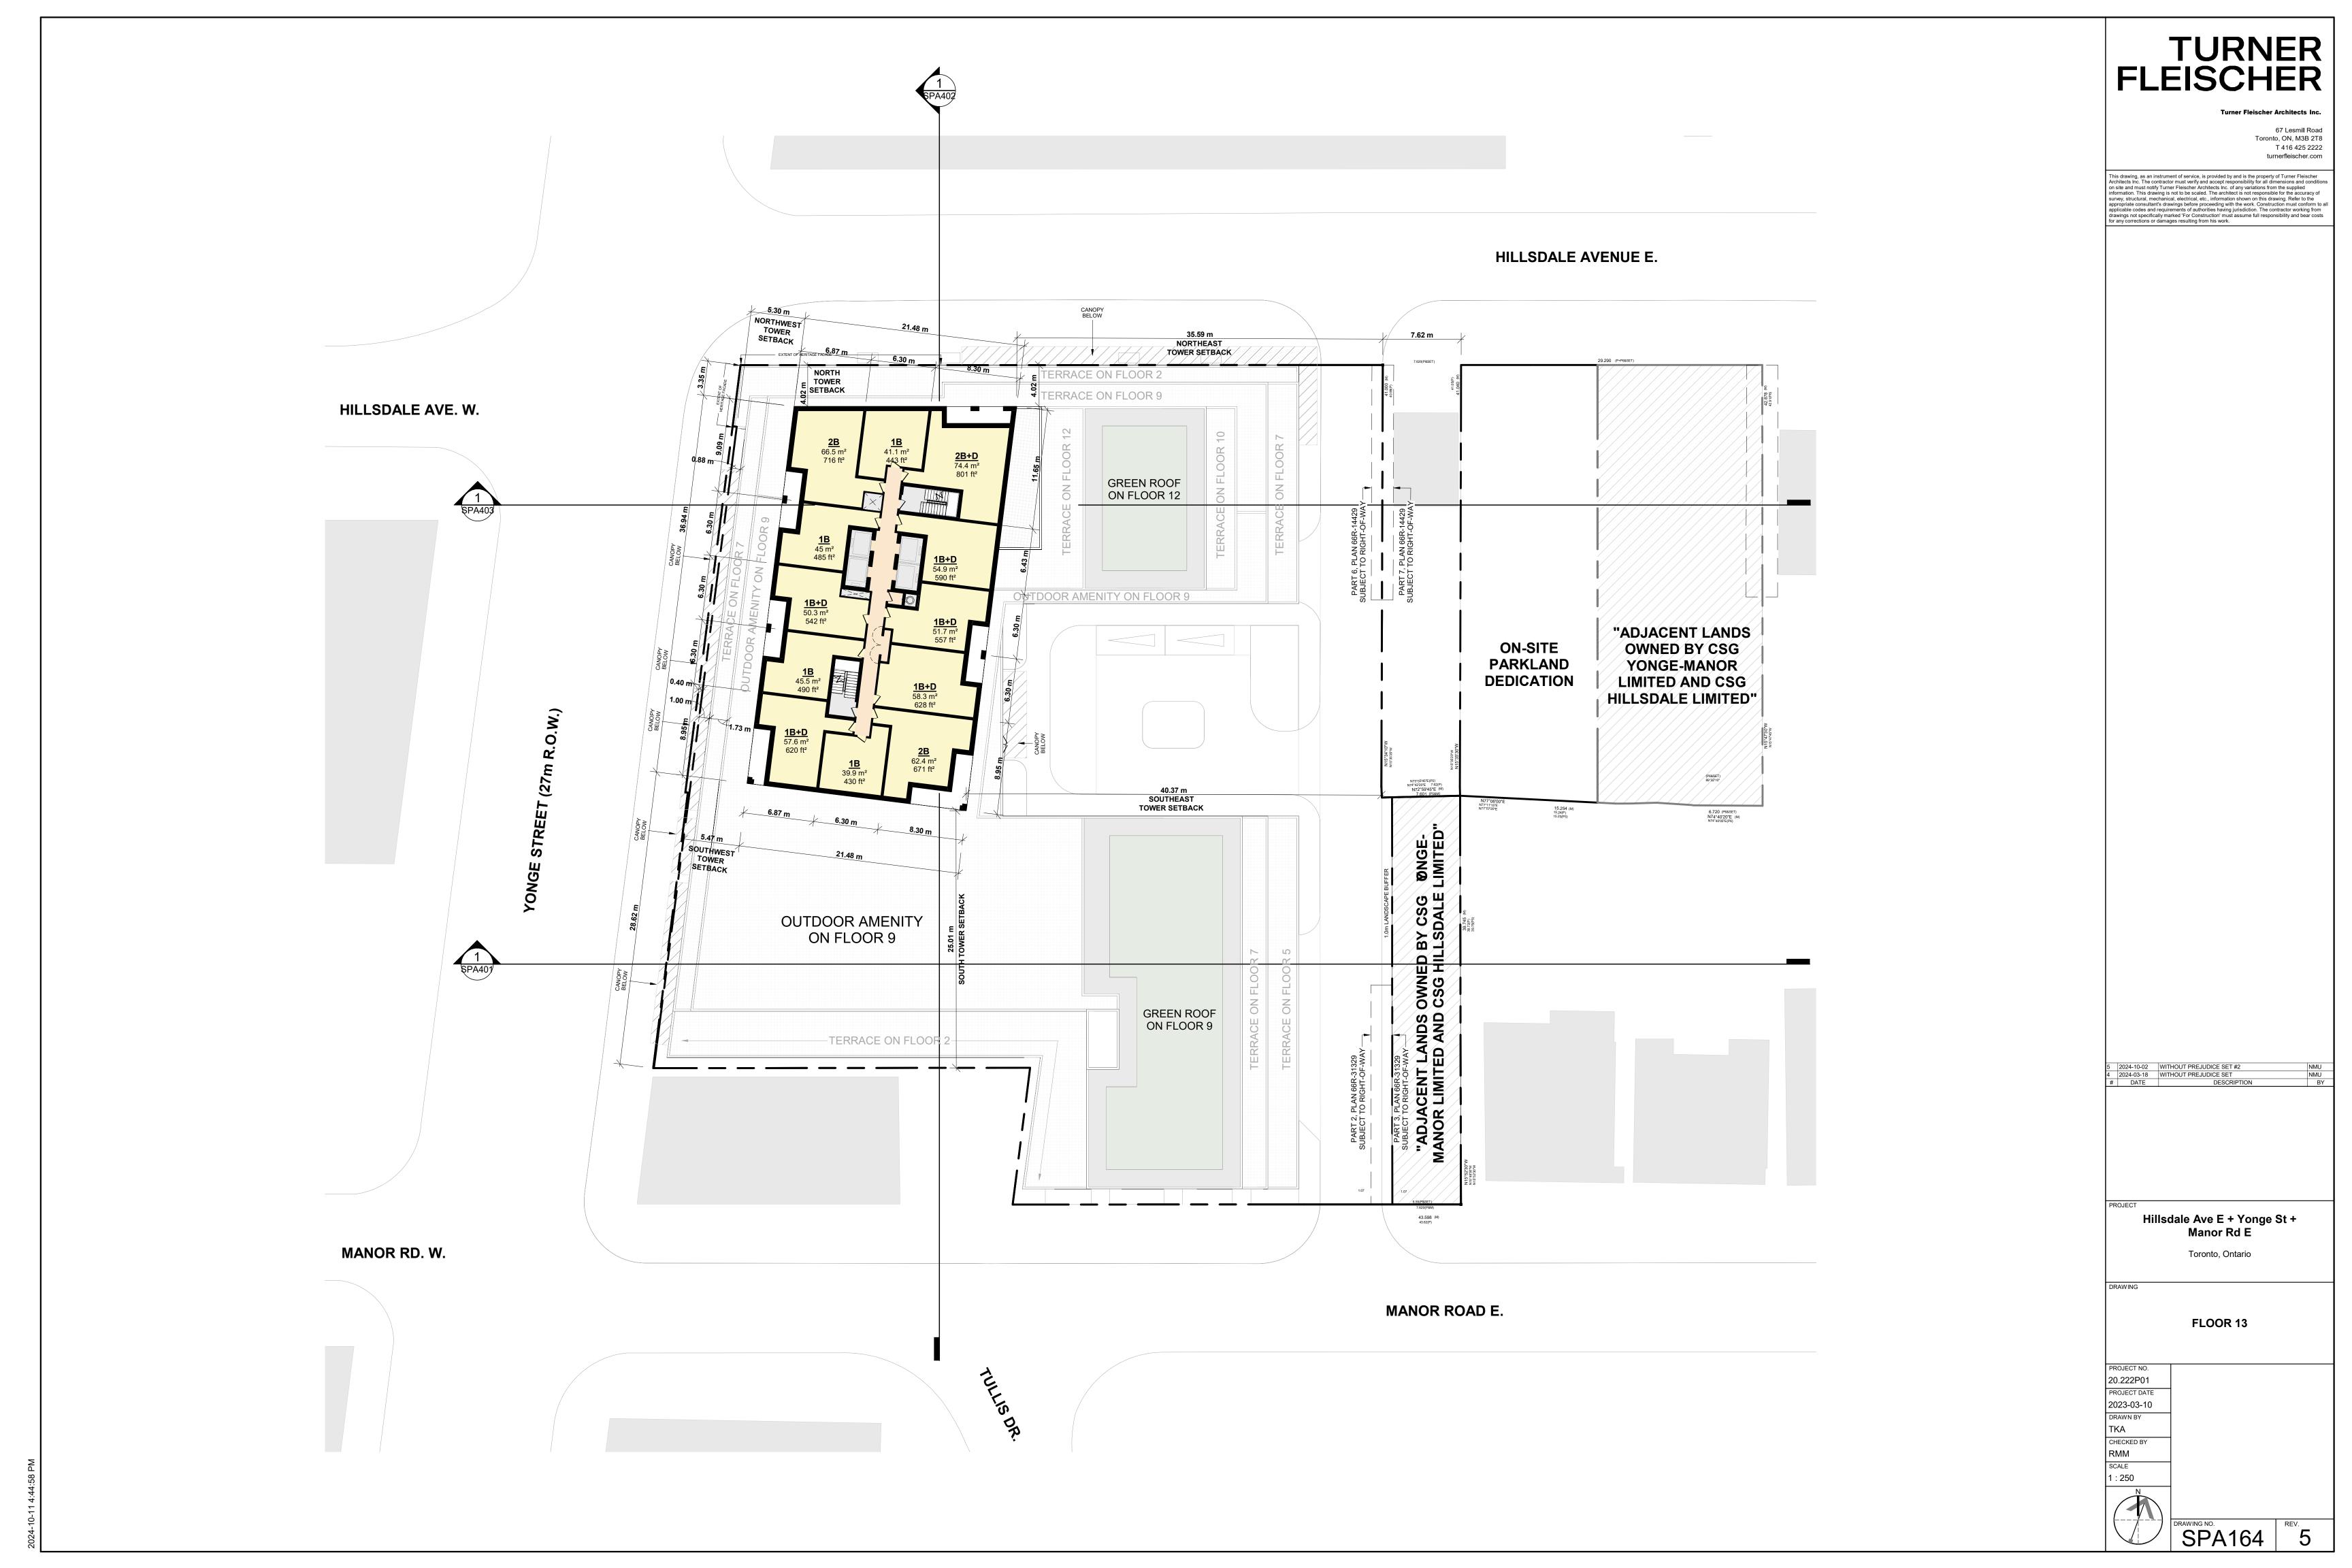

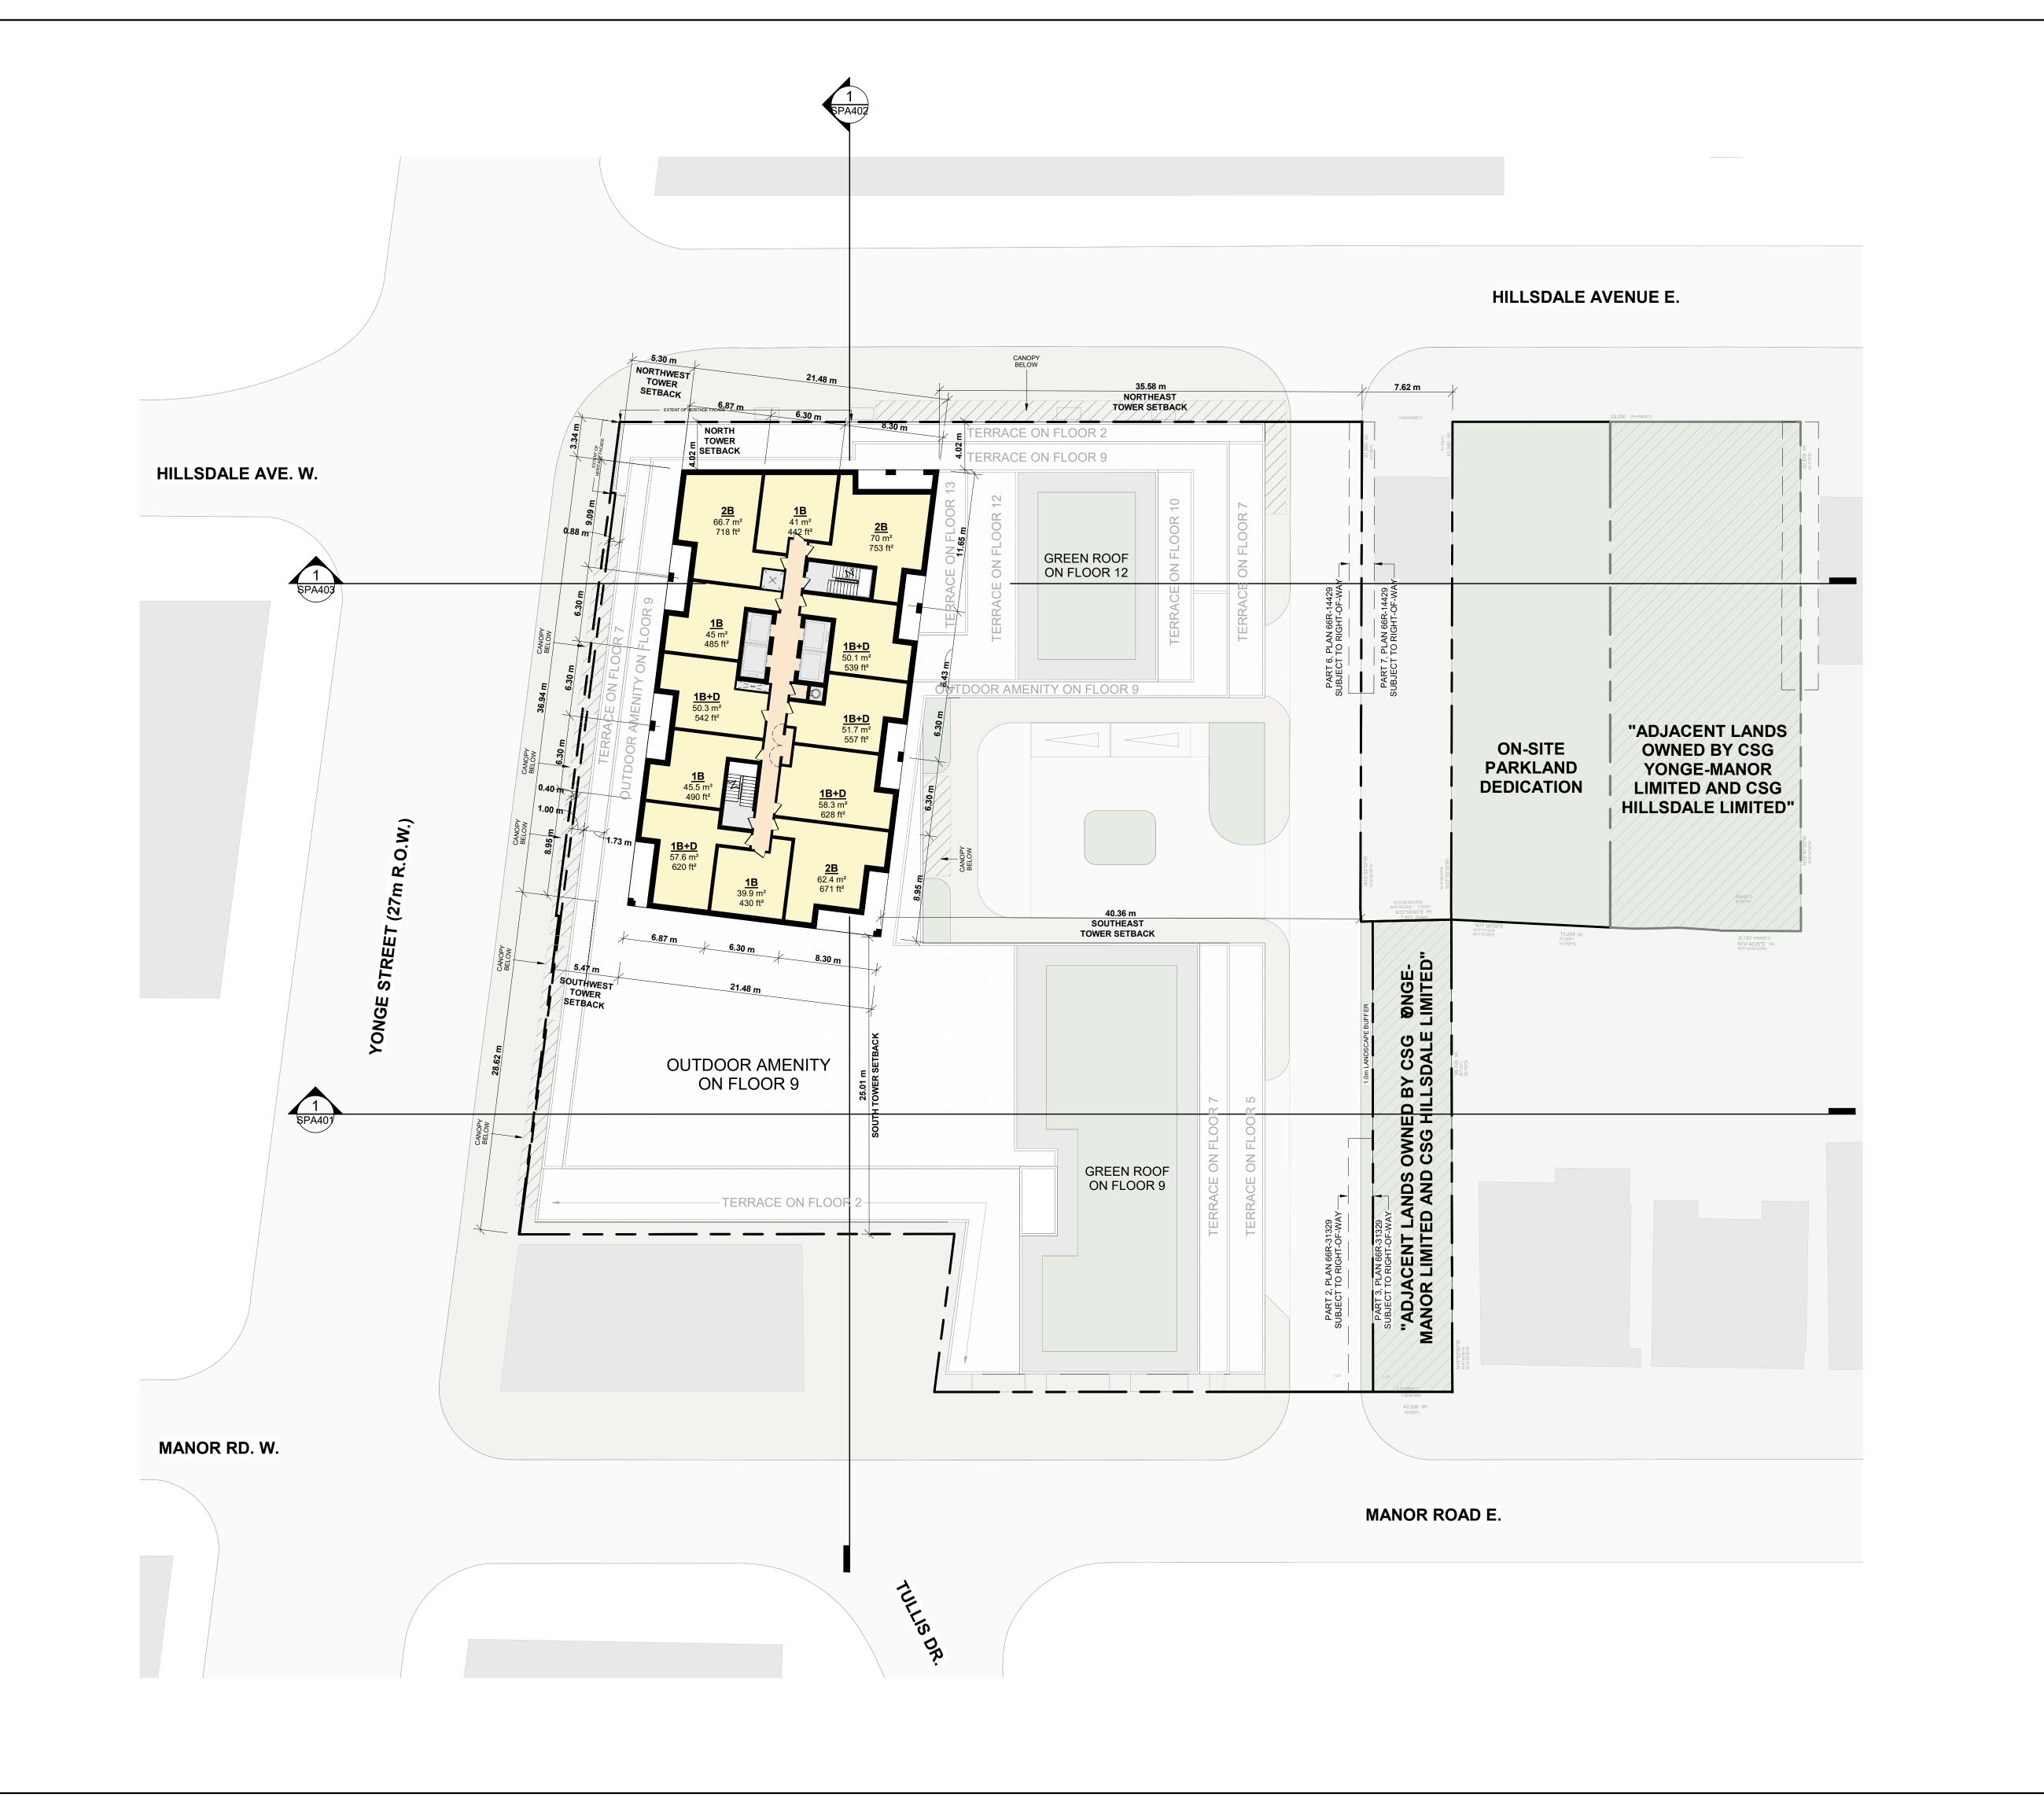

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 5
 2024-10-02
 WITHOUT PREJUDICE SET #2
 NMU

 4
 2024-03-18
 WITHOUT PREJUDICE SET
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 2023-11-08
 REZONING RESUBMISSION
 NMU

 1
 2023-08-15
 ISSUED FOR REZONING
 NMU

 #
 DATE
 DESCRIPTION
 BY

Hillsdale Ave E + Yonge St +
Manor Rd E


Toronto, Ontario

FLOOR 14 - 26 (TYP TOWER)

PROJECT NO.
20.222P01
PROJECT DATE
2023-03-10
DRAWN BY
NMU
CHECKED BY
RMM

DRAWING NO.

SPA165 FEV. 5

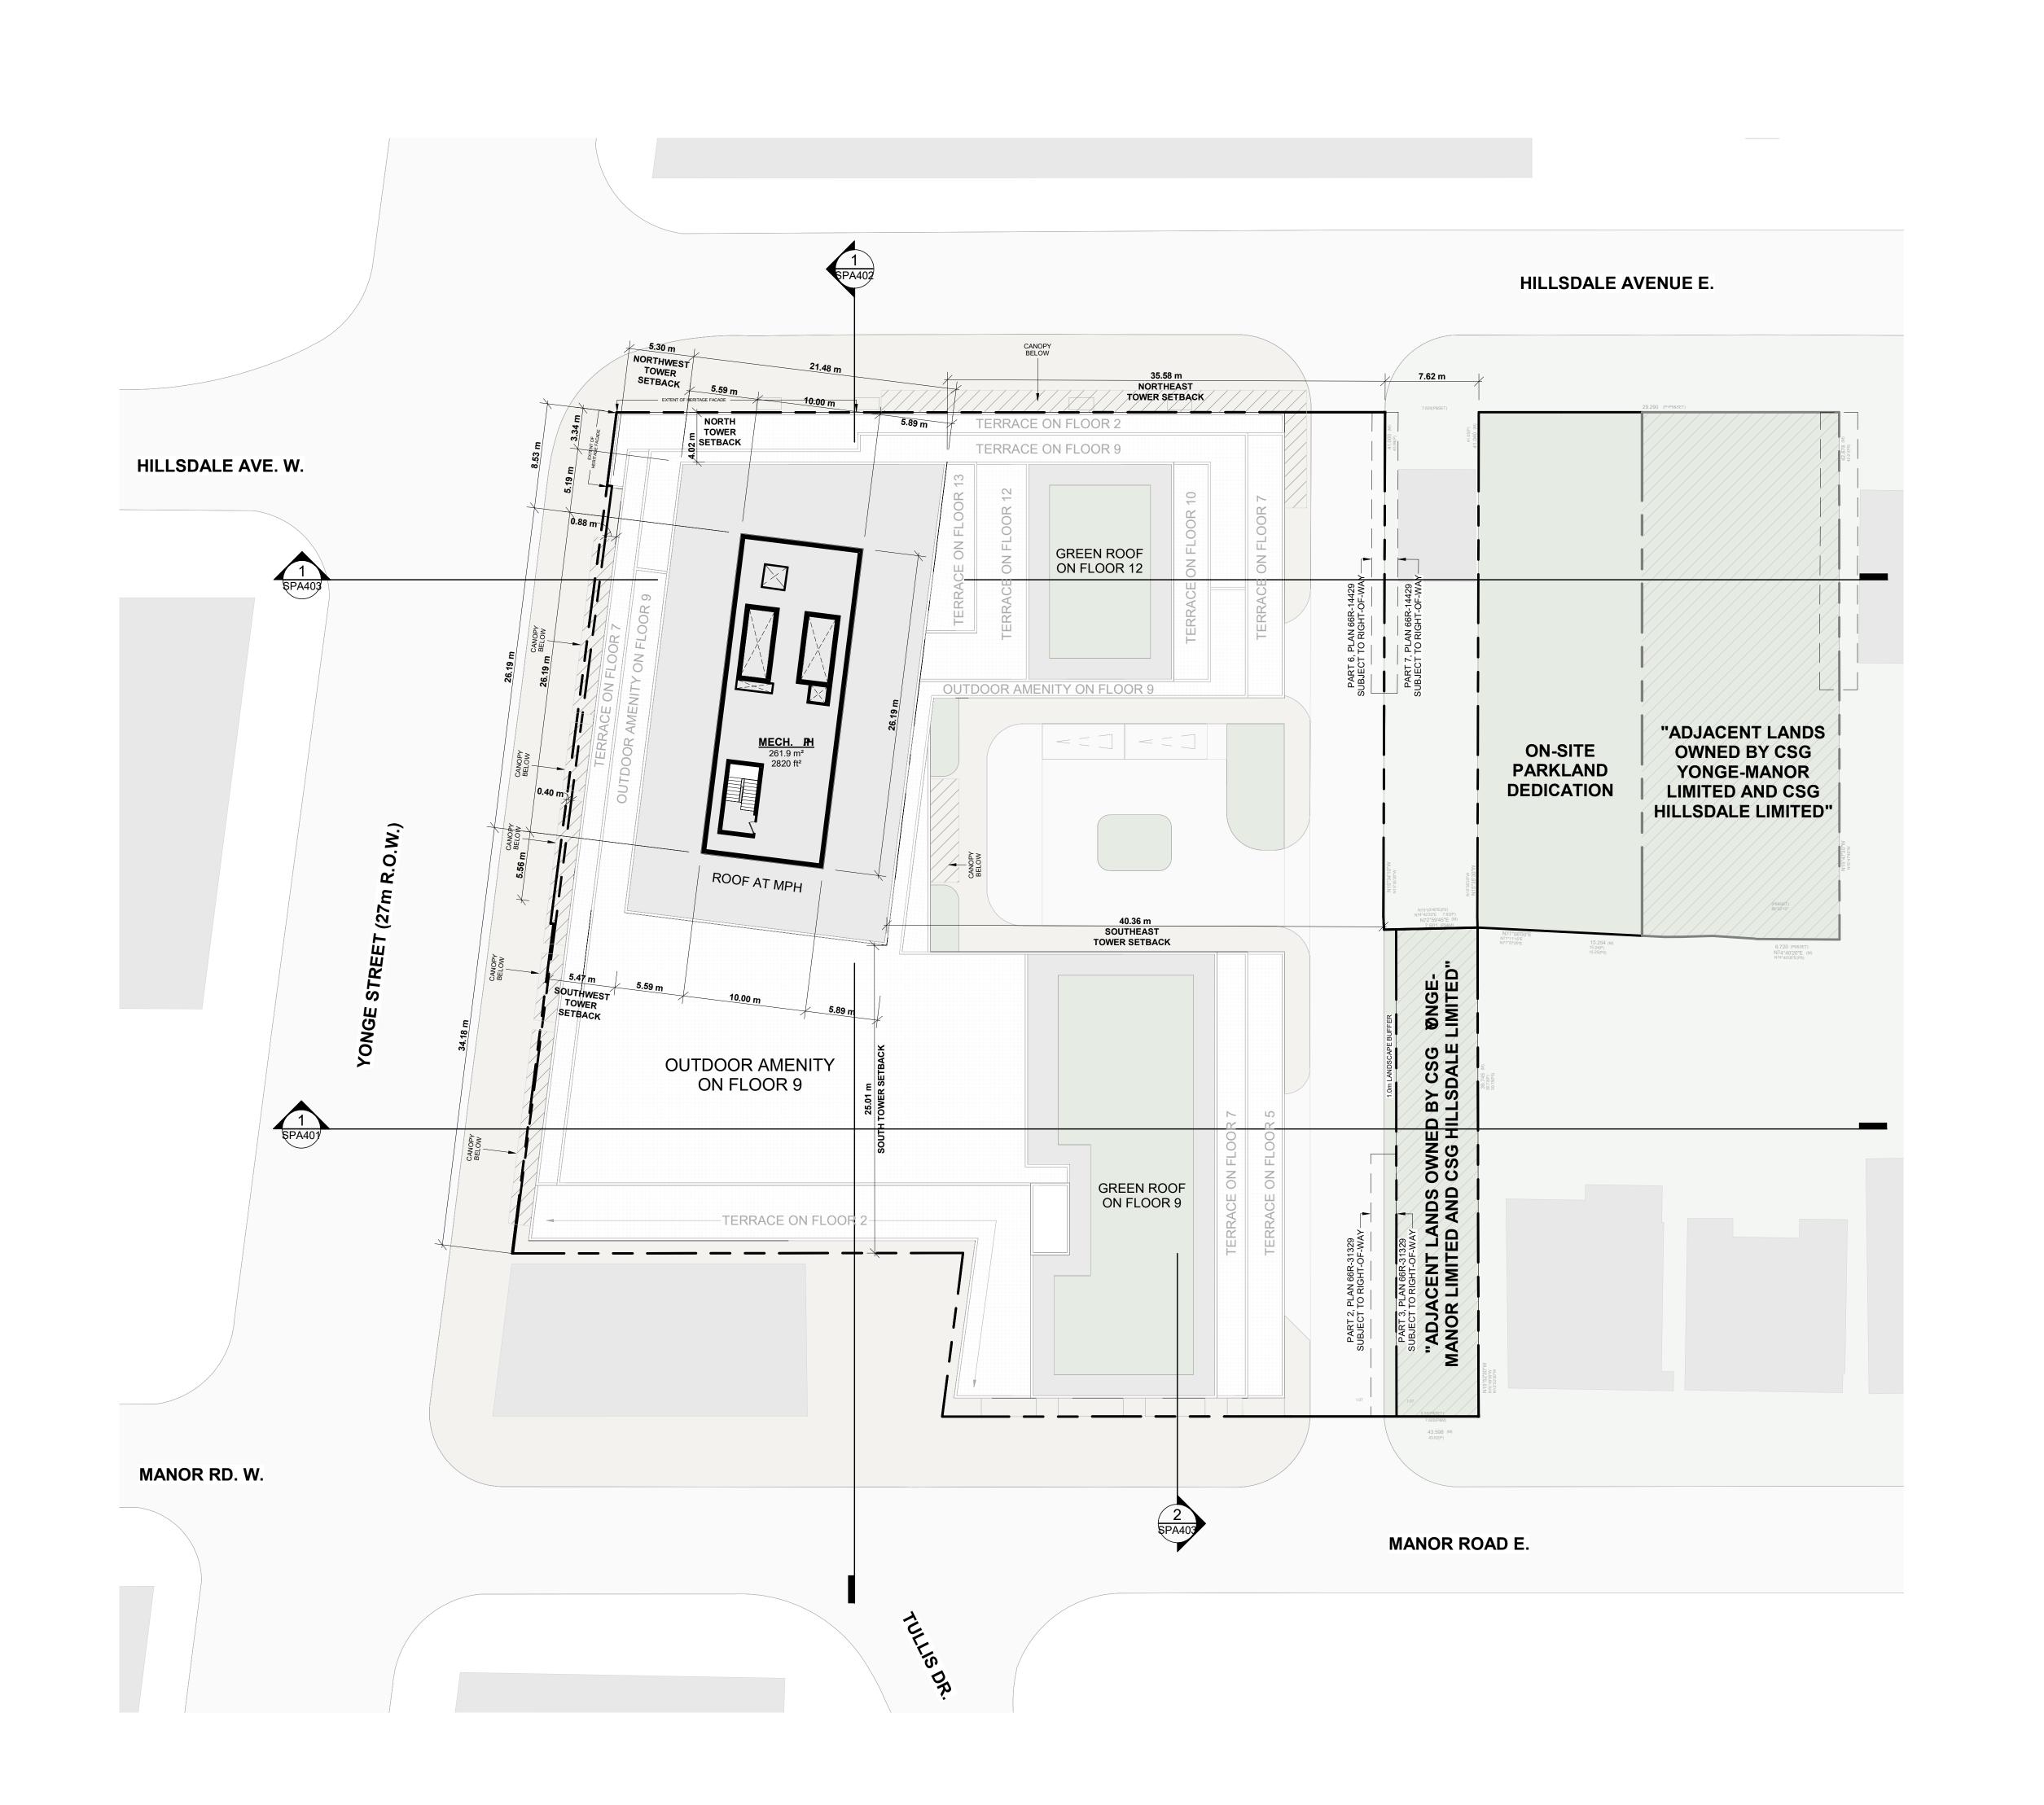

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 5
 2024-10-02
 WITHOUT PREJUDICE SET #2
 NMU

 4
 2024-03-18
 WITHOUT PREJUDICE SET
 NMU

 2
 2023-11-08
 REZONING RESUBMISSION
 NMU

 1
 2023-08-15
 ISSUED FOR REZONING
 NMU

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 DATE
 DESCRIPTION
 BY

Hillsdale Ave E + Yonge St +
Manor Rd E


MECHANICAL PENTHOUSE

Toronto, Ontario


PROJECT NO.
20.222P01
PROJECT DATE
2023-03-10
DRAWN BY
NMU
CHECKED BY
RMM
SCALE
1: 250


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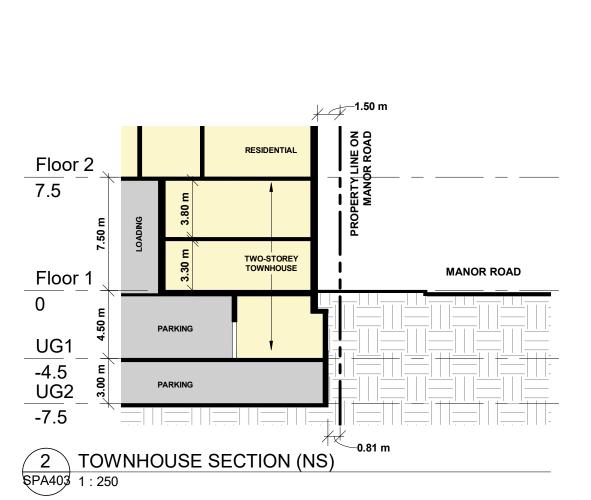
SPA166 SPA166

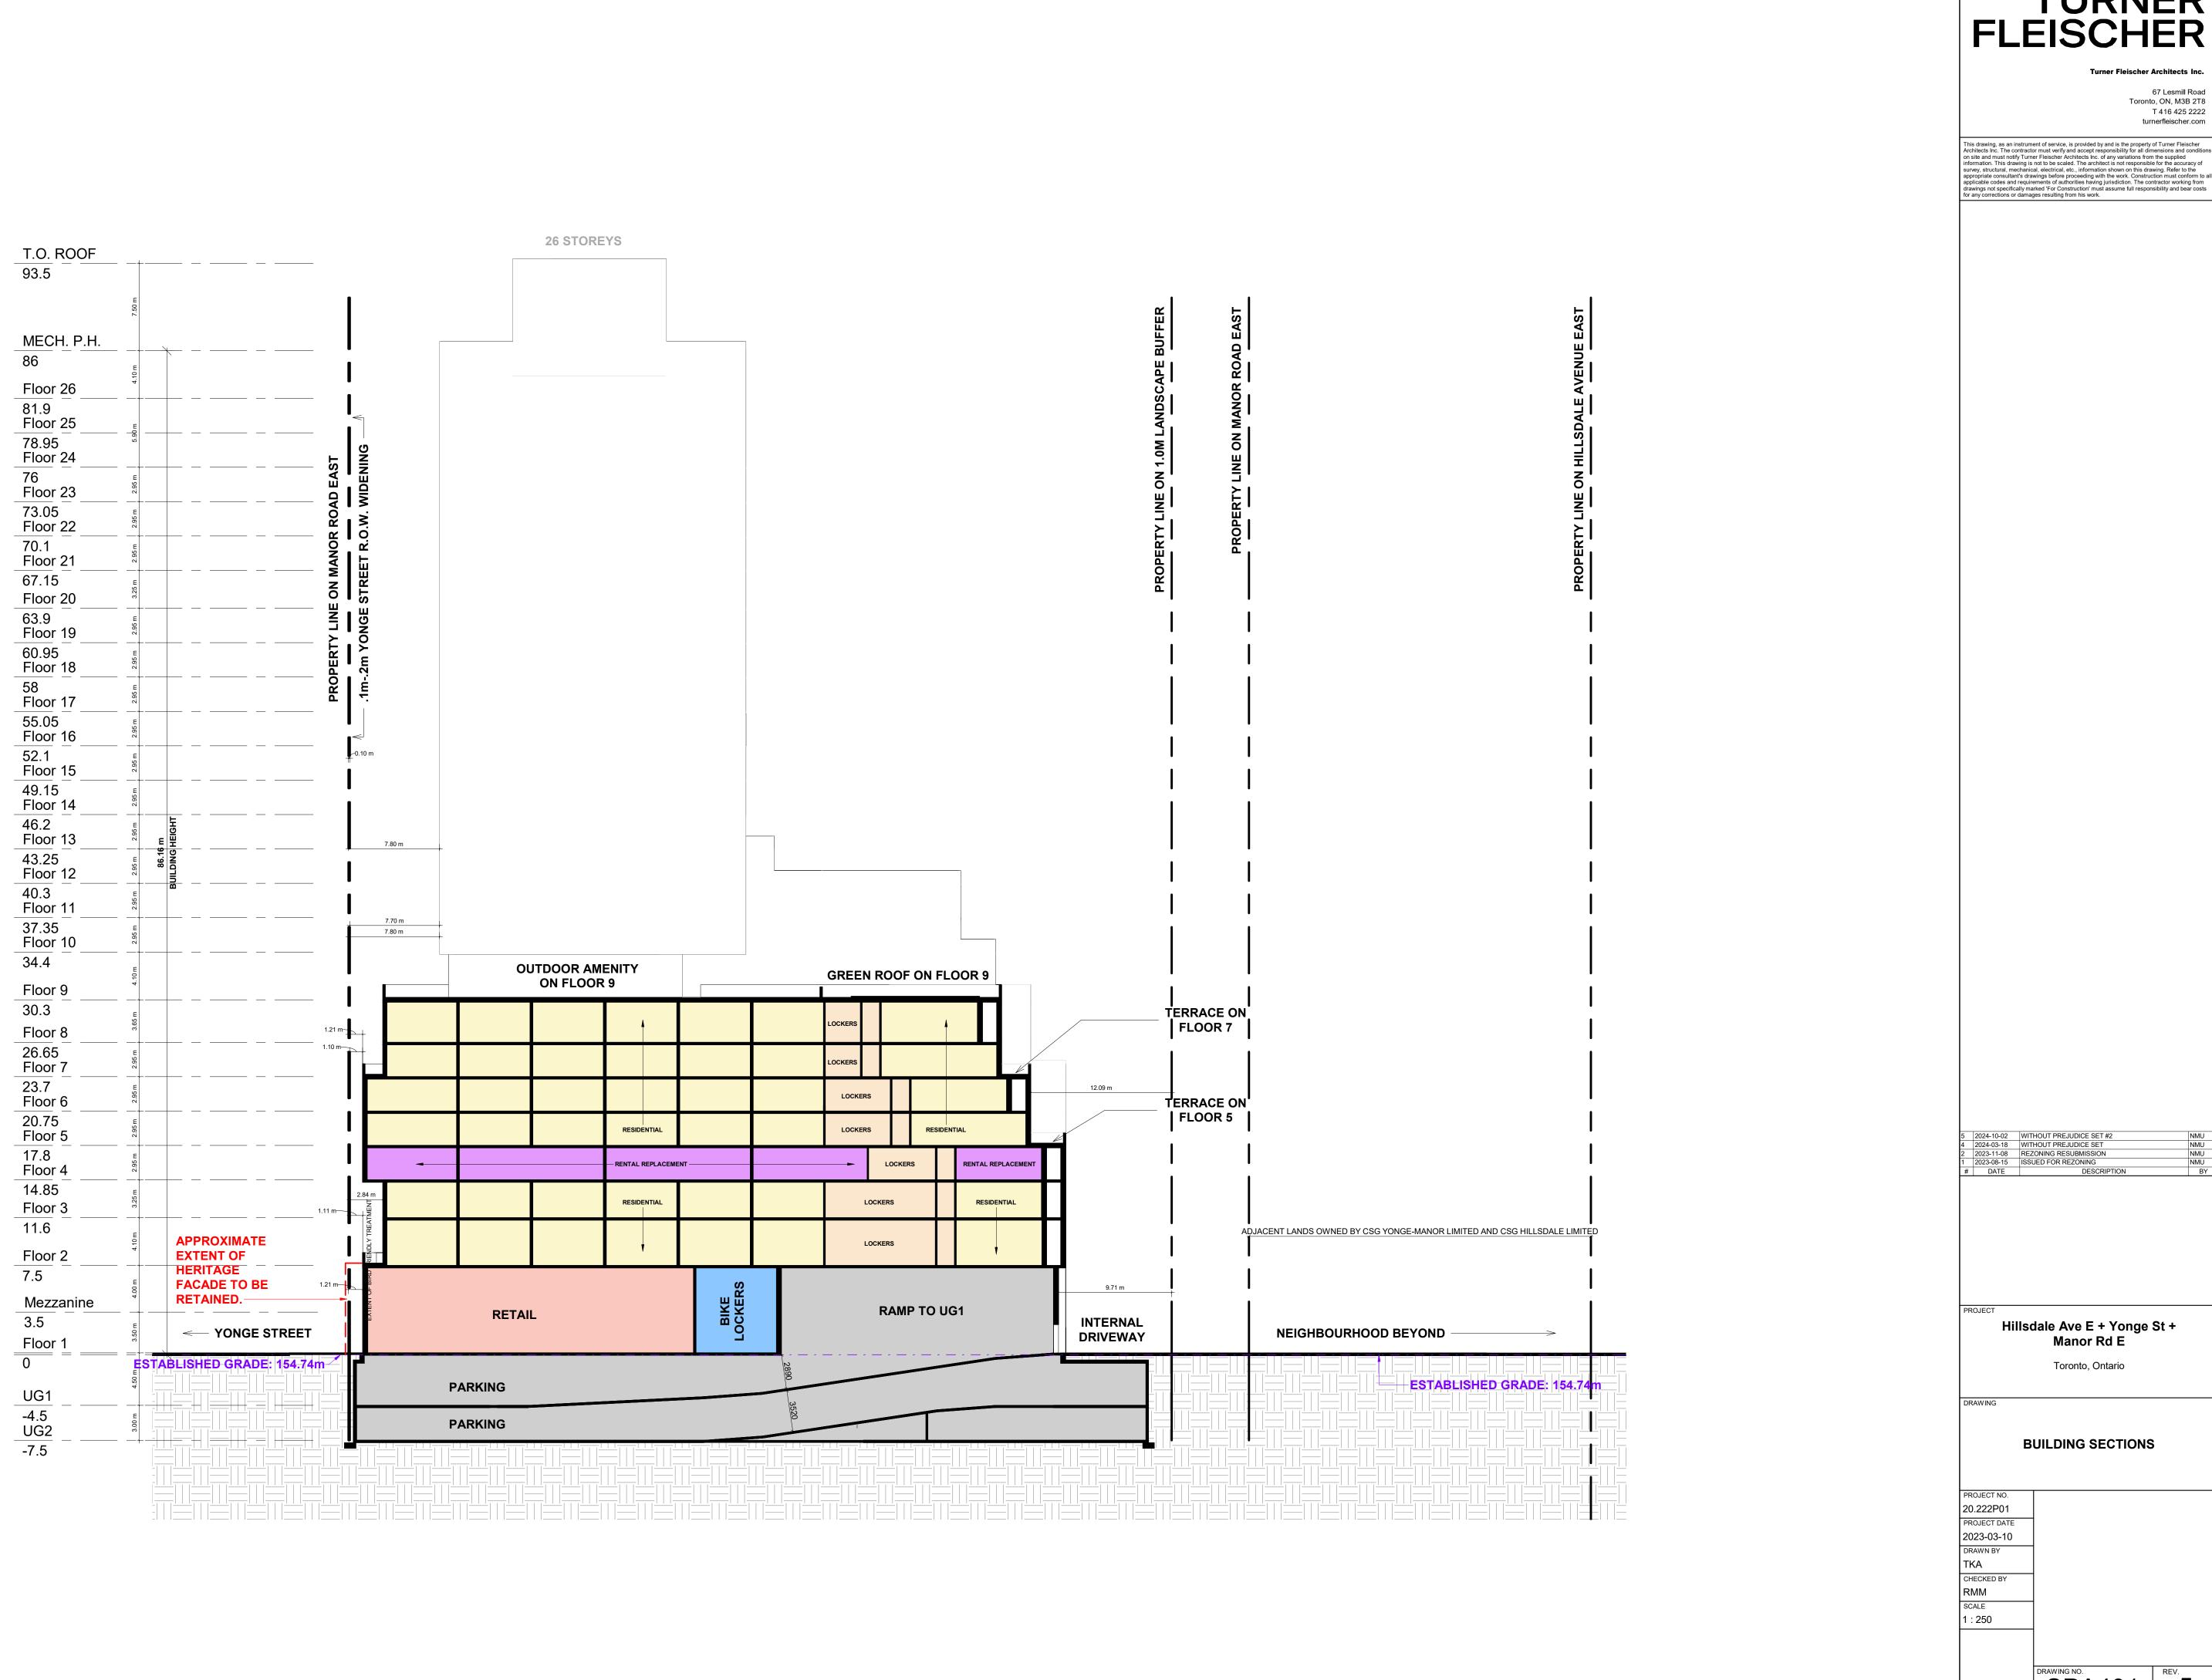

SPA401 REV.



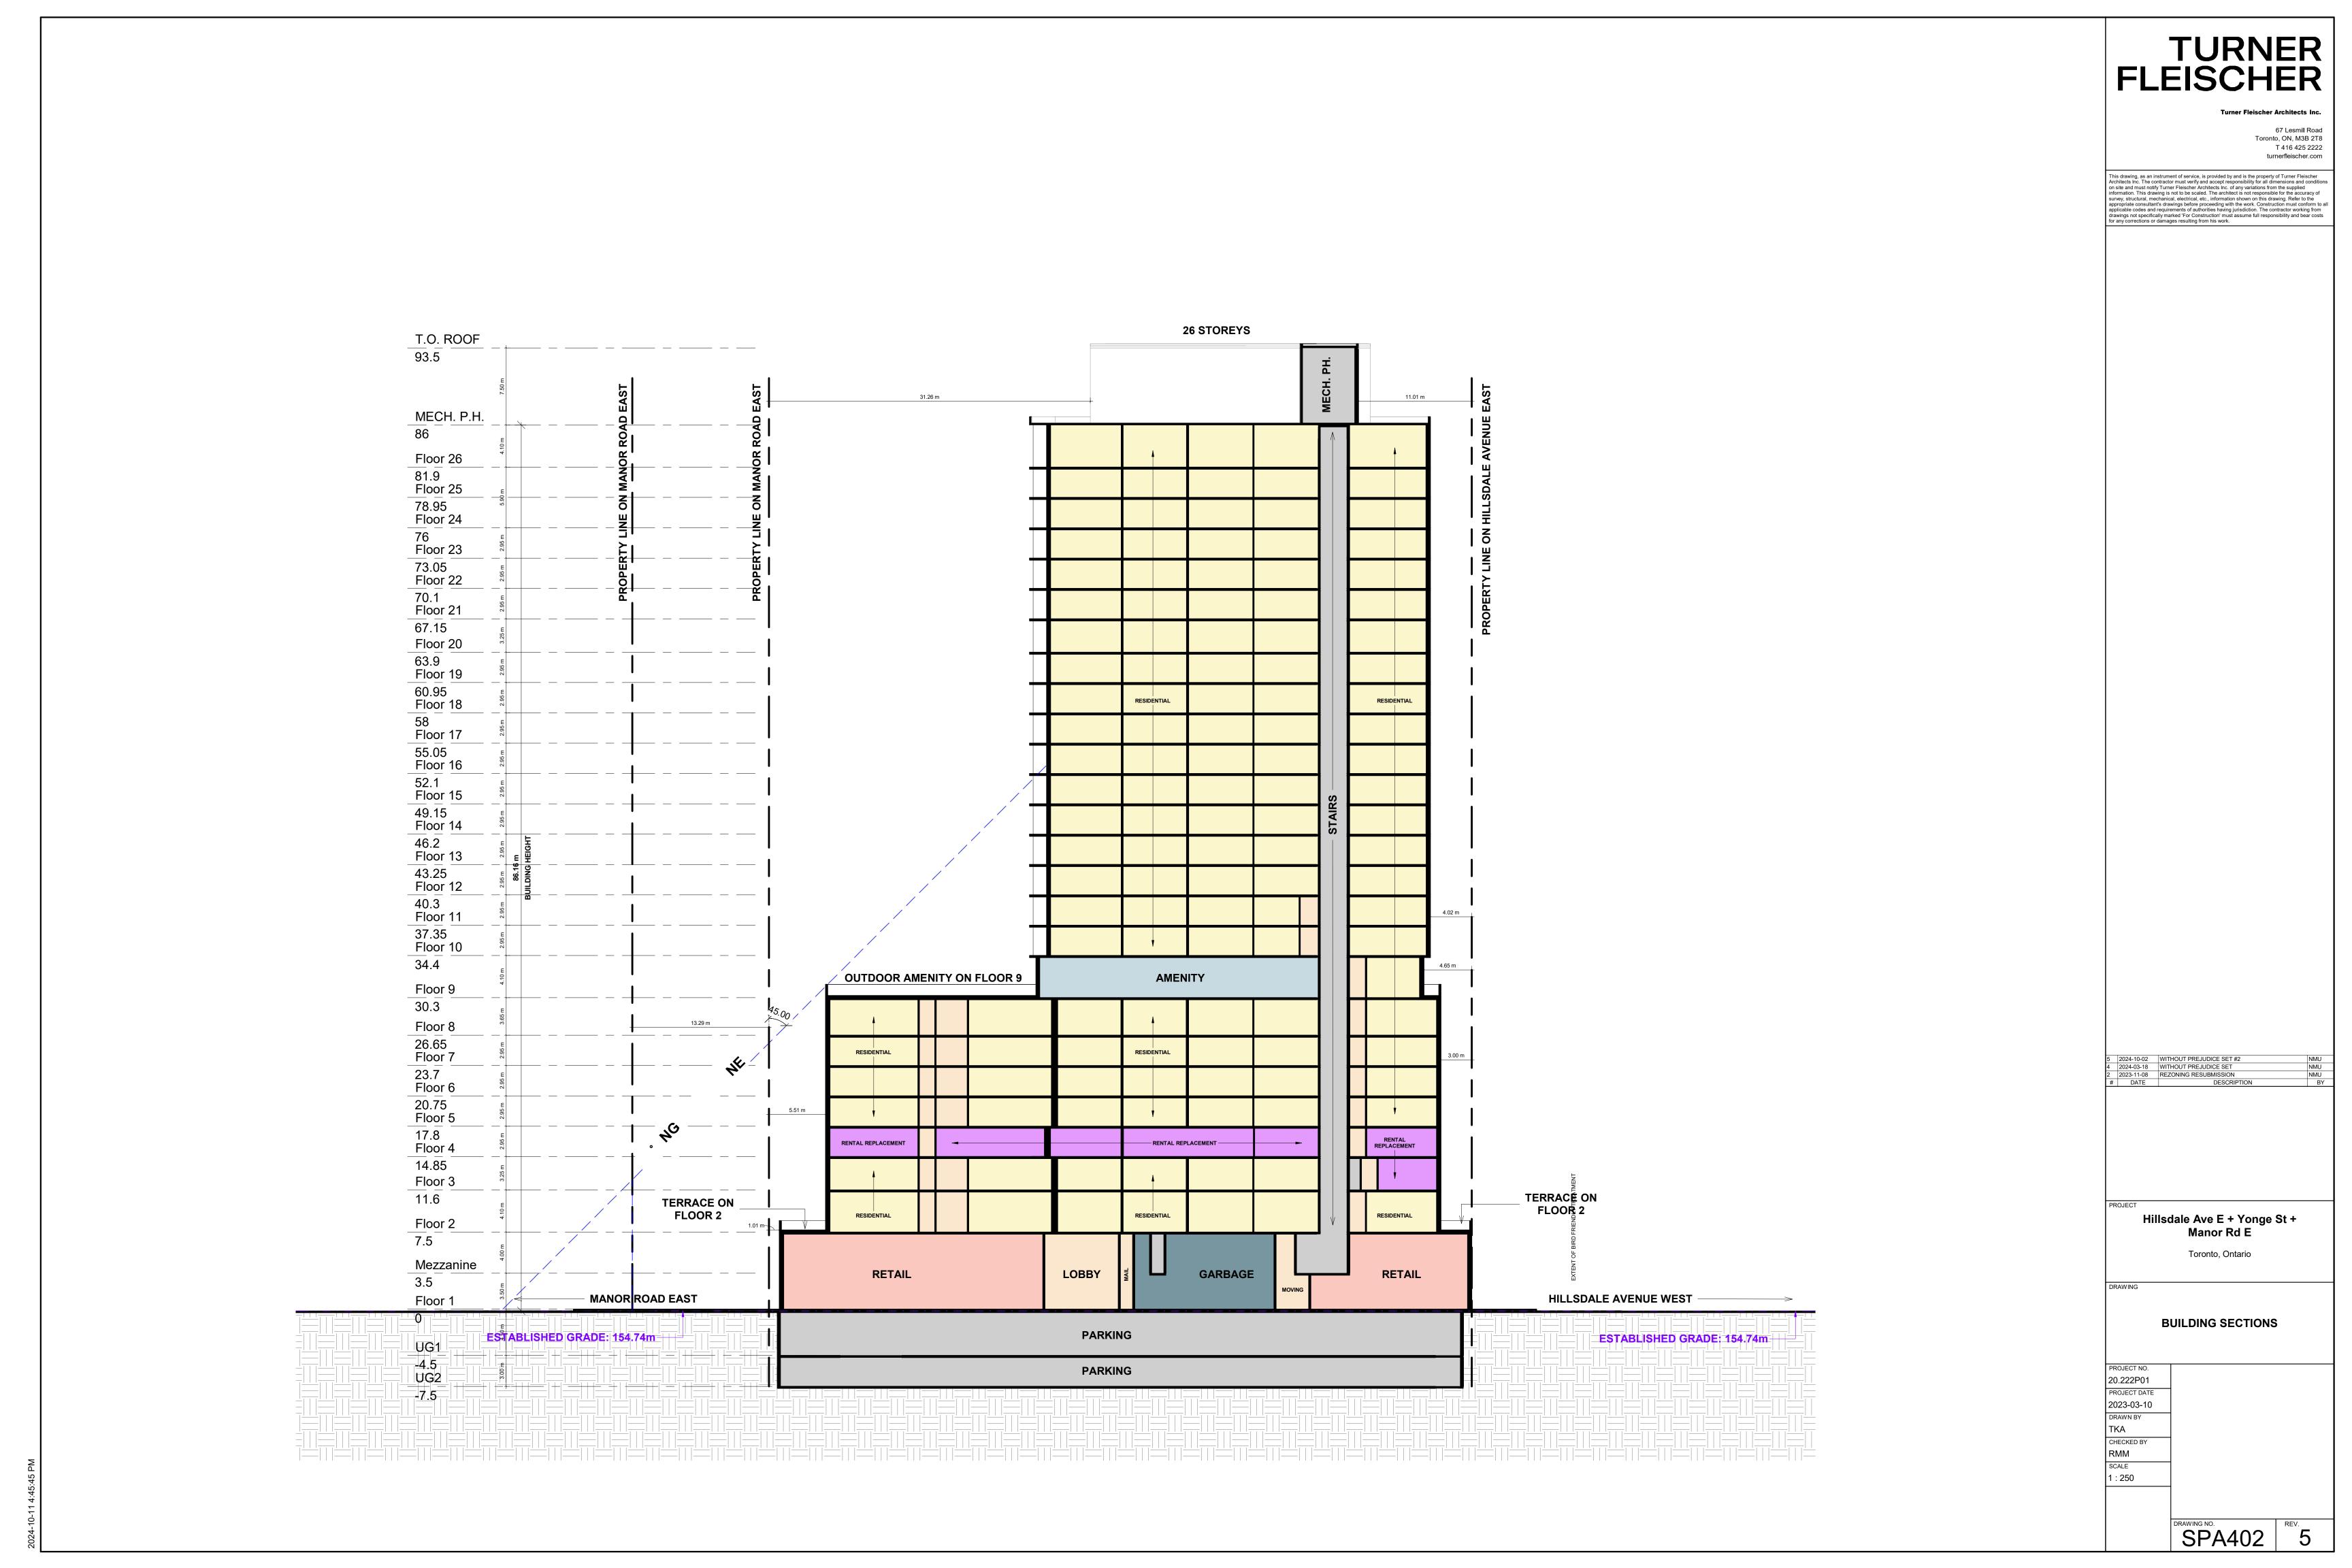

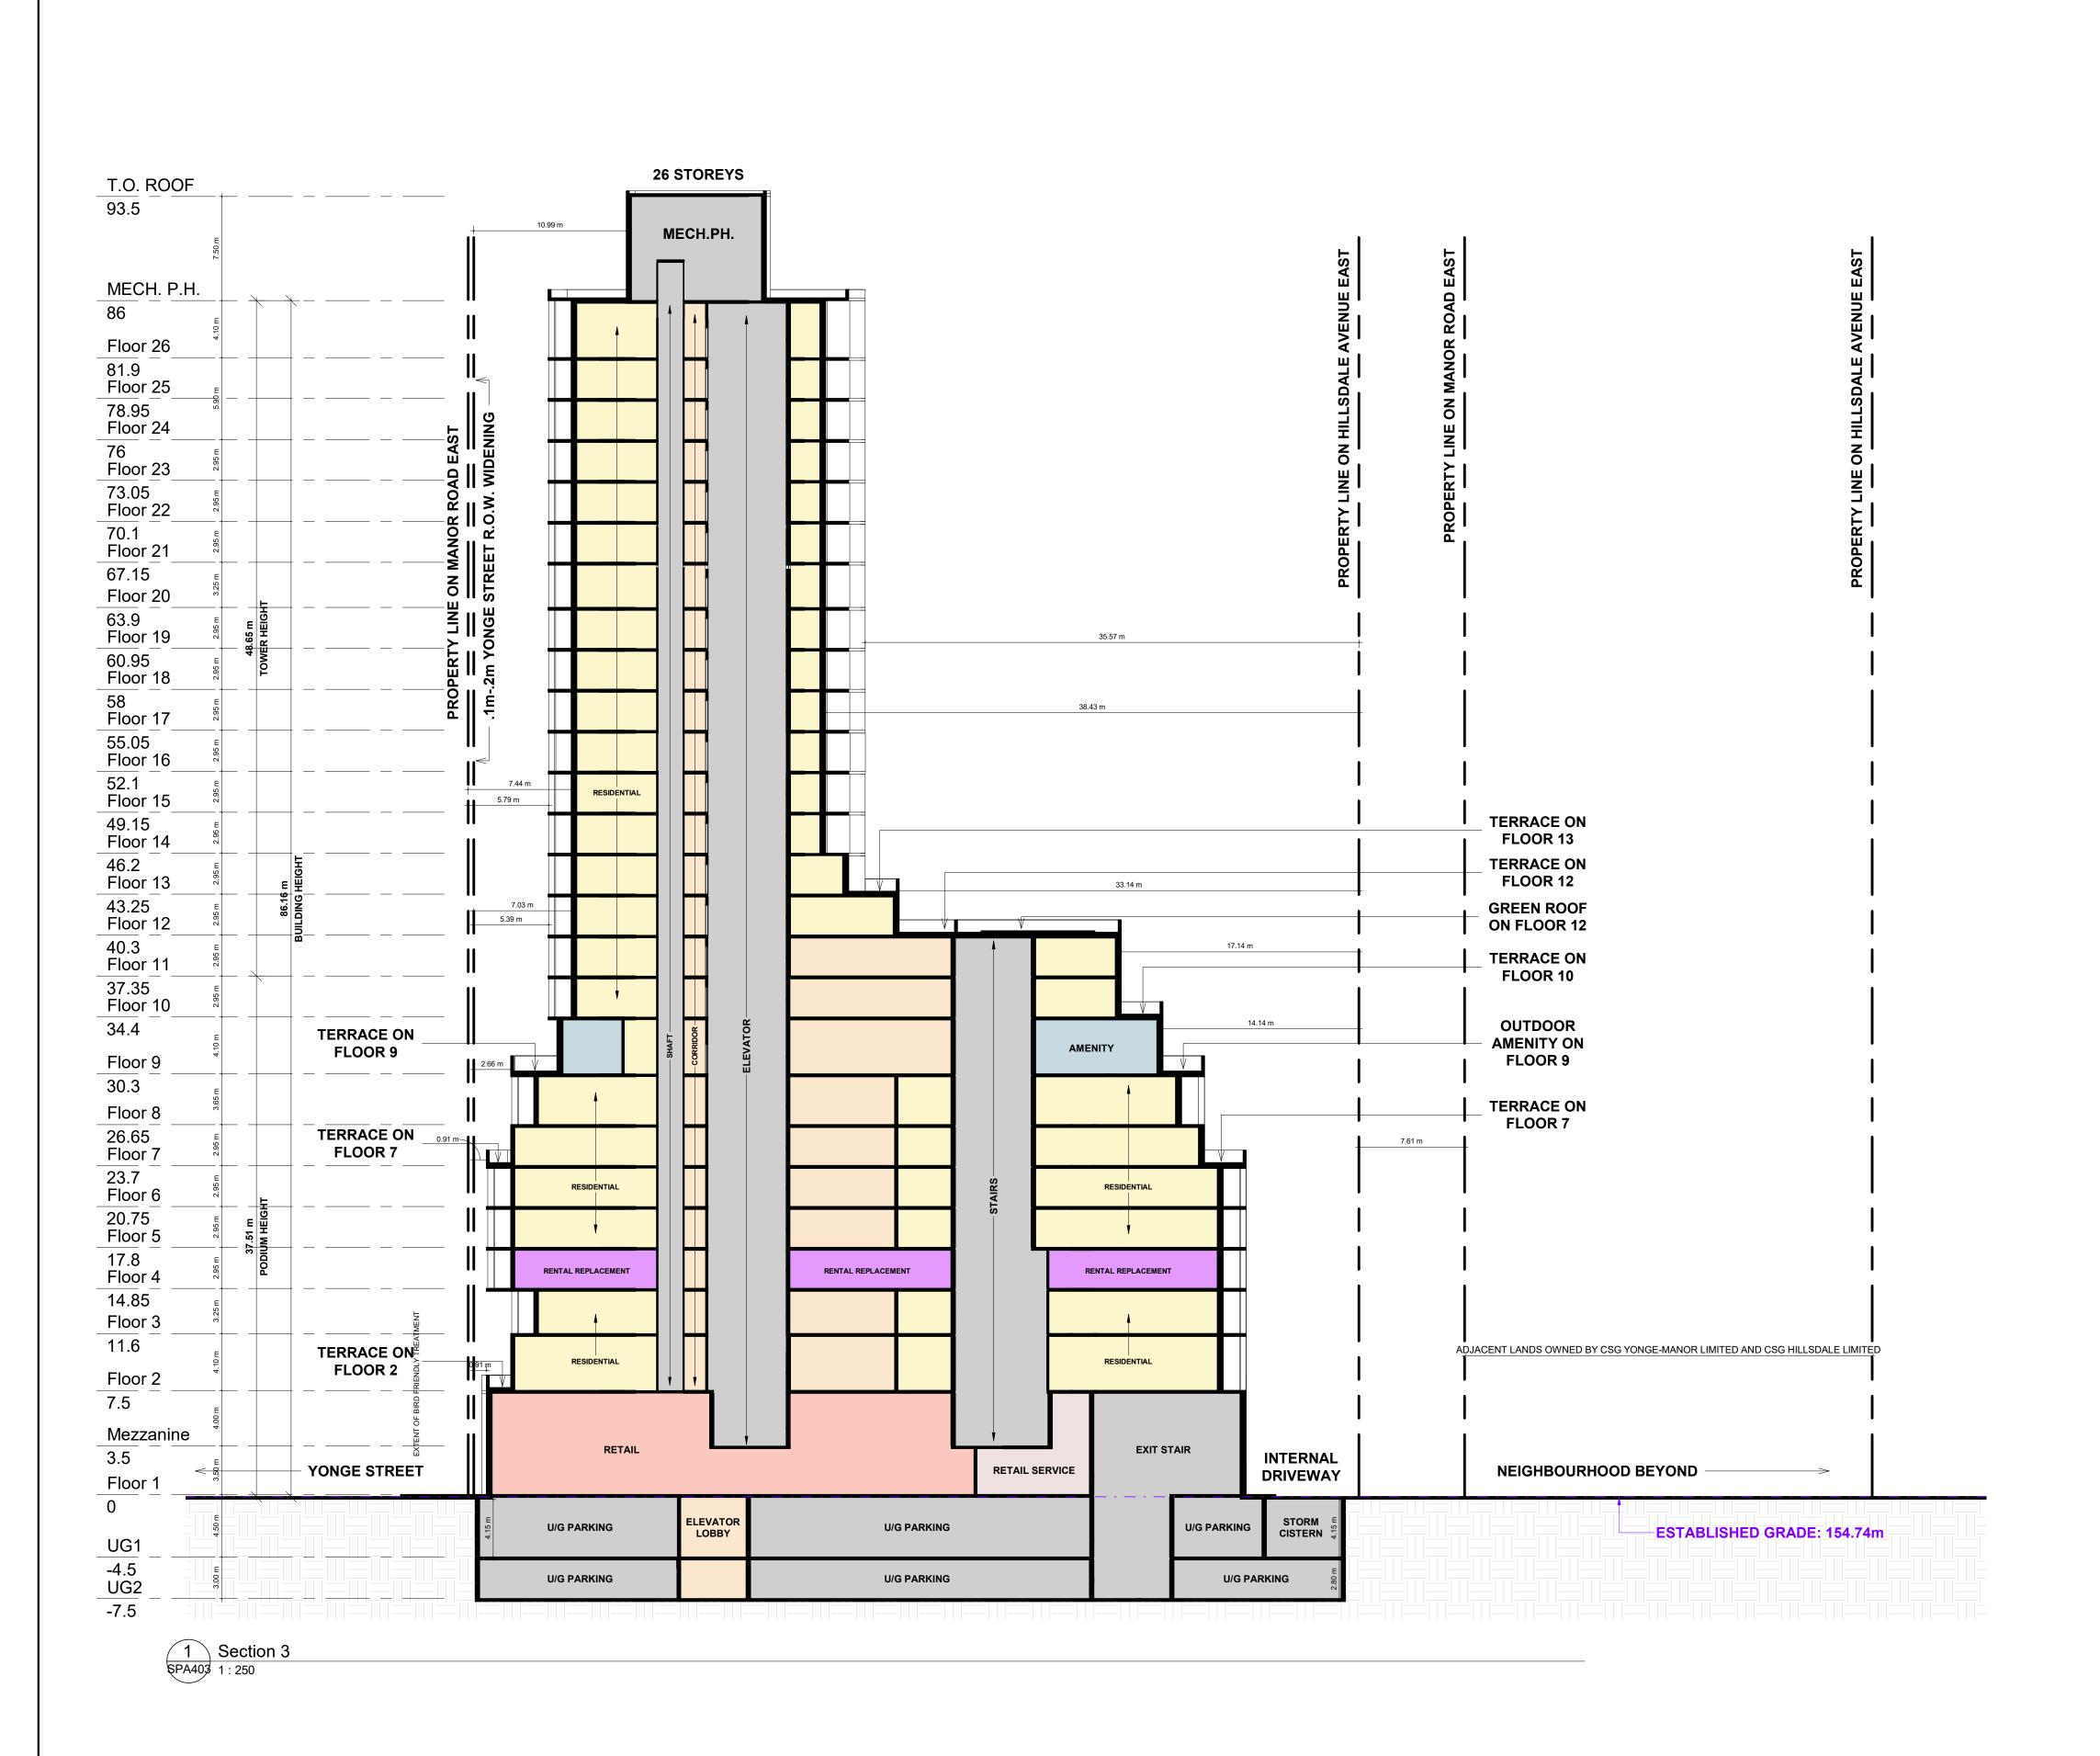

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 5
 2024-10-02
 WITHOUT PREJUDICE SET #2


 4
 2024-03-18
 WITHOUT PREJUDICE SET

 2
 2023-11-08
 REZONING RESUBMISSION

 #
 DATE
 DESCRIPTION
 Hillsdale Ave E + Yonge St + Manor Rd E Toronto, Ontario

BUILDING SECTIONS

PROJECT NO. 20.222P01 PROJECT DATE 2023-03-10 DRAWN BY TKA CHECKED BY RMM SCALE l : 250 SPA403 REV.

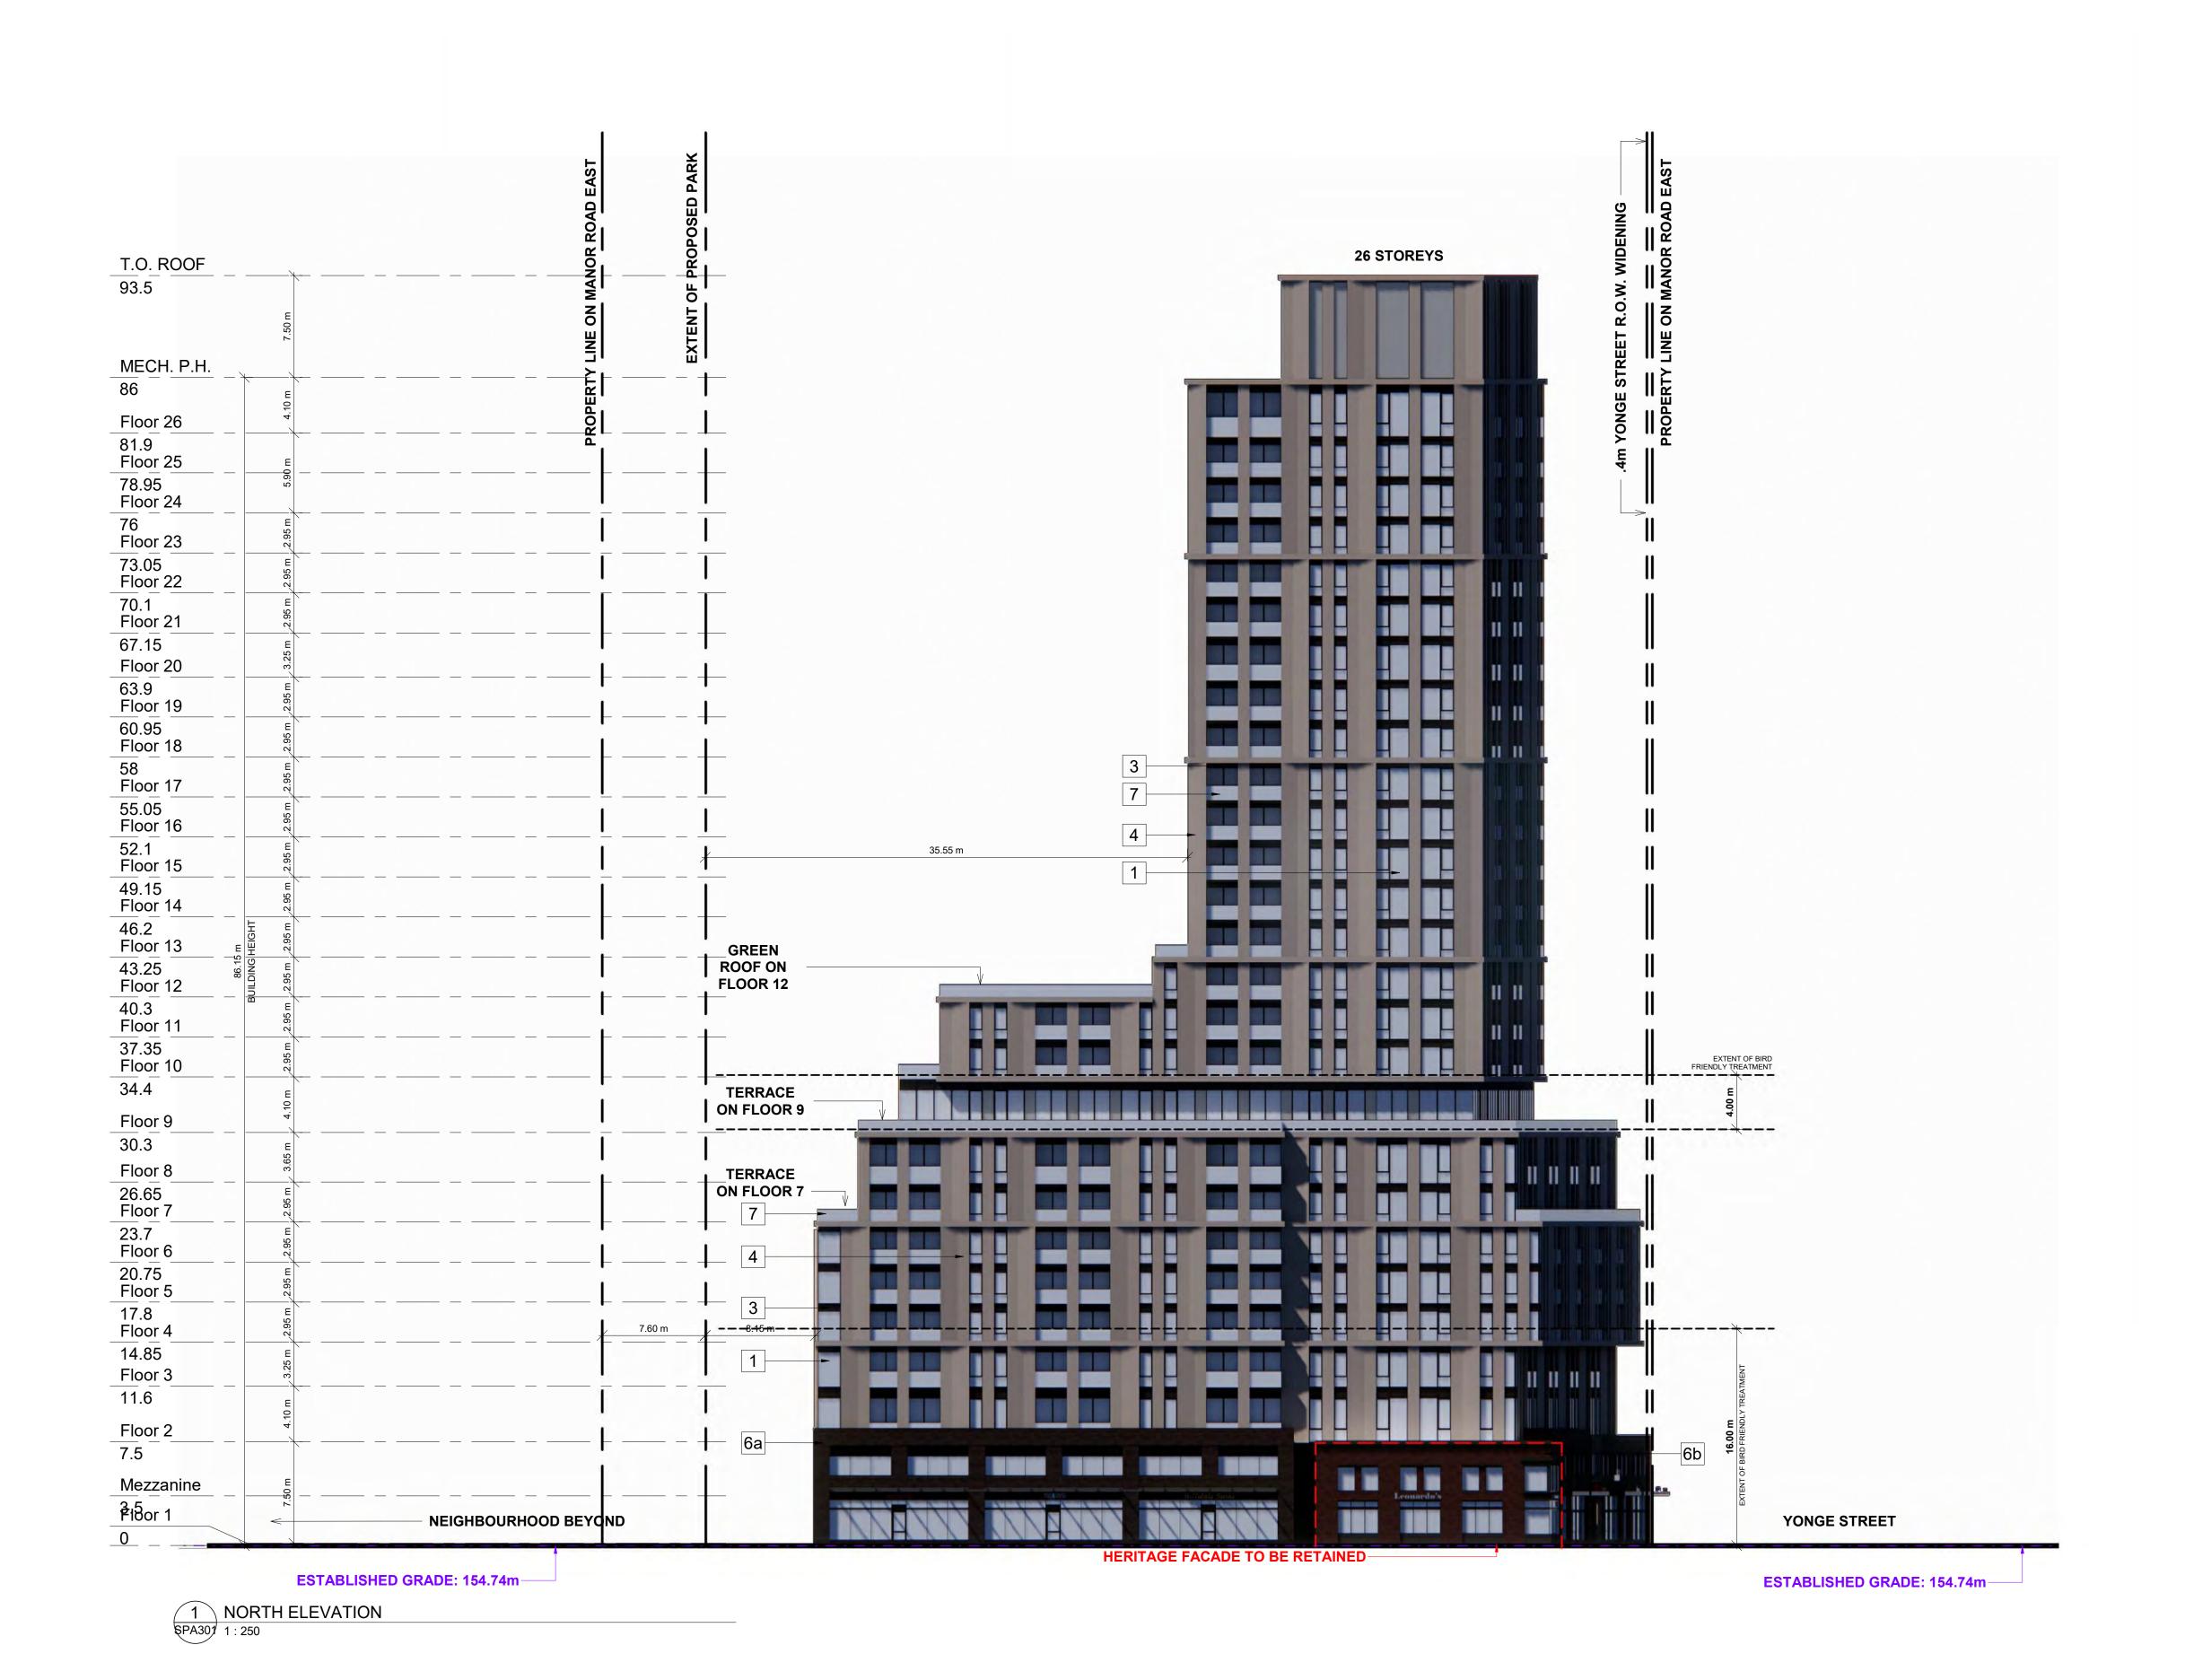

67 Lesmill Road Toronto, ON, M3B 2T8

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EXTERIOR FINISHES LEGEND

ALUMINUM WINDOW WALL GLAZING SYSTEM

1 VISION GLAZING

SPANDREL GLAZING - COLOUR (TBD)

ALUMINUM WALL LOUVER - COLOUR (TBD)

4 ALUMINUM SHEET PANEL - COLOUR (TBD)

PRECAST CONCRETE - COLOUR (TBD)

6a BRICK VENEER -COLOUR (TBD)

6b COLOUR (TBD) BRICK VENEER -

6c BRICK VENEER -COLOUR (TBD)


7 GLASS RAILING

BIRD FRIENDLY GUIDELINE

GENERAL NOTES IN ACCORDANCE WITH THE BIRD-FRIENDLY DEVELOPMENT GUIDELINES (FIRST 16 METERS ABOVE GRADE AND 4 METERS ABOVE GREEN FEATURE):

PROVISION OF VISUAL MARKERS
VISUAL MARKERS TO ALERT BIRDS WILL BE PROVIDED.
INCREASING THE SOLID TO GLASS RATIO OF GLAZING BY
PROVIDING A TIGHTER GLAZING GRID IS ONE METHOD
CONSIDERED, OTHERS ARE:
- APPLICATION OF FILM AND DECALS TO THE GLASS
-MUTTING REFECTIONS IN THE GLASS THOUGH THE
USE OF INTERNAL SCREENS PLACED CLOSE TO THE
GLASS SURFACE.
- CANOPIES LOCATED ALONG THE BUILDING FACADE TO
PROVIDE ADDITIONAL MUTING OF REFLECTED IMAGES
- USE CERAMIC FRIT PANEL GLASS FROM AGC FOR ALL
VISION GLASS ON LEVEL 1 & 2

REDUCTION OF LIGHT POLLUTION
- REDUCTION OF LIGHT POLLUTION FROM INTERIOR
LIGHTS, PARTICULARLY DURING MIGRATION PERIODS.
- SELECTION OF APPROPRIATE EXTERNAL LIGHTING
FIXTURES TO ELIMINATE DIRECT UPWARDS LIGHT.
REDUCE SPILL LIGHT AND OPTIMIZE USEFUL LIGHT.

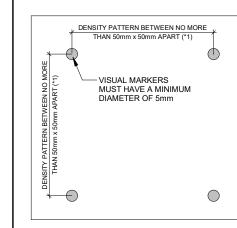

DETAIL NOTES:

1. FRITTED GLASS WILL BE TREATED WITH A DENSITY PATTERN OF VISUAL MARKERS NO MORE THAN 50mm X 50mm APART FOR THE FIRST 16M ABOVE GRADE. (TORONTO GREEN STANDARD EC4.1)


5 2024-10-02 WITHOUT PREJUDICE SET #2
2 2023-11-08 REZONING RESUBMISSION
1 2023-08-15 ISSUED FOR REZONING
DATE DESCRIPTION

Hillsdale Ave E + Yonge St + Manor Rd E

Toronto, Ontario

NORTH ELEVATION

PROJECT NO. 20.222P01 PROJECT DATE 2023-03-10 DRAWN BY NMU CHECKED BY RMM SCALE 1:200

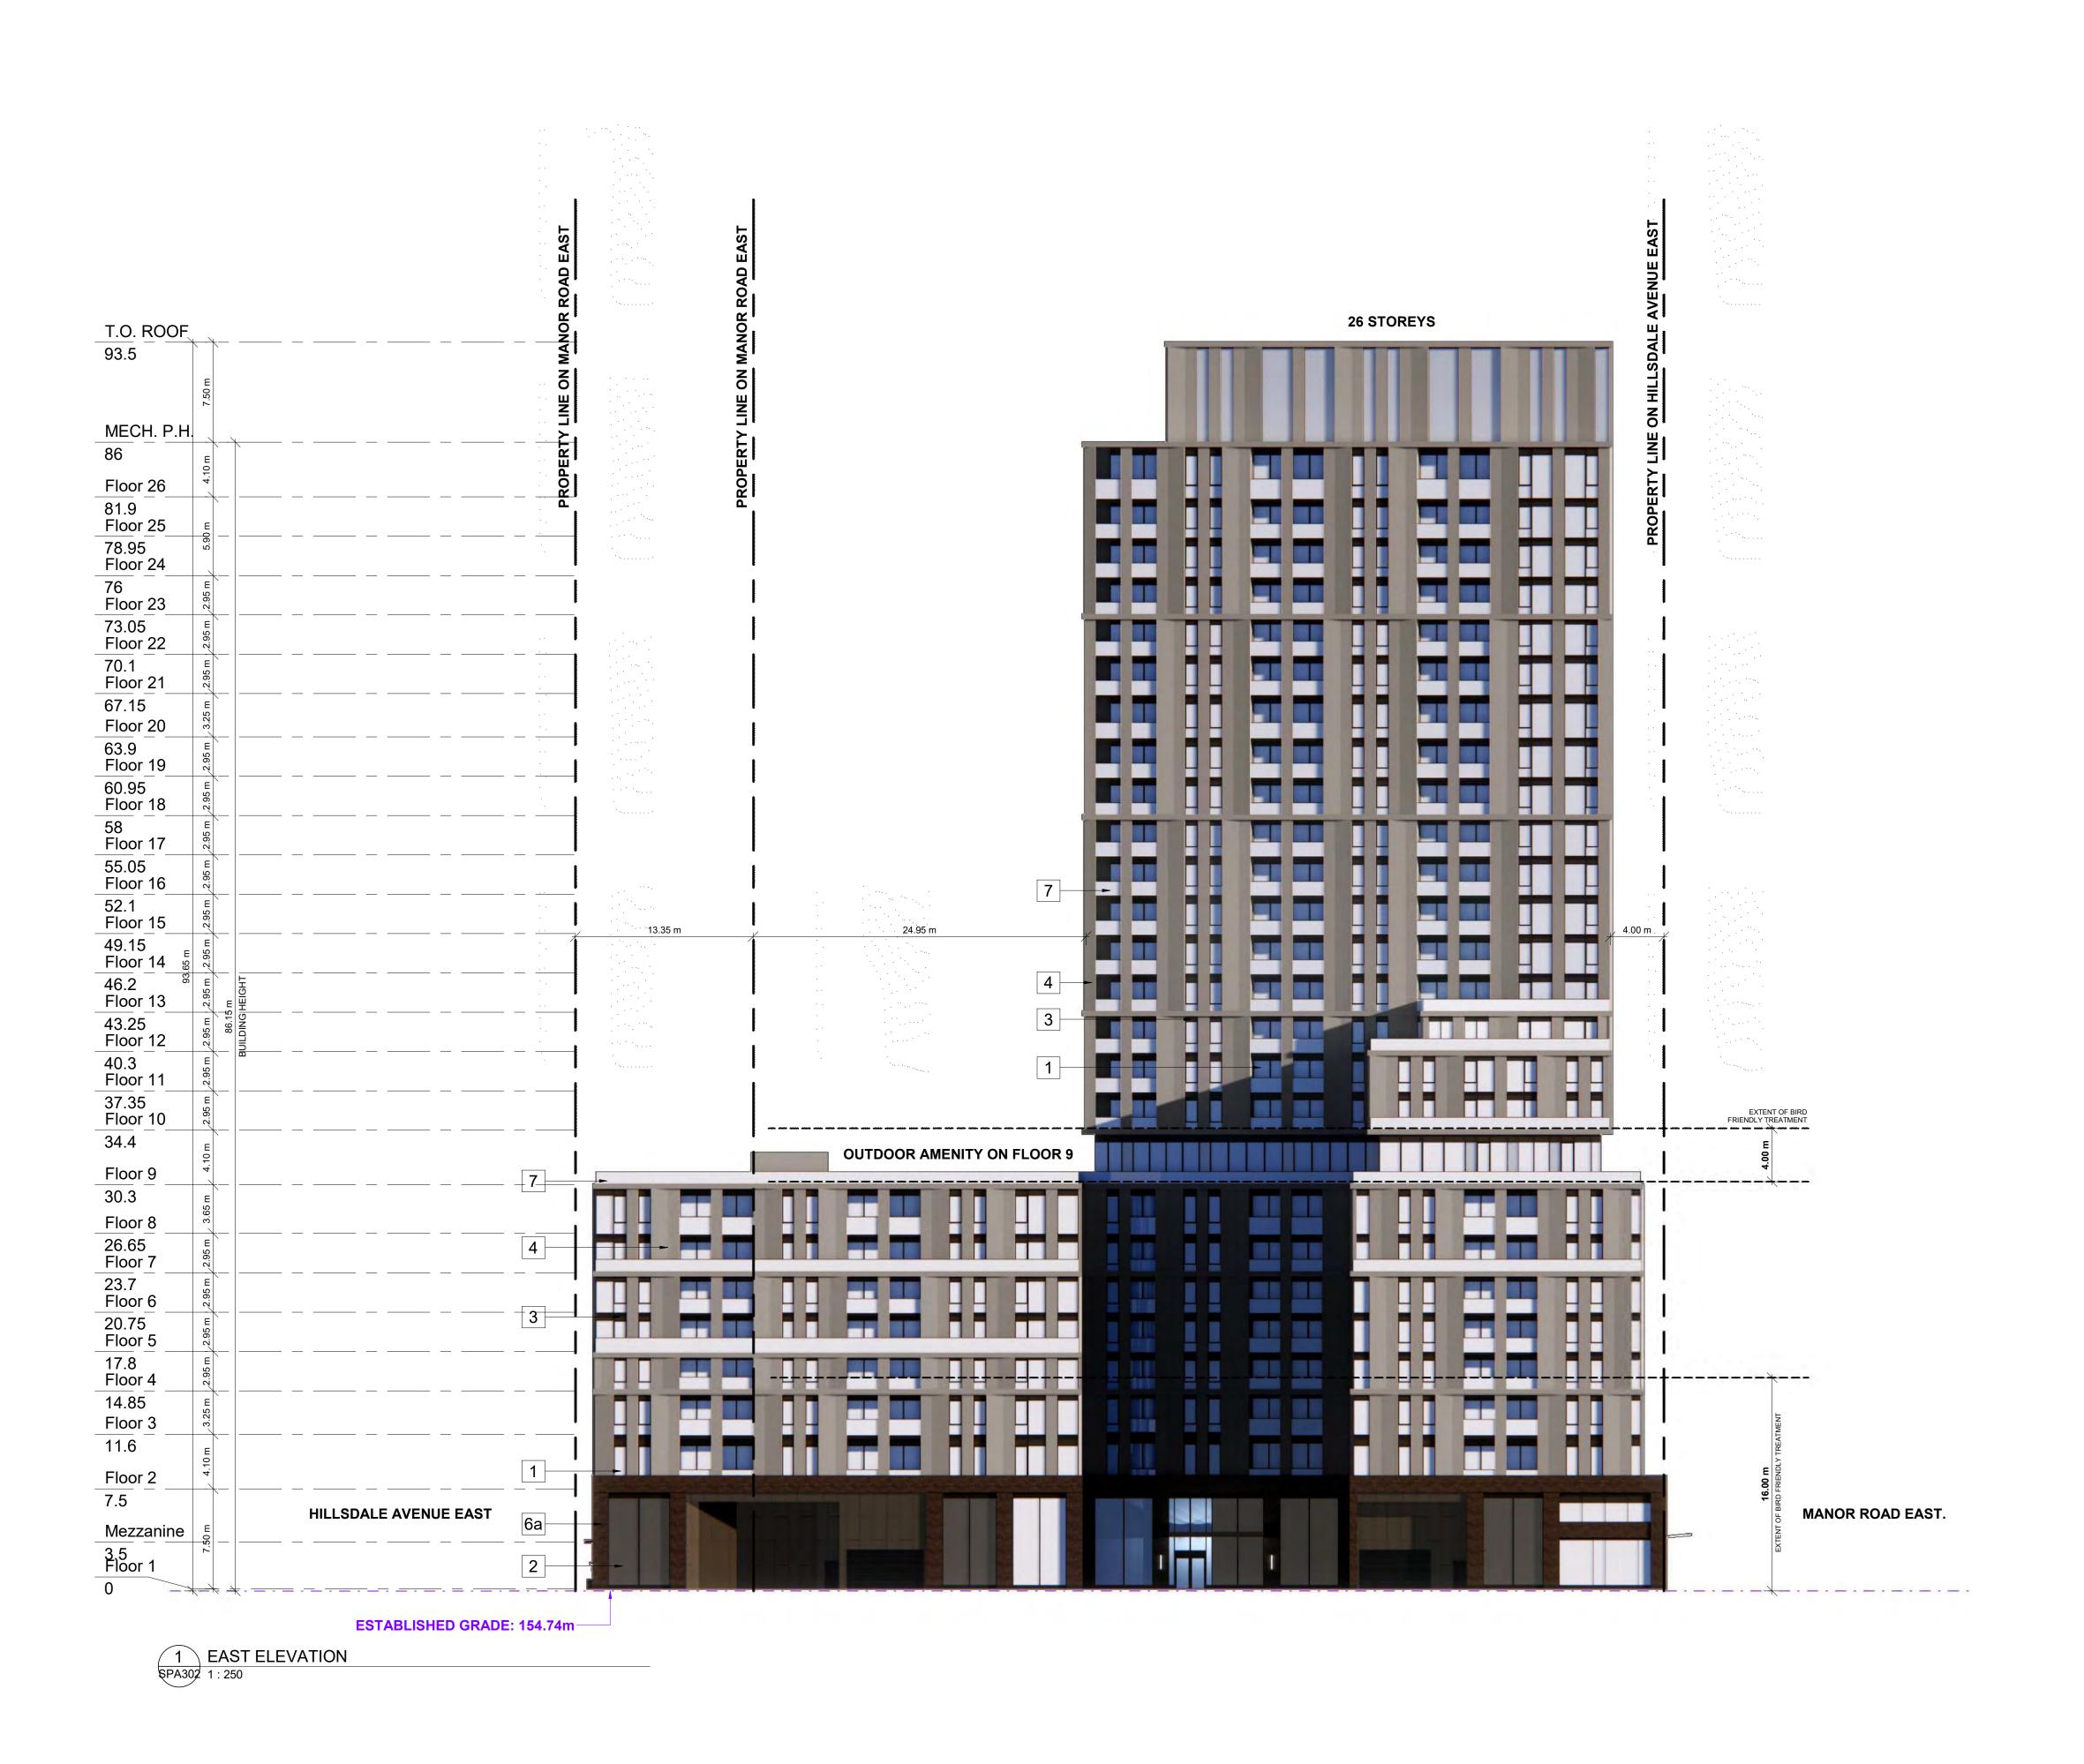

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EXTERIOR FINISHES LEGEND

ALUMINUM WINDOW WALL GLAZING SYSTEM

1 VISION GLAZING

SPANDREL GLAZING - COLOUR (TBD)

ALUMINUM WALL LOUVER - COLOUR (TBD)

ALUMINUM SHEET PANEL - COLOUR (TBD)

PRECAST CONCRETE - COLOUR (TBD)

6a BRICK VENEER -COLOUR (TBD) COLOUR (TBD) BRICK VENEER -

6b COLOUR (TBD) BRICK VENEER -


7 GLASS RAILING

BIRD FRIENDLY GUIDELINE

GENERAL NOTES IN ACCORDANCE WITH THE BIRD-FRIENDLY DEVELOPMENT GUIDELINES (FIRST 16 METERS ABOVE GRADE AND 4 METERS ABOVE GREEN FEATURE):

PROVISION OF VISUAL MARKERS
VISUAL MARKERS TO ALERT BIRDS WILL BE PROVIDED.
INCREASING THE SOLID TO GLASS RATIO OF GLAZING BY
PROVIDING A TIGHTER GLAZING GRID IS ONE METHOD
CONSIDERED, OTHERS ARE:
- APPLICATION OF FILM AND DECALS TO THE GLASS
-MUTTING REFECTIONS IN THE GLASS THROUGH THE
USE OF INTERNAL SCREENS PLACED CLOSE TO THE
GLASS SURFACE.
- CANOPIES LOCATED ALONG THE BUILDING FACADE TO
PROVIDE ADDITIONAL MUTING OF REFLECTED IMAGES
- USE CERAMIC FRIT PANEL GLASS FROM AGC FOR ALL
VISION GLASS ON LEVEL 1 & 2

REDUCTION OF LIGHT POLLUTION
- REDUCTION OF LIGHT POLLUTION FROM INTERIOR
LIGHTS, PARTICULARLY DURING MIGRATION PERIODS.
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 5
 2024-10-02
 WITHOUT PREJUDICE SET #2

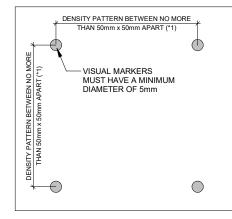 2
 2023-11-08
 REZONING RESUBMISSION

 1
 2023-08-15
 ISSUED FOR REZONING

 #
 DATE
 DESCRIPTION


Hillsdale Ave E + Yonge St + Manor Rd E

Toronto, Ontario

EAST ELEVATION

PROJECT NO. 20.222P01

PROJECT DATE 2023-03-10 DRAWN BY NMU CHECKED BY RMM As indicated

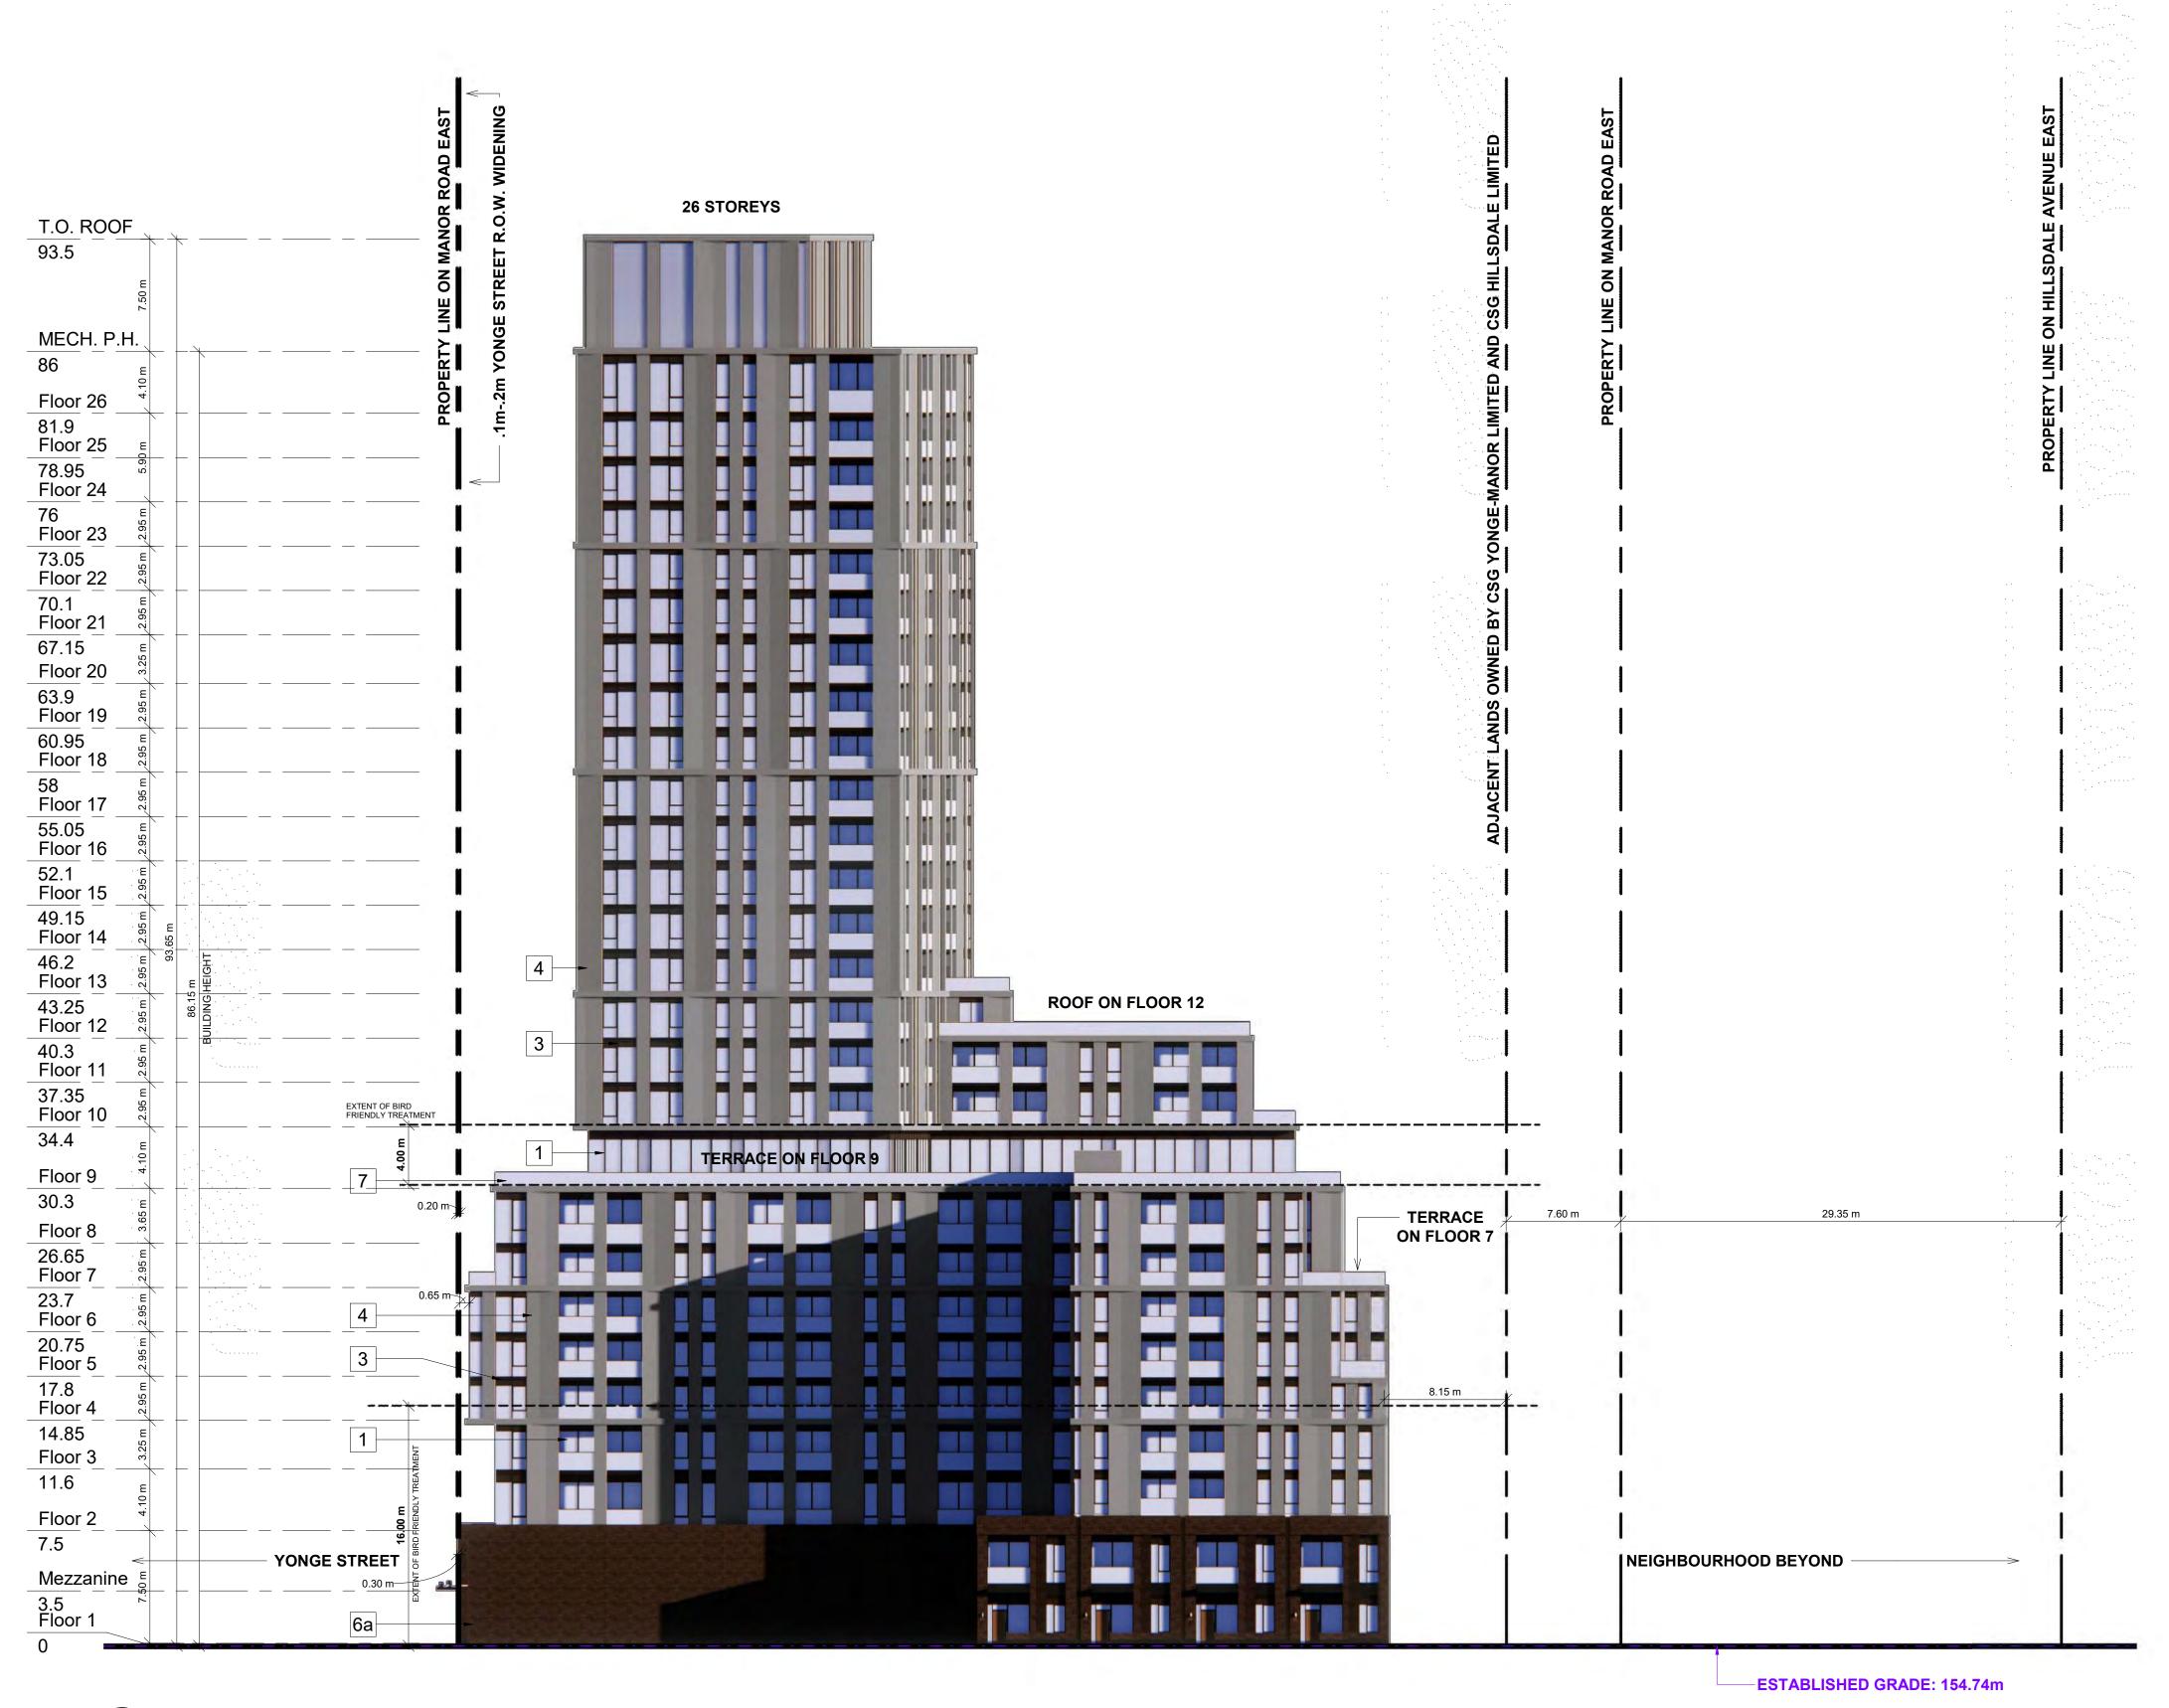

1 SOUTH ELEVATION SPA303 1:250

TURNER FLEISCHER

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EXTERIOR FINISHES LEGEND

ALUMINUM WINDOW WALL GLAZING SYSTEM

1 VISION GLAZING

2 SPANDREL GLAZING - COLOUR (TBD)

ALUMINUM WALL LOUVER - COLOUR (TBD)

4 ALUMINUM SHEET PANEL - COLOUR (TBD)

PRECAST CONCRETE - COLOUR (TBD)

6a BRICK VENEER -COLOUR (TBD)

6b BRICK VENEER -COLOUR (TBD)

6c BRICK VENEER -COLOUR (TBD)


7 GLASS RAILING

BIRD FRIENDLY GUIDELINE

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5 2024-10-02 WITHOUT PREJUDICE SET #2
2 2023-11-08 REZONING RESUBMISSION
DATE DESCRIPTION

Hillsdale Ave E + Yonge St +

Manor Rd E Toronto, Ontario

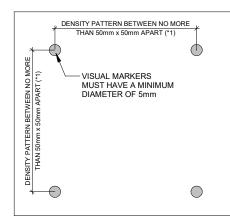SOUTH ELEVATION

PROJECT NO. 20.222P01 PROJECT DATE 2023-03-10 DRAWN BY Author CHECKED BY Checker As indicated



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COLOUR (TBD)

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EXTERIOR FINISHES LEGEND

ALUMINUM WINDOW WALL GLAZING SYSTEM

1 VISION GLAZING

SPANDREL GLAZING - COLOUR (TBD)

ALUMINUM WALL LOUVER - COLOUR (TBD)

ALUMINUM SHEET PANEL - COLOUR (TBD)

PRECAST CONCRETE - COLOUR (TBD)

6a BRICK VENEER -COLOUR (TBD)

COLOUR (TBD) BRICK VENEER -

7 GLASS RAILING

BRICK VENEER -


BIRD FRIENDLY GUIDELINE

6b

GENERAL NOTES IN ACCORDANCE WITH THE BIRD-FRIENDLY DEVELOPMENT GUIDELINES (FIRST 16 METERS ABOVE GRADE AND 4 METERS ABOVE GREEN FEATURE):

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DATE DESCRIPTION

Hillsdale Ave E + Yonge St + Manor Rd E

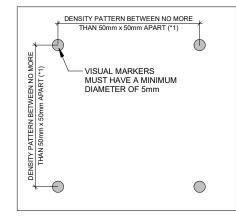Toronto, Ontario

WEST ELEVATION

PROJECT NO. 20.222P01 PROJECT DATE 2023-03-10 DRAWN BY Author CHECKED BY Checker SCALE 1:200



VIEW FROM HILLSDALE AVENUE EAST



VIEW FROM YONGE STREET



VIEW FROM HILLSDALE AVENUE EAST



VIEW FROM ADJACENT LANDS OWNED BY CSG YONGE-MANOR LIMITED AND CSG HILLSDALE LIMITED

TURNER
FLEISCHER

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5 2	2024-10-02	WITHOUT PREJUDICE SET #2 REZONING RESUBMISSION	NMU NMU
1	2023-08-15	ISSUED FOR REZONING	NMU
#	DATE	DESCRIPTION	BY

Hillsdale Ave E + Yonge St + Manor Rd E

Toronto, Ontario

3D PERSPECTIVES

SPA801 REV.




VIEW FROM MANOR ROAD EAST



VIEW FROM YONGE STREET



VIEW FROM YONGE STREET AND MANOR ROAD EAST

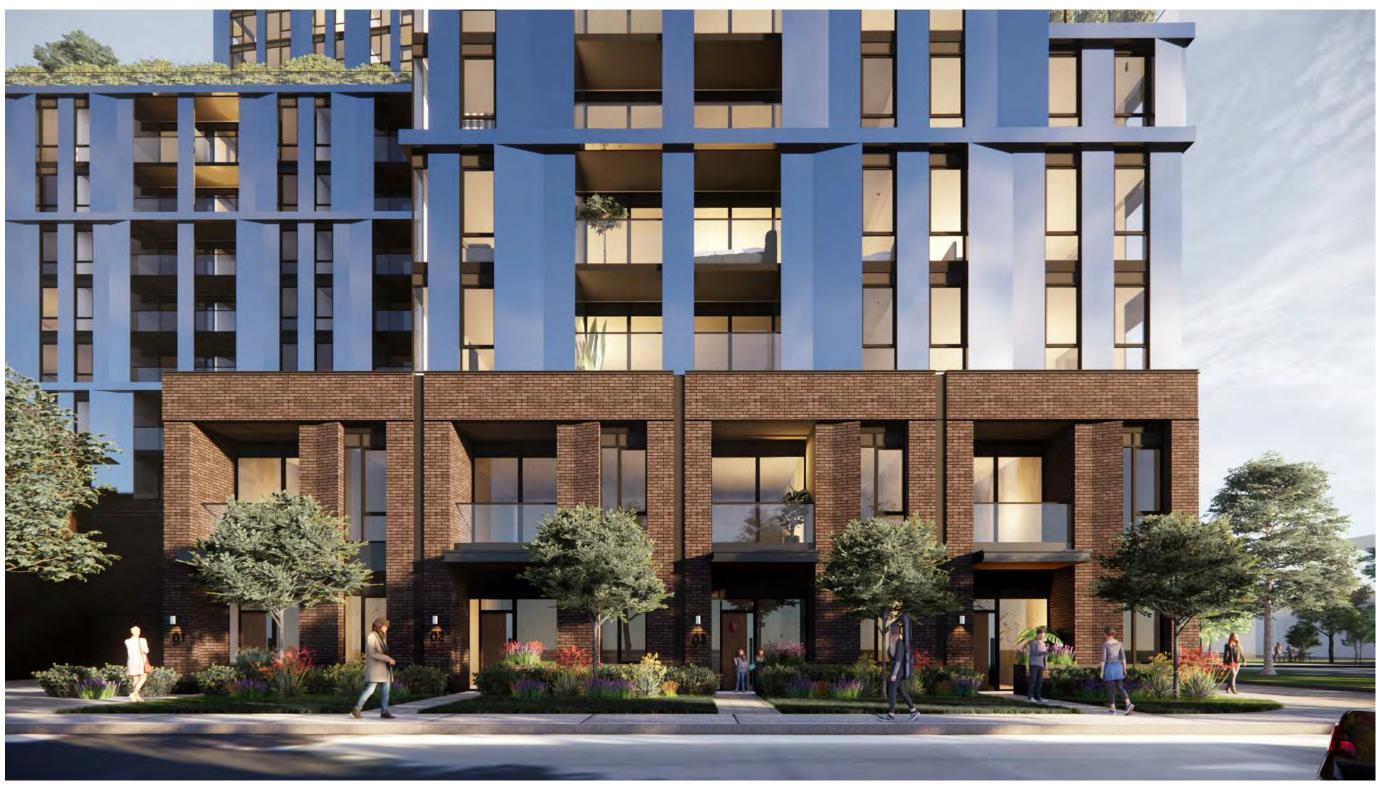

VIEW FROM MANOR ROAD EAST

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Hillsdale Ave E + Yonge St + Manor Rd E


Toronto, Ontario

3D PERSPECTIVES

20.222P01 2023-03-10



VIEW FROM YONGE STREET AND HILLSDALE AVENUE EAST

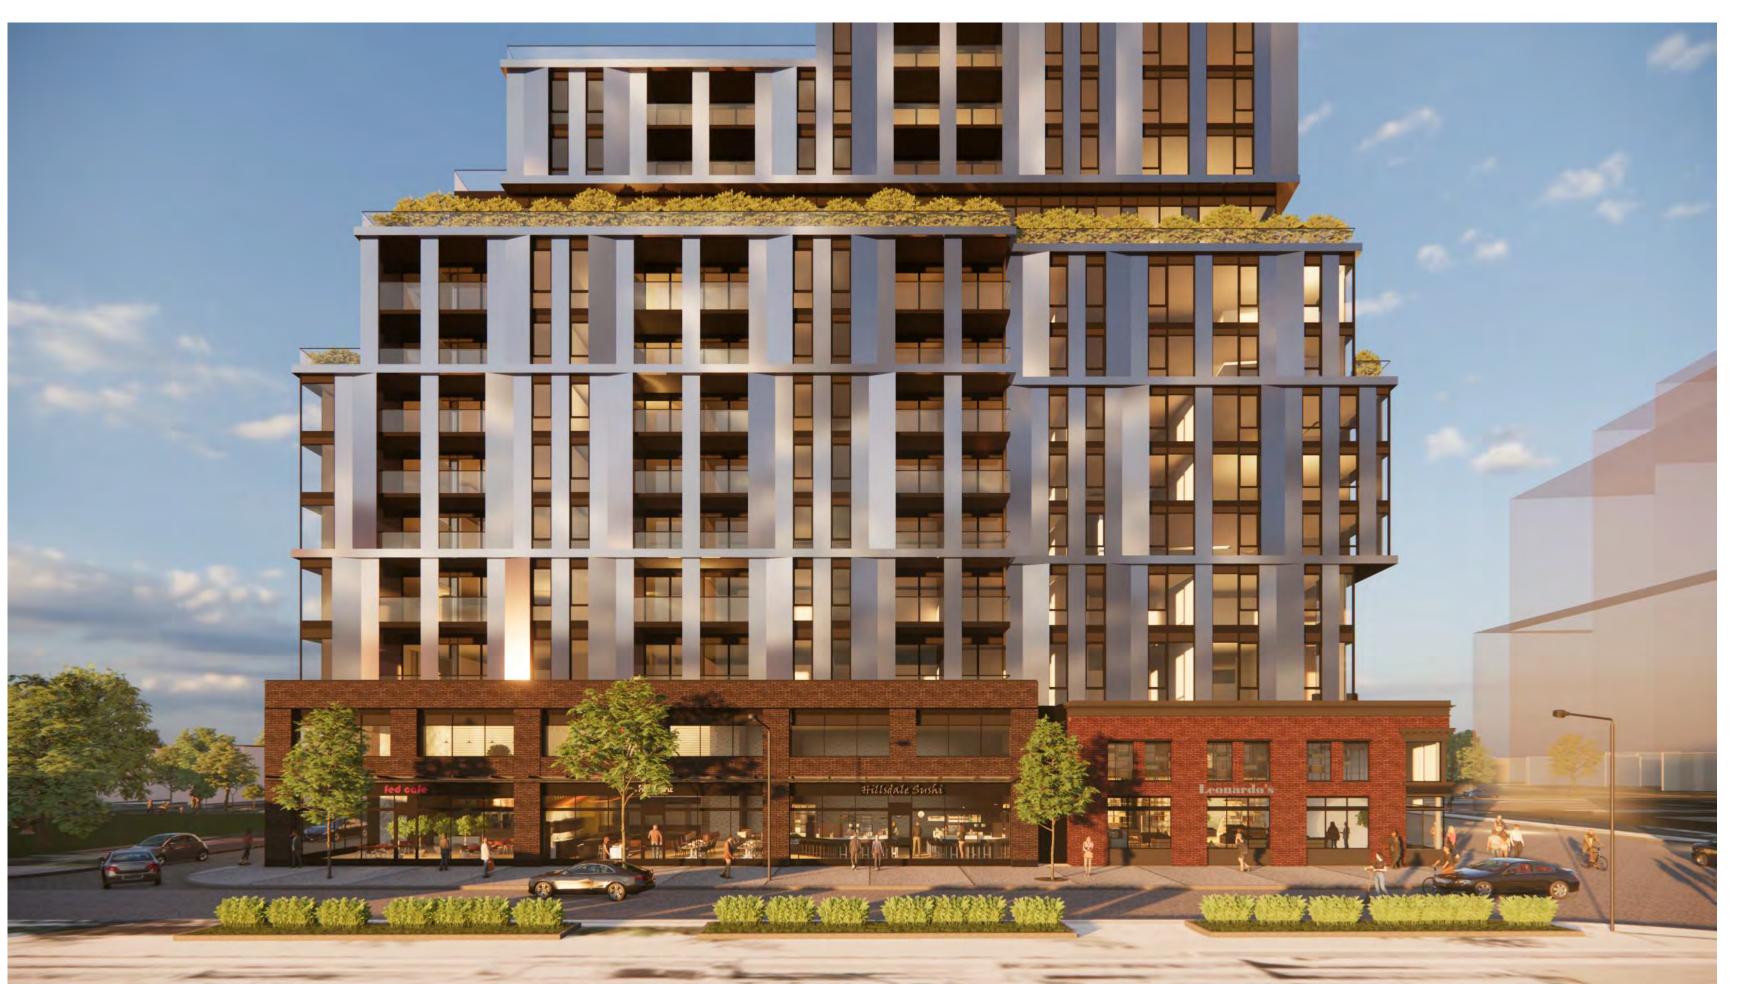


VIEW FROM HILLSDALE AVENUE EAST



VIEW FROM YONGE STREET AND HILLSDALE AVENUE EAST



VIEW OF HERITAGE FACADE FROM HILLSDALE AVENUE EAST

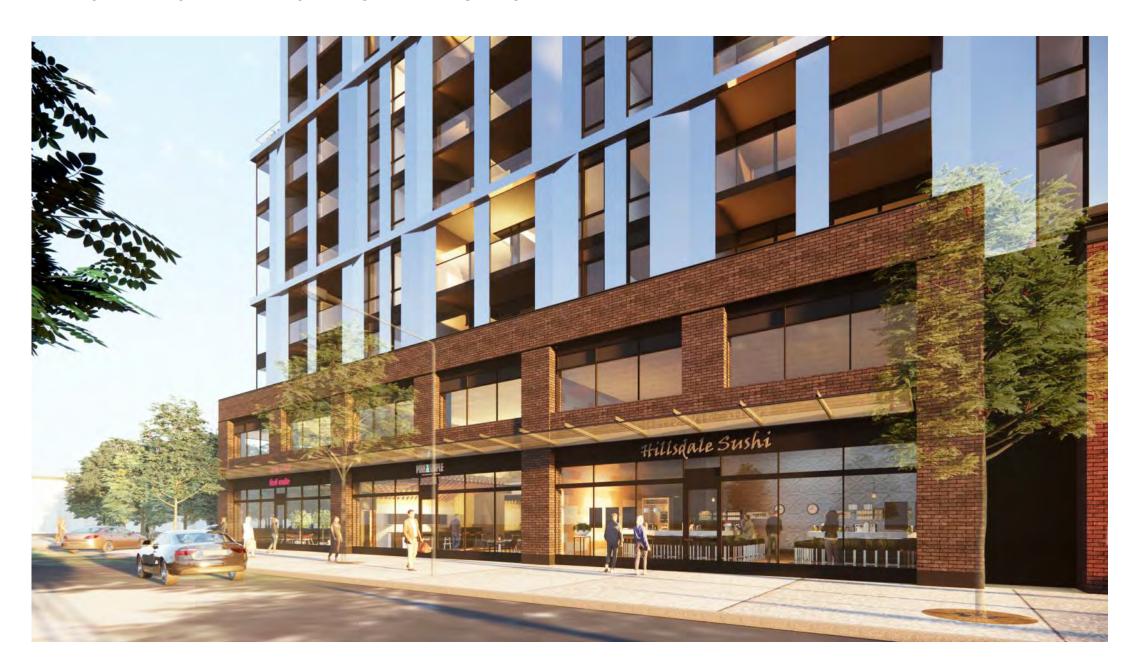

VIEW FROM HILLSDALE AVENUE EAST

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3D PERSPECTIVES

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