3374 KEELE STREET

Proposed Residential Development



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ERTL Surveyors

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No.: 04	Issued For: Mediation	Date: Sept. 26, 2024	
No.: 03	Issued For: Rezoning Submission	Date: Mar. 17, 2023	
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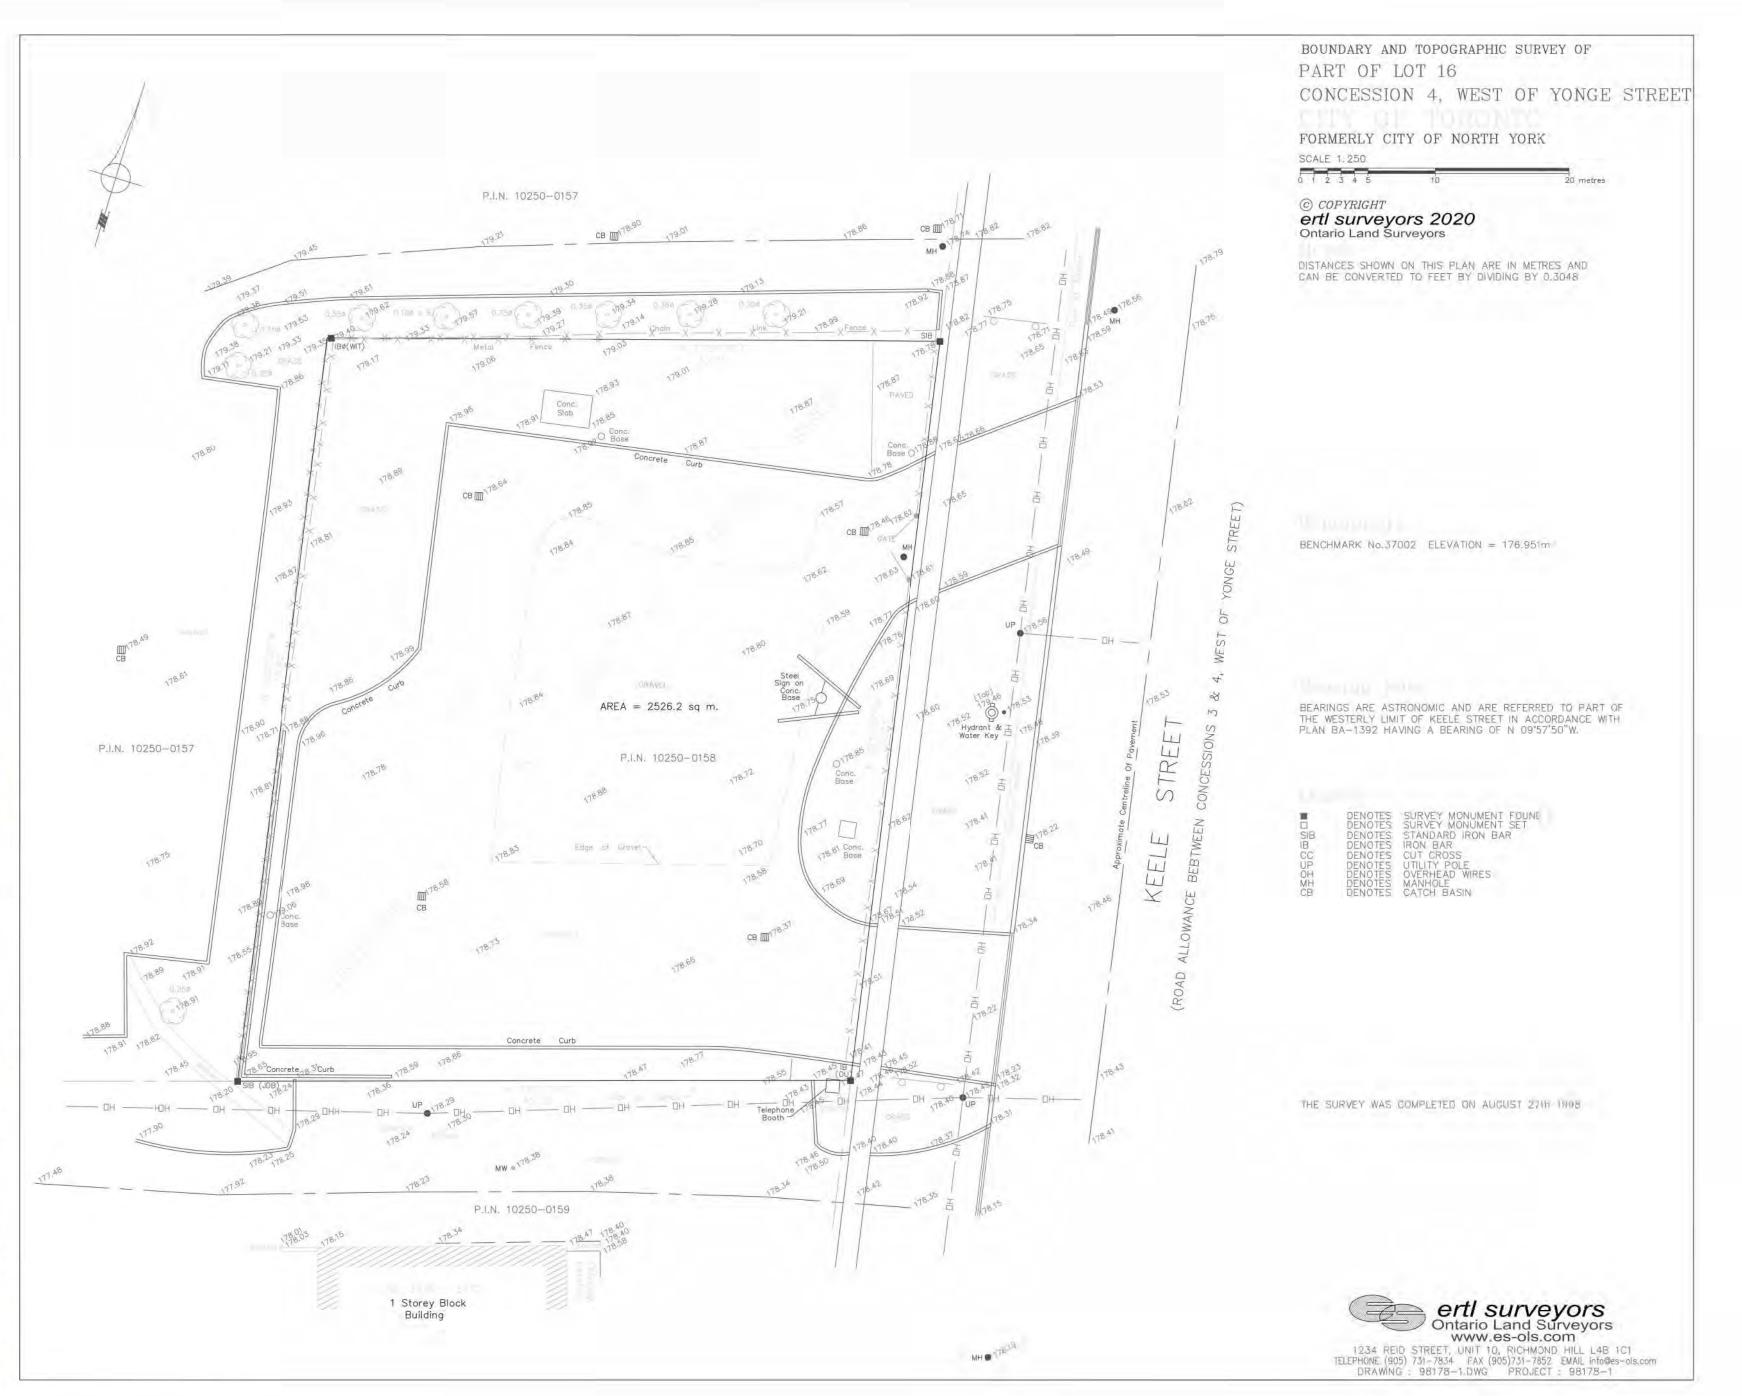
Stikeman Elliott

3374 KEELE STREET, TORONTO

Cover Sheet

Checked by: Project No.:

19-120 Date: Sept. 9, 2024



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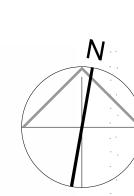
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Stikeman Elliott

Date:

3374 KEELE STREET, TORONTO Proposed Residential Development

Context Plan & Survey



1:2200 Drawn by: J.H. Checked by: N.D Project No.: 19-120 Sept. 9, 2024

■ NTS

2.0

Date: Oct.22,2024

Date: Sept.295, 2024

Date: Mar. 17, 2023

Date: Apr. 29, 2022

Stikeman Elliott

Drawing Title:

Drawn by: J.H.

Checked by: N.D Project No.:

19-120


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Proposed Residential Development

Project Statistics

Authorities Having Jurisdiction

Toronto ON M3J 0H1

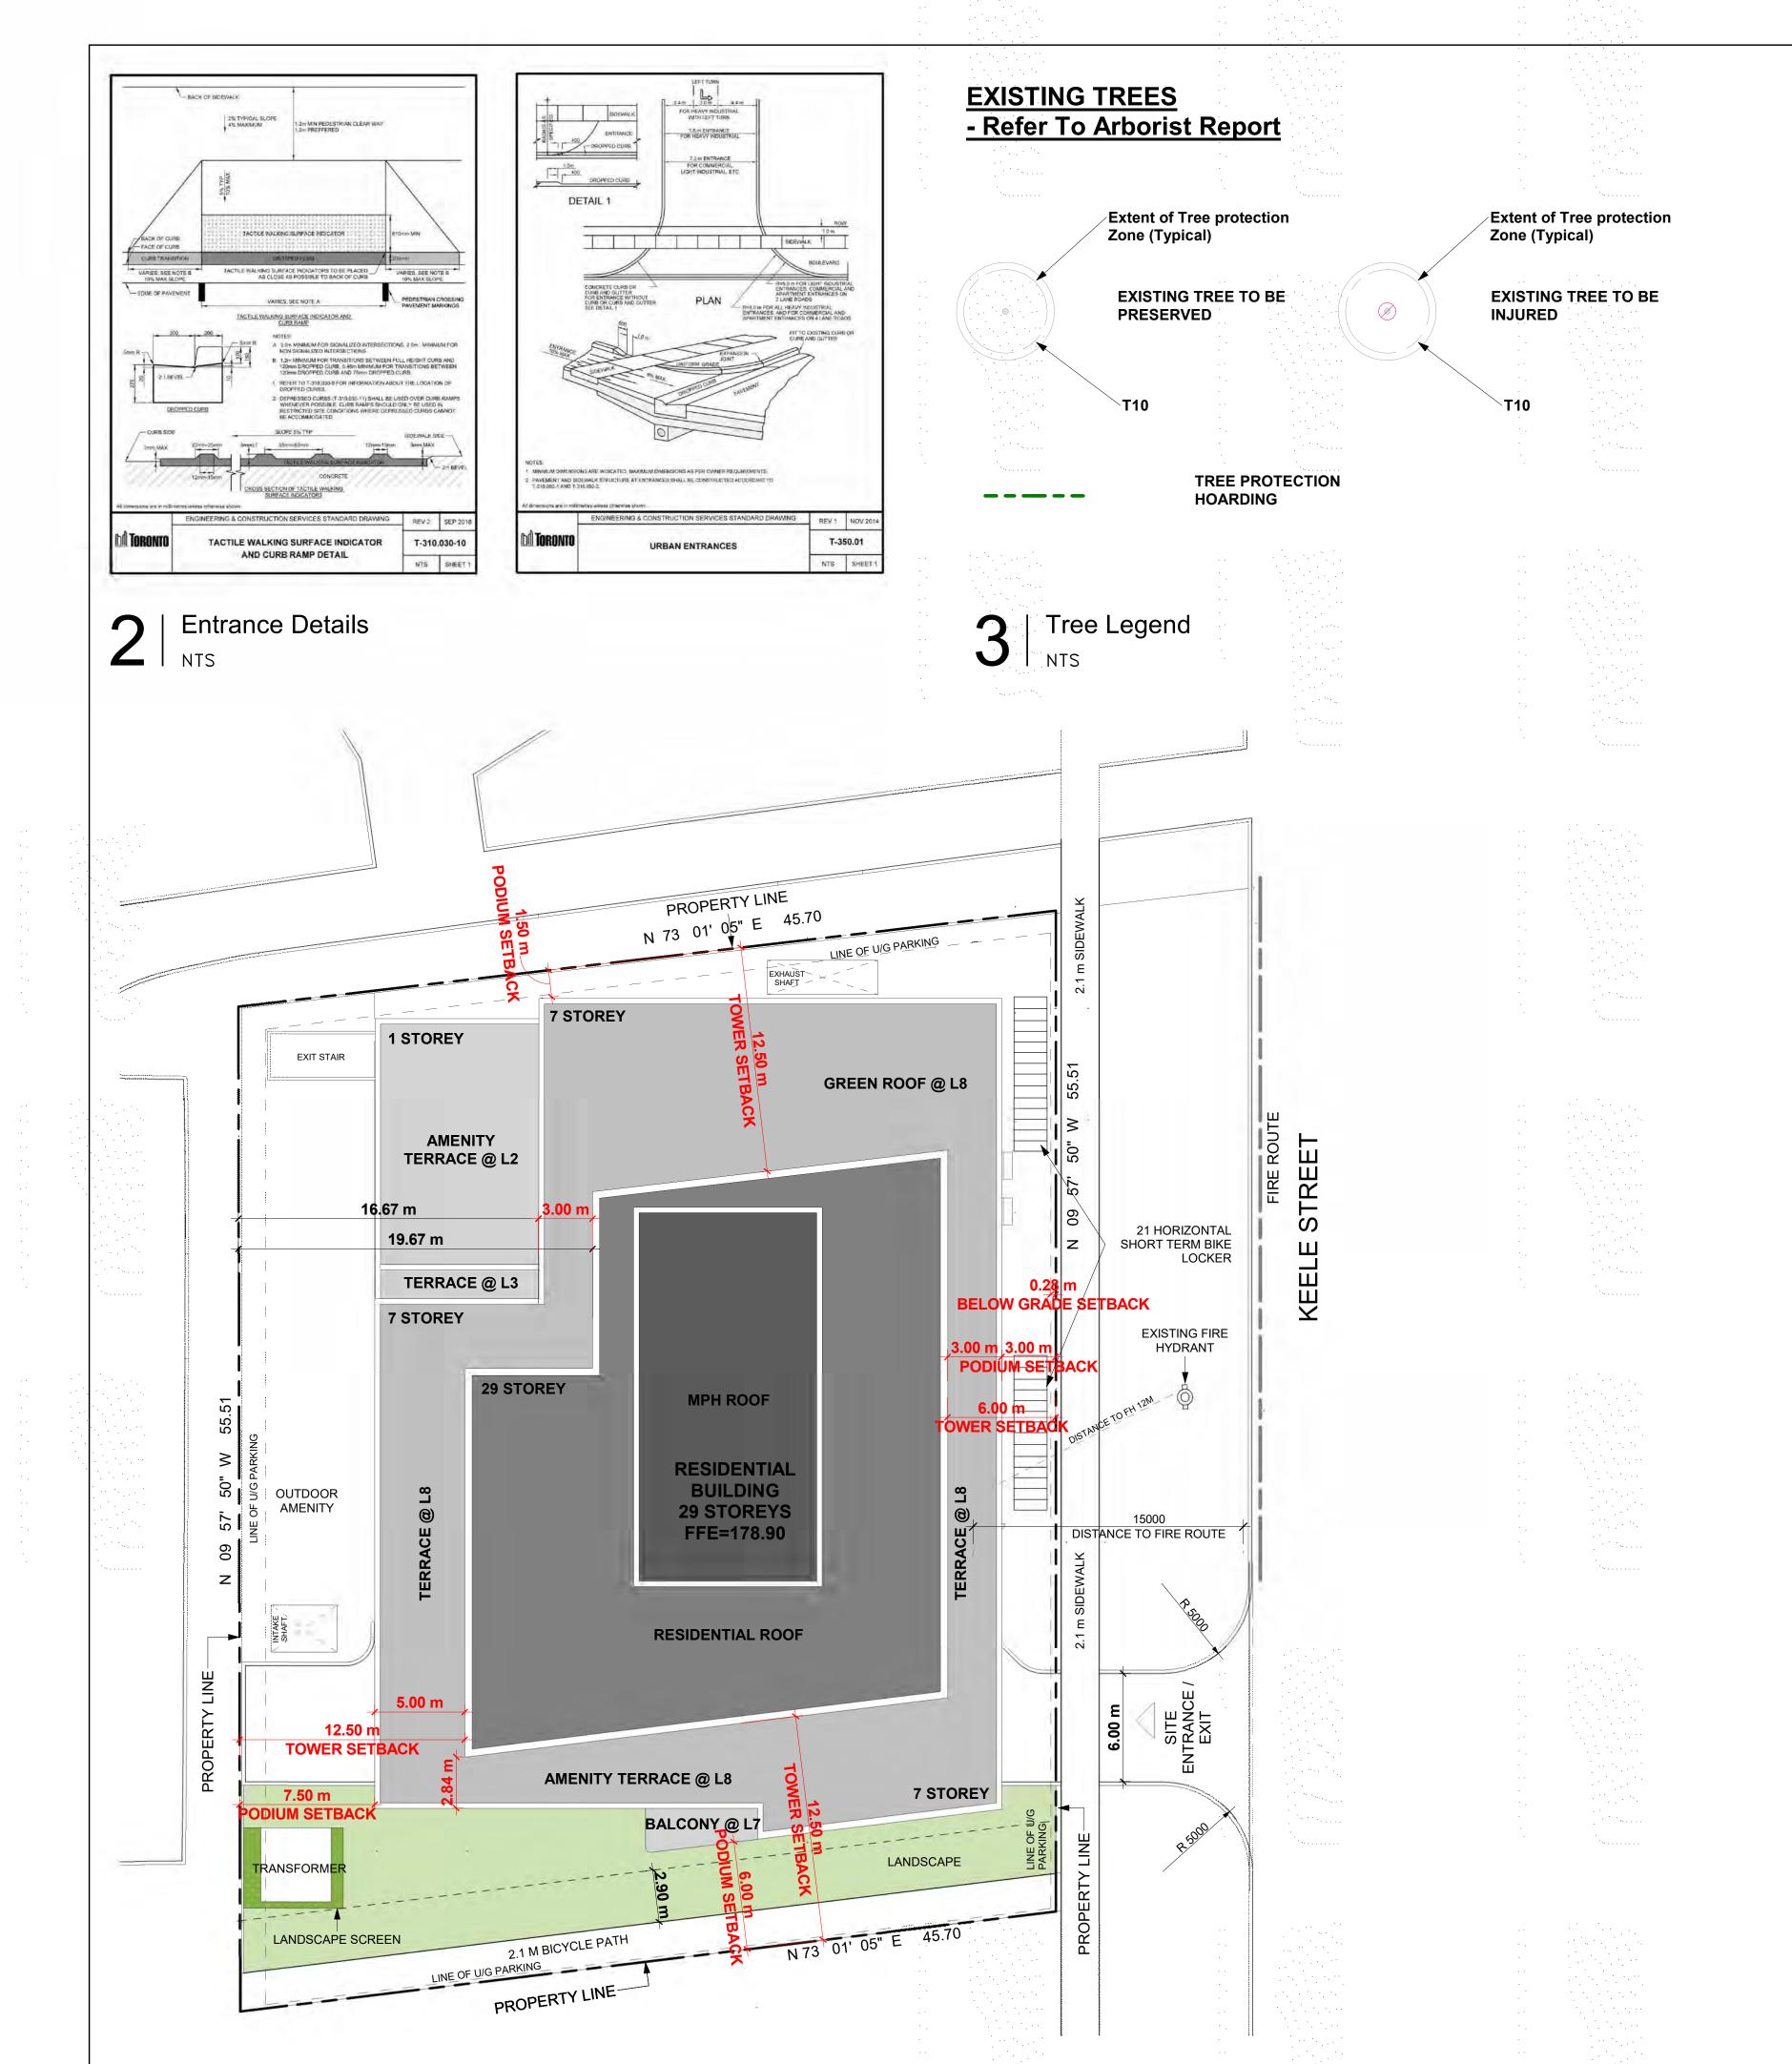


Site Plan

Scale: 1 : 200

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Authorities Having Jurisdiction

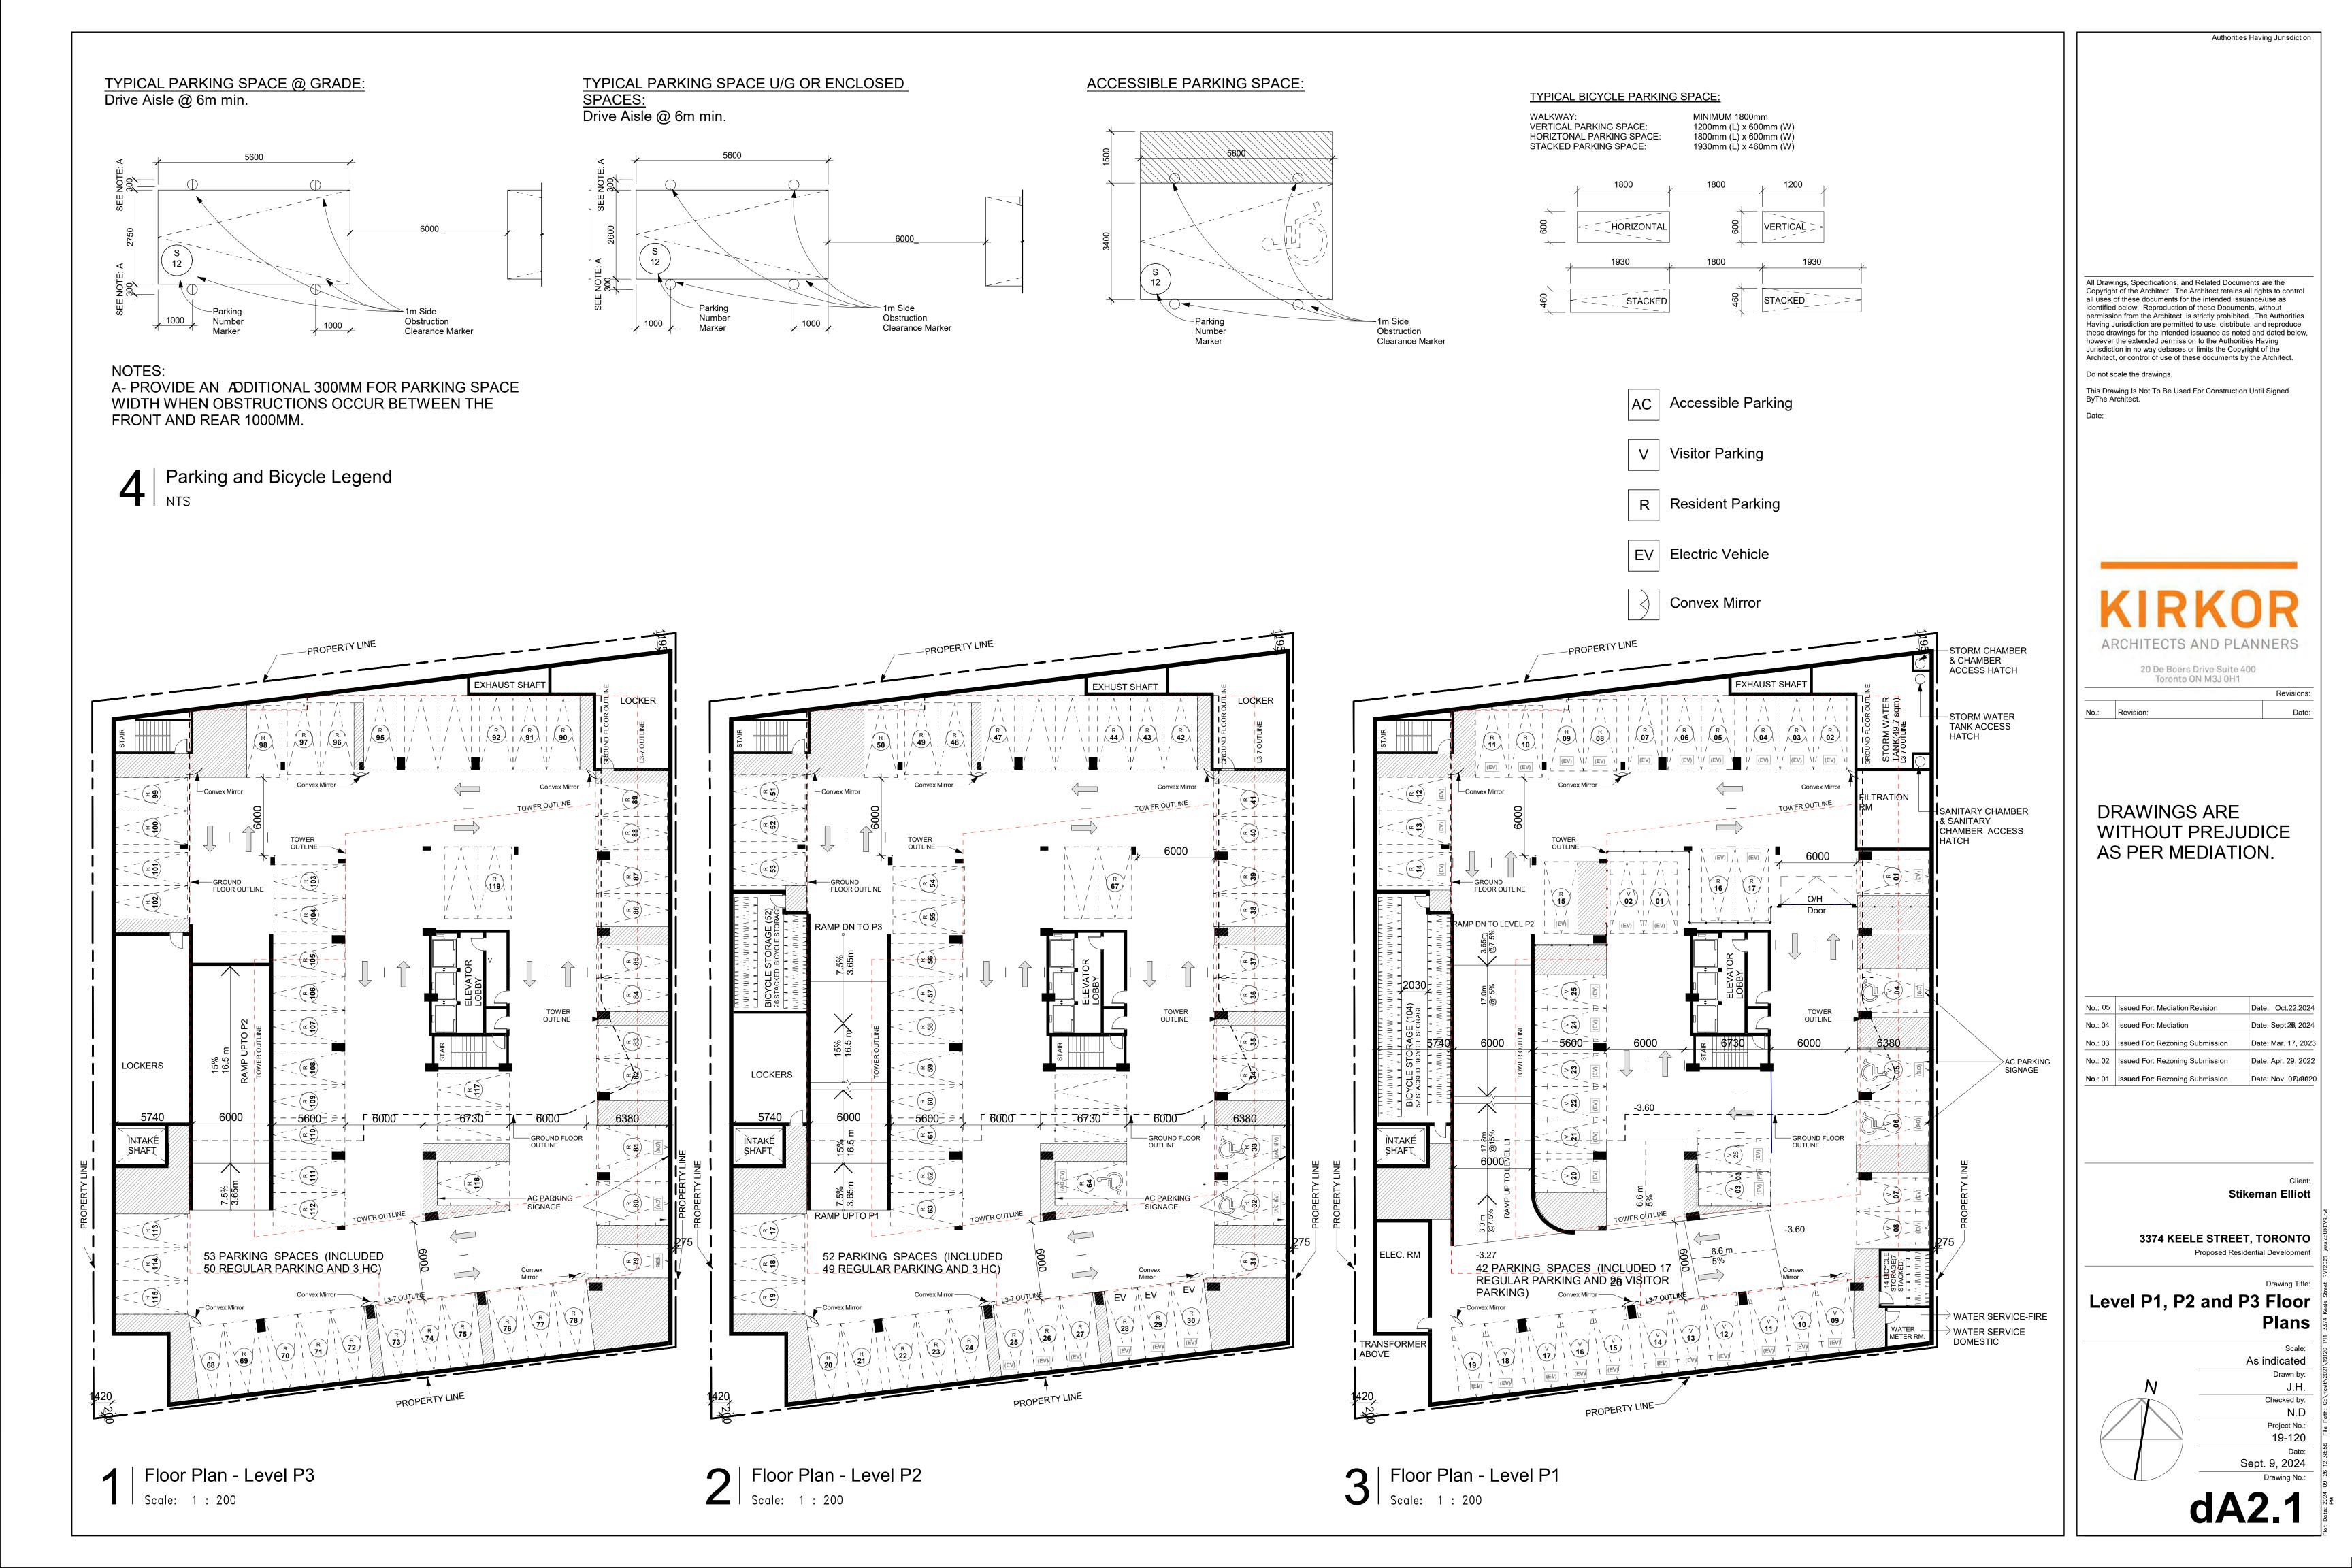

CITY OF TORONTO REQUIREMENTS,2012

GARBAGE/RECYCLING: 25 m²/FIRST 50 UNITS +13m²/EACH ADDITIONAL 50 UNITS +10m² BULK WASTE ROOM

CALCULATION:

299 RESIDENTIAL PROPOSED UNITS

REQUIRED WASTE STORAGE ROOM BUILDING: $25m^2 + (13m^2 \times ((299-50)/50)) + 10m^2 = 99.74m^2$

PROVIDED WASTE STORAGE ROOM

WASTE STORAGE ROOM ON LEVEL 1: 133.81 m² BULK WASTE ROOM ON LEVEL 1: 10 m²

STAGING AREA

HAS AN UNENCUMBERED VERTICAL CLEARANCE OF 6.1 METRES, IS LEVEL (+/-2%), AND IS CONSTRUCTED OF A MINIMUM OF 200 MM REINFORCED CONCRETE.

5m² FOR EVERY 50 UNITS ABOVE 50 REQUIRED=((299-50)/50)x5=24.9m²

PROVIDED: 25m²

ALL ACCESS DRIVEWAYS TO BE USED BY THE COLLECTION VEHICLE WILL HAVE MAXIMUM GRADIENT OF 8%, HAVE A MINIMUM VERTICAL CLEARANCE OF 4.4 METRES THROUGHOUT, A MINIMUM WIDTH OF 4.5 METRES THROUGHOUT AND BE 6 METRES WIDE AT POINT OF INGRESS AND EGRESS.

ACCESS DRIVEWAY FOR DRIVEWAY FOR COLLECTION VEHICLES WILL HAVE:

TRAINED ON SITE STAFF DURING COLLECTION

A TRAINED ON-SITE STAFF MEMBER WILL BE AVAILABLE TO MANOEUVRE BINS FOR THE COLLECTION DRIVER AND ALSO ACT AS A FLAGMAN WHEN THE TRUCK IS REVERSING. IN THE EVENT THE ON-SITE STAFF IS UNAVAILABLE AT THE TIME THE CITY COLLECTION VEHICLE ARRIVES AT THE SITE, THE COLLECTION VEHICLE WILL LEAVE THE SITE AND NOT RETURN UNTIL THE NEXT SCHEDULED COLLECTION DAY.

CONSTRUCTION OF LOADING AND STAGE AREA

CONSTRUCTION OF LOADING AND STAGE AREA TO BE MIN. 200 mm THICK REINFORCED CONCRETE PAD CAPABLE OF WITHSTANDING 35,000kg NO MORE THAN 2% SLOPE6.1 m CLEAR VERTICAL HEIGHT THERE IS 1 TYPE G LOADING AREA IN SITE

ALL OVERHEAD DOORS WILL HAVEA MINIMUM VERTICAL CLEARANCE OF 4 METERS, AND A MINMUM WIDTH OF 4 METERS.



CAUTION: TRUCK MANOEUVRING AHEAD

R2

FLASHING BEACON WITH AUDIBLE WARNING DEVICE ACTIVATED BY VEHICLE DETECTOR LOOPS LOCATED IN LOADINDING

BOLLARD WITH INTERCOME SYSTEM (R=0.15 M),ON ISLAND 0.6X1.2 M

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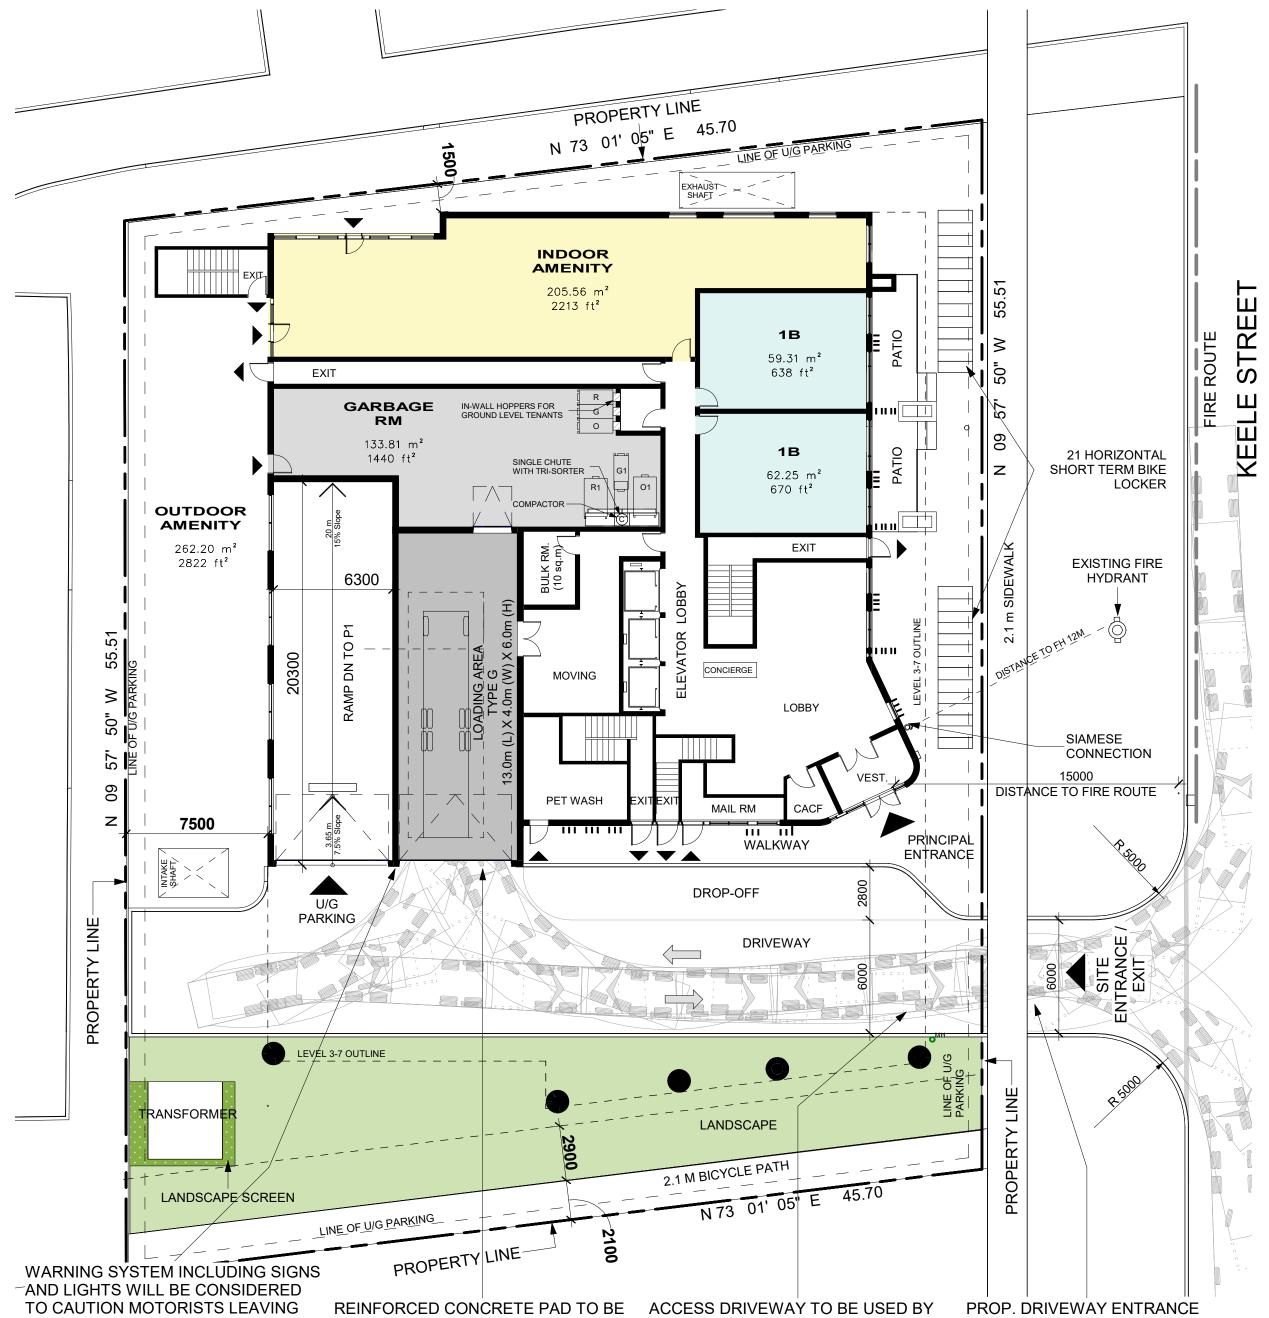
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Stikeman Elliott

Ground Floor Plan-Waste Management Notes

Checked by: N.D Project No.: 19-120 Sept. 9, 2024



REINFORCED CONCRETE PAD TO BE THE PARKING GARAGE OF HEAVY MIN. 200mm THICK, CAPABLE OF VEHICLES WHEN LOADING OPERATIONS ARE OCCURING WITHSTANDING 35,000kg, SLOPE +/-2% 6.1m CLEAR VERTICAL HEIGHT

ACCESS DRIVEWAY TO BE USED BY COLLECTION VEHICLE HAVE A MIN. VERTICAL CLEARANCE 4.4m THROUGHOUT, CAPABLE OF

AS PER T-350-01 & T-310.050-8

WITHSTANDING 35,000kg

Floor Plan - Level 1

Scale: 1 : 200

3374 KEELE STREET, TORONTO Proposed Residential Development As indicated



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GREEN ROOF

90.02 m² 969 ft²

CORRIDOR

INDOOR AMENITY

211.14 m² 2273 ft²

91.02 m² 980 ft²

519 ft²

59.62 m² 642 ft²

OUTDOOR AMENITY

220.68 m² 2375 ft²

3000 3000

1.1 m ROOF WALKWAY

88.00 m² 947 ft²

59.69 m² 642 ft²

OUTDOOR AMENITY @ L2 BELOW

TERRACE @ L3

No.: 05 Issued For: Mediation Revision Date: Oct.22,2024 Date: Sept28, 2024

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3374 KEELE STREET, TORONTO

Proposed Residential Development

Level 2, Level 3 -7, Level 8

Drawn by: J.H. Checked by: N.D Project No.: 19-120 Date: Sept. 9, 2024


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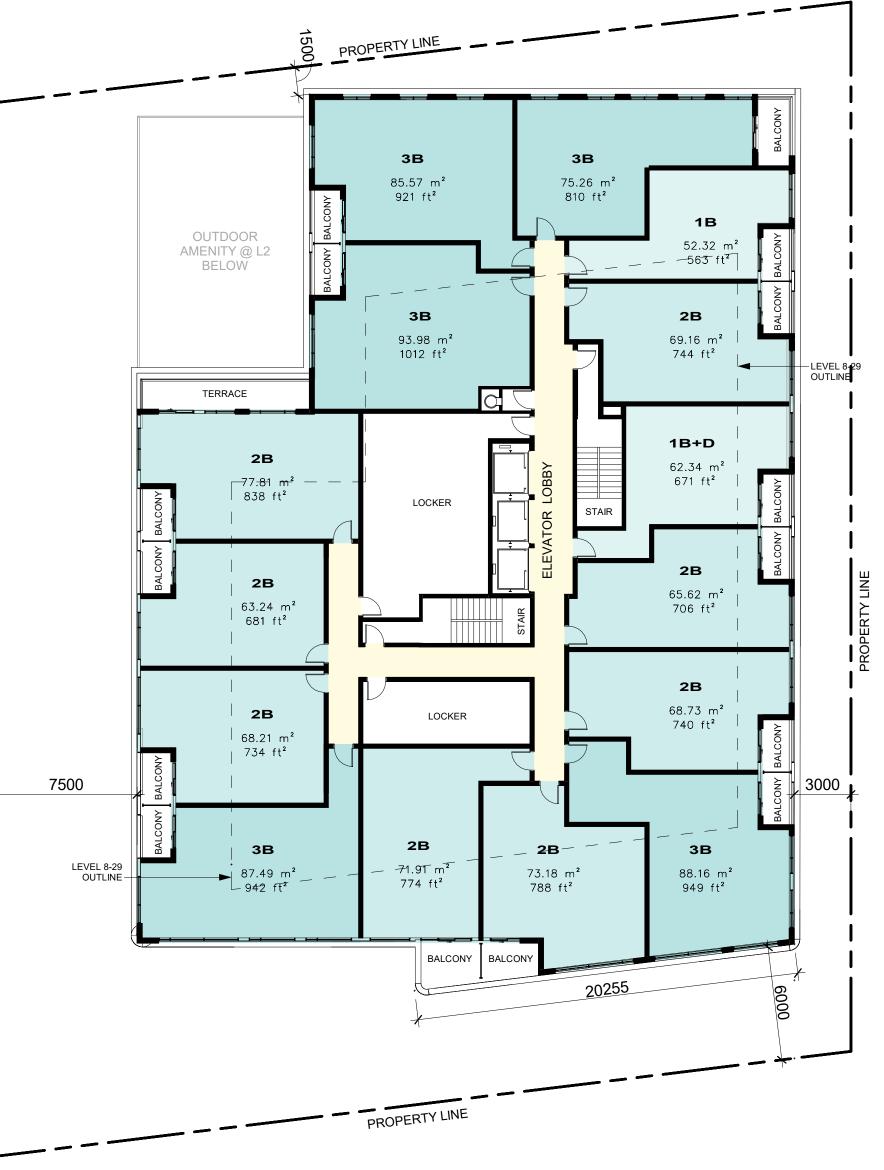
3 | Floor Plan - Level 8 | Scale: 1:200


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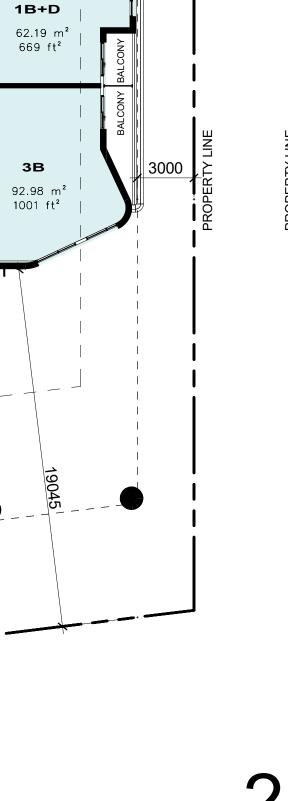
5000

7500





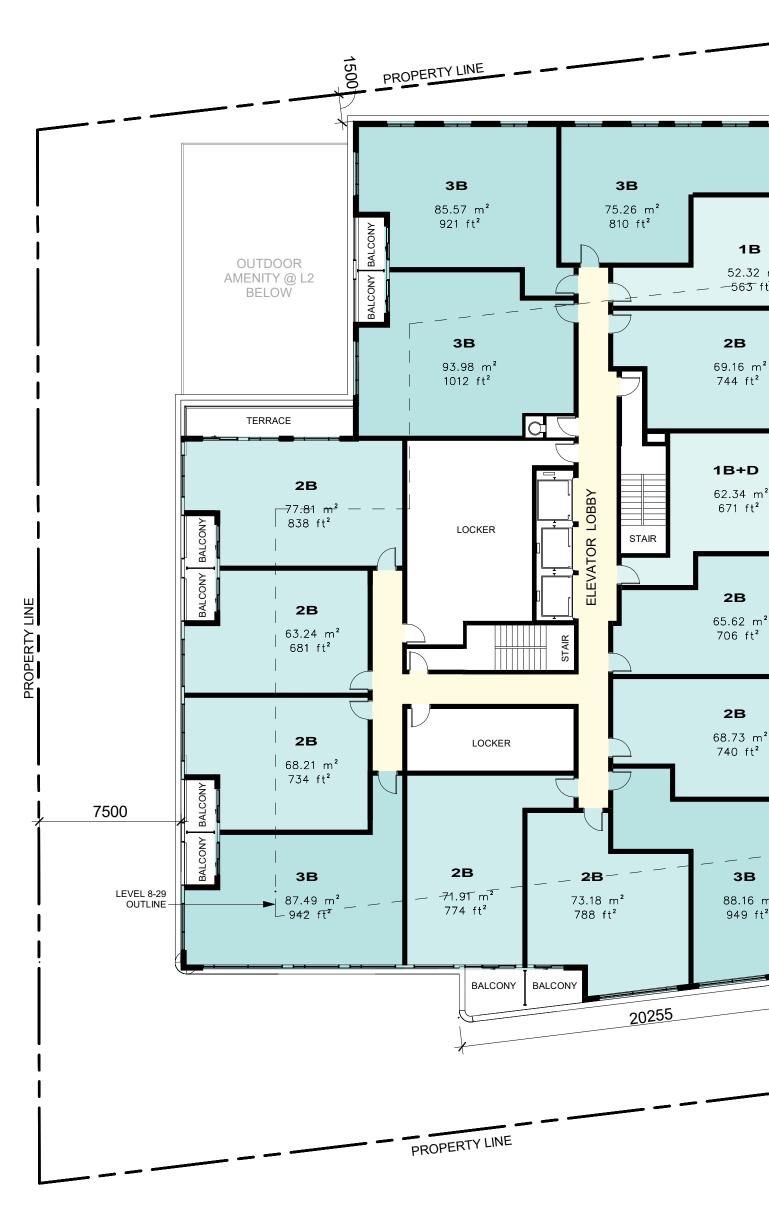

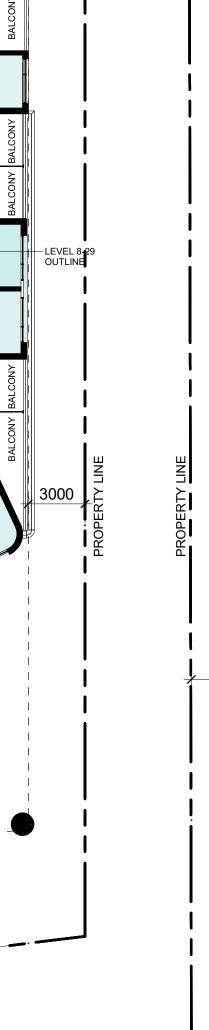

3B 85.57 m²

₩₩₩₩₩₩₩₩ <u>₩₩₩₩₩₩₩₩</u> BICYCLE STORAGE (10 E-Bikes)

OUTDOOR AMENITY

124.44 m² 1339 ft²

INDOOR AMENITY

235.61 m[‡]

LEVEL 3-7 OUTLINE

2536 ft²

7500

LEVEL 8-29 OUTLINE—


Floor Plan - Level 2

Scale: 1 : 200

OPEN TO BELOW

75.37 m²

811 ft²

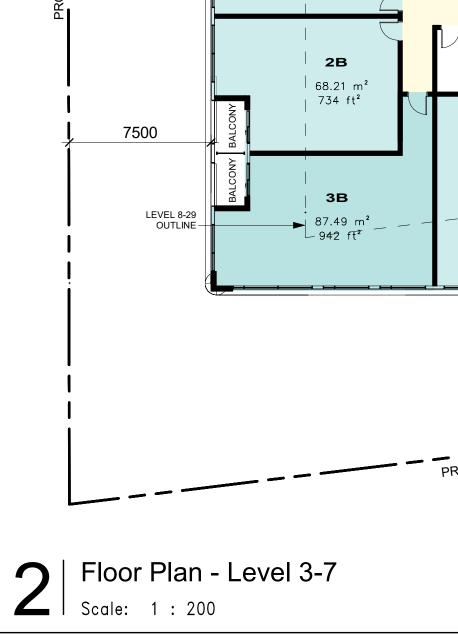



Green Roof Statistics


The Green Roof Statistics Template is required to be submitted for Site Plan Control Applications where a green roof is required under the Toronto Municipal Code Chapter 492, Green Roofs. Complete the table below and copy it directly onto the Roof Plan submitted as part of any Site Plan Control Application requiring a green roof in accordance with the Bylaw. Refer to Section § 492-1 of the Municipal Code for a complete list of defined terms, and greater clarity and certainty regarding the intent and application of the terms included in the template. The Toronto Municipal Code Chapter 492, Green Roofs can be found online at:


http://www.toronto.ca/legdocs/municode/1184_492.pdf

Green Roof Statistics

		Proposed
Gross Floor Area, as defined in Green Roof Bylaw (m2)		
Total Roof Area (m ²)		2176,69
Area of Residential Private Terraces (m ²)		206.08
Rooftop Outdoor Amenity Space, if in a Residential Building (m ²)		345.12
Area of Renewable Energy Devices (m ²)		0
Tower (s)Roof Area with floor plate less than 750 m ²		695.96
Total Available Roof Space (m ²)		929.53
Green Roof Coverage	Required	Proposed
Coverage of Available Roof Space (m ²)	557.72	573.02
Coverage of Available Roof Space (%)	60%	62%


4 | Green Roof Statistics

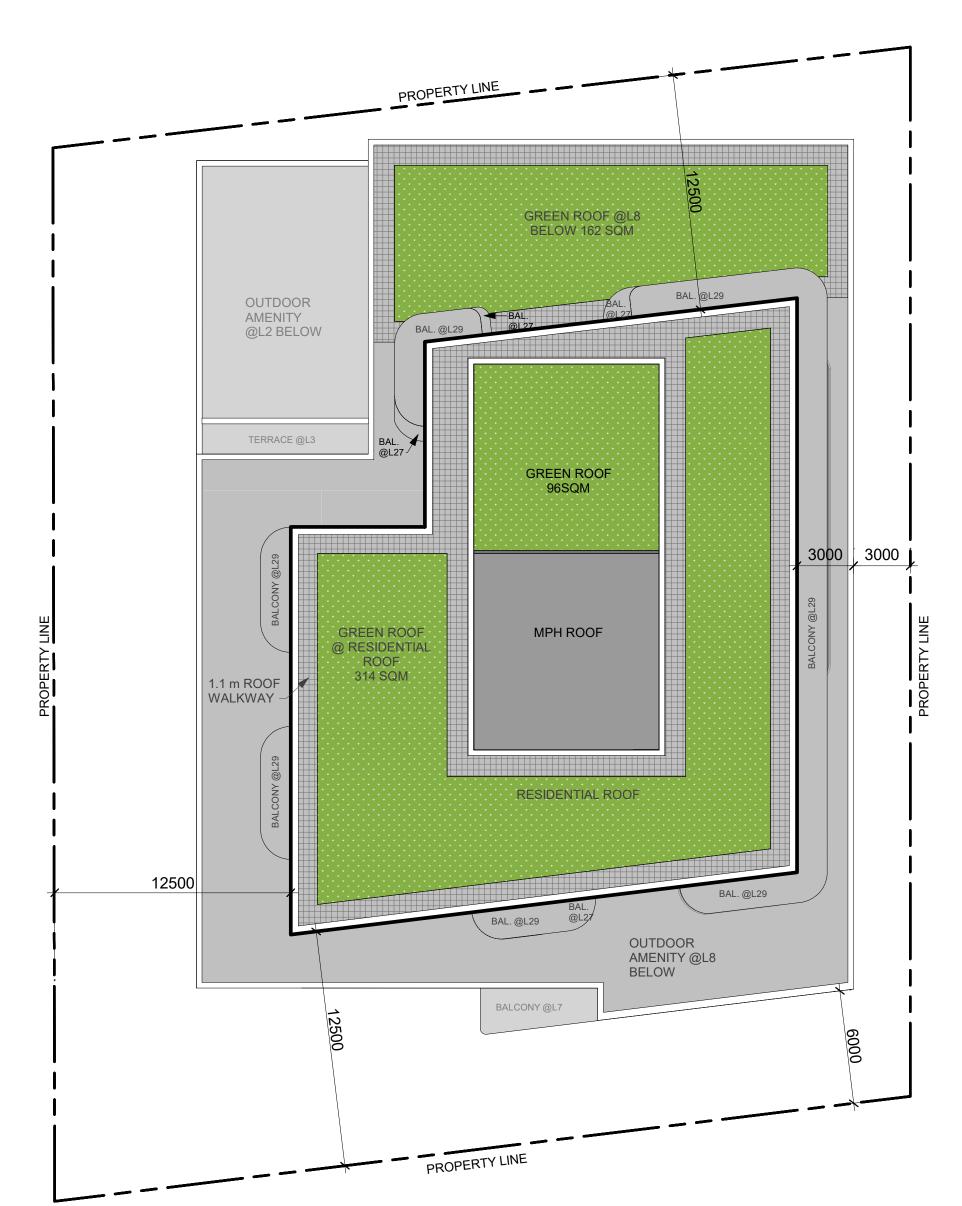

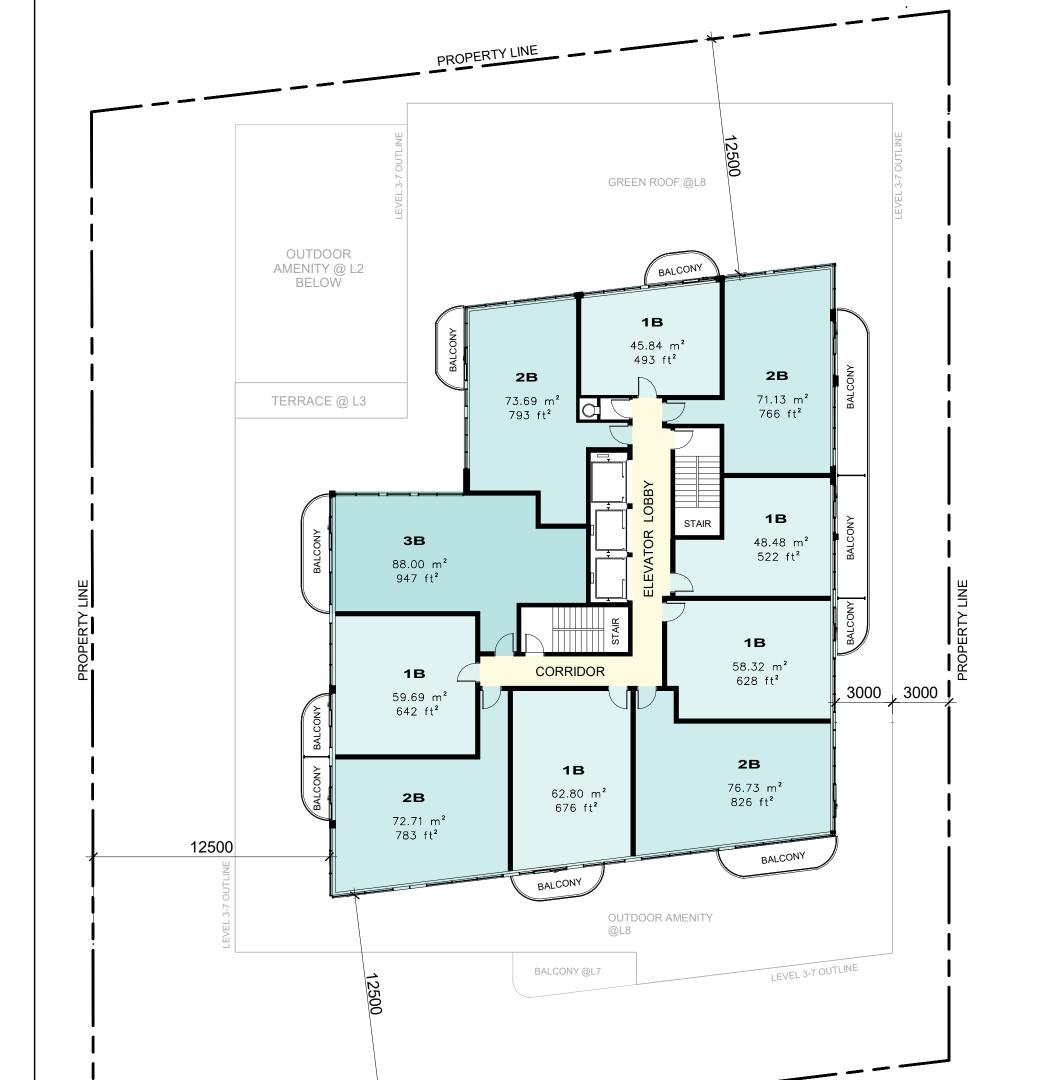

Floor Plan - Level 9-29

Scale: 1 : 200

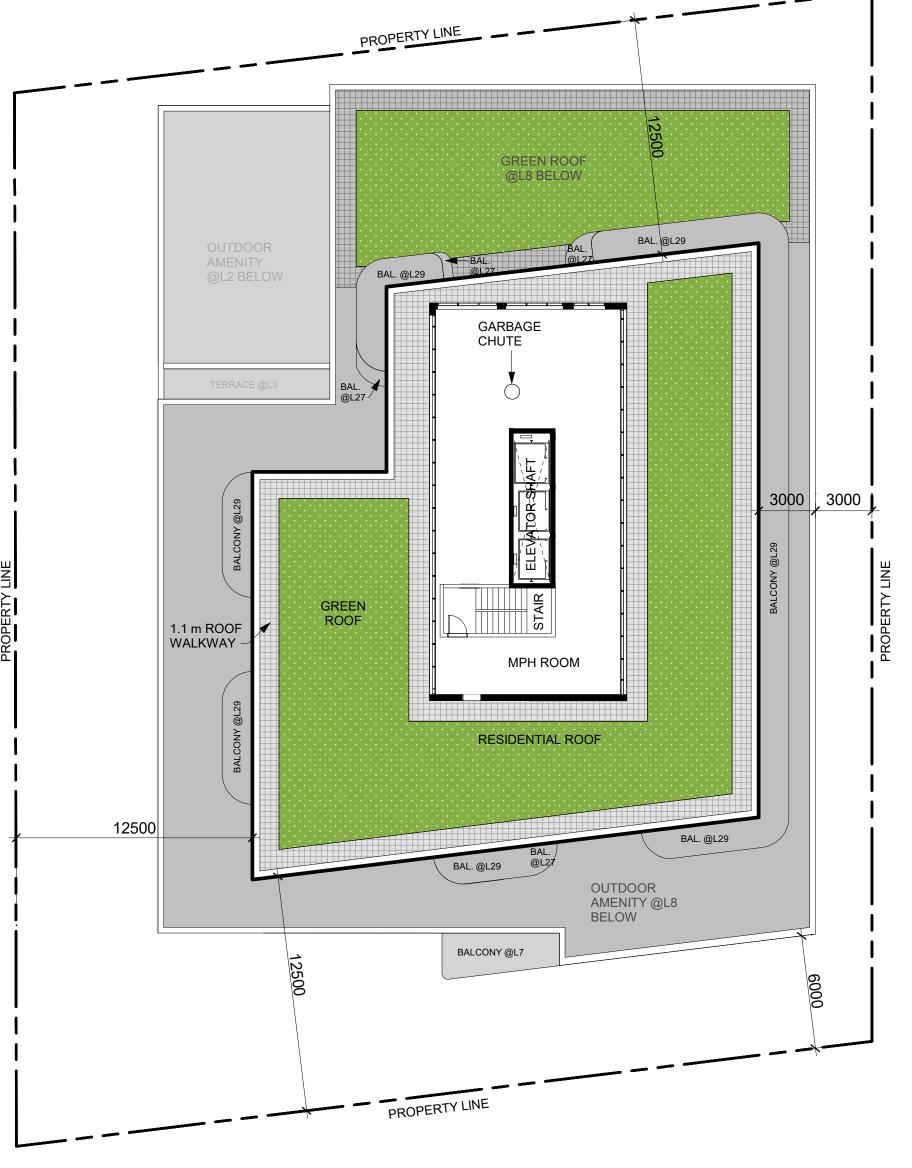

Residential Roof
Scale: 1:200

3 | MPH Roof Scale: 1 : 200 All Drawings, Specifications, and Related Documents are the Copyright of the Architect. The Architect retains all rights to control all uses of these documents for the intended issuance/use as identified below. Reproduction of these Documents, without permission from the Architect, is strictly prohibited. The Authorities Having Jurisdiction are permitted to use, distribute, and reproduce these drawings for the intended issuance as noted and dated below, however the extended permission to the Authorities Having Jurisdiction in no way debases or limits the Copyright of the Architect, or control of use of these documents by the Architect.

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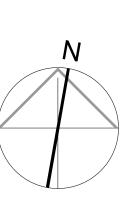
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Proposed Residential Development

Level 9-29, Residential MPH Roof Floor Plan



19-120

Date:
Sept. 9, 2024


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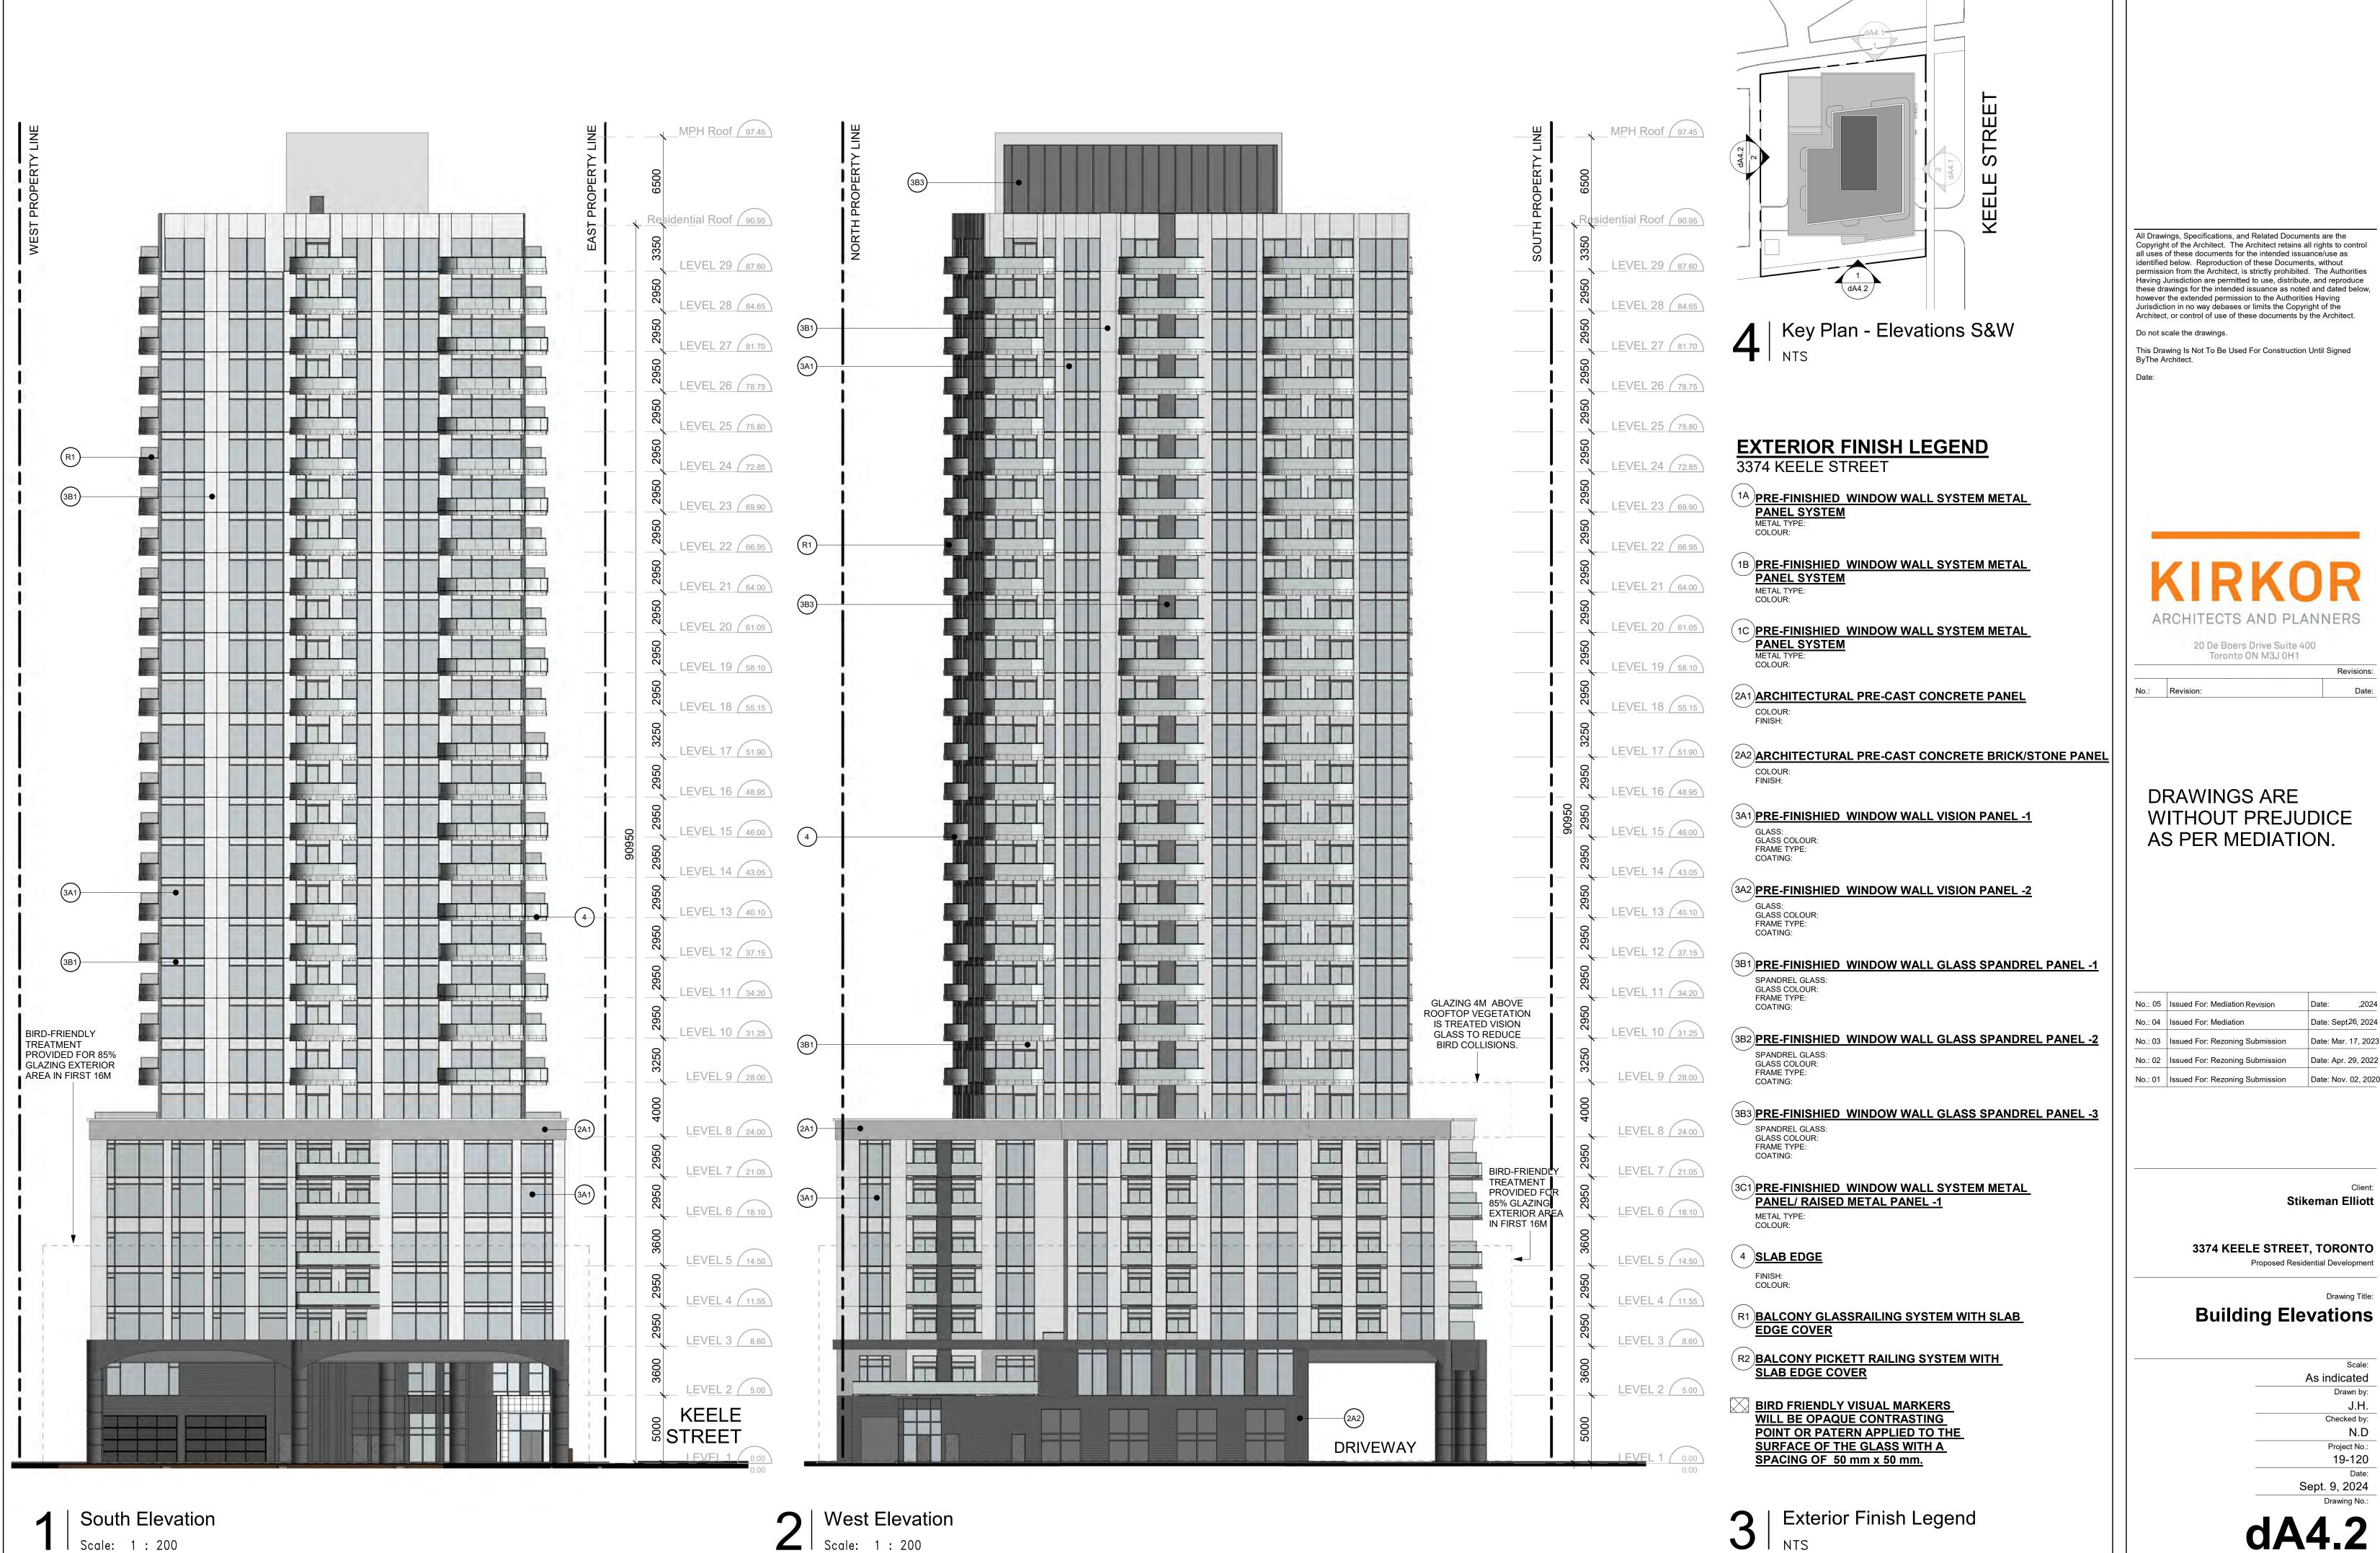
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Project No.:

dA2.4








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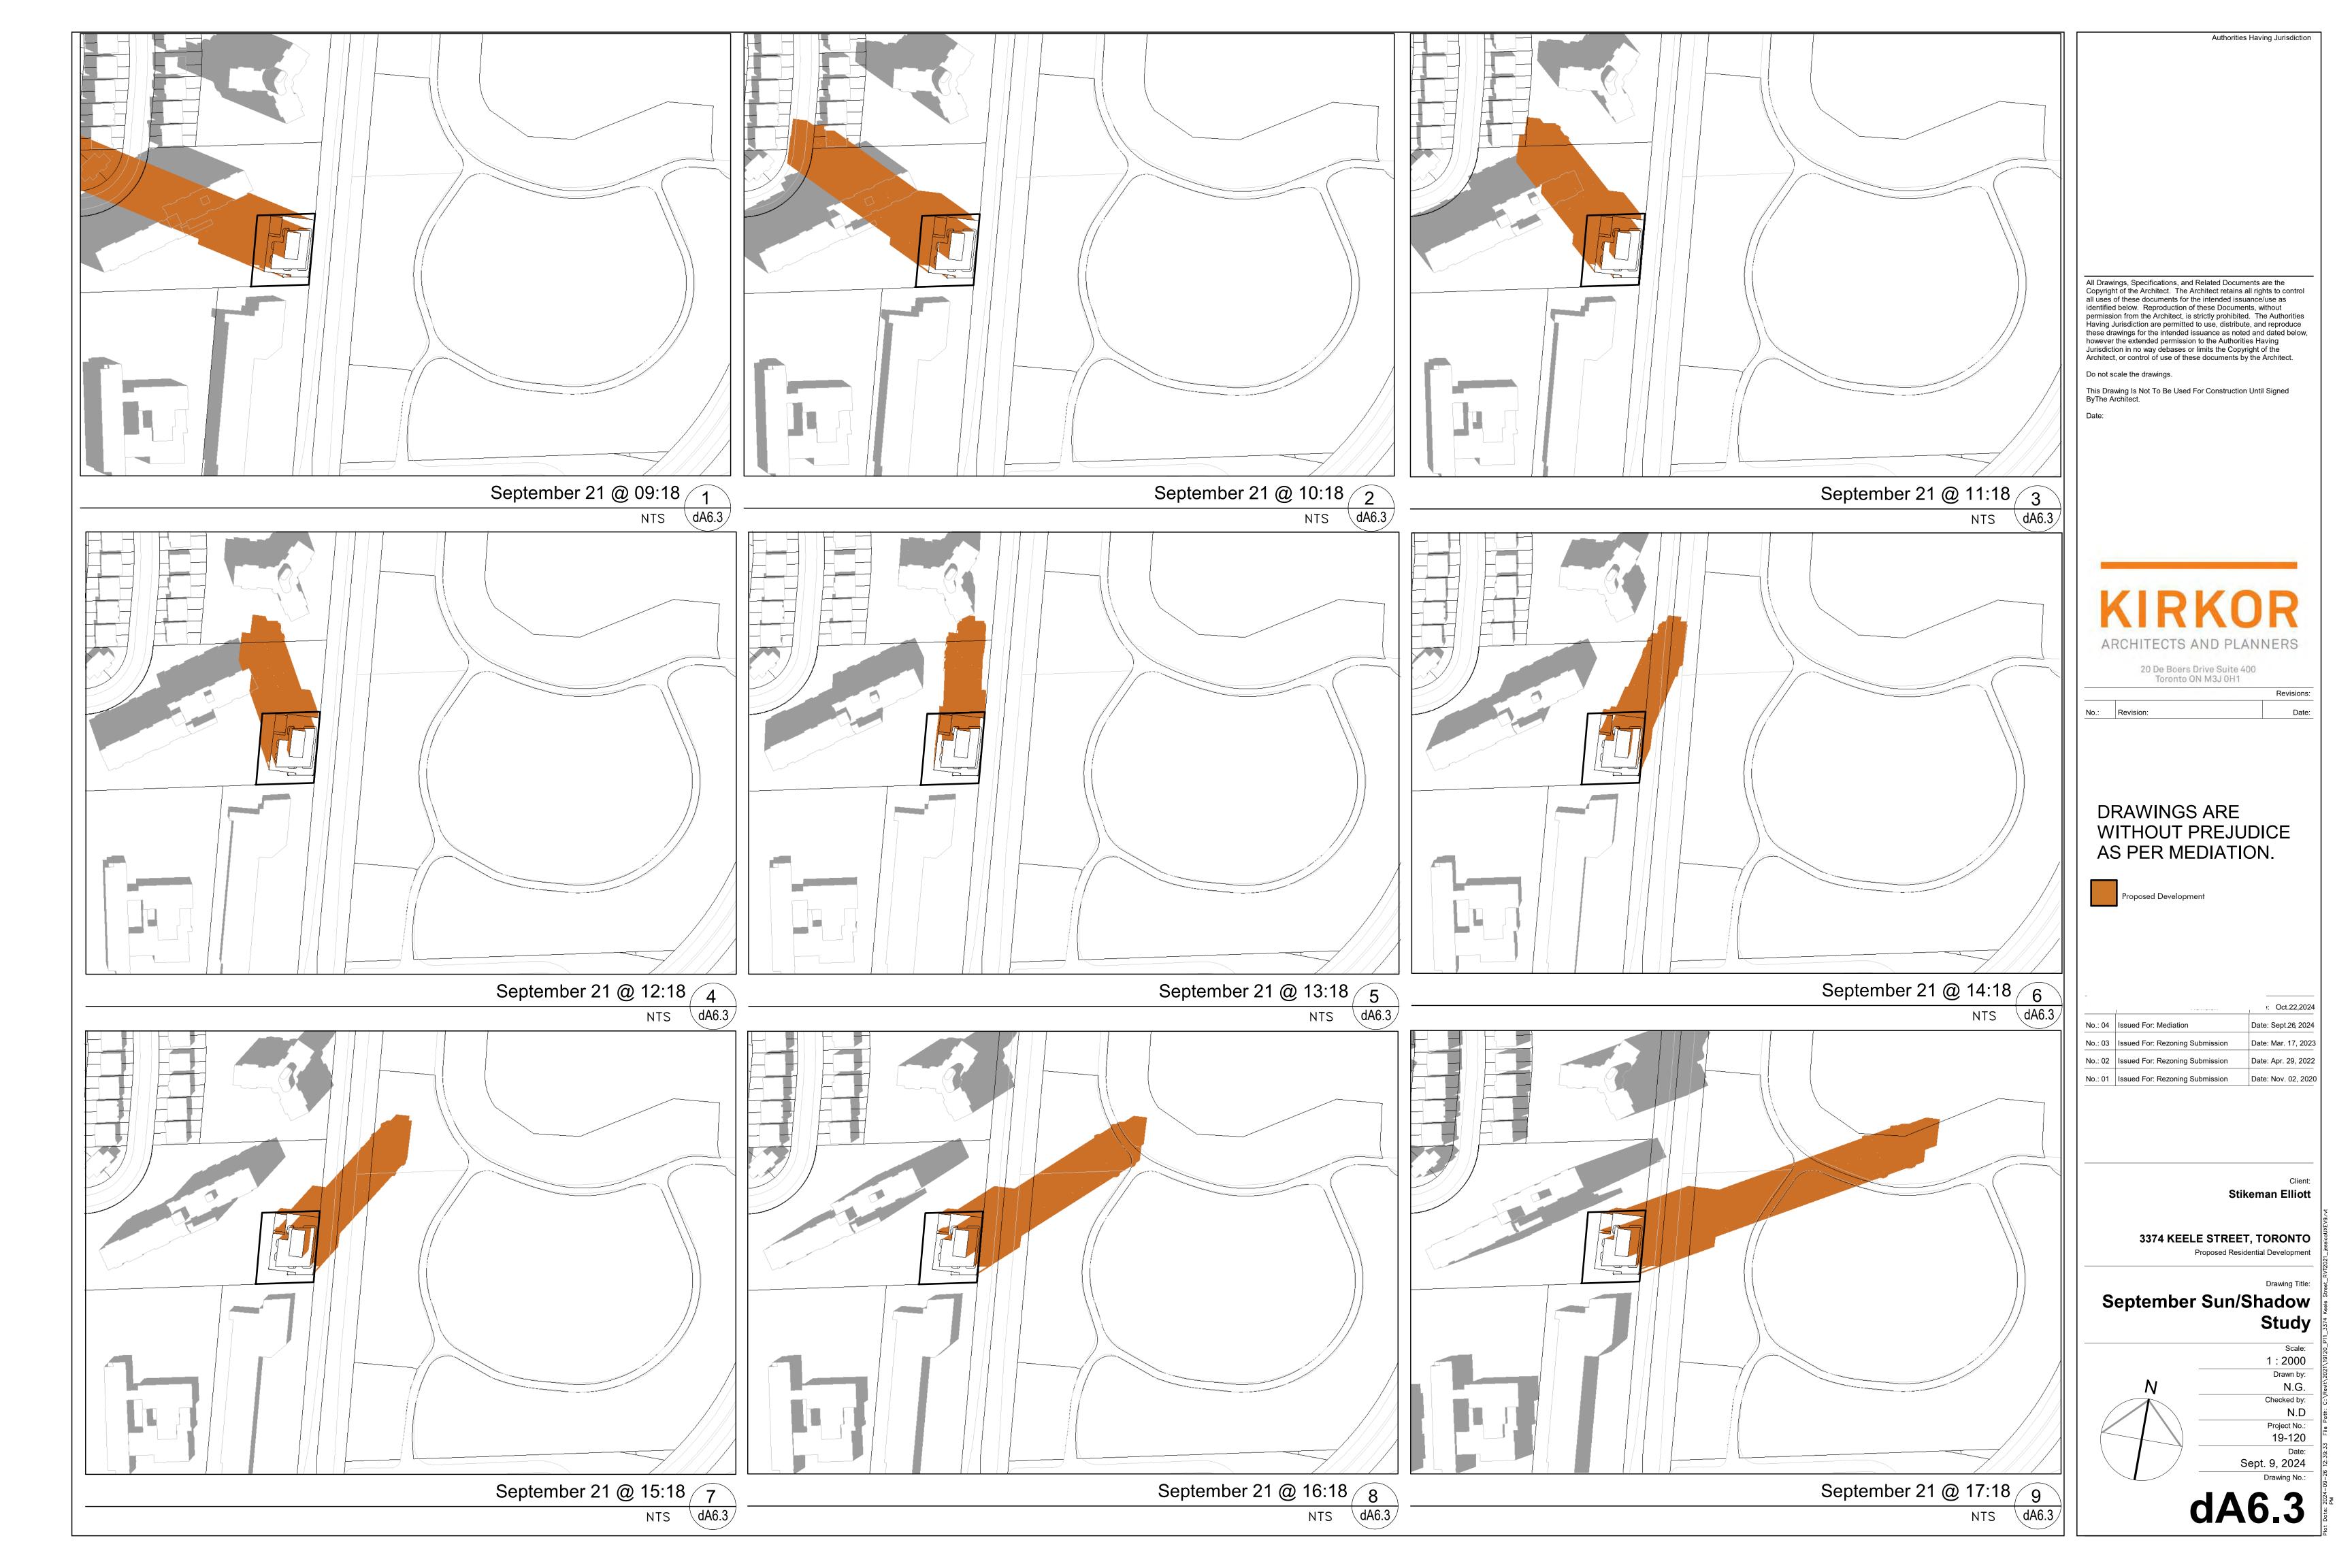
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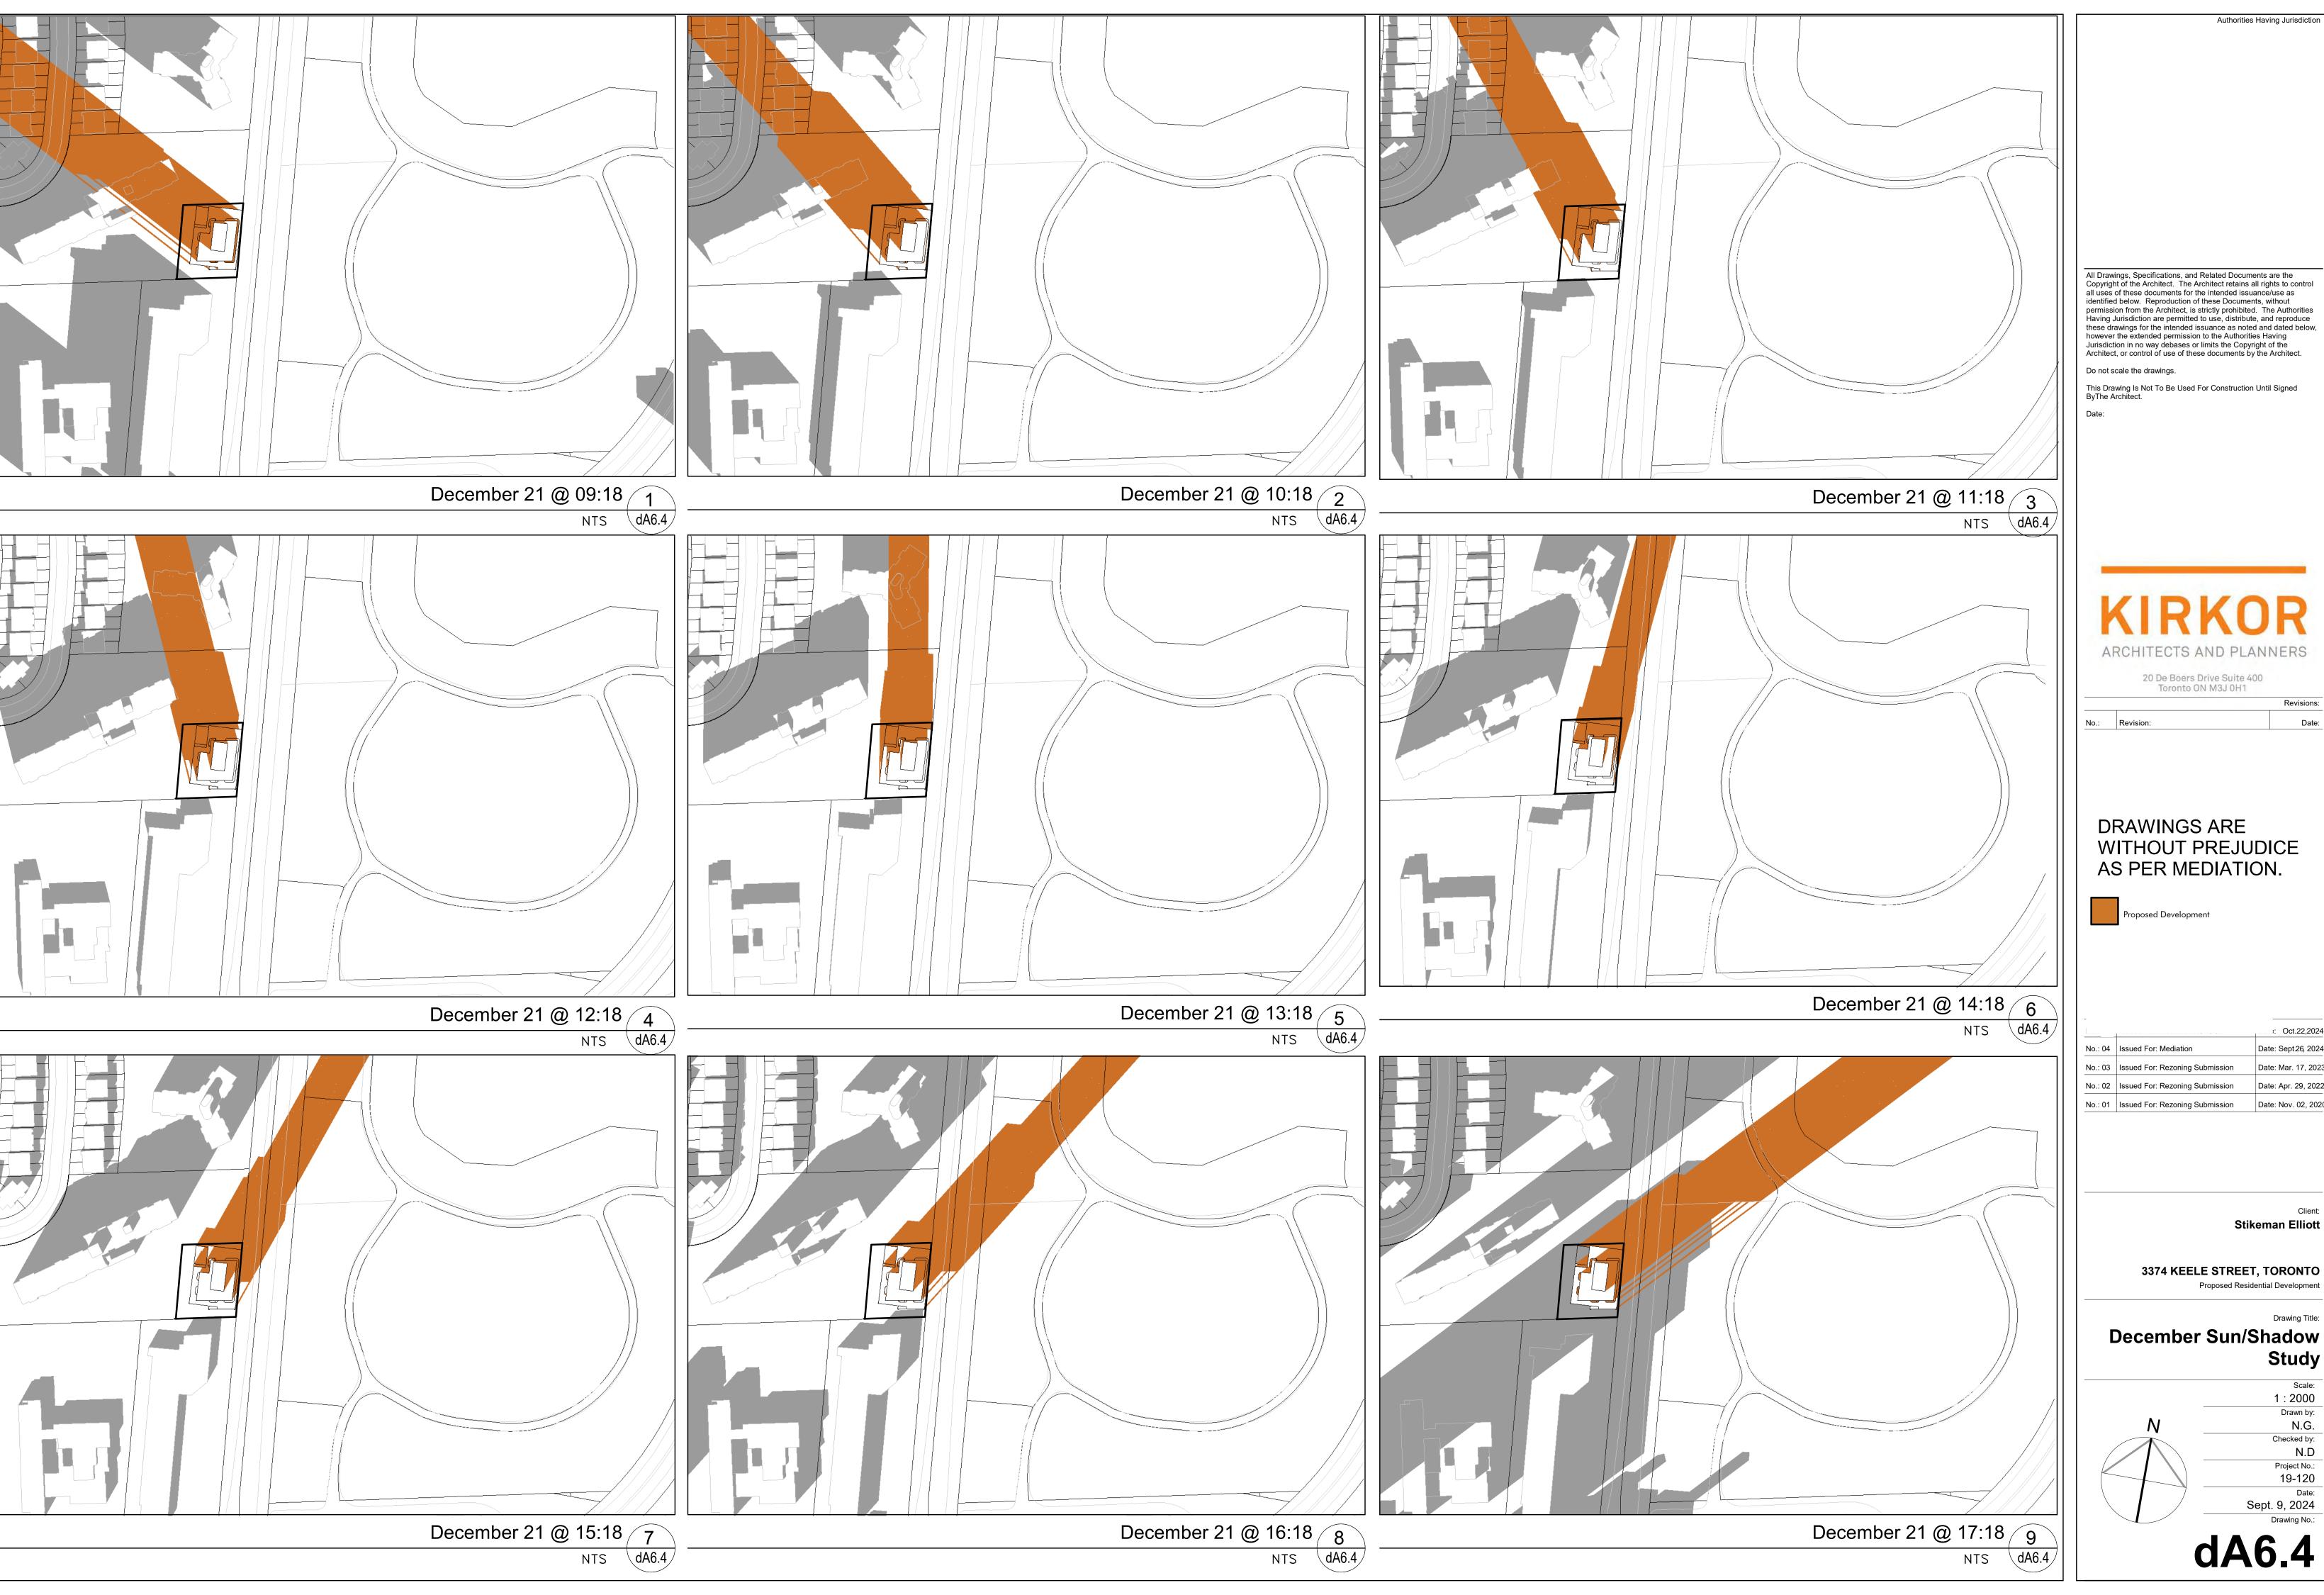
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Date: Nov. 02, 2020
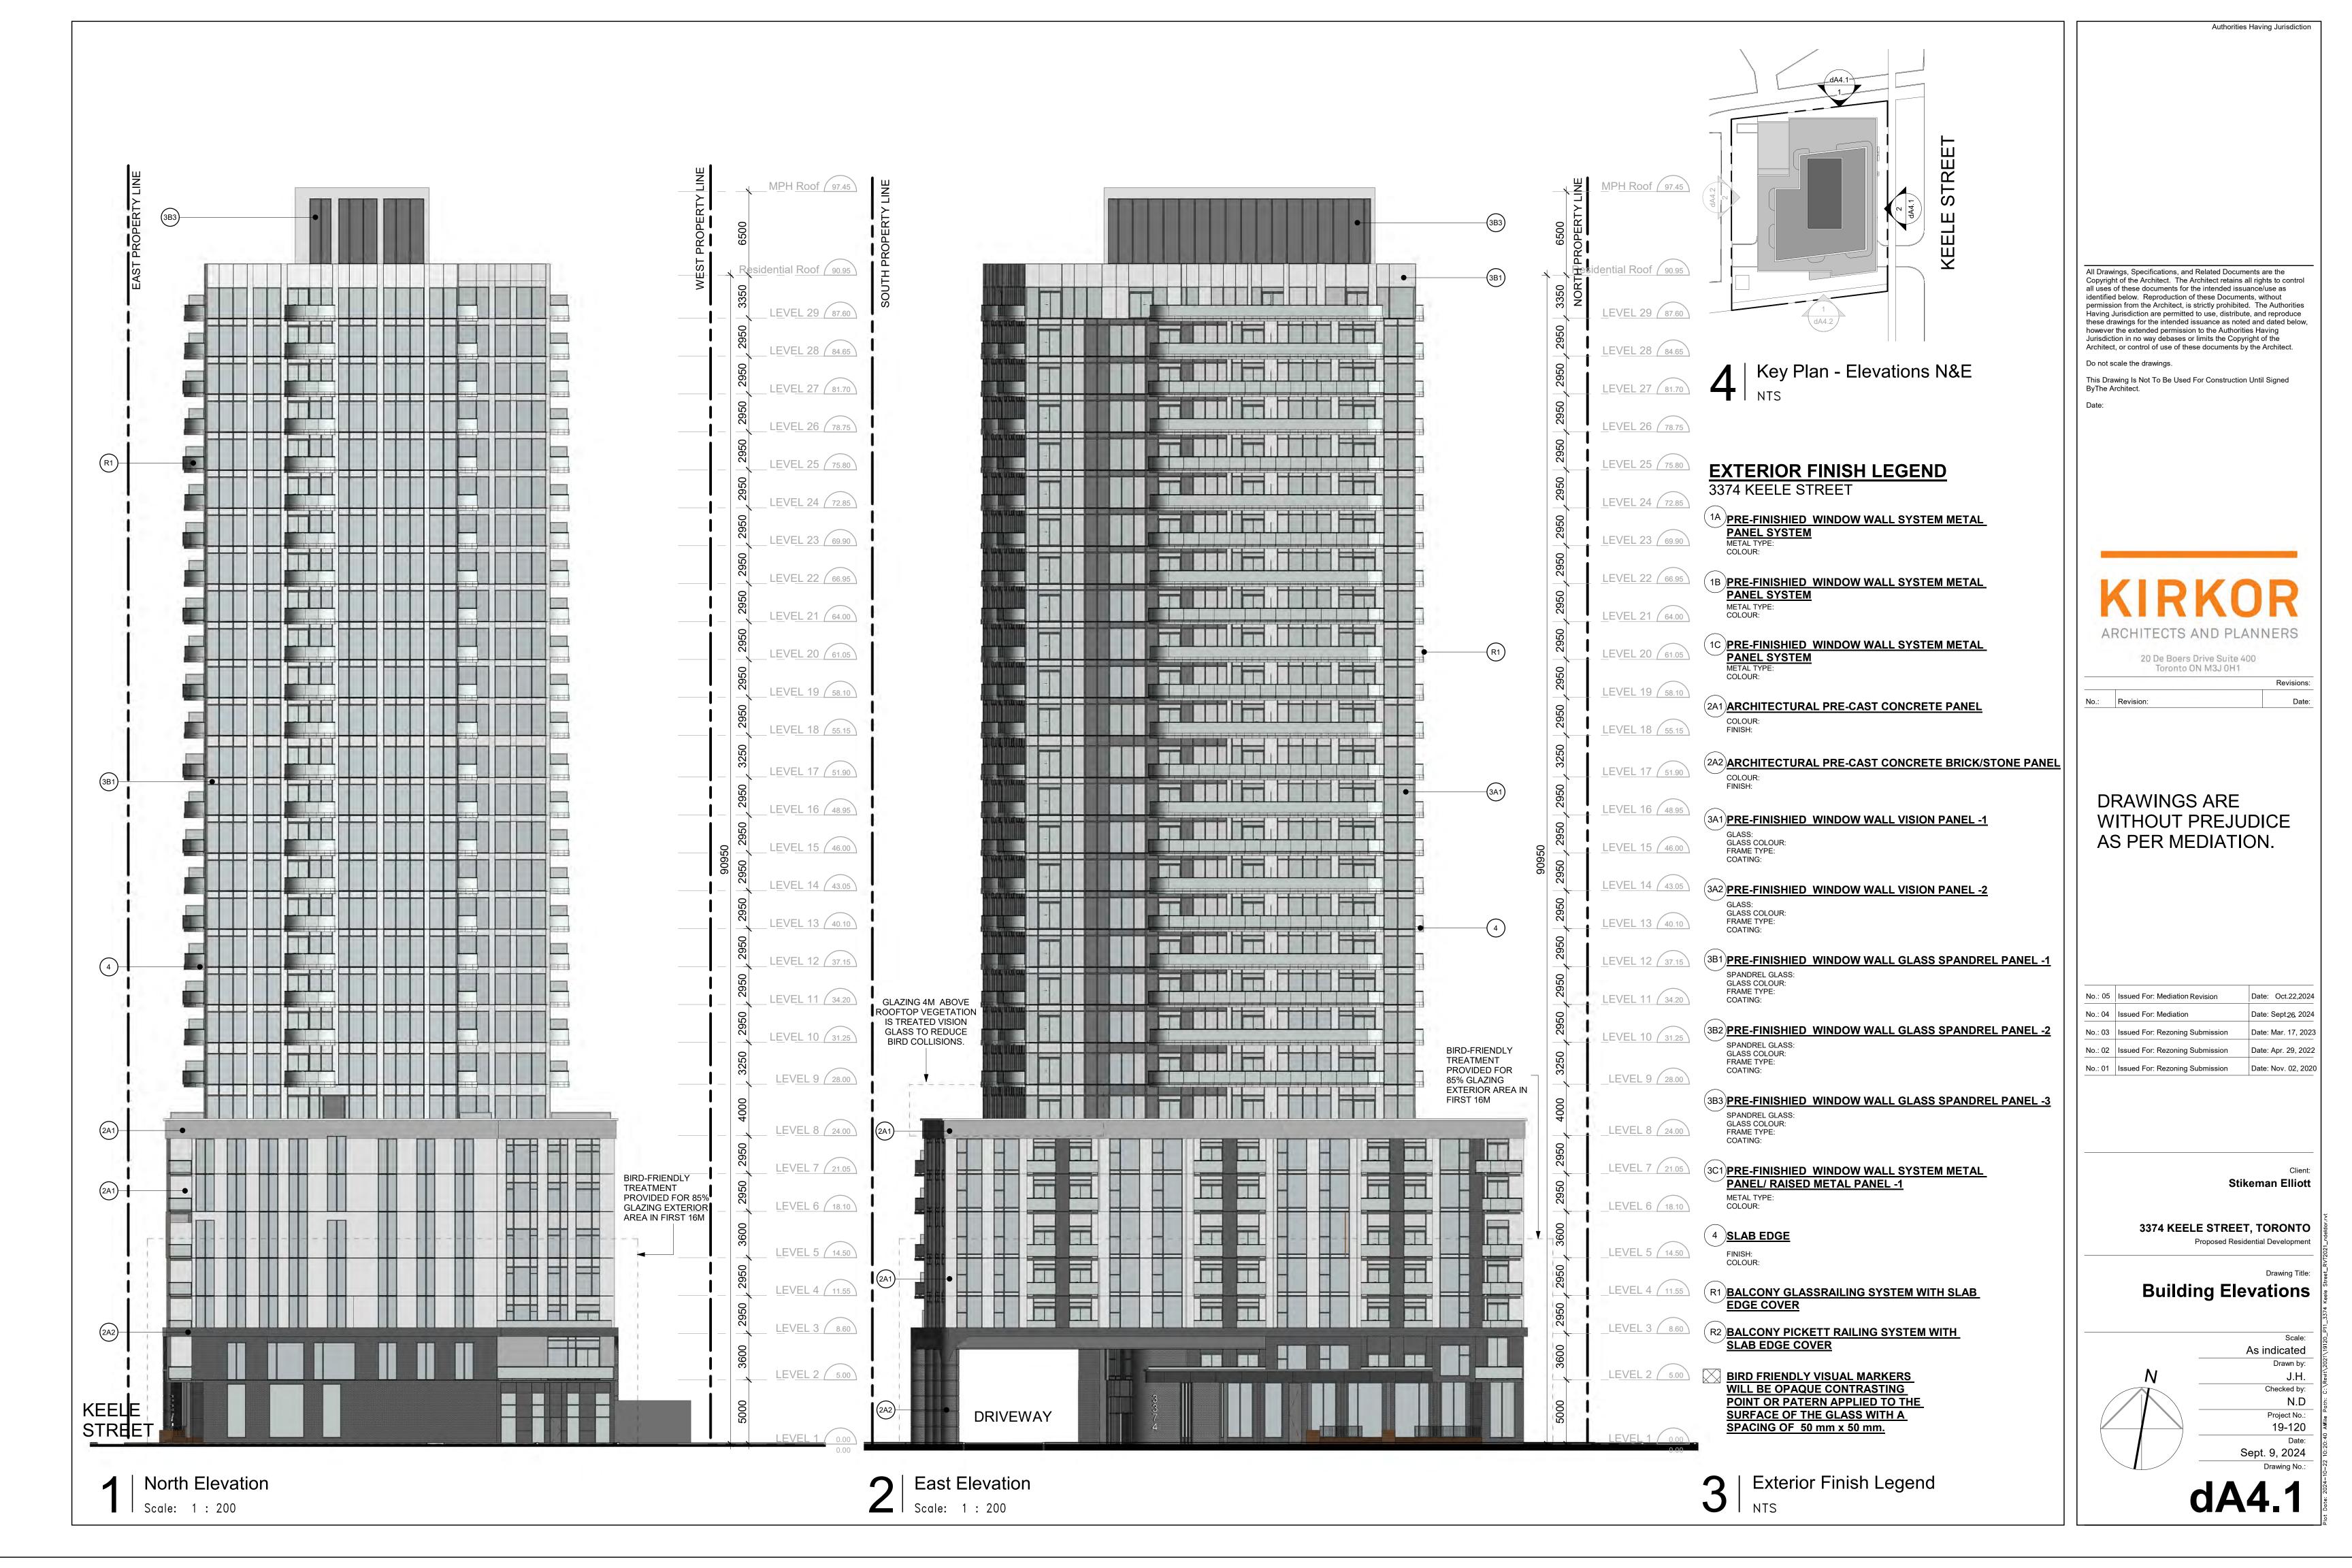
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Proposed Residential Development Drawing Title:

December Sun/Shadow Study

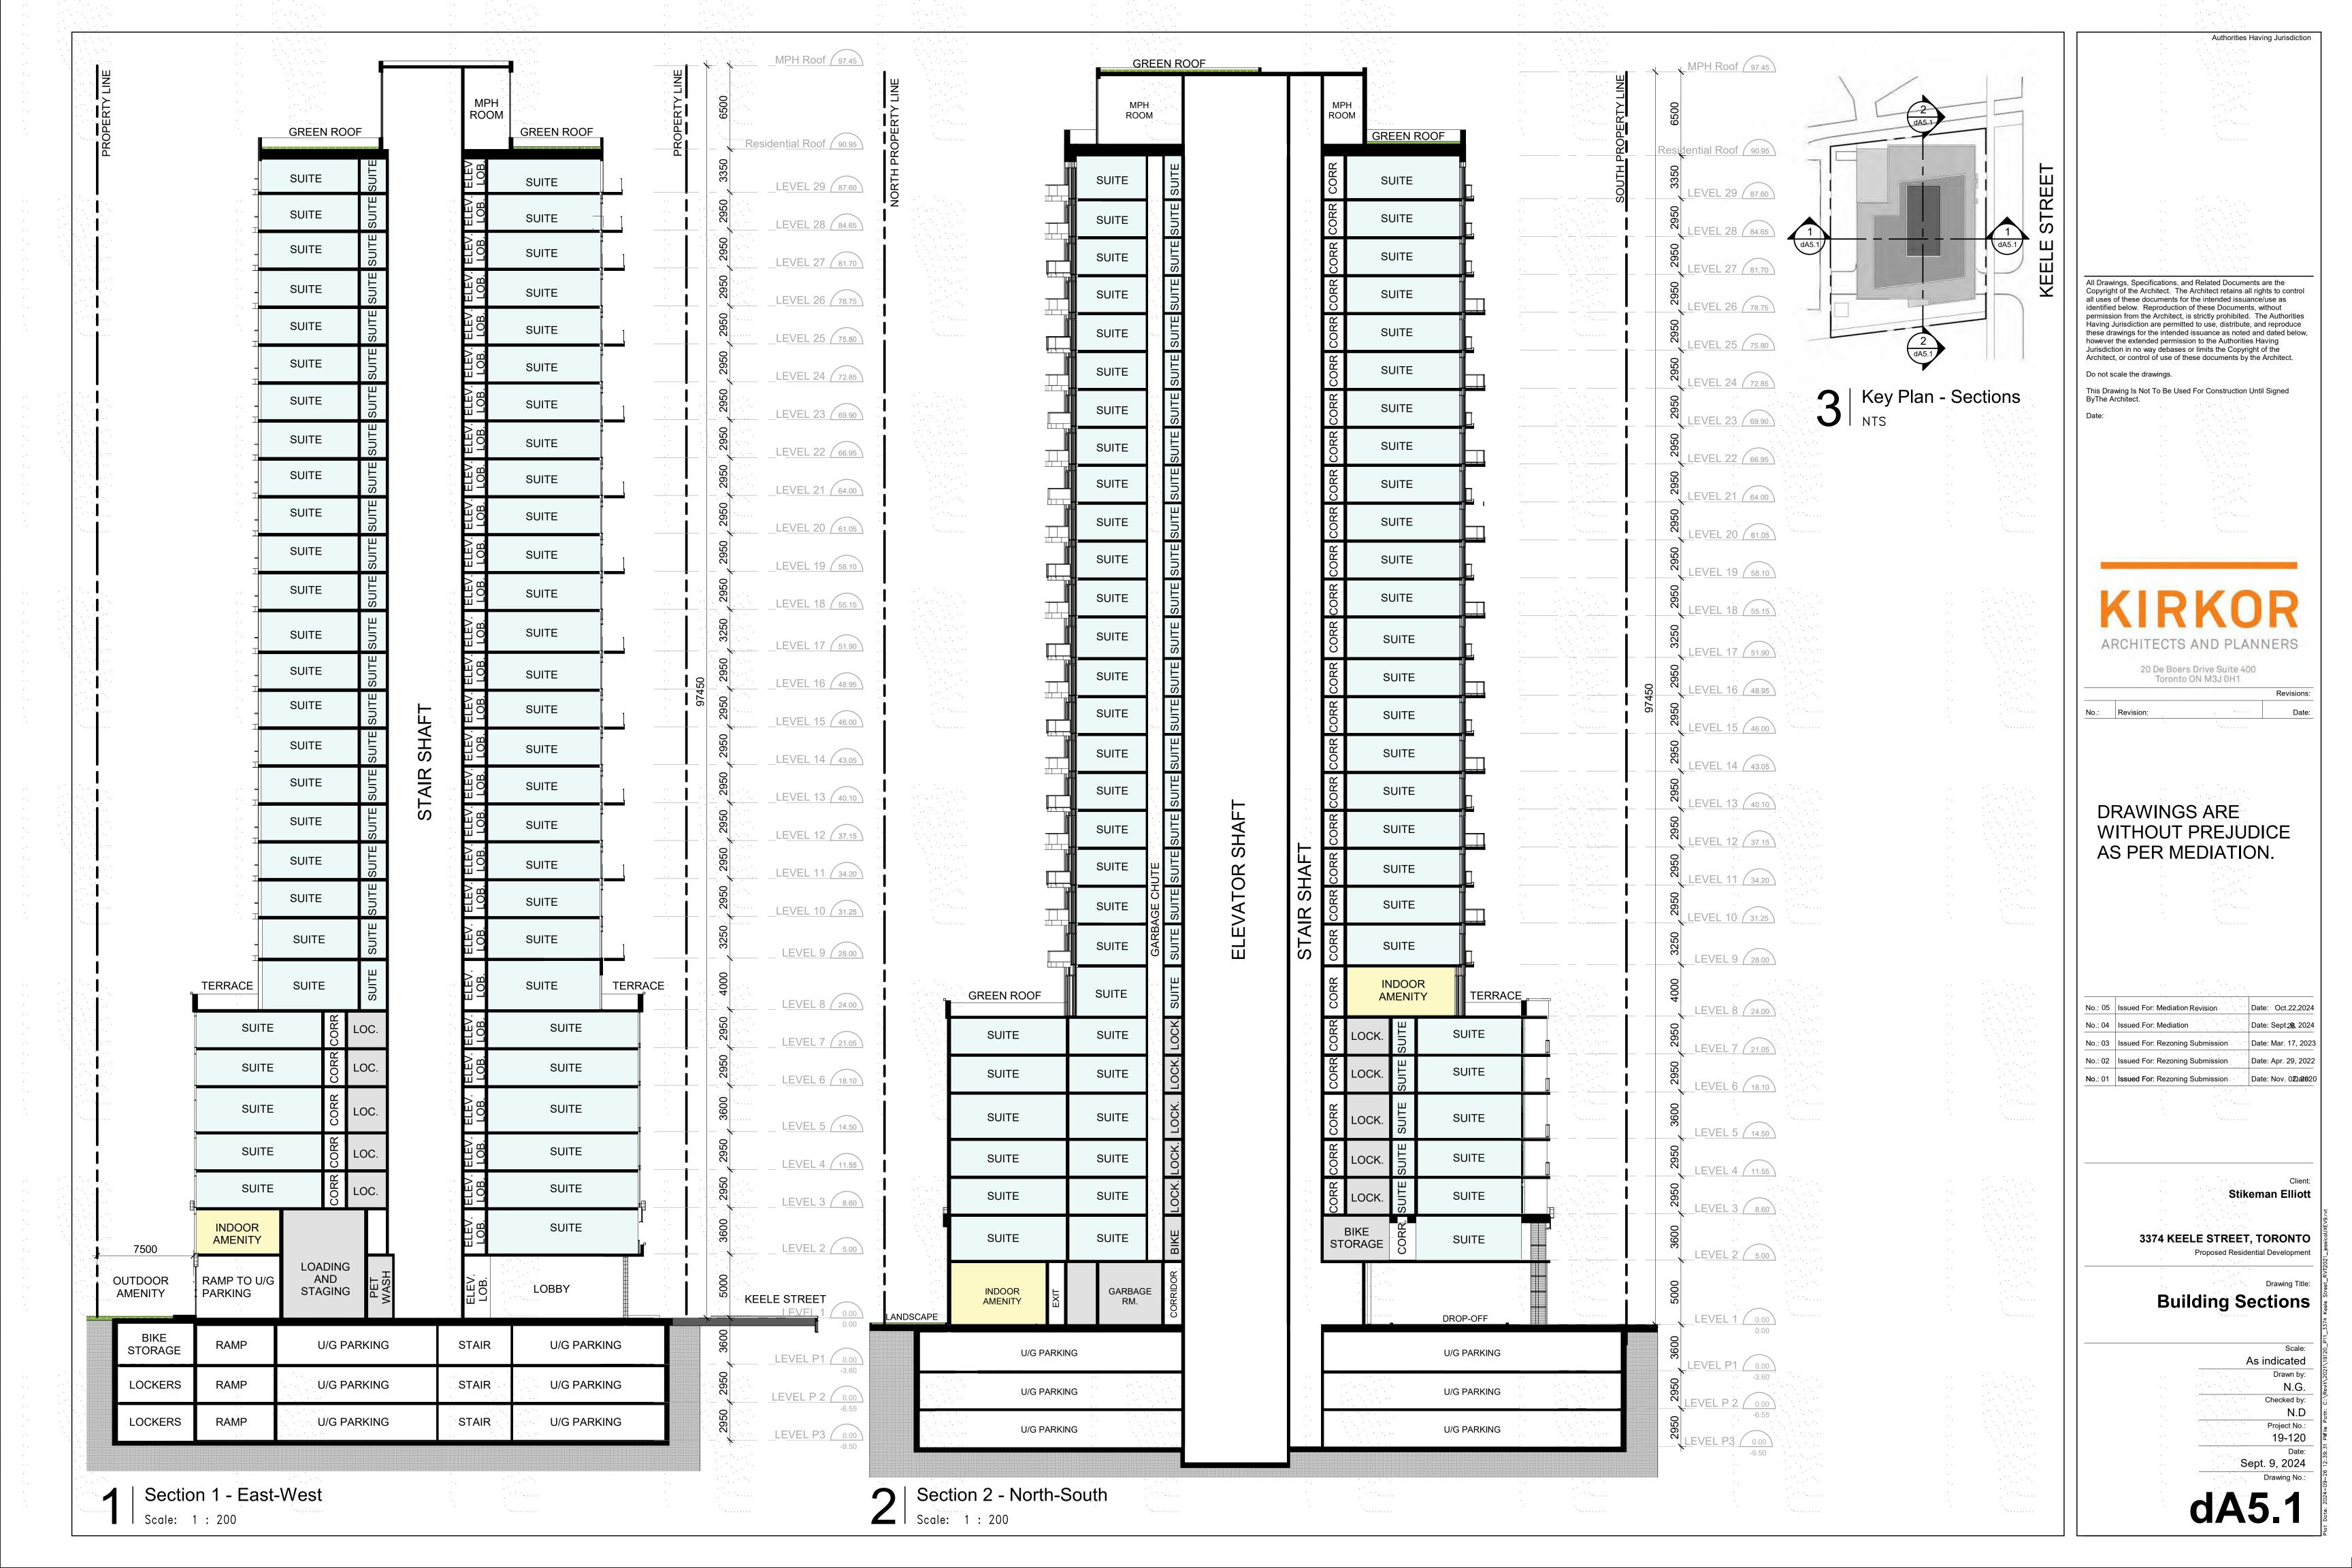Scale: 1:2000 Drawn by: N.G. Checked by: Project No.: 19-120 Date: Sept. 9, 2024 Drawing No.:

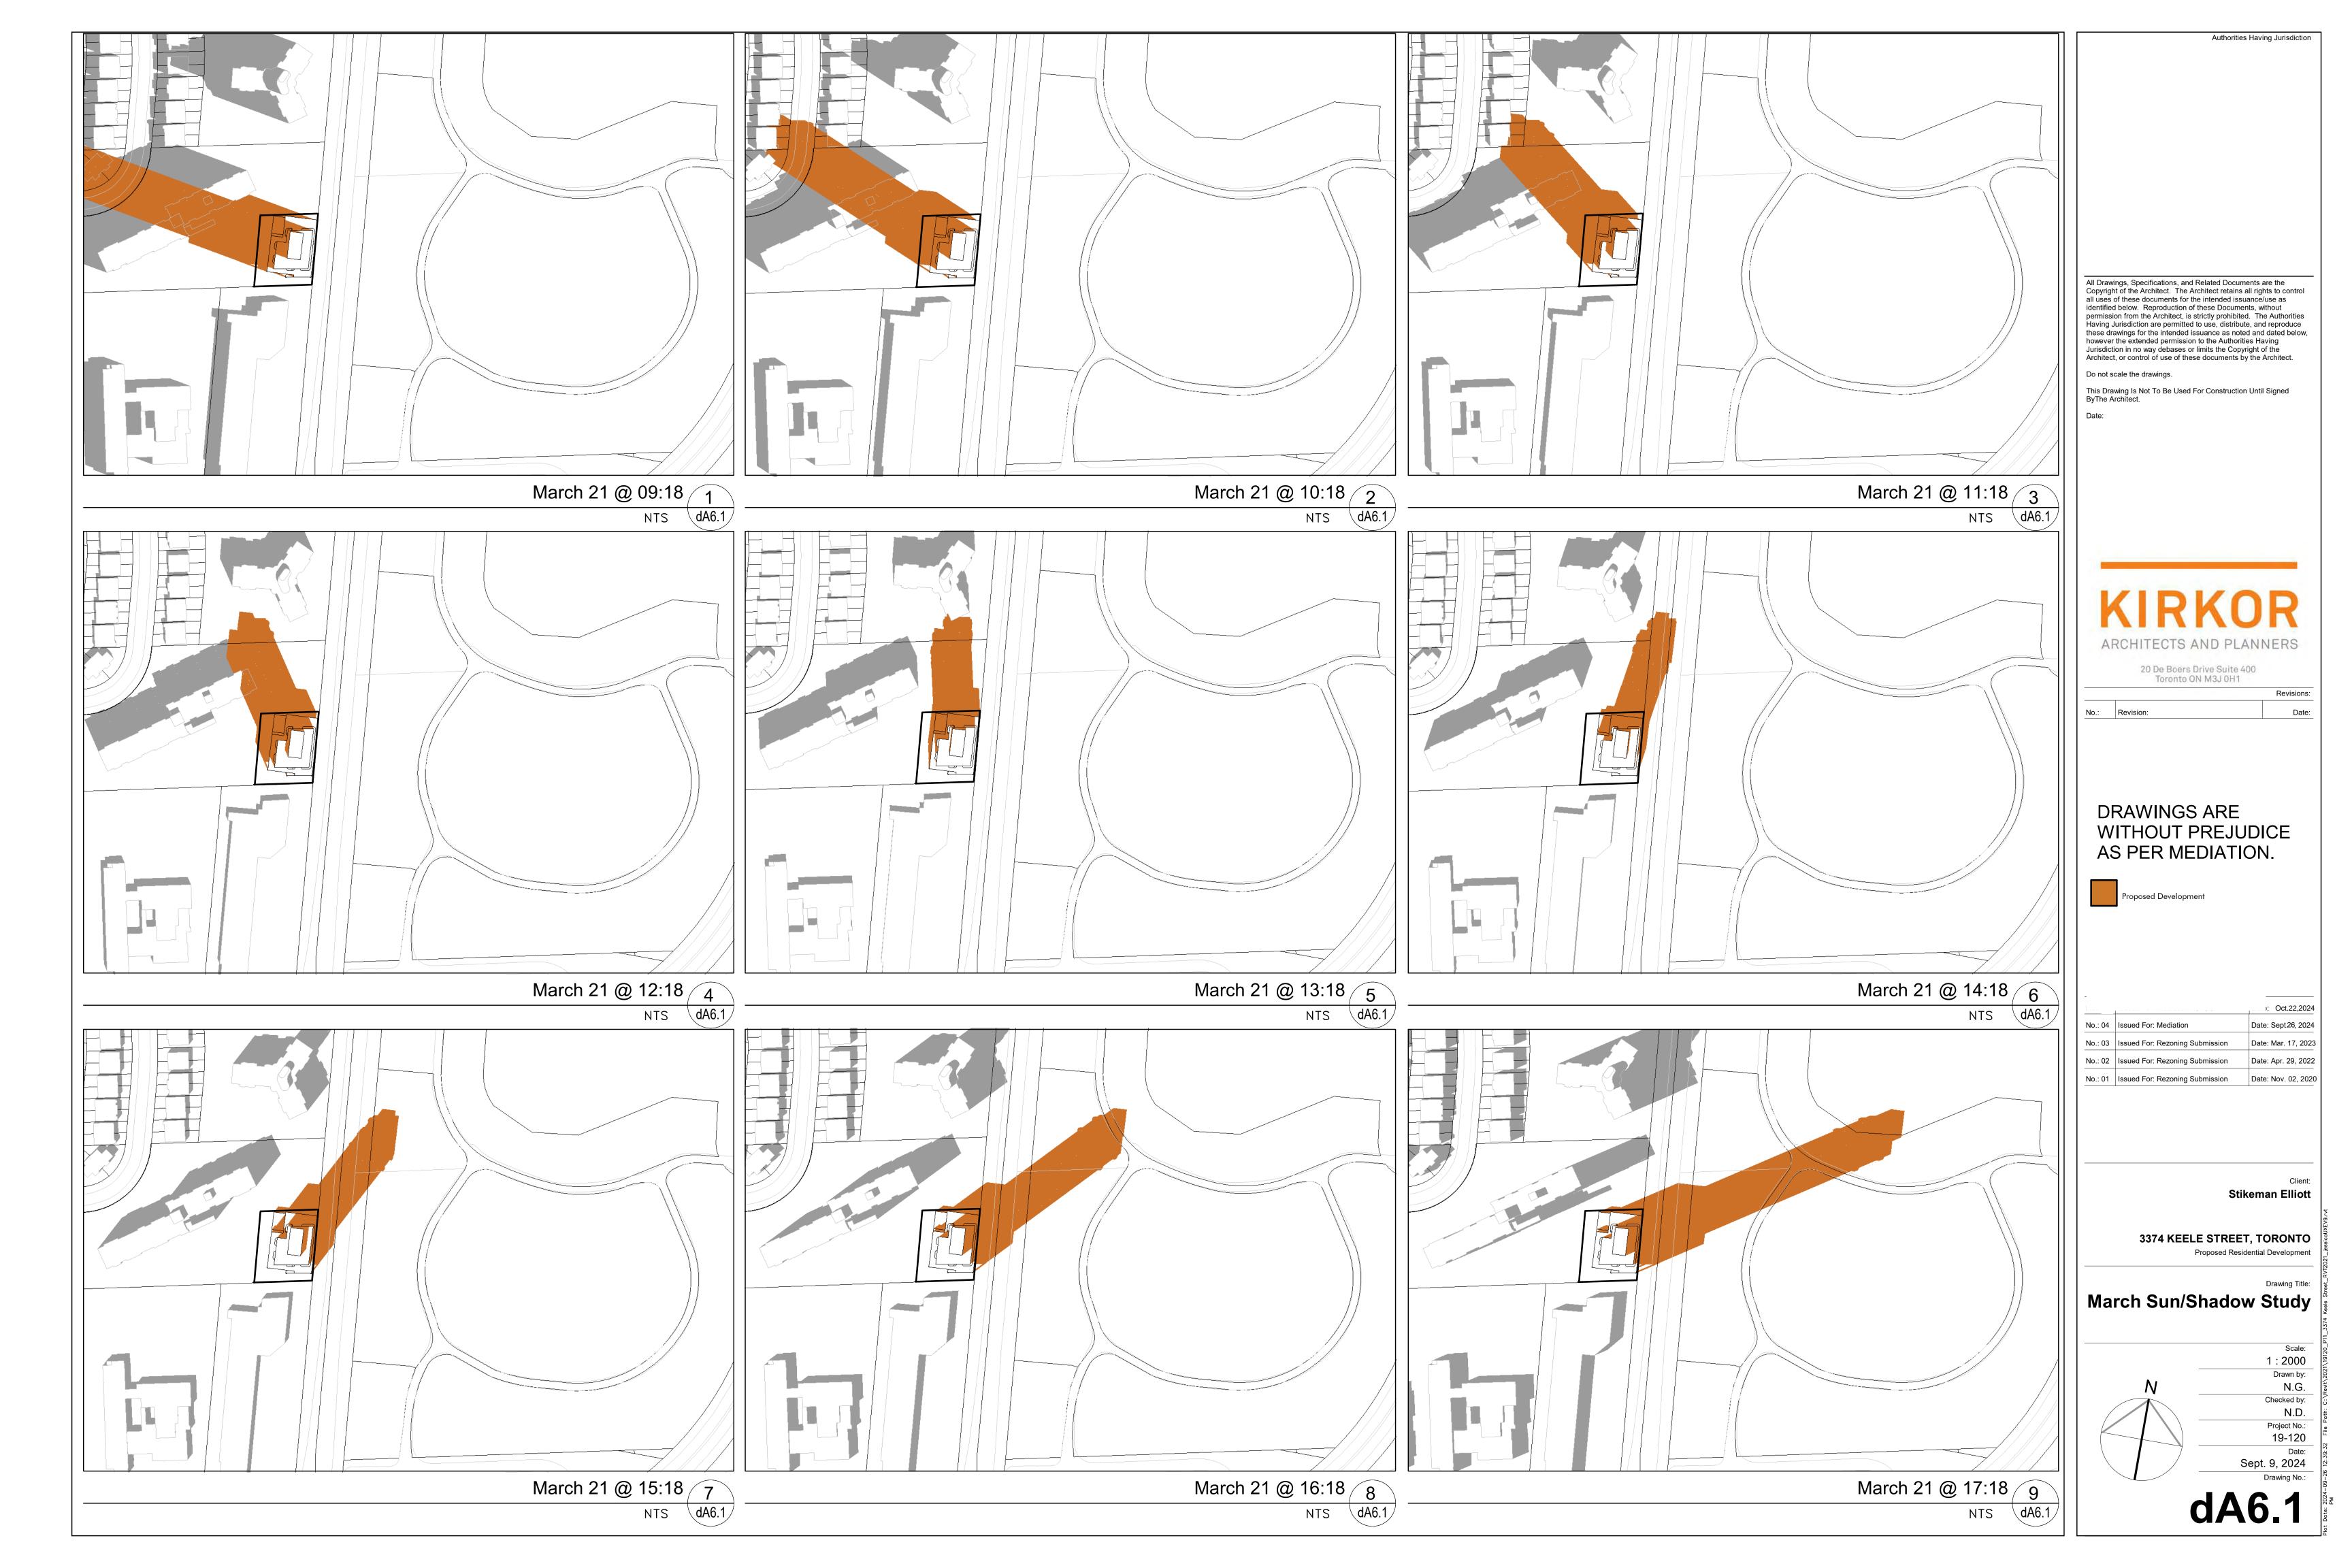dA6.4

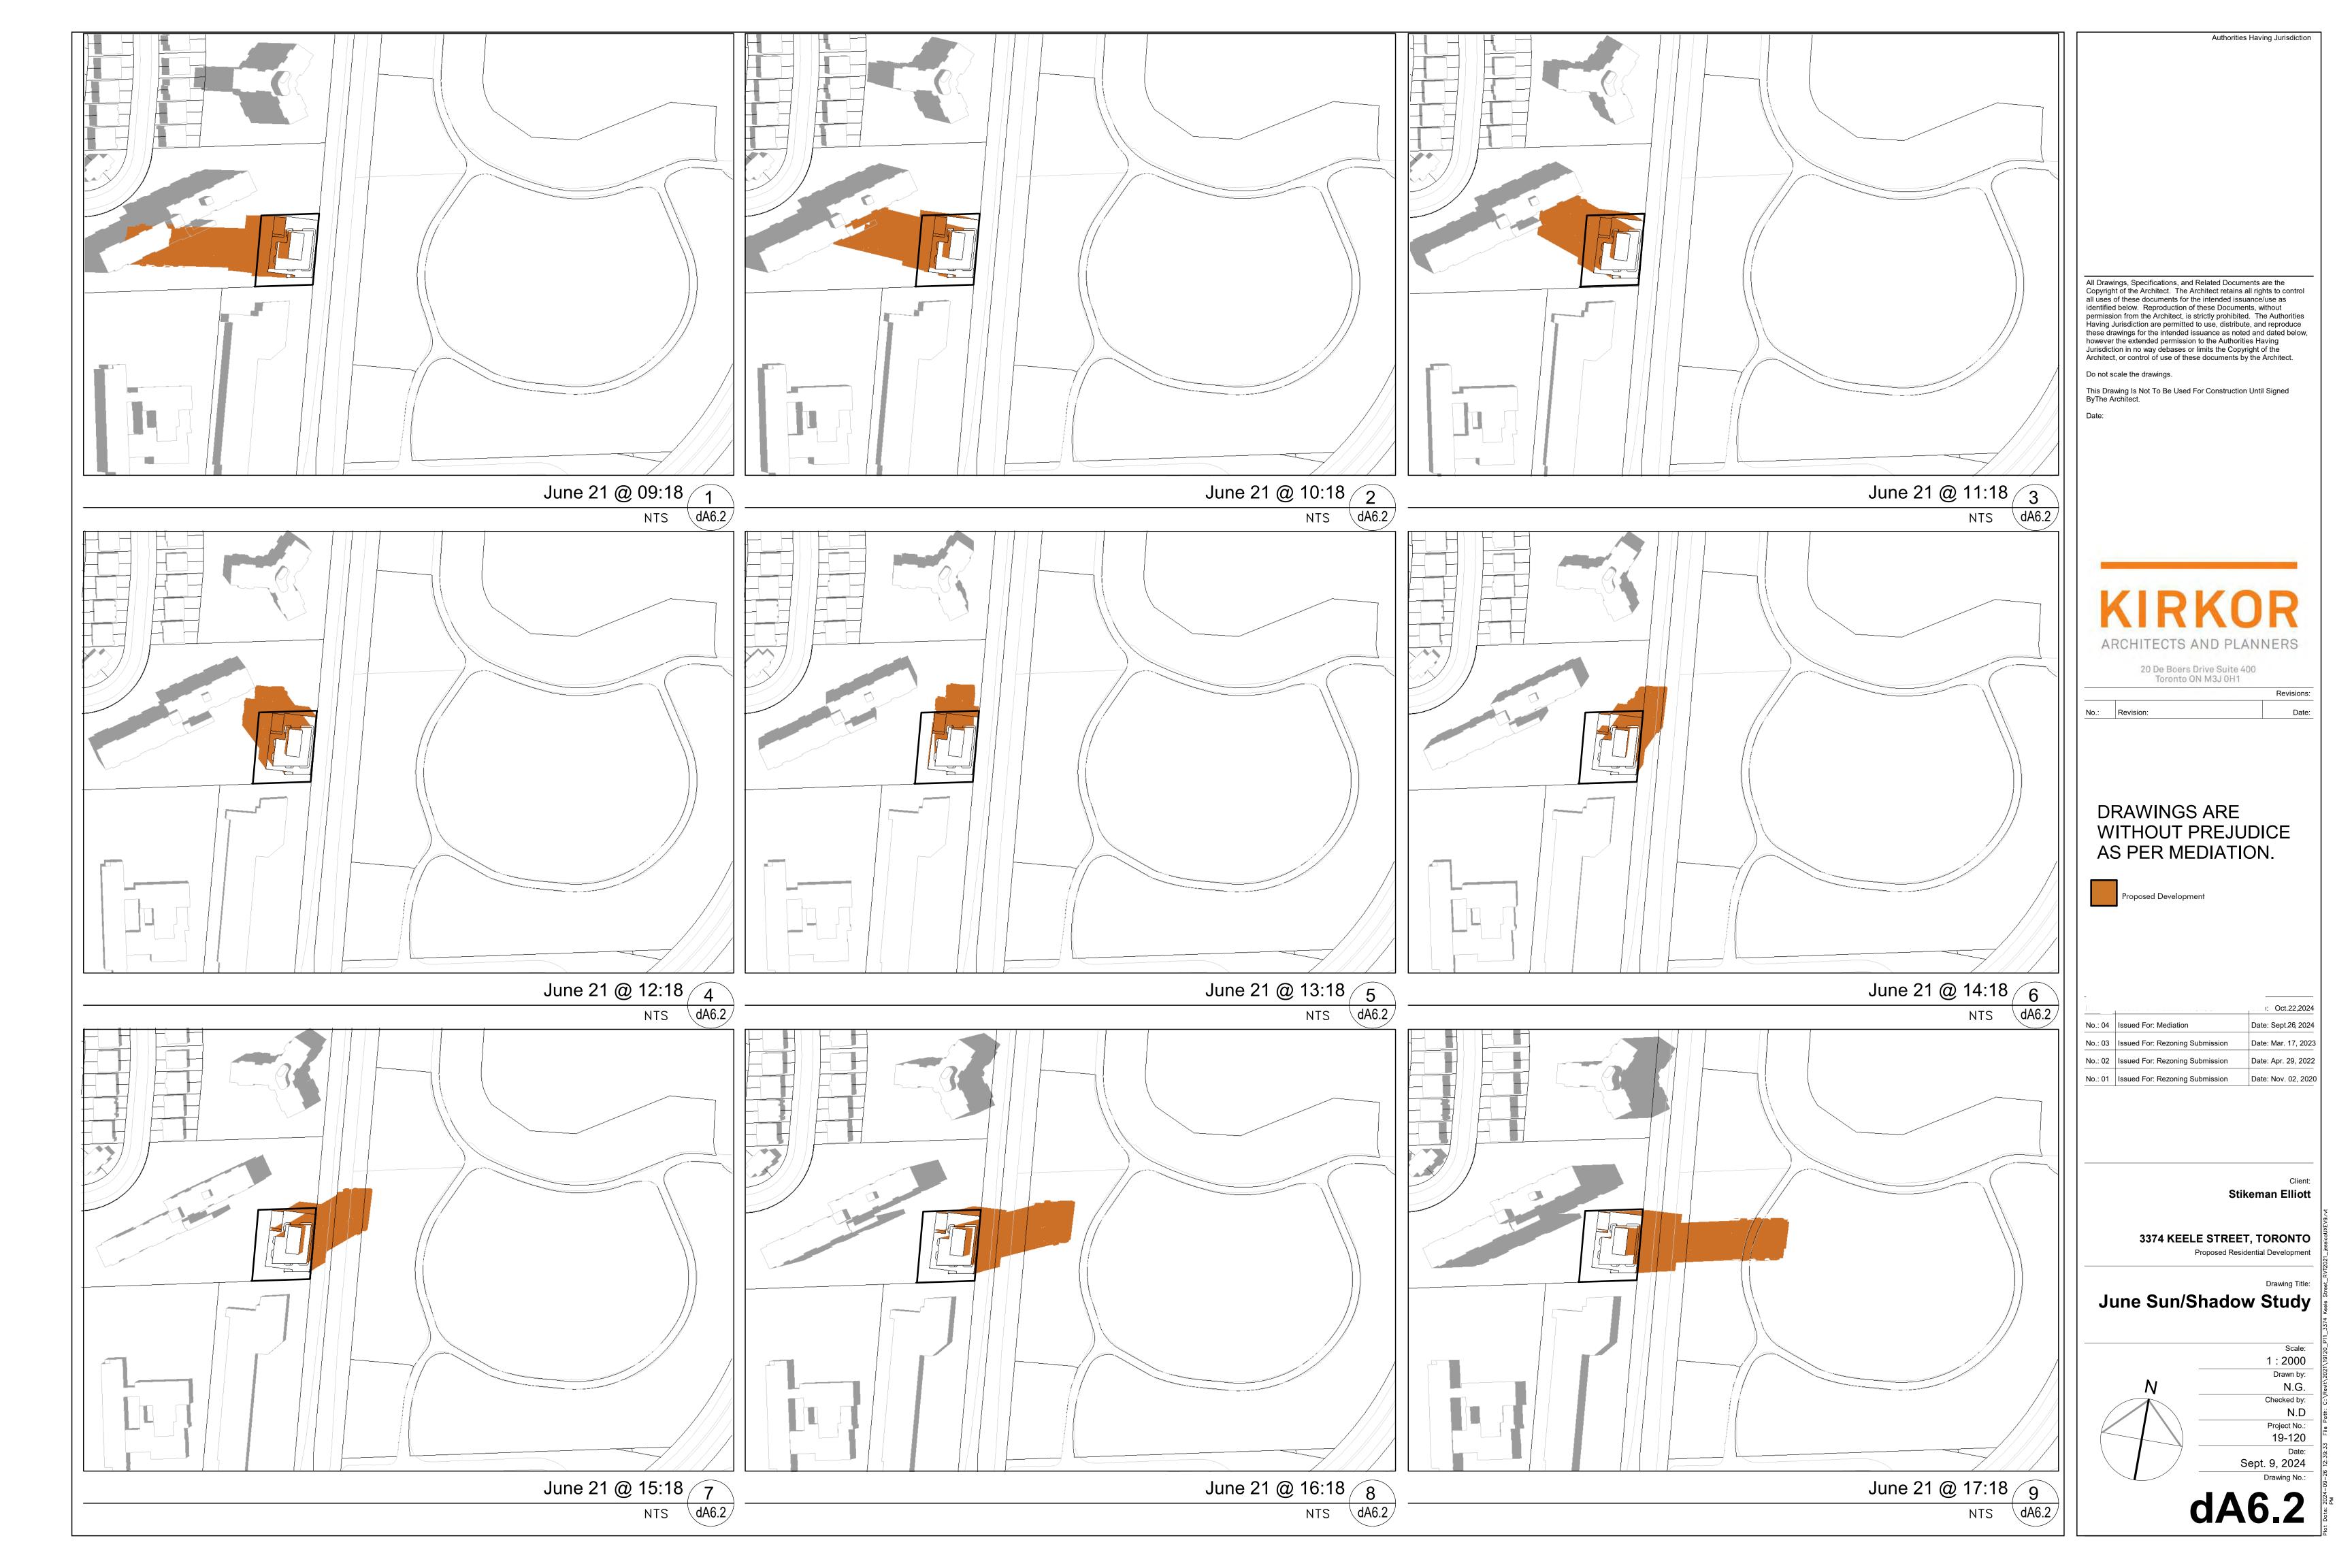

3 | Street Level View of Driveway





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Perspectives

Checked by: Project No.: 19-120

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dA7.1