1930-1938 BLOOR ST. WEST AND 3, 5 & 21 QUEBEC AVE.

A PROJECT OF

CLIFTON BLAKE ASSET MANAGEMENT 370 KING ST. W, SUITE 805 TORONTO, ON, M5V 1J9

LANDSCAPE ARCHITECT



20 Champlain Boulevard, Suite 102 Toronto, ON M3H 2Z1

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CONSULTANTS

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TORONTO, ON, M6K 3E3

CIVIL ENGINEER LITHOS GROUP 150 BERMONDSEY ROAD TORONTO, ON, M4A 1Y1

STAMP



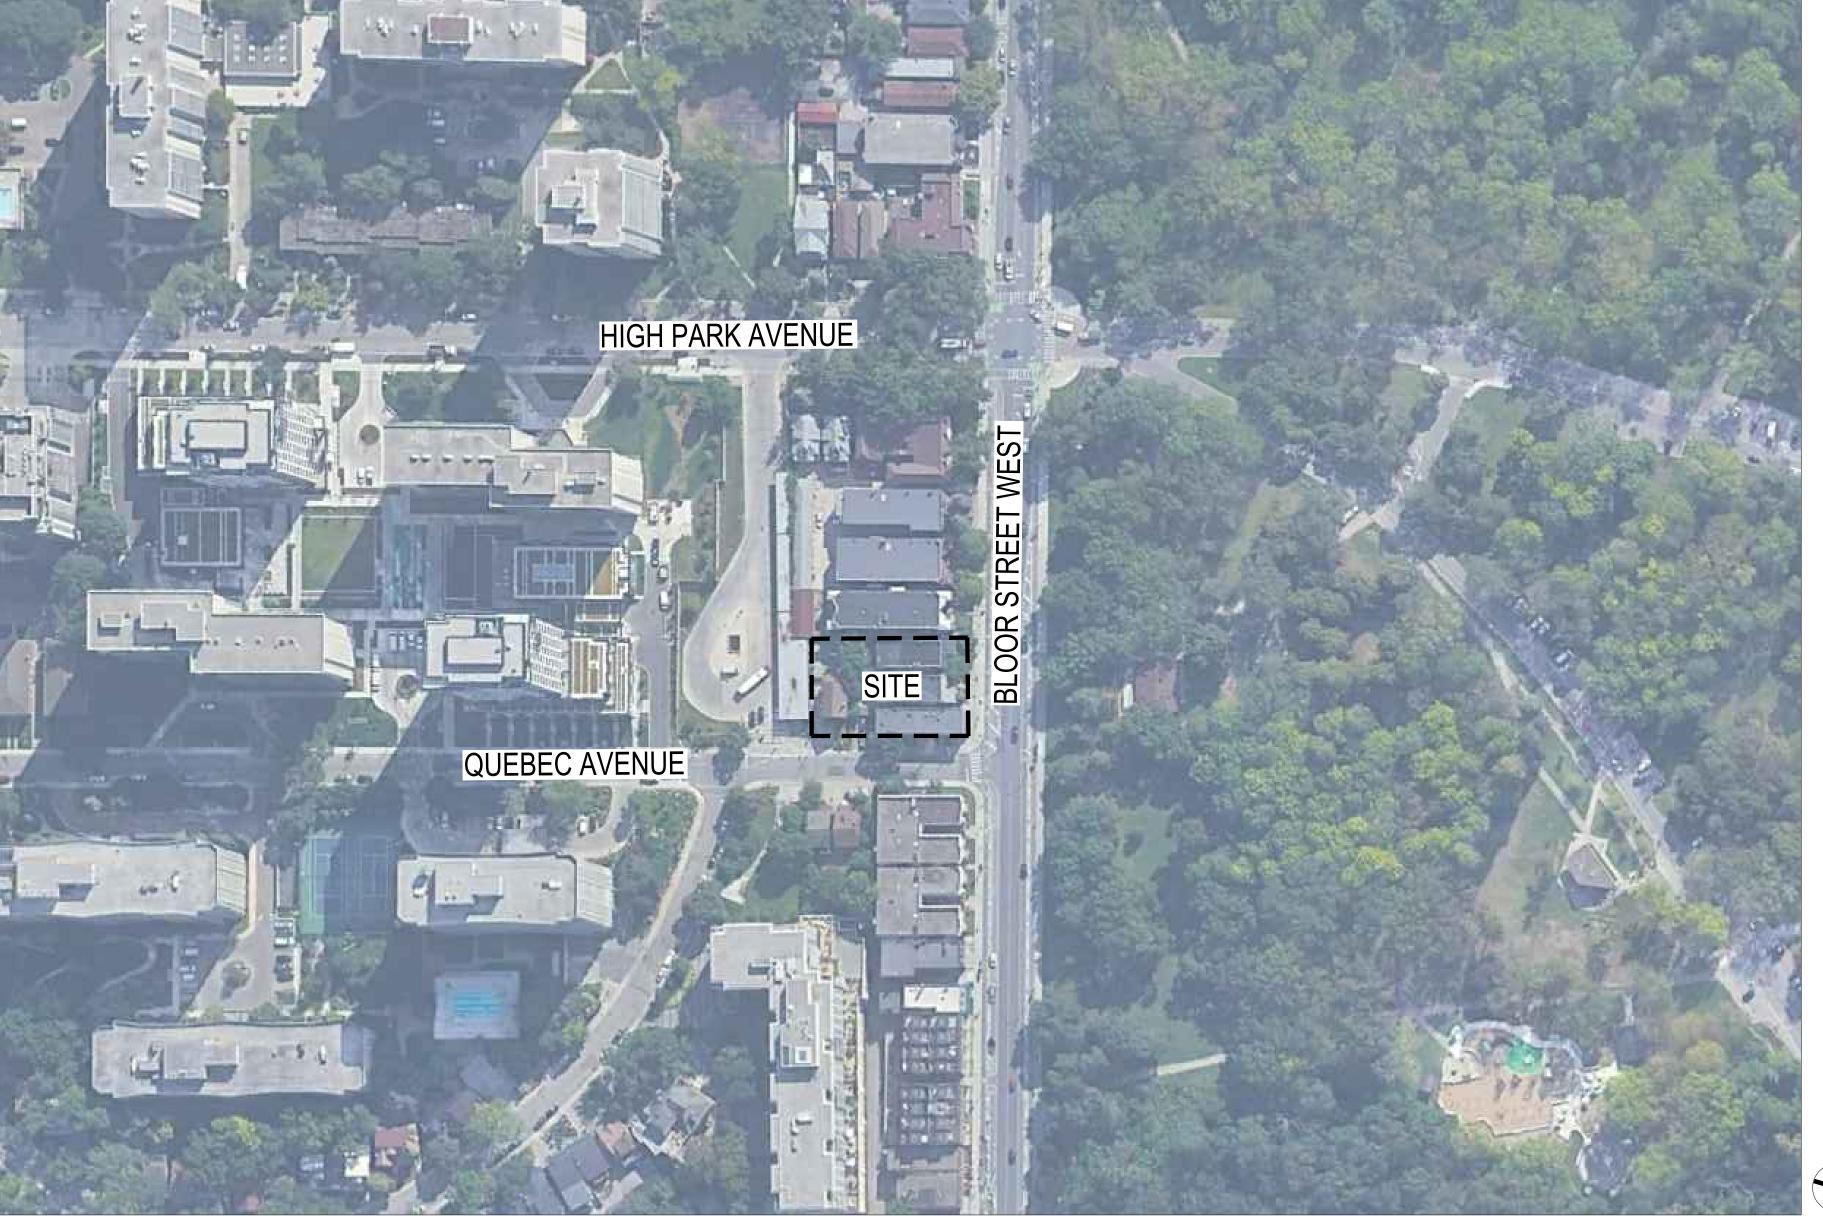
REVISIONS

5 4

3 ISSUED FOR ZBA 2024-11-22 2 ISSUED FOR ZBA 2024-07-24 1 ISSUED FOR PRE-APP CONSULTATION 2023-09-27

PHASE

PROJECT NUMBER 23-133




SHEET INDEX

SHEET NO. SHEET TITLE
LC.000 COVER PAGE
LS.100 LANDSCAPE PLAN
LSV.100 SOIL VOLUME PLAN
LU.100 COMPOSITE UTILITY PLAN
LR.100 LEVEL 2 AMENITY PLAN
LR.101 LEVEL 17 AMENITY PLAN


LANDSCAPE DETAILS

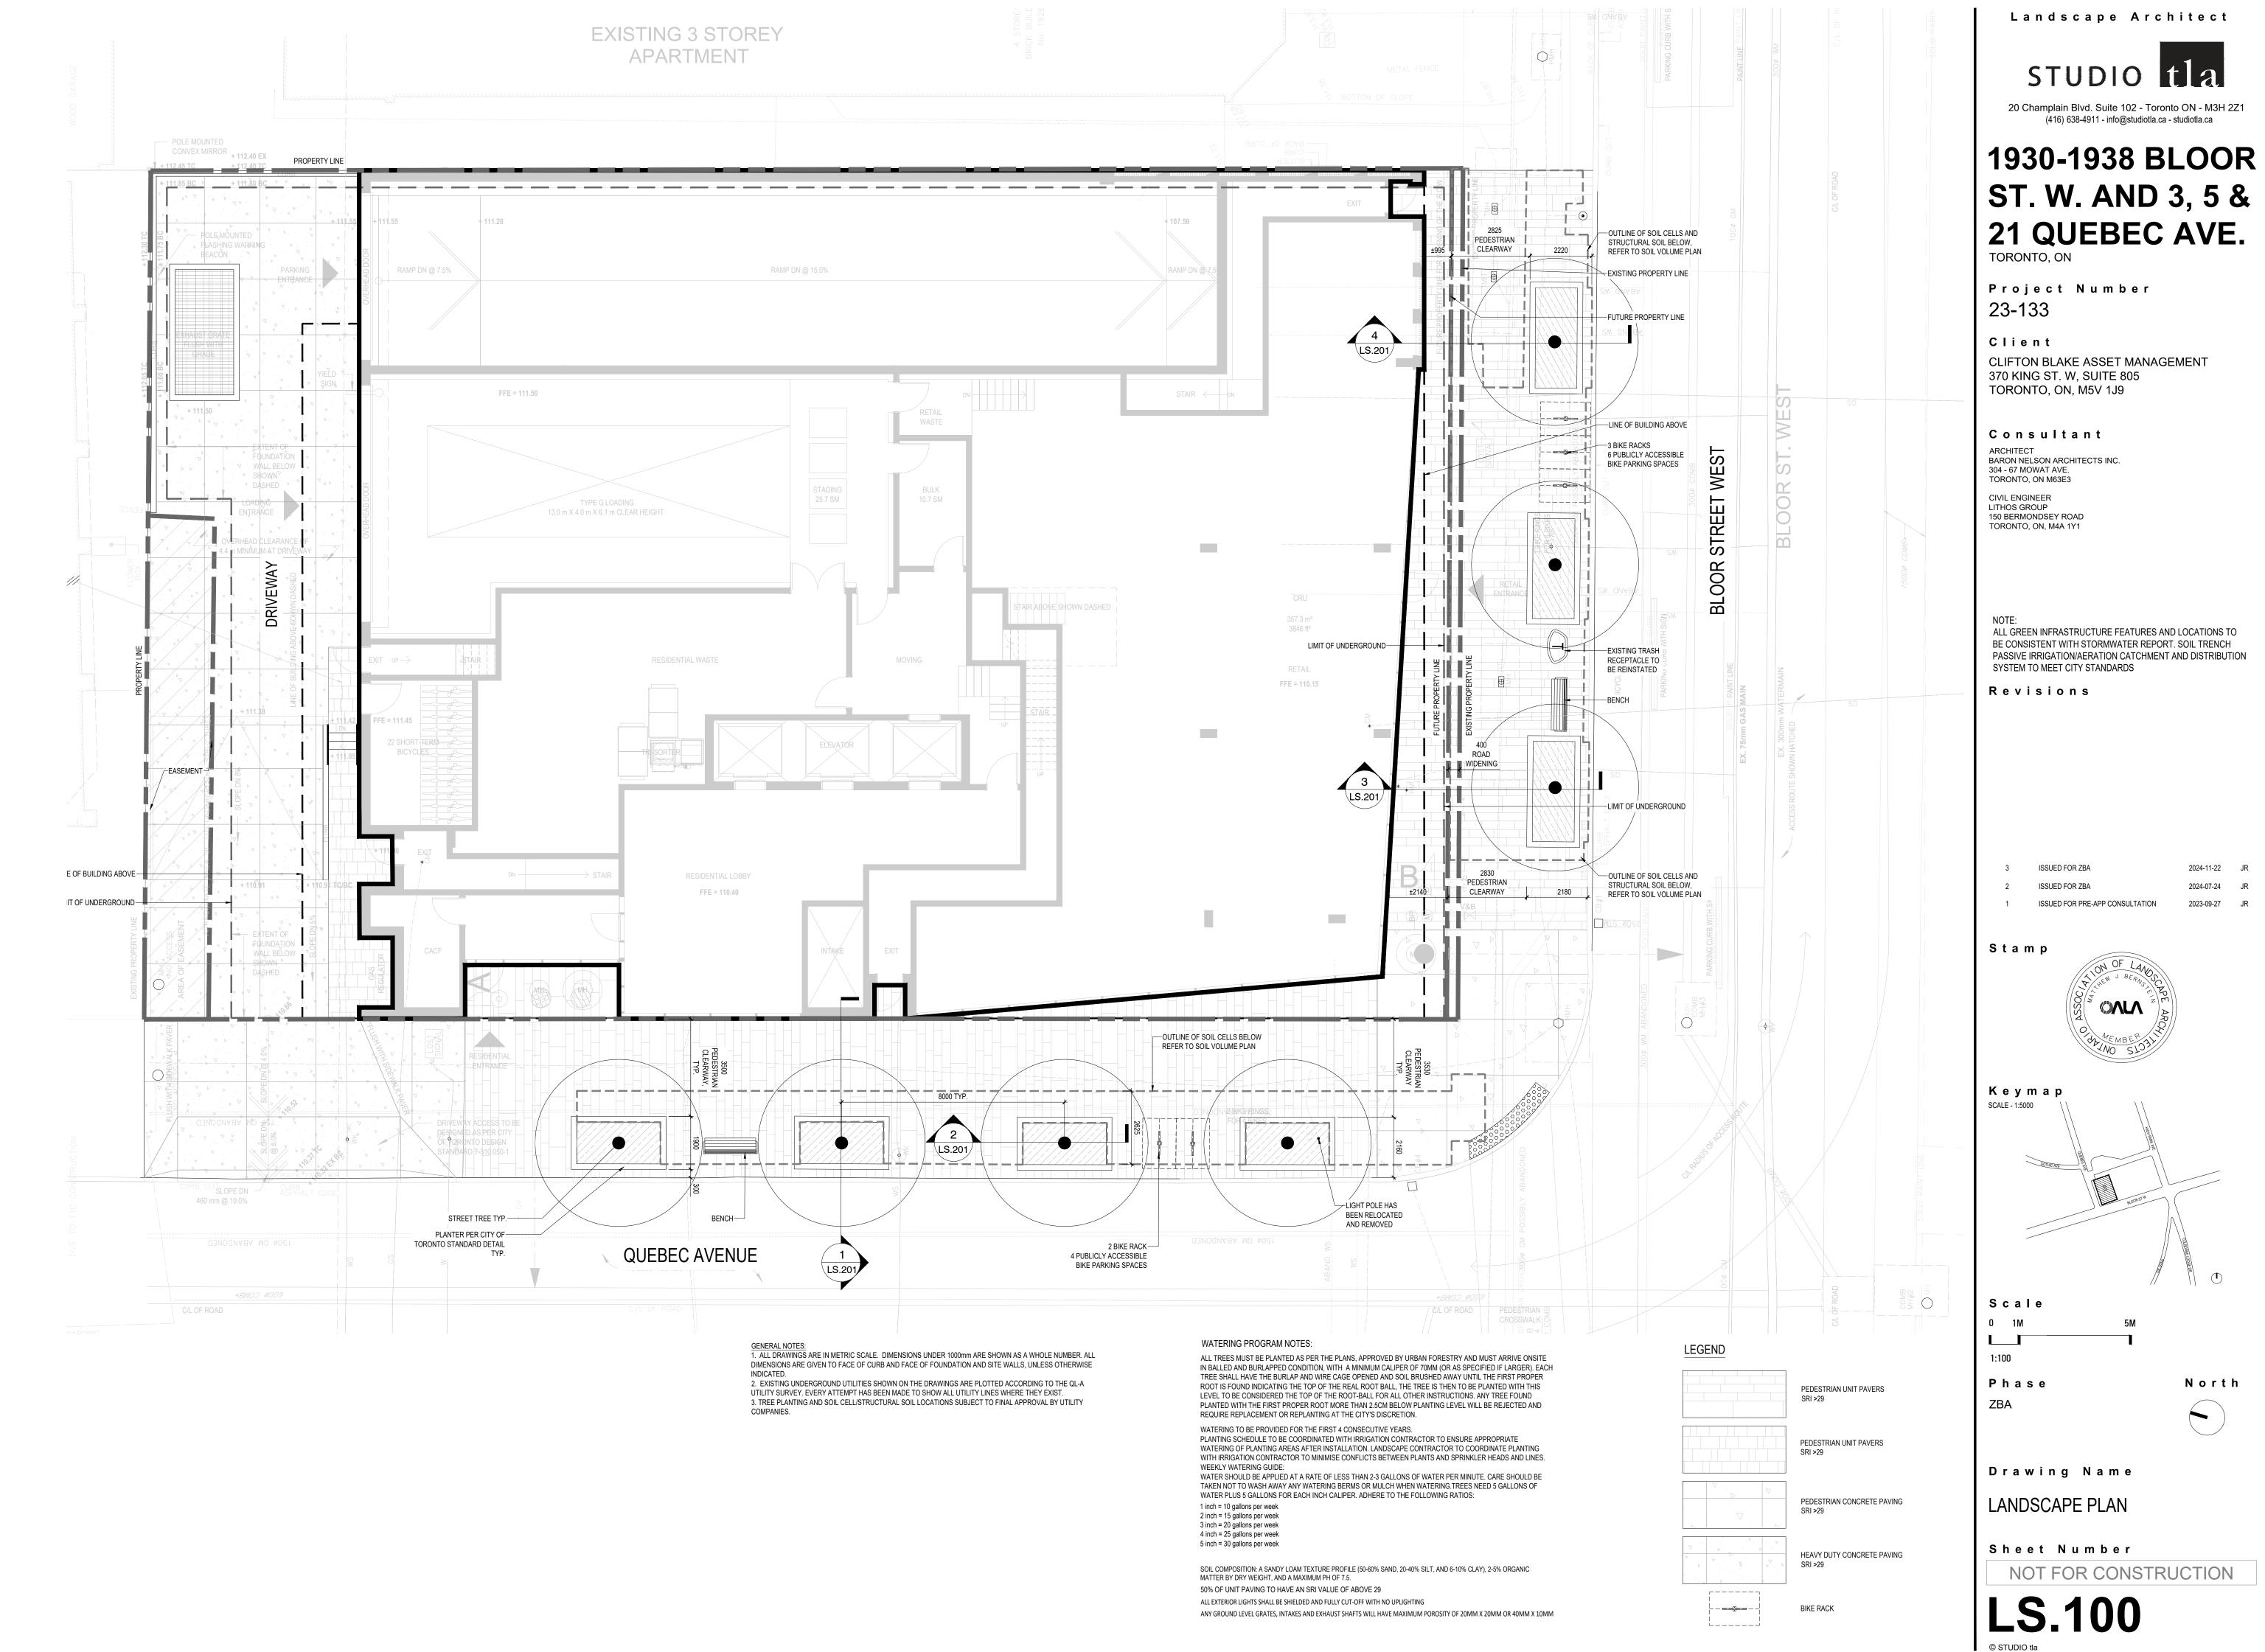N.T.S.



ST. W. AND 3, 5 & 21 QUEBEC AVE.

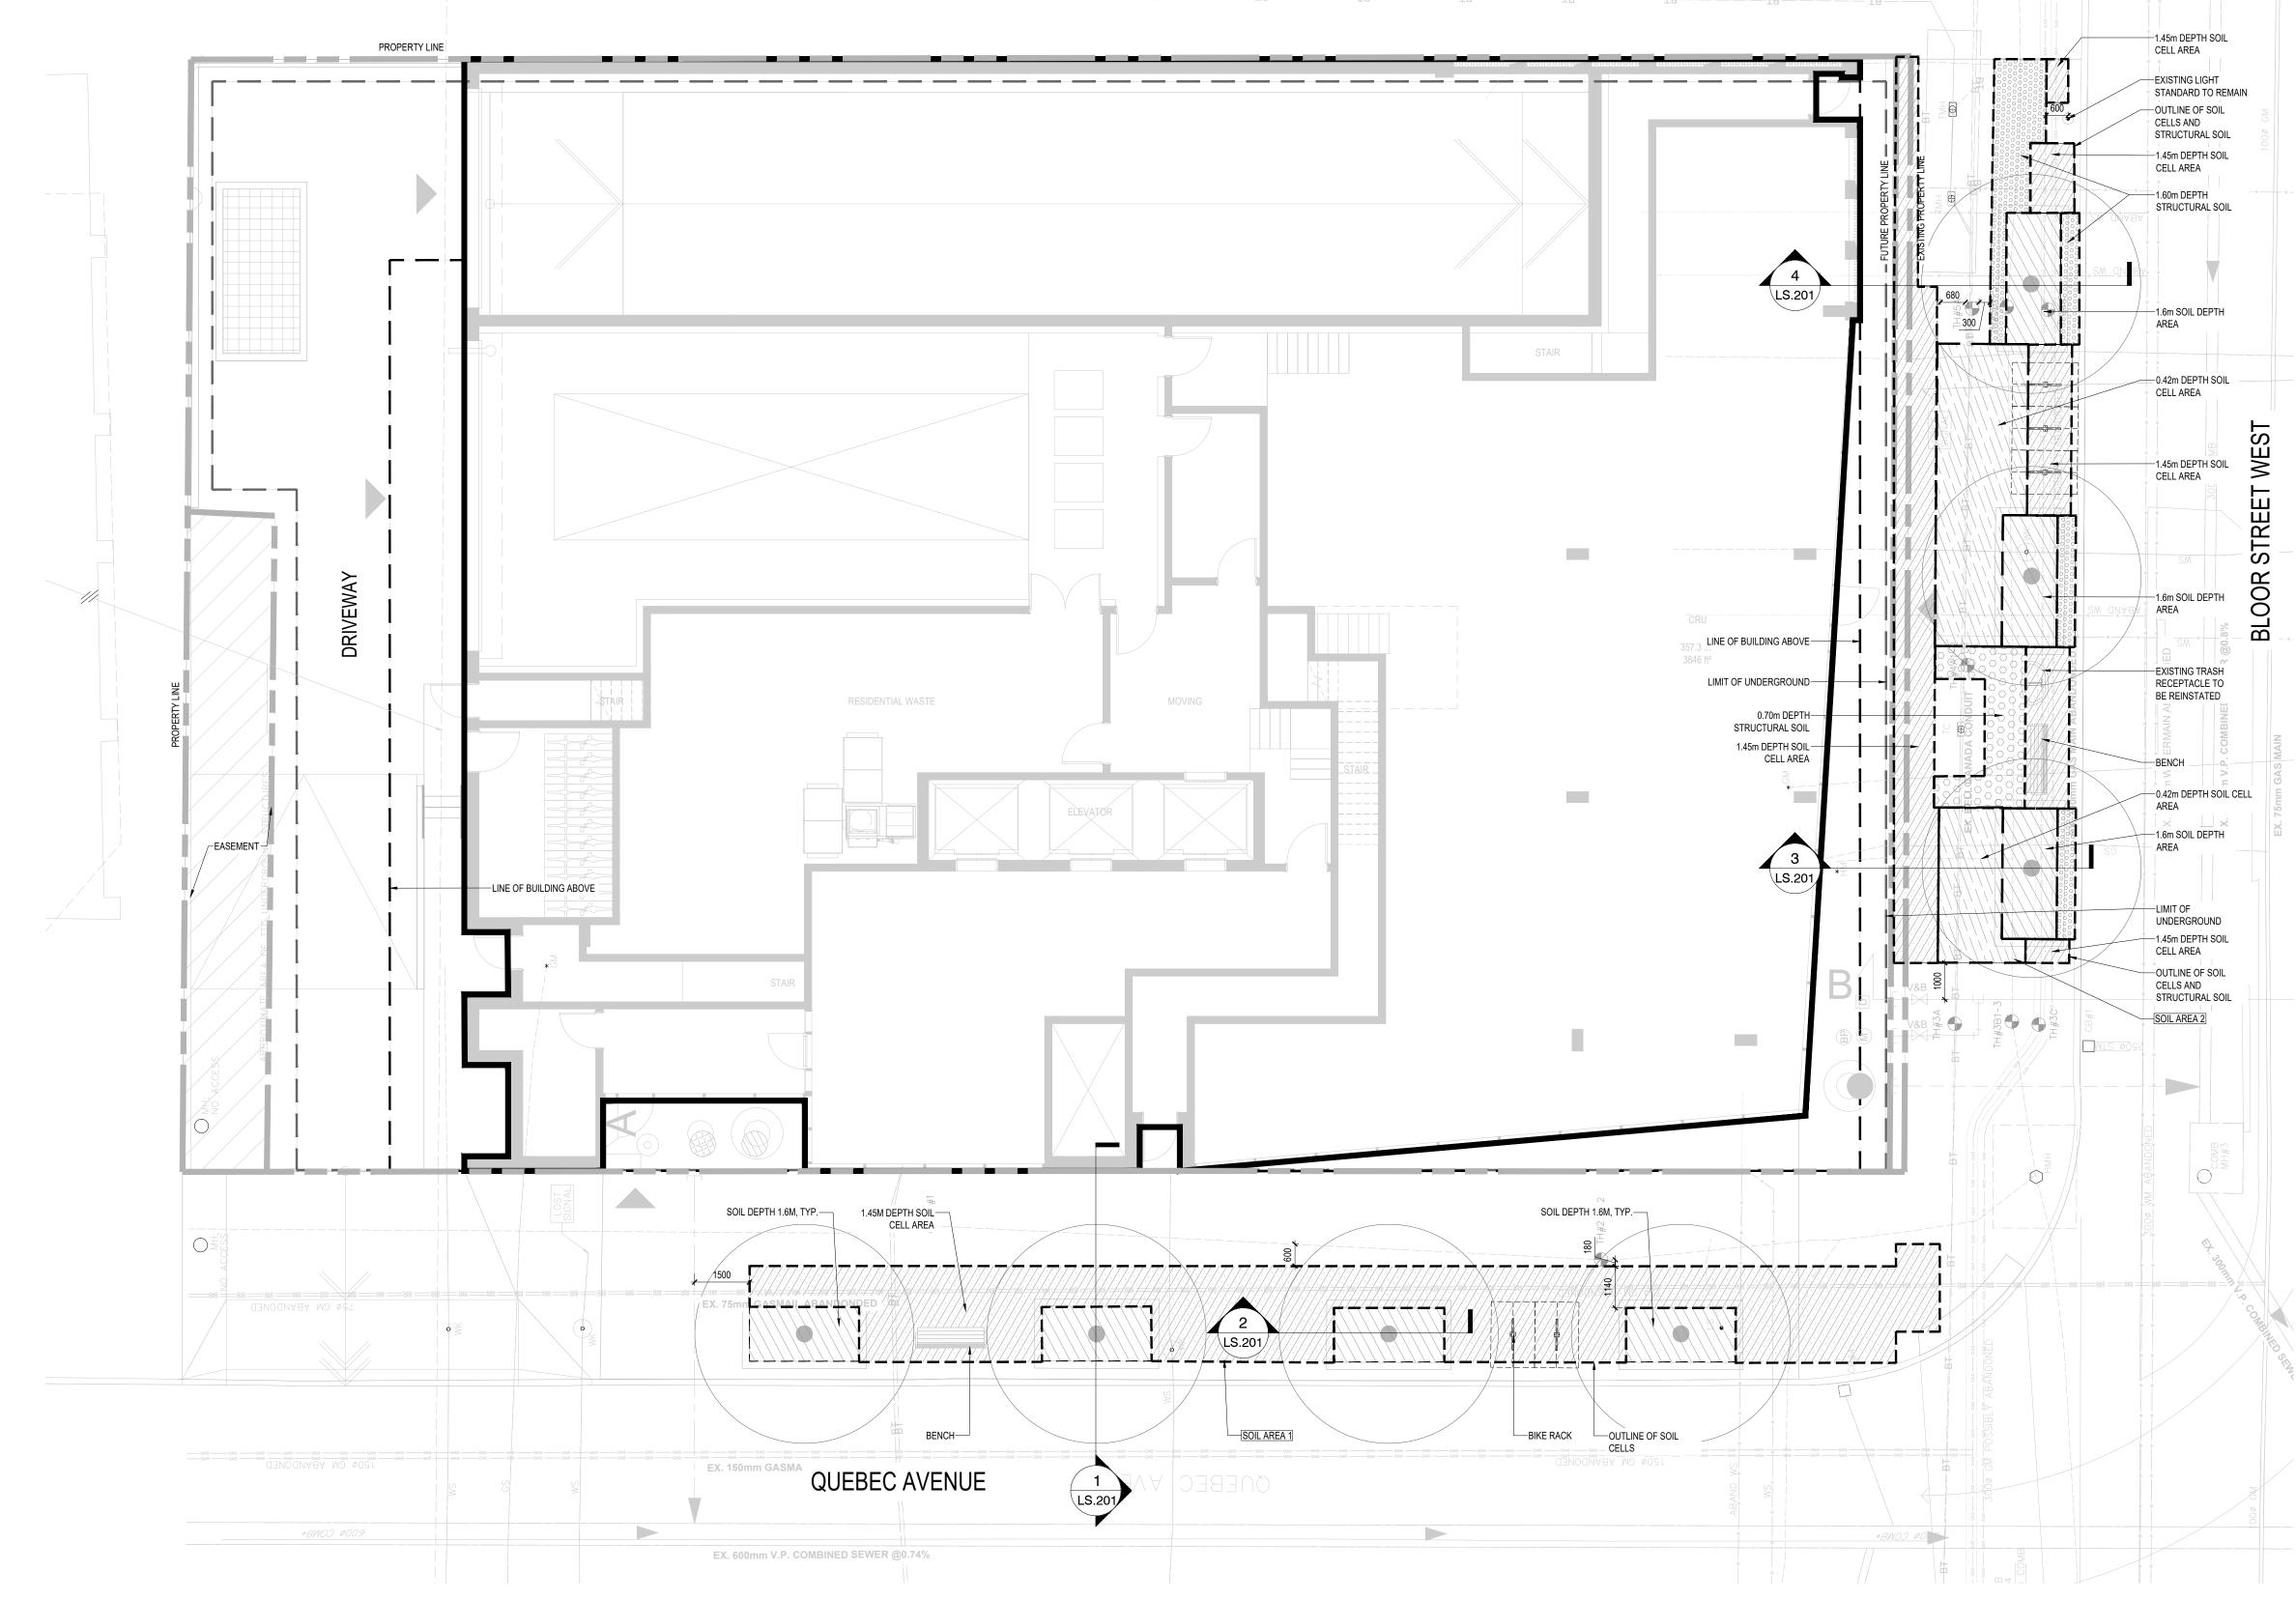PASSIVE IRRIGATION/AERATION CATCHMENT AND DISTRIBUTION





| | Soil Area# | Location (City ROW, private property) | Soil Area (m²) | Structural Soil Area (m²) | Soil Depth(m*) | Soil Volume (m³) | Total Soil Volume (m³) | Tree Quantity | Soil Volume per tree (m³) | Irrigation provided (Yes/No) | Hard Surface or Soft Surface (Yes/No) | Soil Cel (Yes/N |
|--|------------|---------------------------------------|-------------------|---------------------------------|-------------------|---------------------|------------------------------|------------------|------------------------------|------------------------------------|---|--------------------|
| | 1 | ROW | 68 | - | 1.45 | 88.7 | 119.1 | 4 | 30 | Yes | Hard | Yes |
| | | | 19 | - | 1.6 | 30.4 | | | | Yes | Soft | No |
| | 2 | ROW | 39.0 | - | 1.45 | 50.9 | 91.1 | 3 | 30 | Yes | Hard | Yes |
| | | | 16 | - | 1.6 | 25.6 | | | | Yes | Soft | No |
| | | | 26.0 | - | 0.42 | 9.8 | | | | Yes | Hard | Yes |
| | | | - | 7 | 0.7 | 1 | | | | Yes | Hard | No |
| | | | - | 12 | 1.6 | 4 | | | | Yes | Hard | No |
| | Totals | | | | | | 210.3 | 7 | | | | |

^{*} Soil depth excludes drainage layer

GENERAL NOTES:

1. ALL DRAWINGS ARE IN METRIC SCALE. DIMENSIONS UNDER 1000mm ARE SHOWN AS A WHOLE NUMBER. ALL DIMENSIONS ARE GIVEN TO FACE OF CURB AND FACE OF FOUNDATION AND SITE WALLS, UNLESS OTHERWISE INDICATED.

EXISTING UNDERGROUND UTILITIES SHOWN ON THE DRAWINGS ARE PLOTTED ACCORDING TO THE QL-A
UTILITY SURVEY. EVERY ATTEMPT HAS BEEN MADE TO SHOW ALL UTILITY LINES WHERE THEY EXIST.
 TREE PLANTING AND SOIL CELL/STRUCTURAL SOIL LOCATIONS SUBJECT TO FINAL APPROVAL BY UTILITY
COMPANIES.
 SOIL CELL VOLUME CALCULATIONS ACCOMODATE SOIL CELL STRUCTURE; REDUCING VOLUMES BY 10%.

1.45m DEPTH SOIL CELL AREA

0.42m DEPTH SOIL CELL AREA

1.6m DEPTH SOIL AREA

1.6m DEPTH STRUCTURAL SOIL

Landscape Architect

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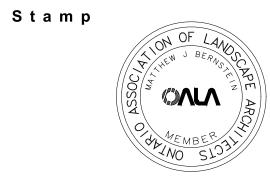
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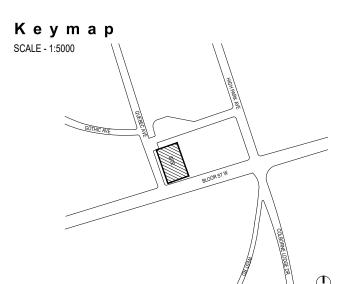
ALL GREEN INFRASTRUCTURE FEATURES AND LOCATIONS TO BE CONSISTENT WITH STORMWATER REPORT. SOIL TRENCH PASSIVE IRRIGATION/AERATION CATCHMENT AND DISTRIBUTION SYSTEM TO MEET CITY STANDARDS

Revisions

ISSUED FOR ZBA

ISSUED FOR ZBA 2024-07-24 JR
ISSUED FOR PRE-APP CONSULTATION 2023-09-27 JR





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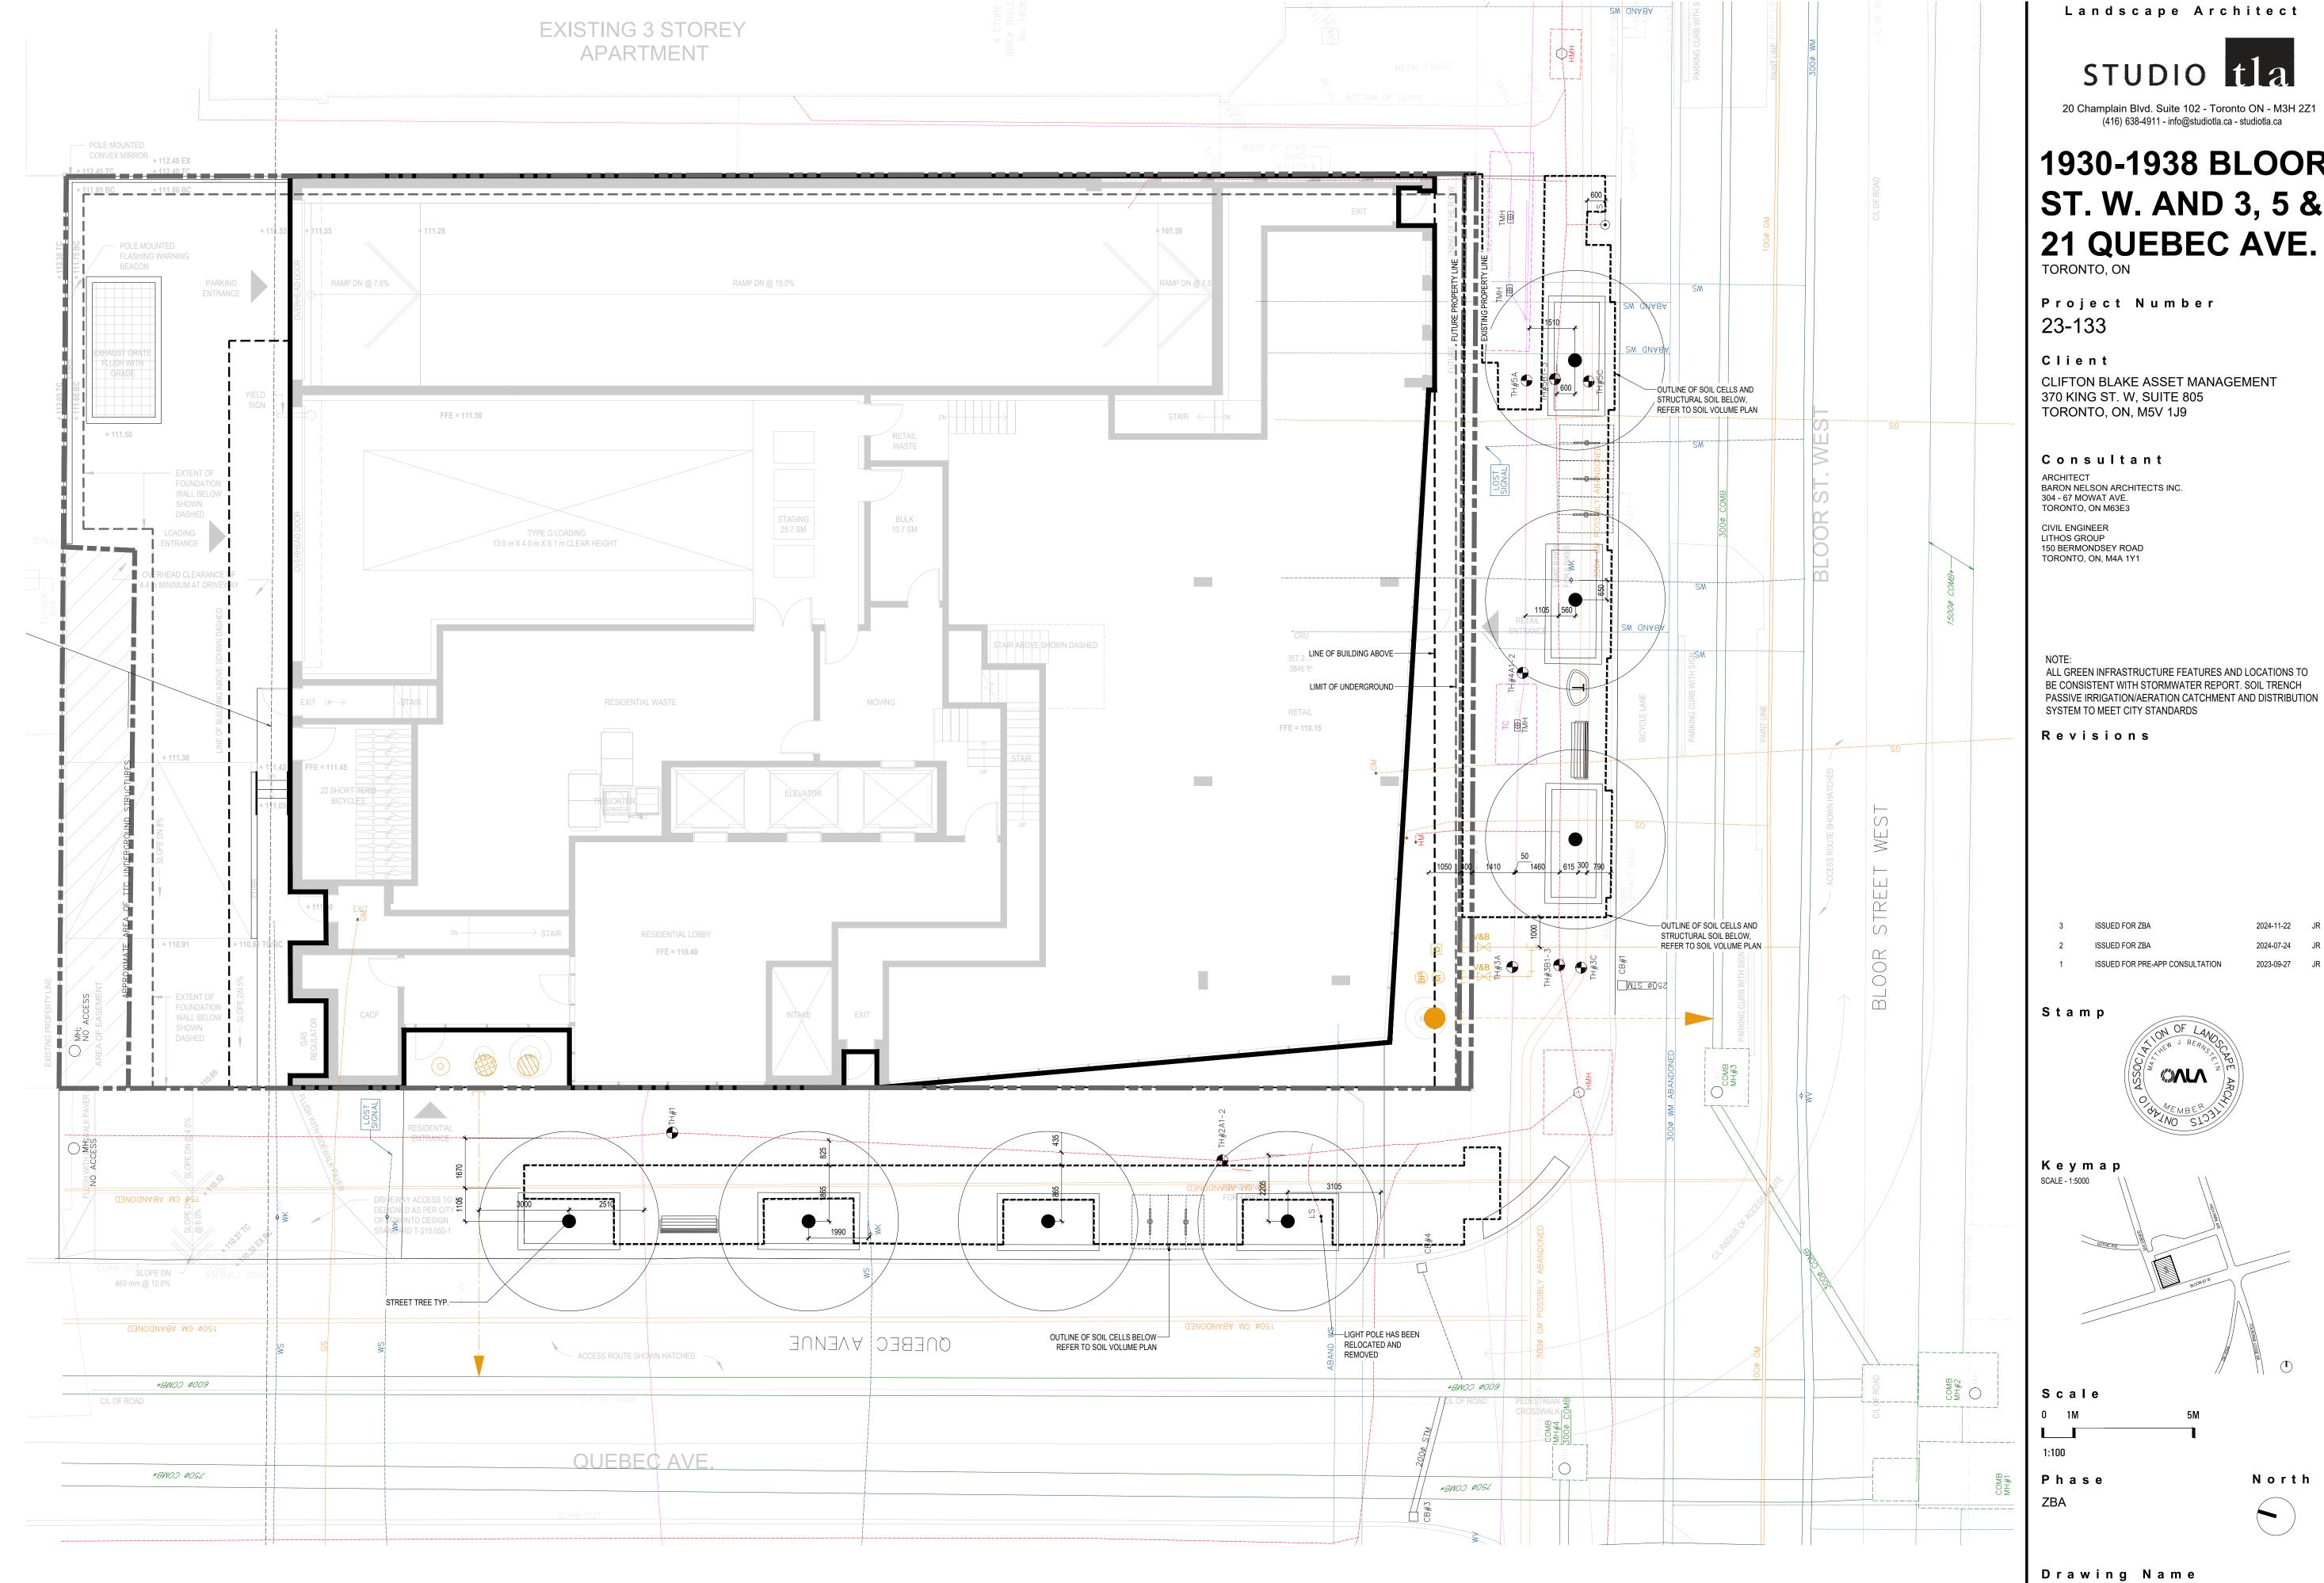
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Drawing Name

SOIL VOLUME PLAN

Sheet Number

LSV.100



LEGEND

PROPOSED WATER/SANITARY/STORM BUILDING CONNECTIONS. REFER TO CIVIL ENGINEER DRAWINGS

EXISTING WATER LINE

EXISTING WATER LINE -ABANDONED

EXISTING HYDRO LINE

EXISTING GAS LINE

EXISTING GAS LINE, ABANDONED

OR POSSIBLY ABANDONED

EXISTING COMBO SEWER

EXISTING CABLE LINE

Landscape Architect STUDIO 1 a

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Keymap SCALE - 1:5000

Scale 1:100

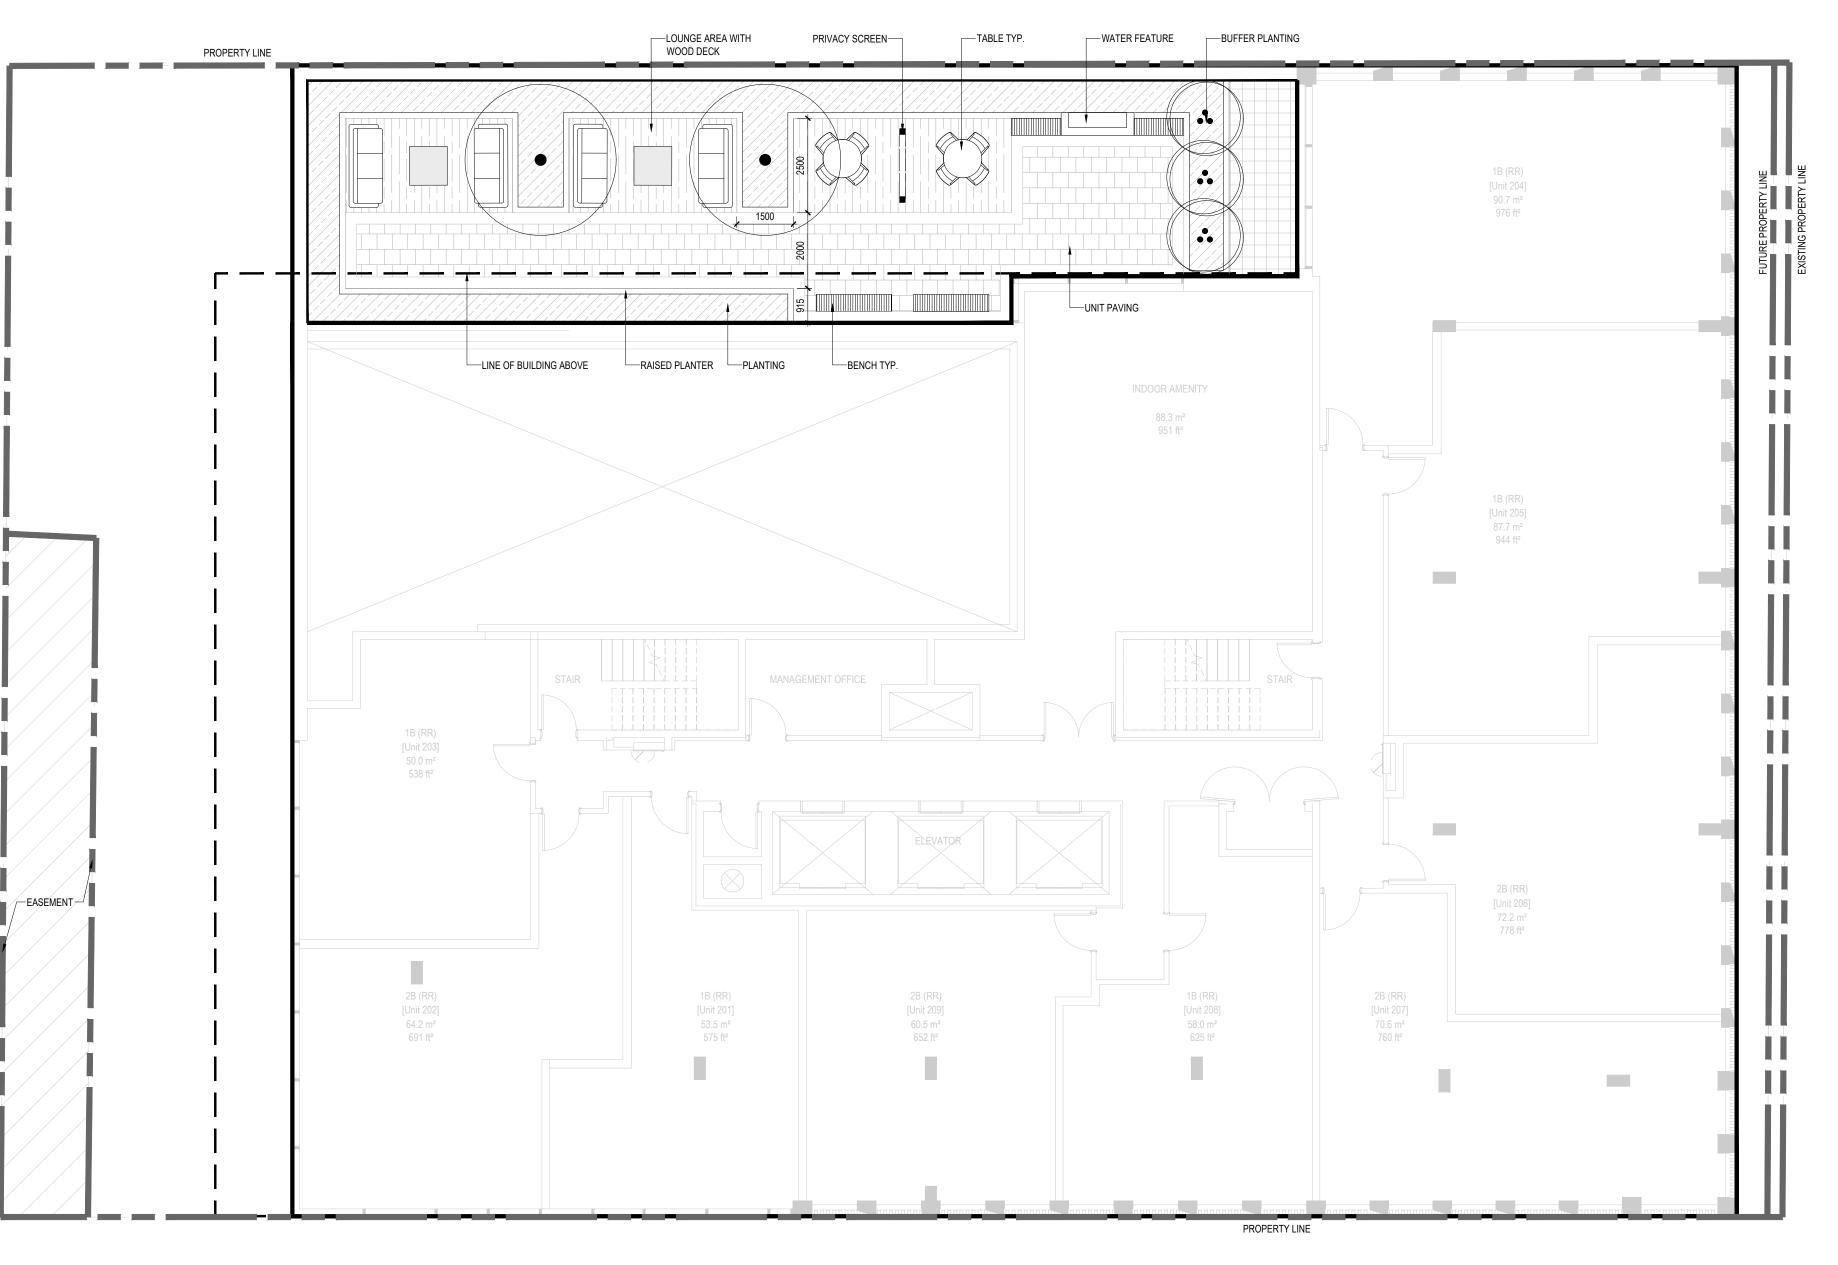
North

Drawing Name

COMPOSITE UTILITY PLAN

Sheet Number

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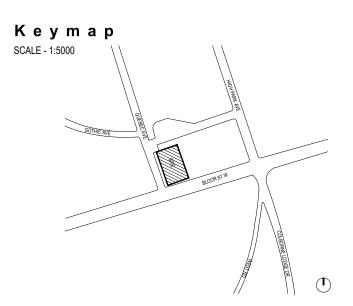
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Phase

ZBA

Drawing Name

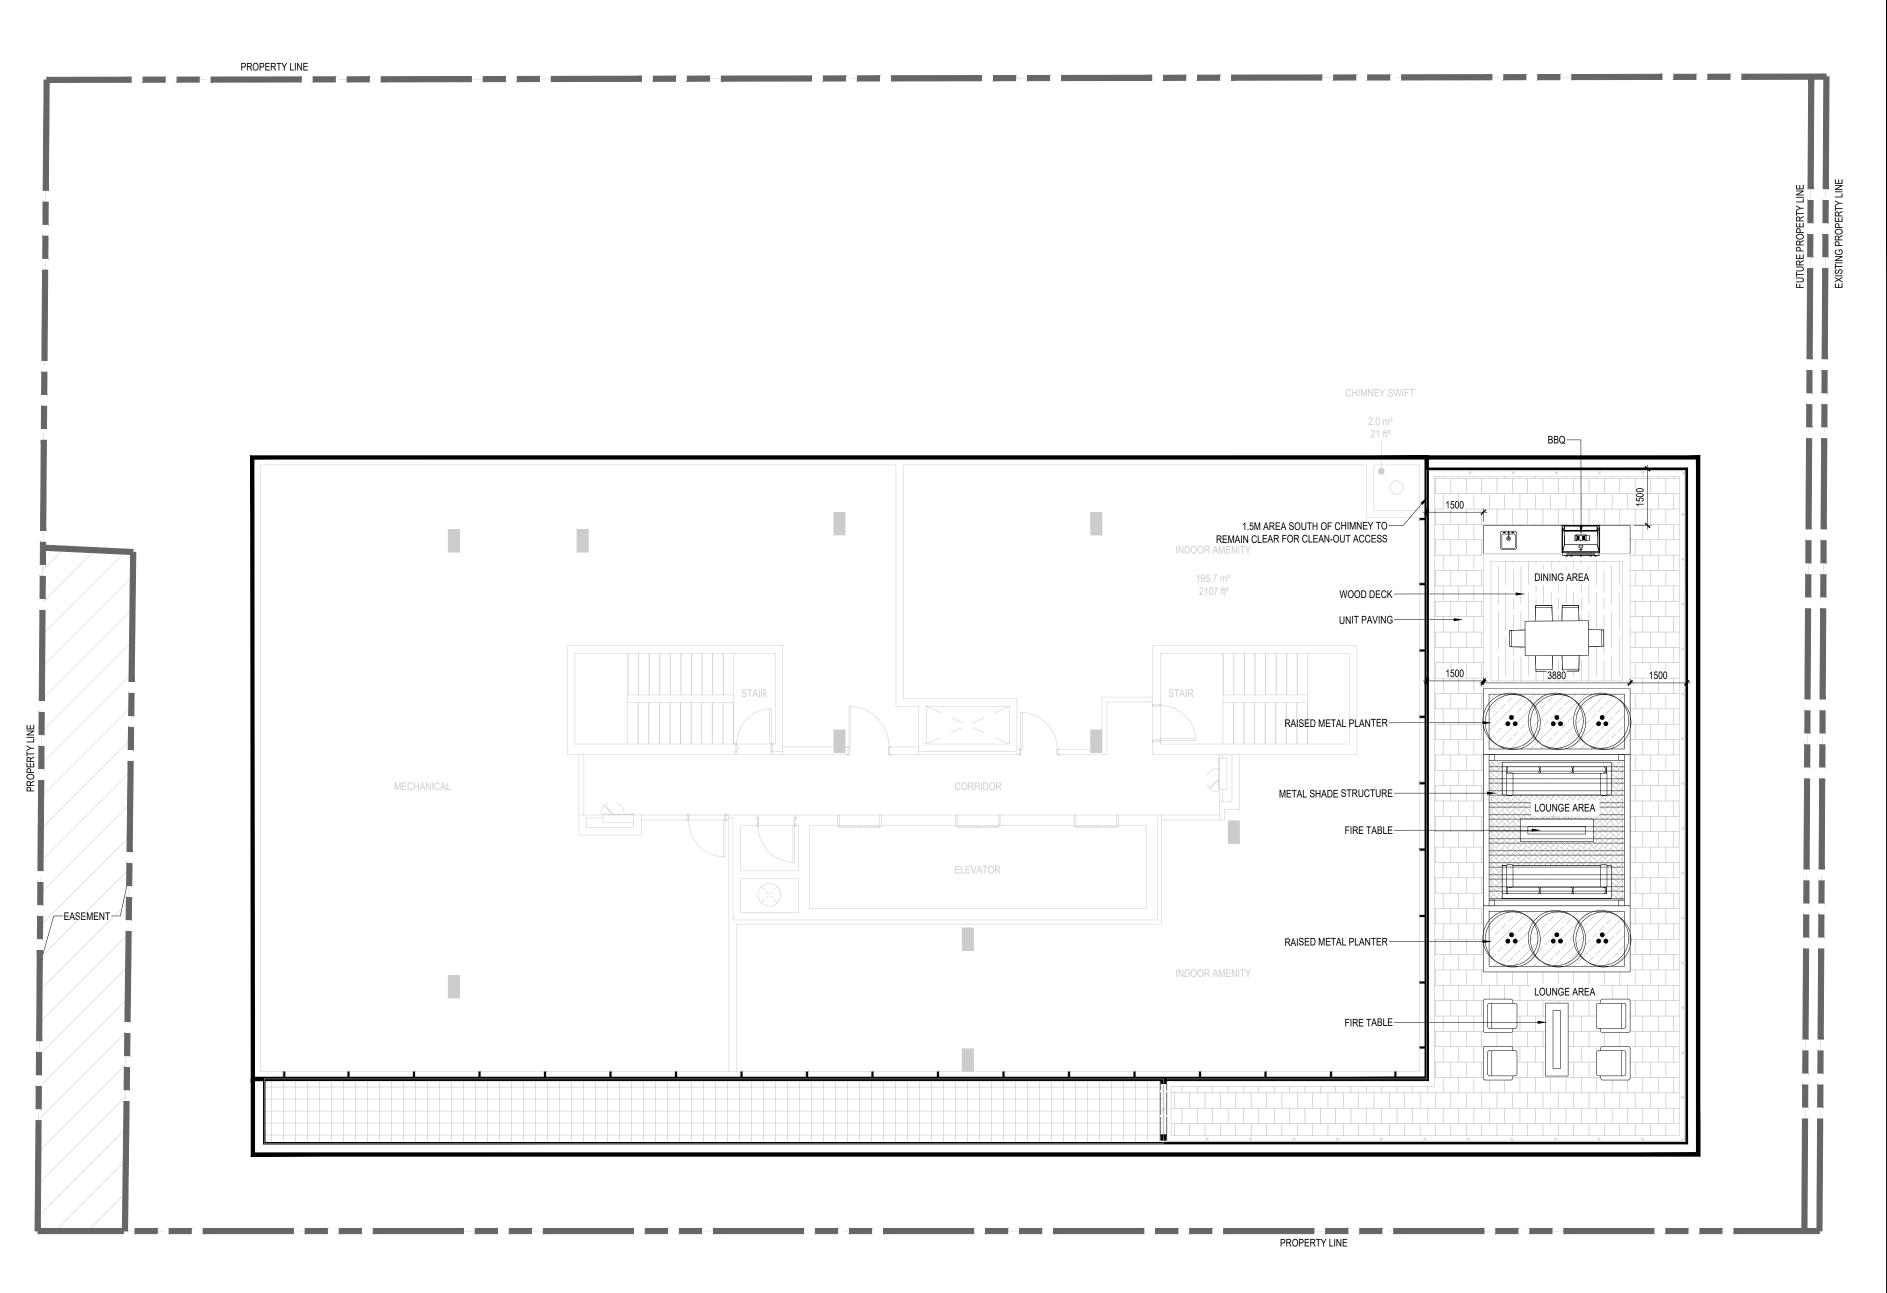
North

LEVEL 2 AMENITY PLAN

Sheet Number

NOT FOR CONSTRUCTION

R.100



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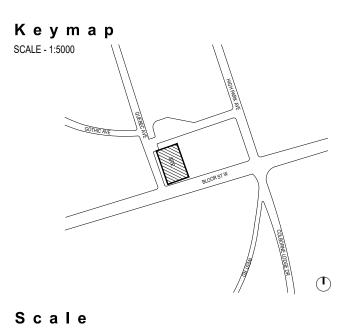
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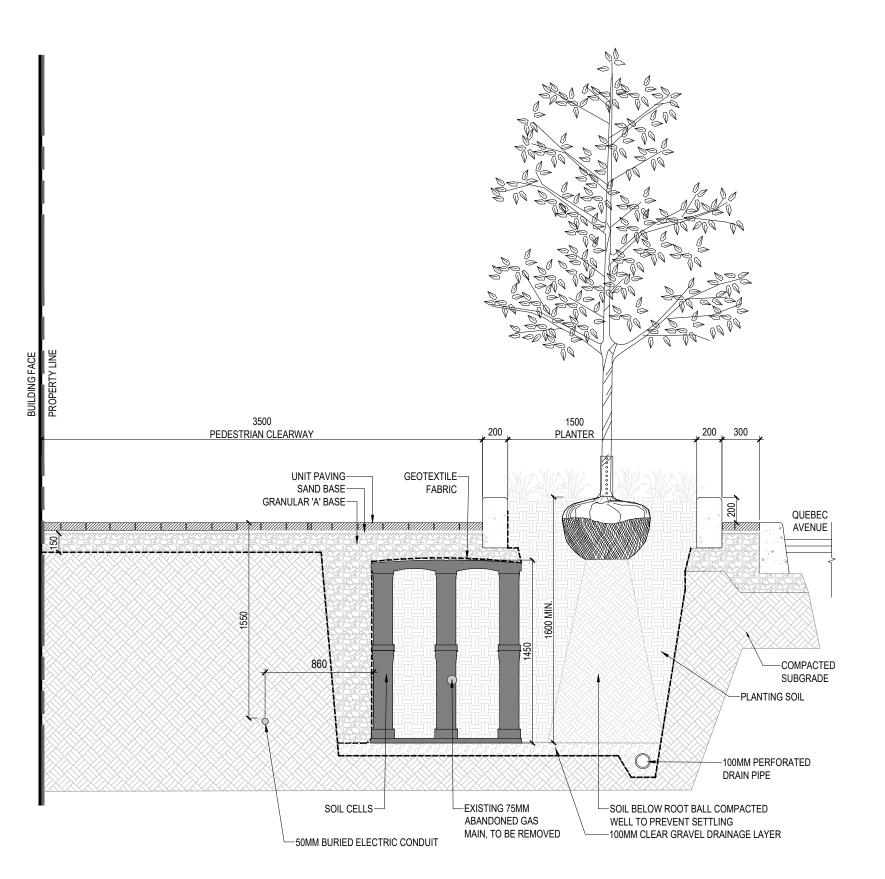
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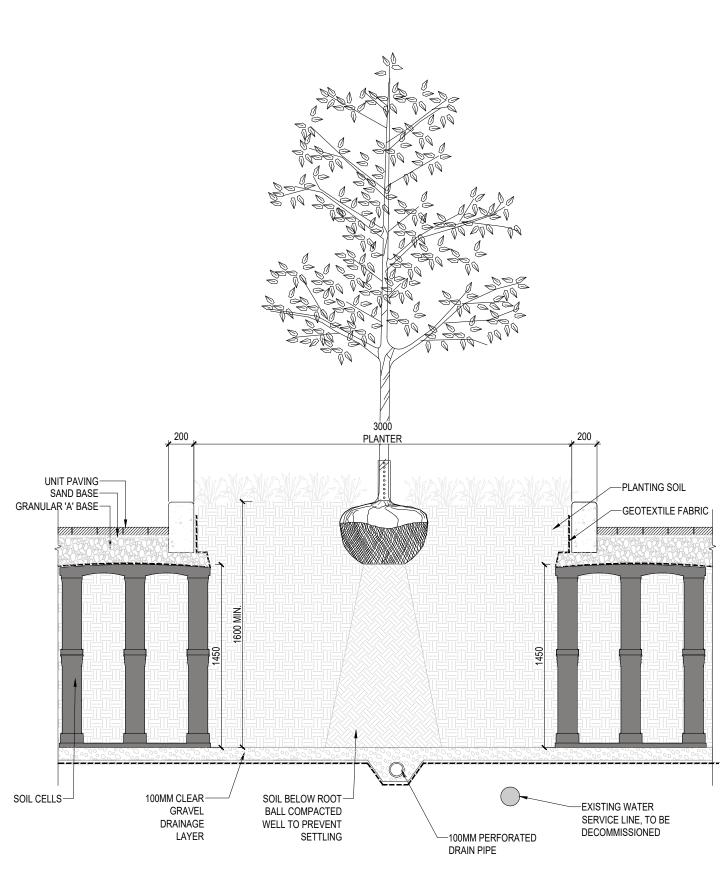
LEVEL 17 AMENITY PLAN

Sheet Number
NOT FOR CONSTRUCTION

LR.101

JDIO tla



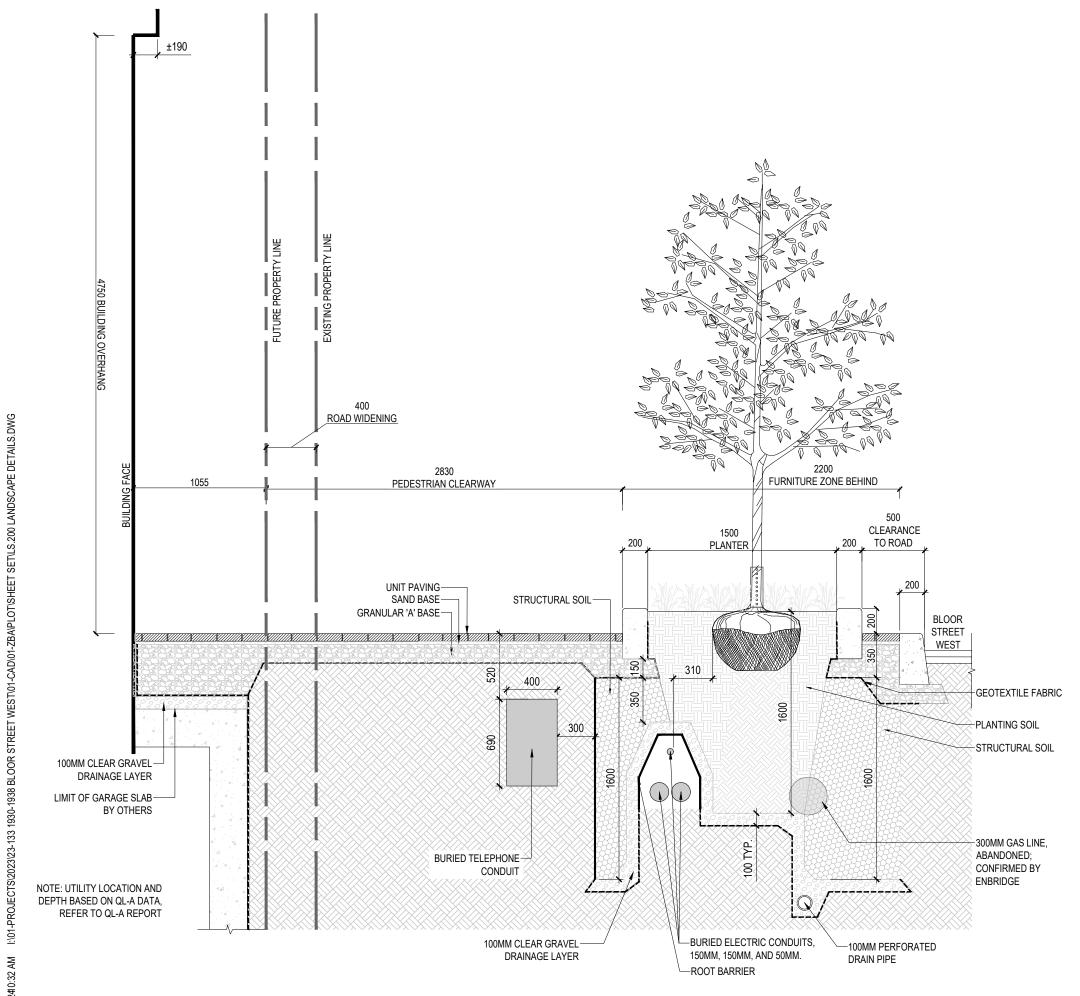


±1070 ROAD WIDENING FURNITURE ZONE BEHIND PEDESTRIAN CLEARWAY UNIT PAVING—— SAND BASE—— GRANULAR 'A' BASE----PLANTING SOIL —COMPACTED 100MM CLEAR GRAVEL-SUBGRADE DRAINAGE LAYER LIMIT OF GARAGE SLAB--300MM GAS LINE, BY OTHERS ABANDONED; CONFIRMED BY ENBRIDGE -STRUCTURAL SOIL NOTE: UTILITY LOCATION AND DEPTH BASED ON QL-A DATA, -100MM PERFORATED 100MM PERFORATED REFER TO QL-A DRAIN PIPE REPORT -BURIED ELECTRIC BURIED TELEPHONE CONDUIT CONDUITS, 150MM, 150MM, AND 50MM. ROOT BARRIER GEOTEXTILE LAYER

WEST-EAST SECTION - QUEBEC AVE

NORTH-SOUTH SECTION - QUEBEC AVE

NORTH-SOUTH SECTION - BLOOR ST W



NORTH-SOUTH SECTION - BLOOR ST W

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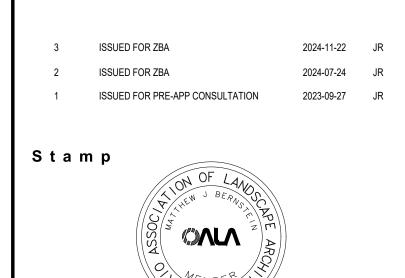
Consultant


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Scale 1:200

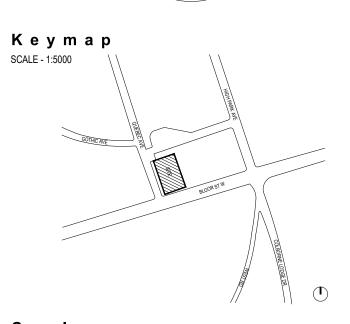Drawing Name

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