Appendix "A"

1601-1603 BATHURST STREET

PROPOSED 12 STOREY RESIDENTIAL DEVELOPMENT, TORONTO, ONTARIO (REVISED CONCEPT)



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 04
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 03
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 02
 OPA/ZBA/SPA #2 SUBMISSION APR 26, 2022

 01
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Azuria Group Inc. :

1212763 Ontario Ltd. and 1212765 Ontario Ltd.


Drawing Title:

Cover Sheet

Proje

1601 BATHURST STREET

TORONTO, ON

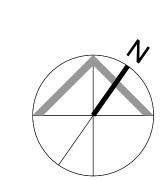

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M.C.

23-035

Oct. 03, 2025

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GENERAL NOTES:

IT IS THE RESPONSIBILITY OF THE APPLICANT TO COMPLY WITH THE SEWER USE BY-LAW AND OBTAIN ALL APPROVALS/PERMITS FROM TORONTO WATER -ENVIRONMENTAL MONITORING & PROTECTION UNIT FOR ANY PROPOSED TEMPORARY OR PERMANENT DISCHARGE OF GROUNDWATER INTO THE MUNICIPAL SEWER SYSTEMS AND

THE APPLICANT ISALSO RESPONSIBLE FOR COMPLYING WITH ALL APPLICABLE PROVINCIAL REQUIREMENTS AND OBTAINING THE NECESSARY APPROVALS AND/OR PERMITS FROM THE MINISTRY OF THE ENVIRONMENT & CLIMATE CHANGE WITH REGARD TO ANY PROPOSED

ALL TREE PRESERVATION WITHIN THE RIGHT OF WAY LANDS SHALL BE IN ACCORDANCE WITH LANDSCAPE DRAWINGS AND TREE PRESERVATION DRAWINGS AND REPORTS, APPROVED BY TORONTO URBAN FORESTRY.

PRIOR TO COMMENCING ANY WORK WITHIN THE RIGHT OF WAY, THE CONTRACTOR, DEVELOPER, OR CONSULTANT WILL OBTAIN ALL NECESSARY ROAD OCCUPANCY PERMITS FROM THE CITY'S RIGHT OF

STAFF HAVE REVIEWED THIS APPLICATION ON THE UNDERSTANDING IT WILL COMPRISE A SINGLE PARCEL OF LAND, UNDER ONE OWNER, UPON COMPLETION. IF ANY PARTY, INCLUDING THE APPLICANT OR ANY SUBSEQUENT OWNER, SUBMITS AN APPLICATION FOR SEVERANCE, PART-LOT CONTROL, SUBDIVISION, CONDOMINIUM APPROVAL OR ANY OTHER FORM OF LAND DIVISION FOR THIS DEVELOPMENT NOT IN ACCORDANCE WITH THIS ASSUMPTION, DIFFERENT SERVICING CONNECTIONS, INCLUDING ALL ASSOCIATED STORM-WATER MANAGEMENT FACILITIES AND ANY NECESSARY REVISED PLANS AND STUDIES, MAY BE REQUIRED BY THE CITY AT THE SOLE COST TO THE

REFER TO THE APPROVED ENGINEERING DRAWINGS FOR THIS SUBJECT SITE, PREPARED BY IBI GROUP FOR ALL SITE SERVICING AND ABOVE GROUND CONNECTIONS INFORMATION.

PRIOR TO THE COMMENCEMENT OF THE SOLID WASTE COLLECTION SERVICES BY THE CITY OF TORONTO, A CERTIFIED LETTER BY A PROFESSIONAL ENGINEER WILL BE REQUIRED TO ASSURE THAT IN ALL SCENERIOS WHERE A COLLECTION VEHICLE IS REQUIRED TO DRIVE ONTO, INCLUDING OVER A SUPPORTED STRUCTURE SUCH AS AN UNDERGROUND PARKING GARAGE, HAVE THE STRUCTURAL INTEGRITY TO SUPPORT A FULLY LOADED COLLECTION VEHICLE WEIGHING UP TO 35,000 KILOGRAMS AND CONFORM TO THE FOLLOWING:

(a) DESIGN CODE -ONTARIO BUILDING CODE (b) DESIGN LOAD -CITY BULK LIFT VEHICLE IN ADDITION

BUILDING CODE REQUIREMENTS (c) IMPACT FACTOR -5% FOR MAXIMUM VEHICULAR SPEEDS TO

15KM/H AND 30% FOR HIGHER SPEEDS

THE OWNER WILL BE RESPONSIBLE FOR PROVIDING ON-SITE PERSONNEL AVAILABLE TO MANOEUVRE THE SOLID WASTE BINS FOR COLLECTION AND BE TRAINED AS FLAGMEN TO BE AVAILABLE TO ASSIST WHEN THE CITY COLLECTION VEHICLE IS BACKING OUT OF THE LOADING AREA. IN THE EVENT THAT TRAINED PERSONNEL ARE NOT AVAILABLE AT THE TIME THE COLLECTION VEHICLE ARRIVES ON SITE, THE COLLECTION VEHICLE WILL LEAVE AND NOT RETURN UNTIL THE NEXT SCHEDULED

TORONTO WATER NOTE 2

1601 BATHURST STREET

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SITE PLAN, ECOLOGICAL

INFORMATION &

Drawing Title:

Project:

TORONTO, ON

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pos	o, Ontario sed 12 Storey Residential Development									
	t Statistics 3, 2025								Pr	roject
	Site Area 1601 Bathurst Street							acres 0.18	sq.m. 715.82	
	1603 Bathurst Street (Existing Parcel) Total Site Area							2.12 2.30	8,575.49 9,291.31	
	<u>GFA</u>									
2.1	1 Existing GFA - 1603 Bathurst Street Levels to 6 Total Existing GFA	floors 6 x	sq.m. 1,354.67						sq.m. 8,128.02 8,128.02	
2.2	2 Proposed GFA - Proposed Residential Building- 1601 Bathurst Street GFA calculations are as per S.40.5.40.40 of the by-law 569-2013-: excludes parking, loadi	ing and bicyc	le parking below	and above grade	e: storage and m	echanical room	s below arade: ii	ndoor amenity s		
	elevator & garbage shafts, exit stairwells, and mechanical penthouse. Level Lower 1 (Lockers, Elev. Lobby, Corri., Trash & mud)	floors 1 x	sq.m. 137.76		, corego una m				sq.m. 137.76	_
	Level 1 Level 2 Level 3	1 x 1 x 1 x	254.40 620.09 772.04						254.40 620.09 772.04	
	Level 4 - 5 Level 6 Level 7-10	2 x 1 x 4 x	772.04 651.74 684.92						1,544.07 651.74 2,739.70	
	Level 11-12 Level Roof (Elev. Lobby & Shefts) Excess Indoor Amenity (Proposed Amenity minus Required Amenity)	2 x 1 x	544.62 33.97 37.96						1,089.24 33.97 37.96	
0.0	Total Proposed GFA 3 Total GFA		37.90						7,880.97	
2.3	Existing GFA	floors 6							sq.m. 8,128.02	
	Proposed GFA Total GFA	12							7,880.97 16,008.99	
		otal GFA	÷	Site Area						
	Unit Count	6,008.99 sq.r	n.	9,291.31 sq.n	n.					
4.1	1 Existing Building- 1603 Bathurst St.	floors	ST	1BR	2 BR	3BR				
	Level 1 Level 2 - 4 Level 5	1 x 3 x 1 x	1 0 0	4 10 6	3 3 2	0 1 3				
	Level 6 Total Existing Units	1 x	1	9 49	1 15	2 8				
4.2	2 Existing-1601 Bathurst St. Level	floors 1 x	ST 0	1BR 5	2 BR	3BR 4				
4.3	Total Rental Replacement Units 3 Proposed Units -1601 Bathurst St.		0	5 NEW UNIT	0 r s	4	GROWING U	P UNITS		
	Level Lower 1 Level 1	floors 1 x 1 x	ST 0 0	1BR 0 1	2BR 0 0		2B-GU 0 0	3BR-GU 0 1		
	Level 2 Level 3 Level 4-5	1 x 1 x 2 x	0 0 1	3 2 2	2 3 4		0 1 1	2 3 2		
	Level 6 Level 7-10 Level 11-12	1 x 4 x 2 x	1 1 3	7 5 3	0 2 1		2 2 2	0 0 0		
	Total Proposed Units	13 x	13	43	23		17	10		
4.4	(*15% of suites to be Barrier-Free + 9 Rental replacement units) 4 Units After Construction		12%	41%	22%		16%	9%		
	Existing Building Proposed New Building								floors 6 12	
	Total Units After Construction Amenity Area									
	1 Required Indoor & Outdoor Amenity Area (New Building)				No of Hote					
	Indoor Amenity Outdoor Amenity Table Bergind by Amenity According to the Parity According to the Parit			2.00 2.00	No. of Units 106 106				sq.m. 212.00 212.00	
	Total Required Indoor & Outdoor Amenity Area (New Building) Indoor Amenity Area Provided (New Building)								424.00	
	Level 1 Lounge & Kids Play Room Rooftop Amenity Room								sq.m. 173.48 76.48	
	Total Indoor Amenity Area Provided (New Building) 3 Outdoor Amenity Area Provided (New Building)								249.96	
	Rooftop Pet Relief Area								sq.m. 198.55 20.00	
	Total Outdoor Amenity Provided Vehicular Parking								218.55	
6.2	2 Existing Parking Spaces Before Construction									
	At Grade Level (Surface Parking) Below Grade Level								Pa	rkin
6.3	Total Existing Parking Spaces Before Construction 3 Existing Parking Spaces to Remain After Construction									
6.3	At Grade Level (Reconfigured Surface Parking)	upant 0	Visitor 9	Оссиј	pant -Access	Vi	sitor- Access.		Pa	rkin
	Total Parking Spaces to Remain After Construction	58	0		0		0			
6.4	At Grade Level (Surface Parking Adjacent to 1603 Building)	upant	Visitor 2	Оссиј	pant -Access	Vi	sitor- Access.		Pa	rkir
	At Grade Level (Indoor - 1601 Building) Total New Proposed Parking	10	0		1					
6.5		upant 58	Visitor 9	Оссиј	pant -Access	Vi	sitor- Access.		Pa	rkir
		10 68	11		1		1			
7 1	Bicycle Parking 1 Bicycle Parking Required (New Building)									
	New Long-term New Short-term				7atio 0.90 0.10	units x 106 x 106			Pa	rkir
	Total Bicycle Parking Required				0.10	X 100				
7.2	2 Bicycle Parking Proposed (New Building) New Long-term (Indoor)				106	Outdoor 0			Pa	rkir
	New Short-term (Outdoor) Total Bicycle Parking Provided				0	12				
8.1	Proposed Building Coverage 1 Building Coverage							sq.m.	sq.ft.	
0.1	Existing 6 Storey Building							1,424.67 822.88 337.61	15,335 8,857 3,634	
0.1	Proposed 12 Storey Building Sidewalk Coverage							337.01	3,034	
0.1								5,121.01 1,585.14 9,291.31	55,122 17,062 100,011	

PROPOSED 12 STOREY DESIGN OPTION PROJECT STATISTICS

NTS

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	01	OPA / SPA / ZBA SUBMISSION	AUG 16, 2019

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STATISTICS

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1601 BATHURST STREET

TORONTO, ON

Drawn by:
D.N.

Checked by:
M.C.

Project
23-035

No.:

Oct. 03, 2025

Drawing No.

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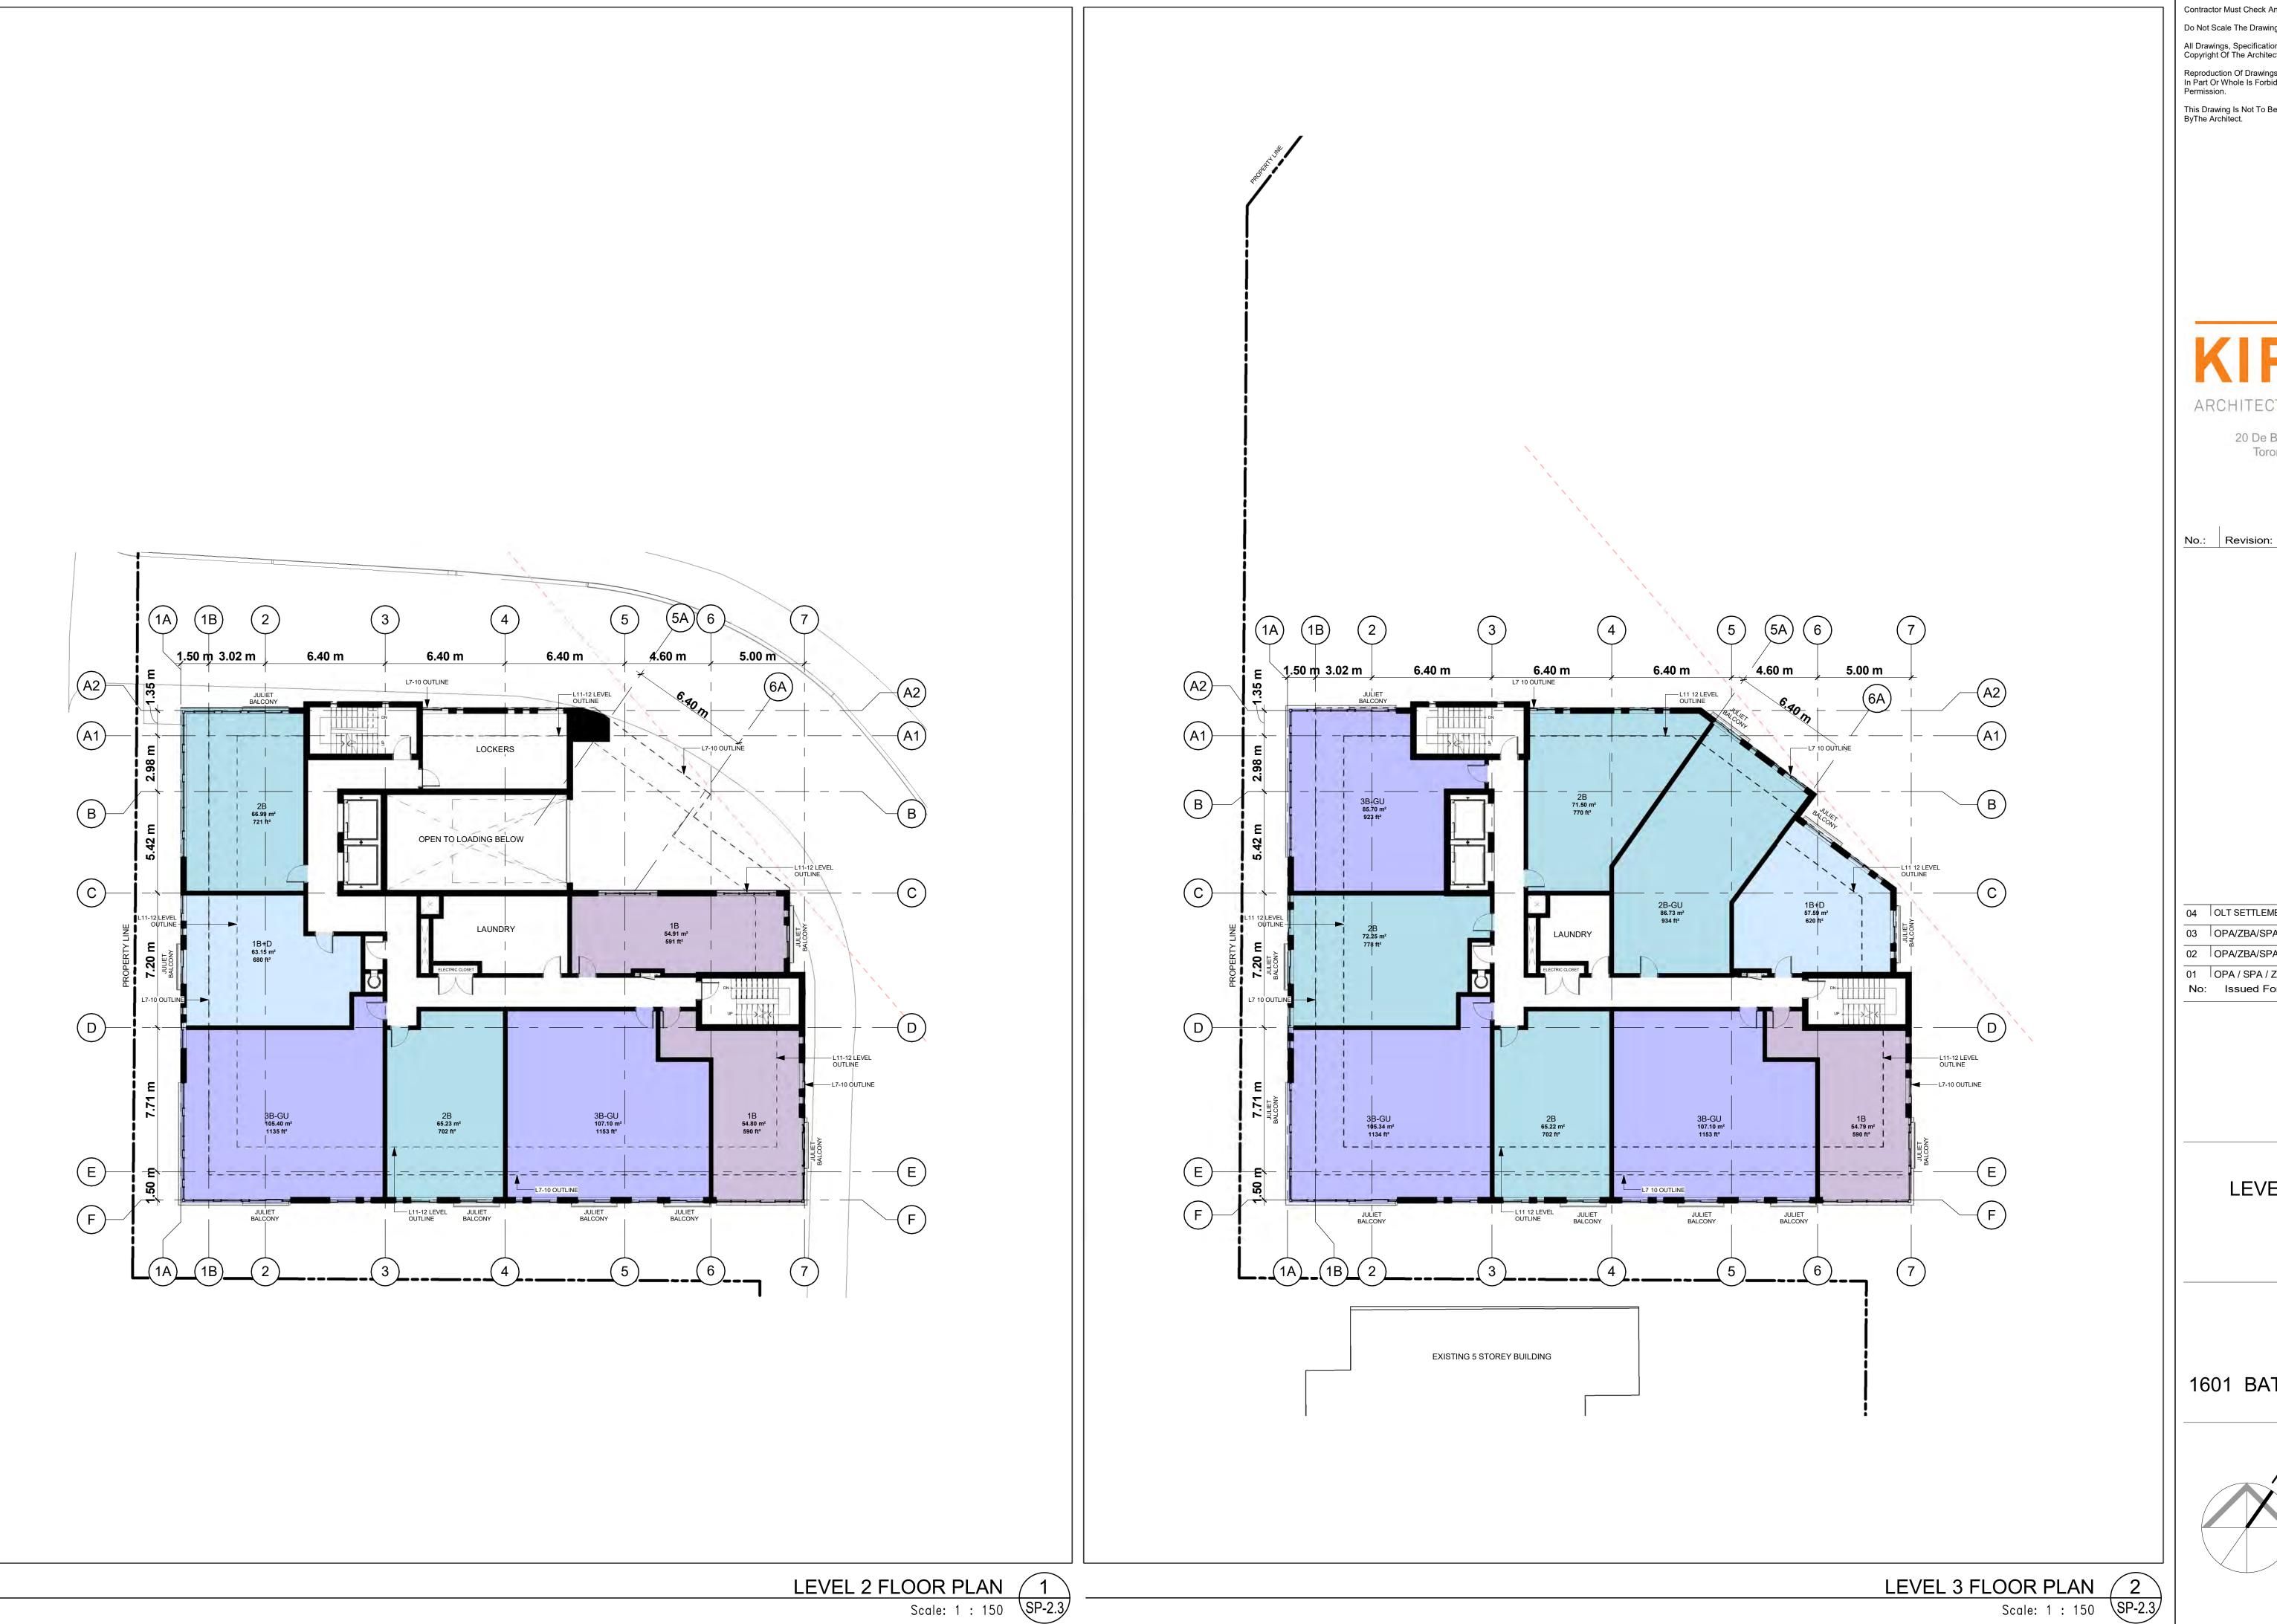
LOWER GROUND LEVEL & LEVEL 1 FLOOR PLANS

Checked by

1601 BATHURST STREET

TORONTO, ON As indicated

23-035 Oct. 03, 2025



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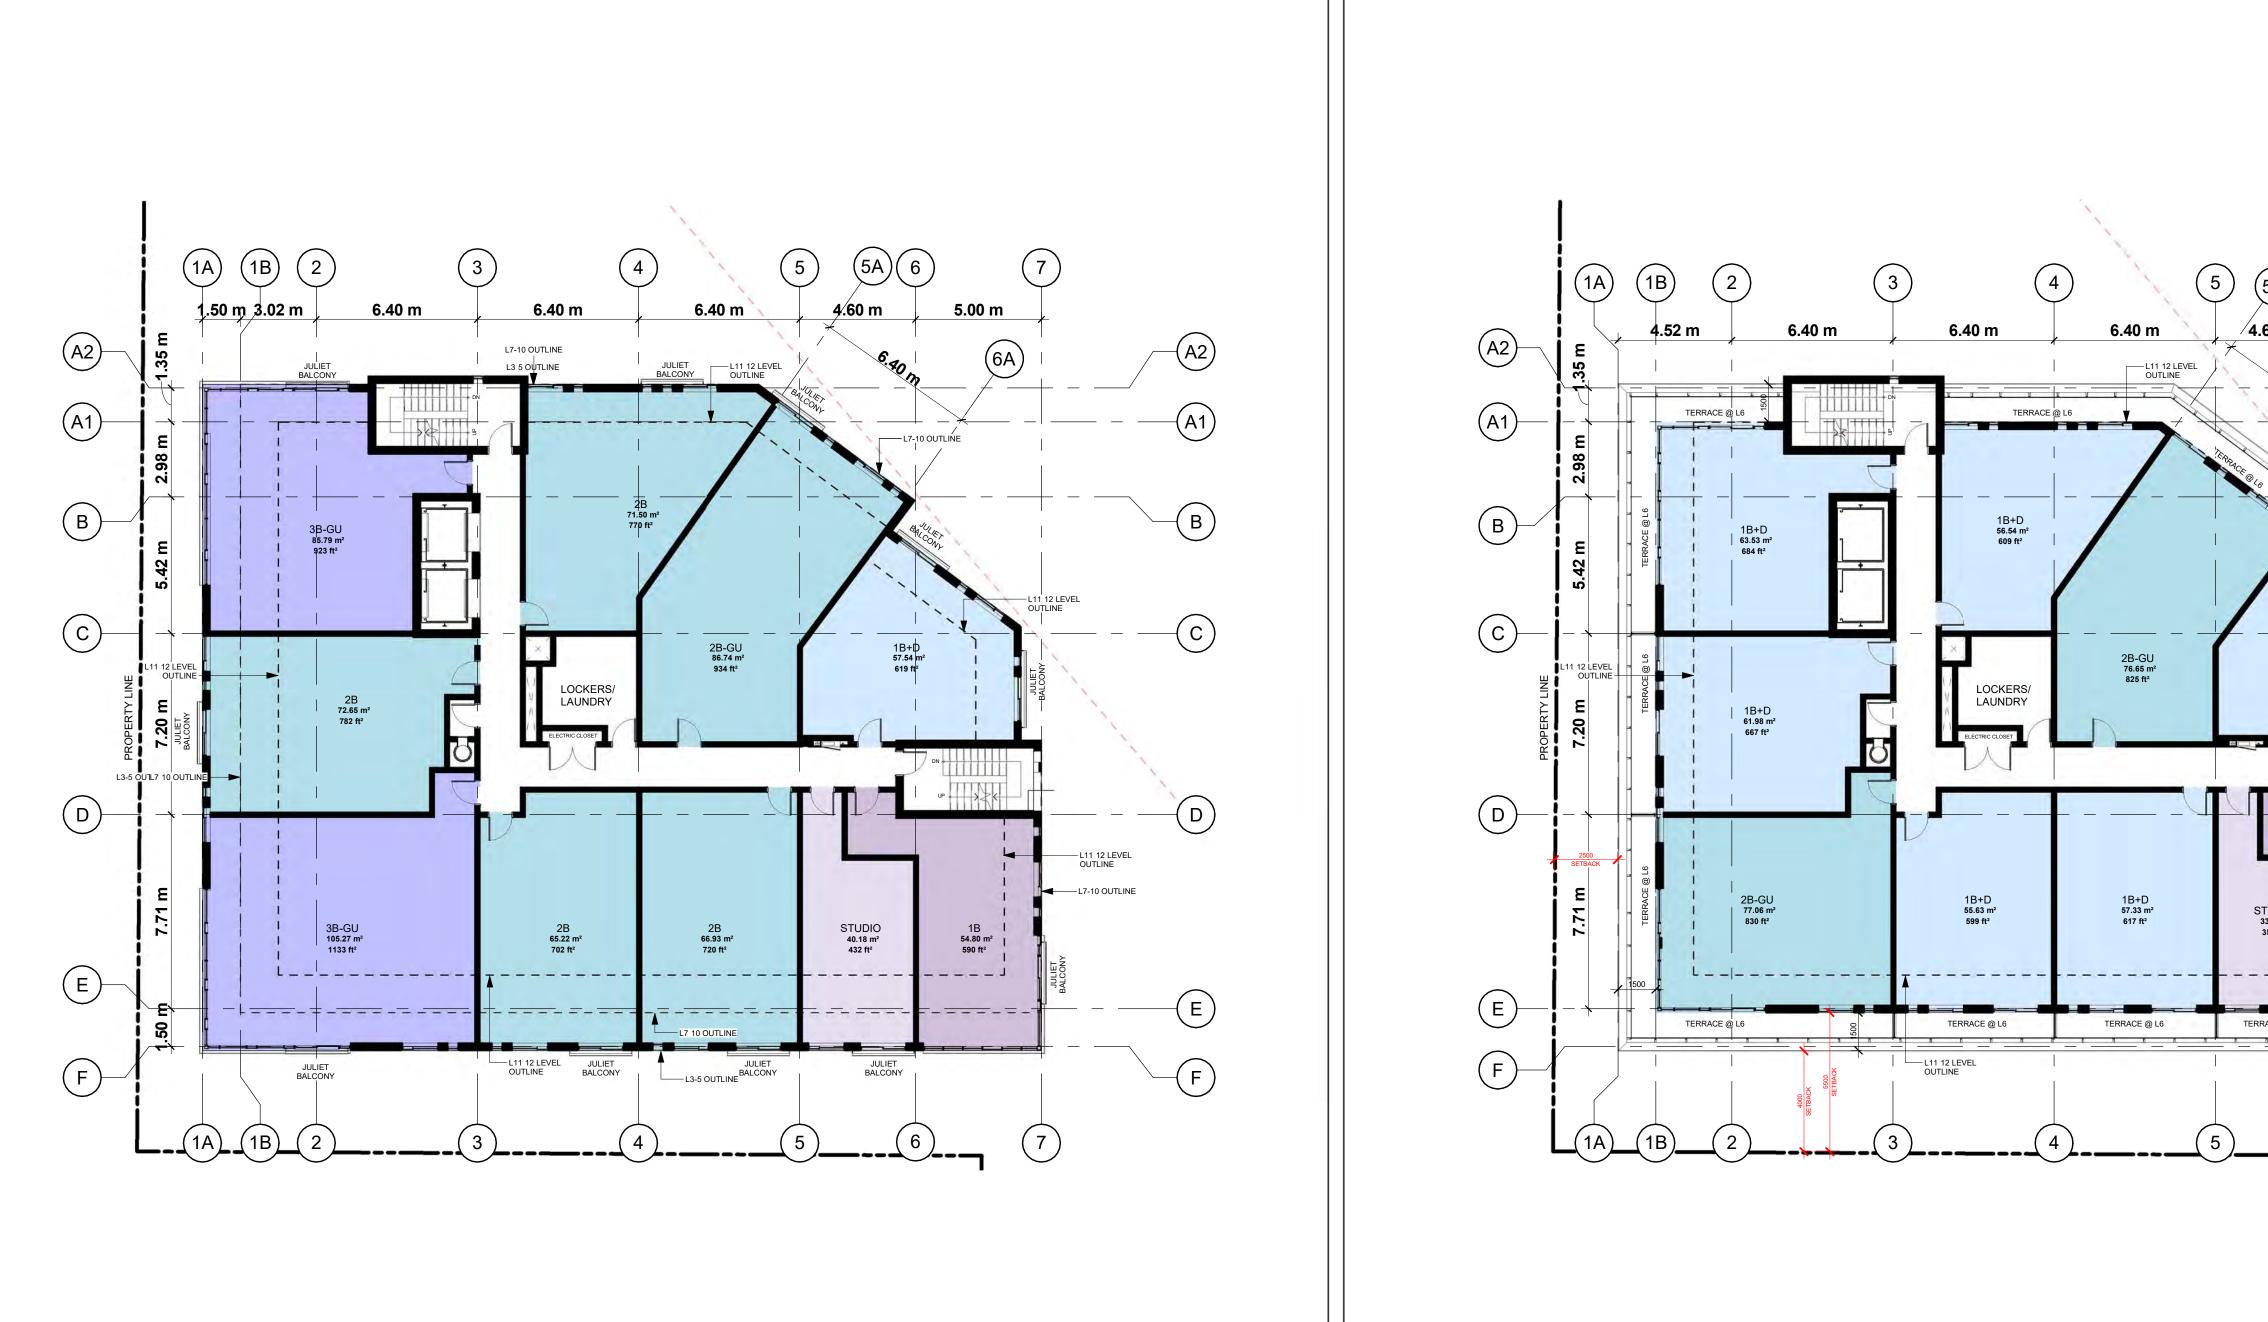
LEVEL 2 TO 5 FLOOR **PLANS**

1601 BATHURST STREET

TORONTO, ON 1:150

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23-035 Oct. 03, 2025



1B 47.30 m² 509 ft² TERRACE @ L6

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LEVEL 4 TO 6 FLOOR **PLANS**

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LEVEL 6 FLOOR PLAN



6.40 m

2B-GU 76.17 m² 820 ft²


TERRACE @ L11


----L3-5 OUTLINE


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TERRACE @ L11

2B-GU 72.95 m² 785 ft²



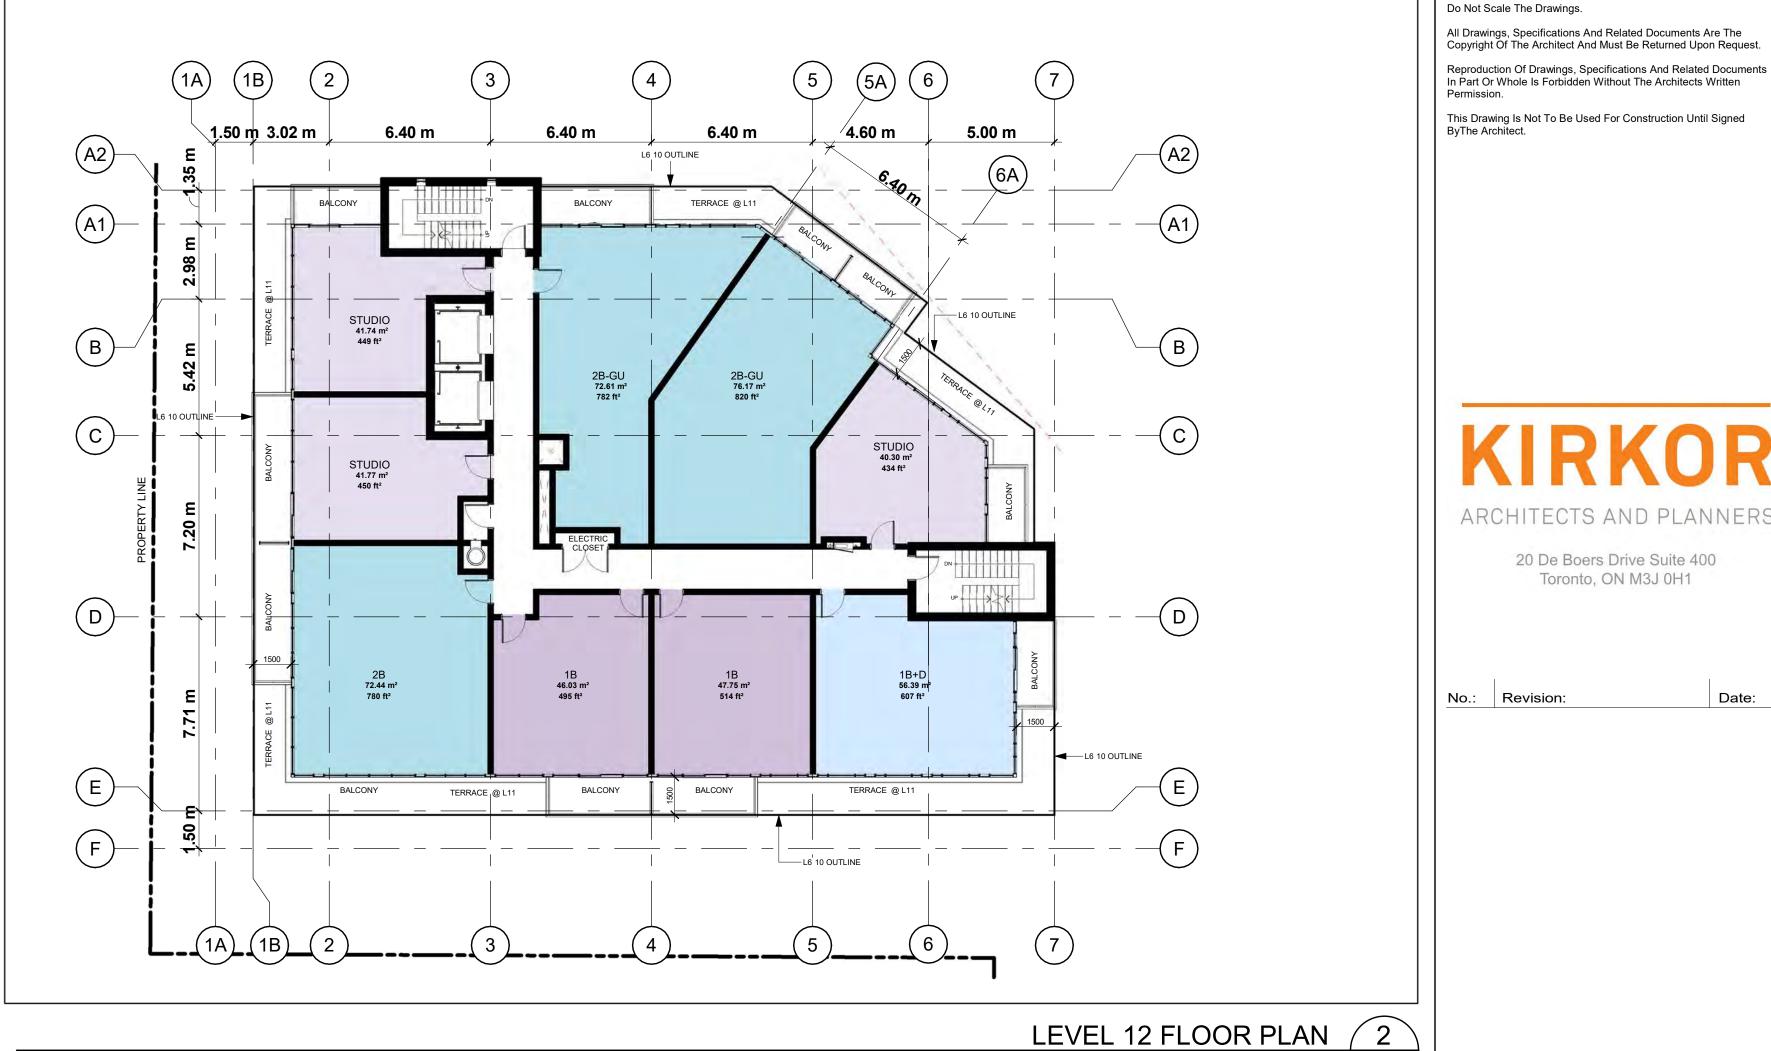

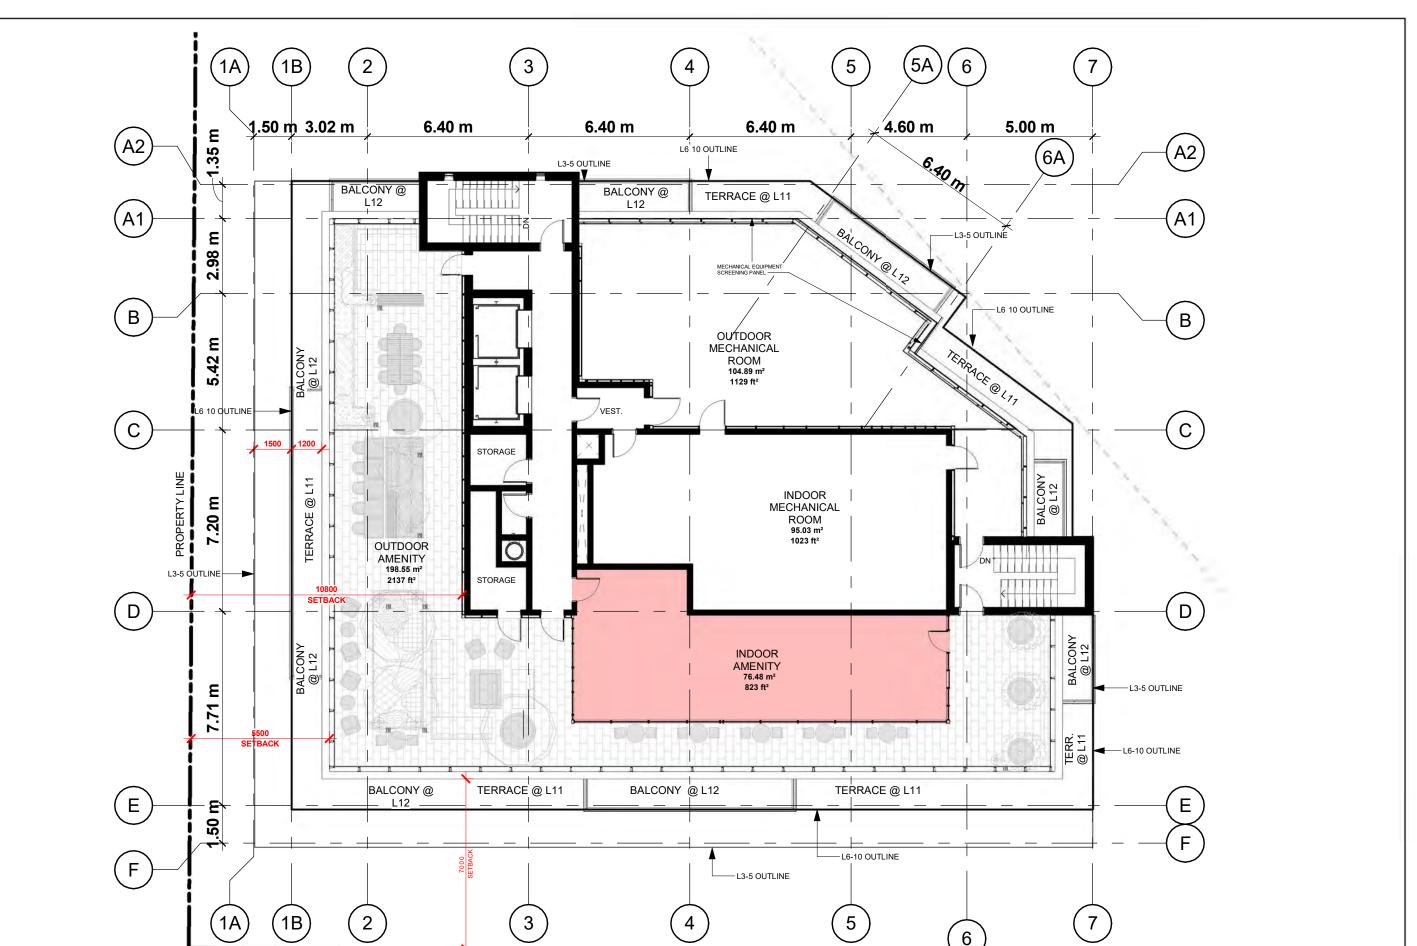

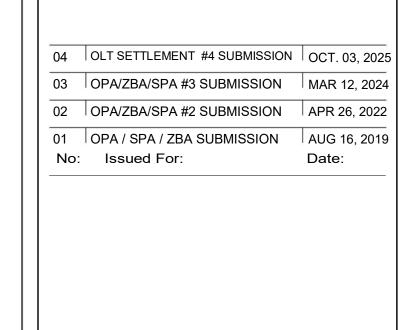Scale: 1 : 150

MPH LEVEL FLOOR PLAN

Scale: 1 : 150

SP-2.5

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Date:

Drawing Title:

LEVEL 7 TO 12, MPH FLOOR PLANS

TORONTO, ON

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1601 BATHURST STREET

1 : 150 23-035 Oct. 03, 2025

LEVEL 11 FLOOR PLAN

(c)

■ L3-5 OUTLINE

5.00 m

STUDIO 40.30 m² 434 ft²

TERRACE @ L11

Scale: 1 : 150

1.50 m 3.02 m

TERRACE @ L11

STUDIO 41.91 m² 451 ft²


(A2)-

(A1)-

D

6.40 m

TERRACE @ L11

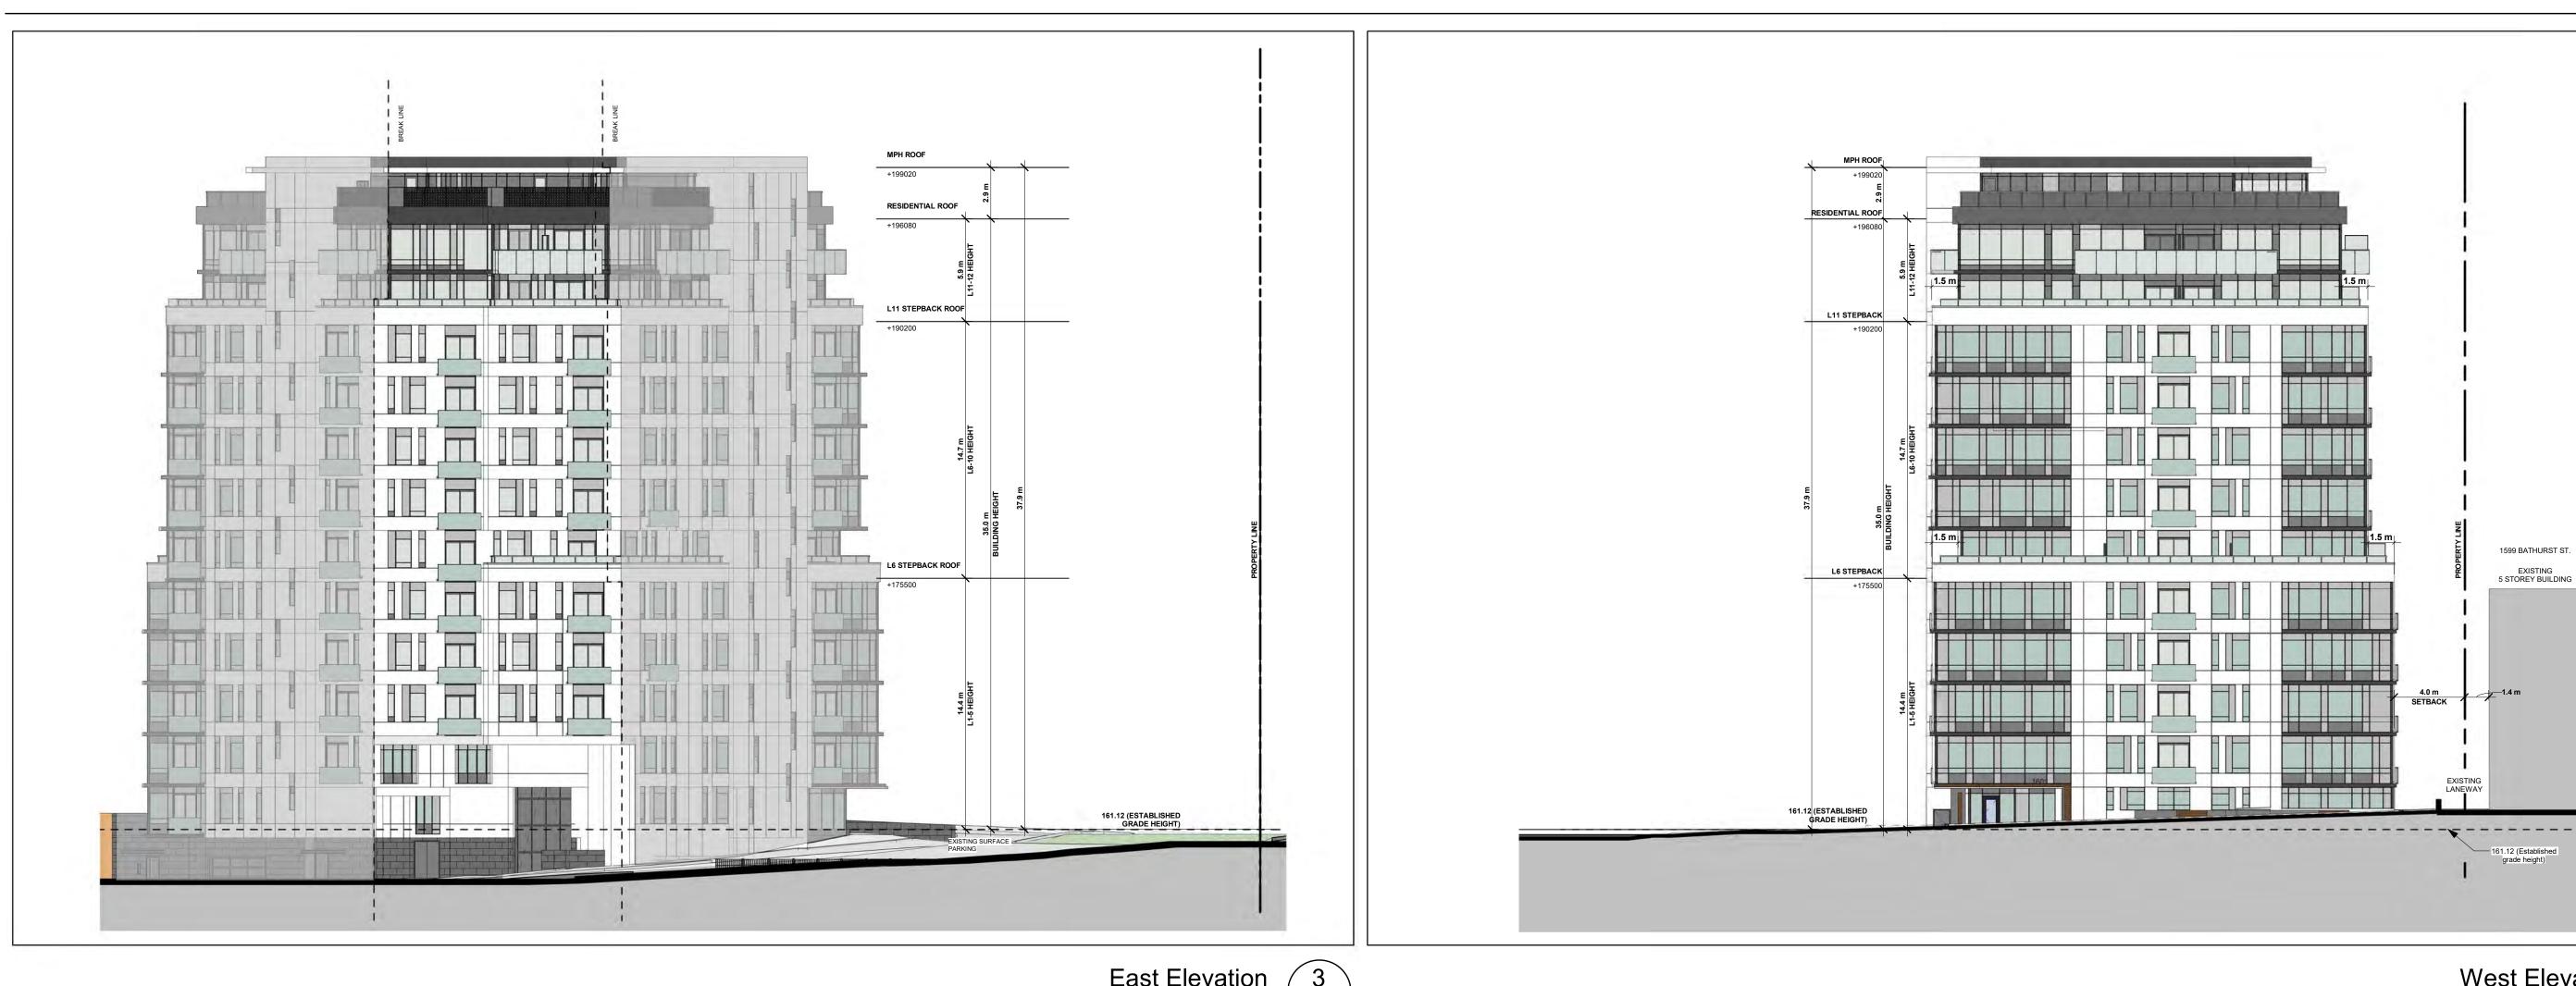

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East Elevation Scale: 1 : 200

North Elevation

Scale: 1 : 200 SP-3.2



West Elevation Scale: 1 : 200



Plot Date: 10/3/2025 1:59:29 PM File Path: Autodesk Docs://ACC-23035/KAP-ACC_23035P13_1601 Bathurst_RVT2023-12 Storeys.rvt



South Elevation SP-3.2 Scale: 1 : 200

1601 BATHURST STREET

TORONTO, ON 1:200

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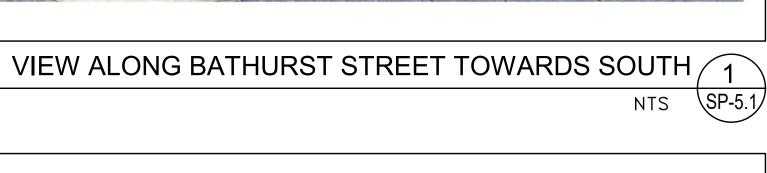
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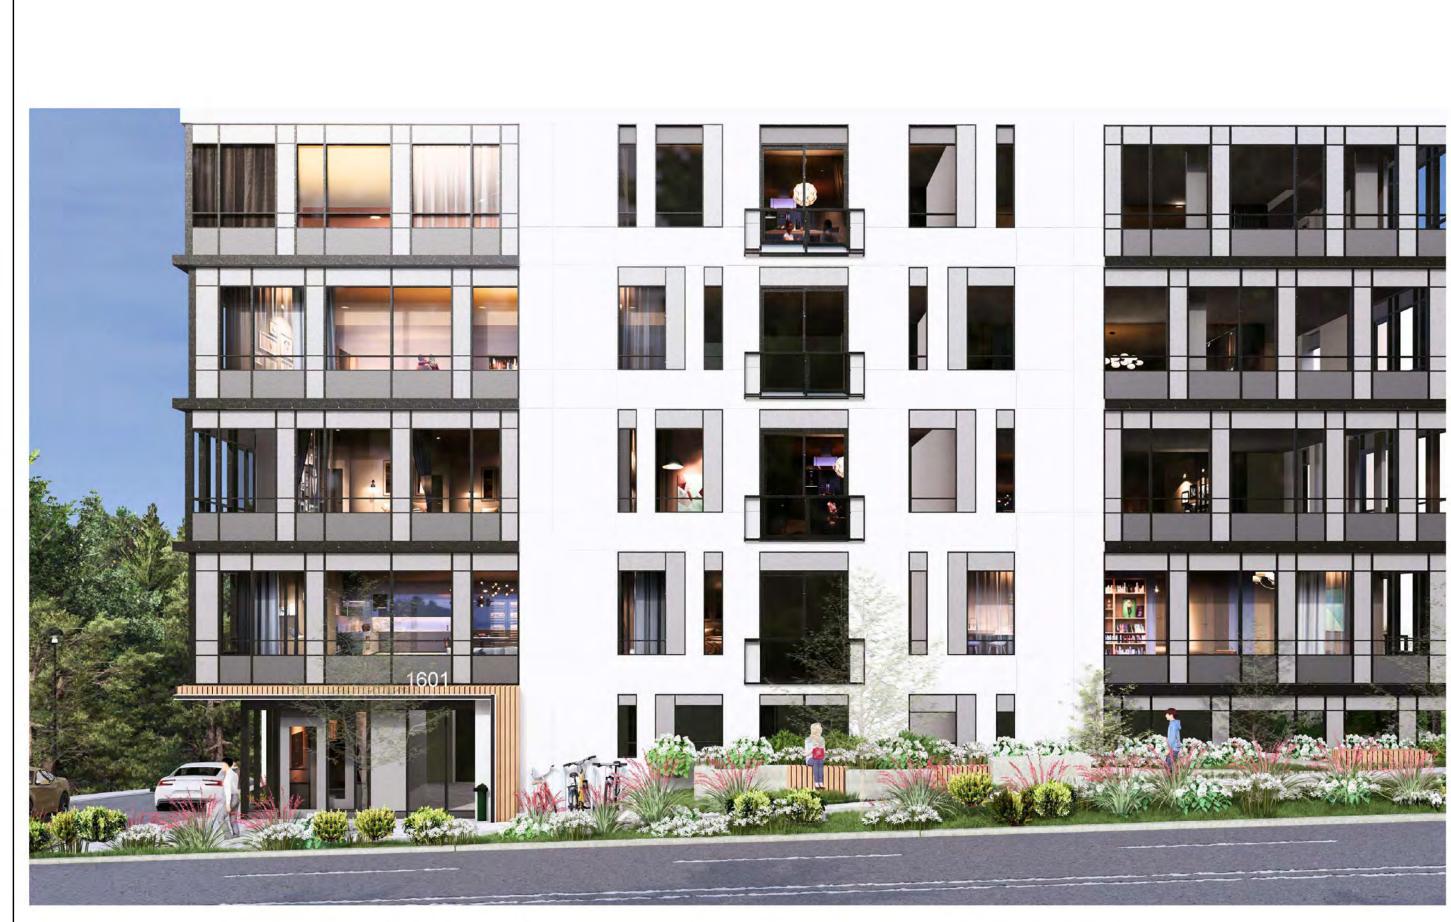
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ELEVATIONS









VIEW FROM BATHURST STREET 3 NTS SP-5.1



VIEW ALONG BATHURST STREET TOWARDS NORTH 2



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PERSPECTIVE VIEWS

Project:


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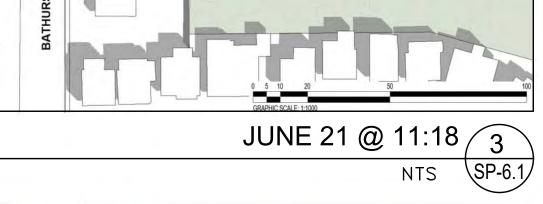
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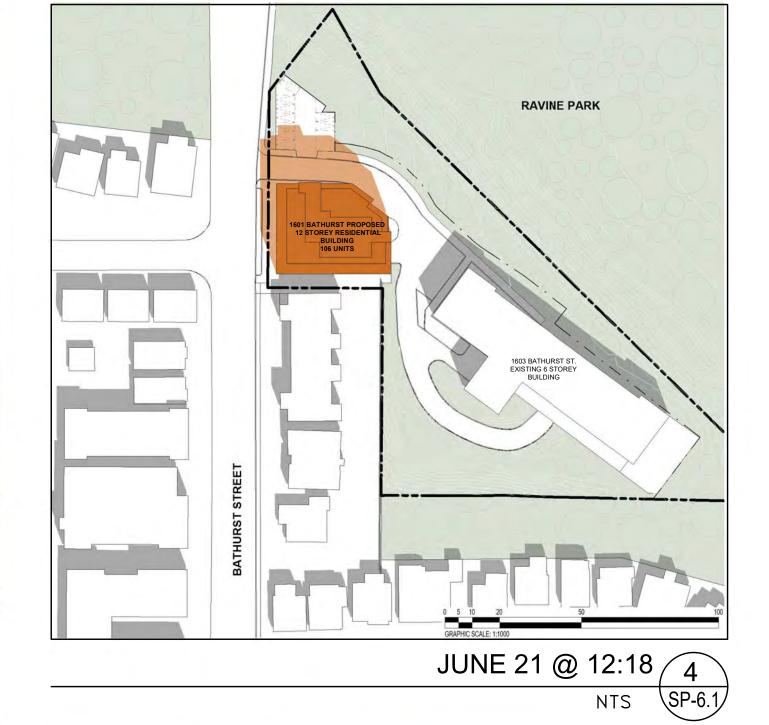








RAVINE PARK

JUNE 21 @ 15:18 7 NTS SP-6.1

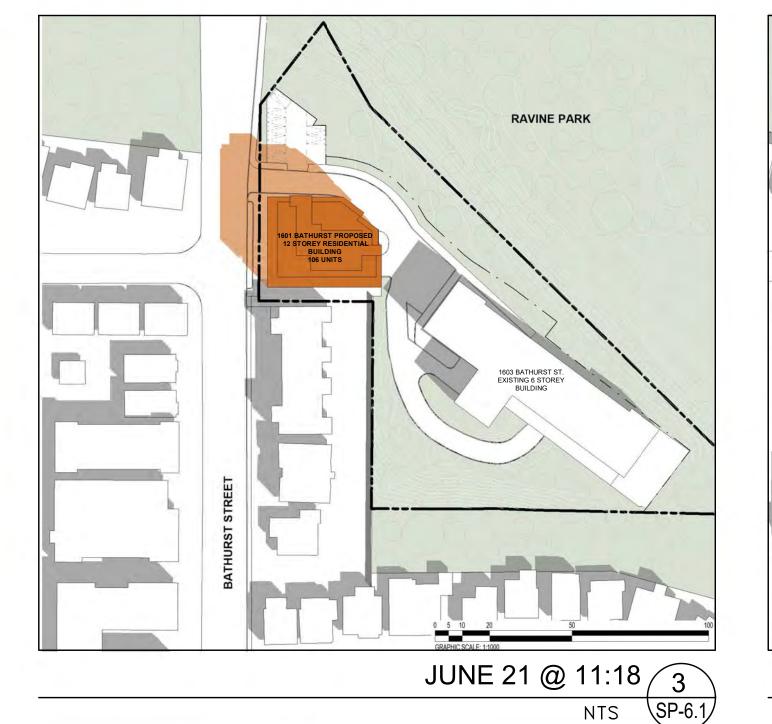

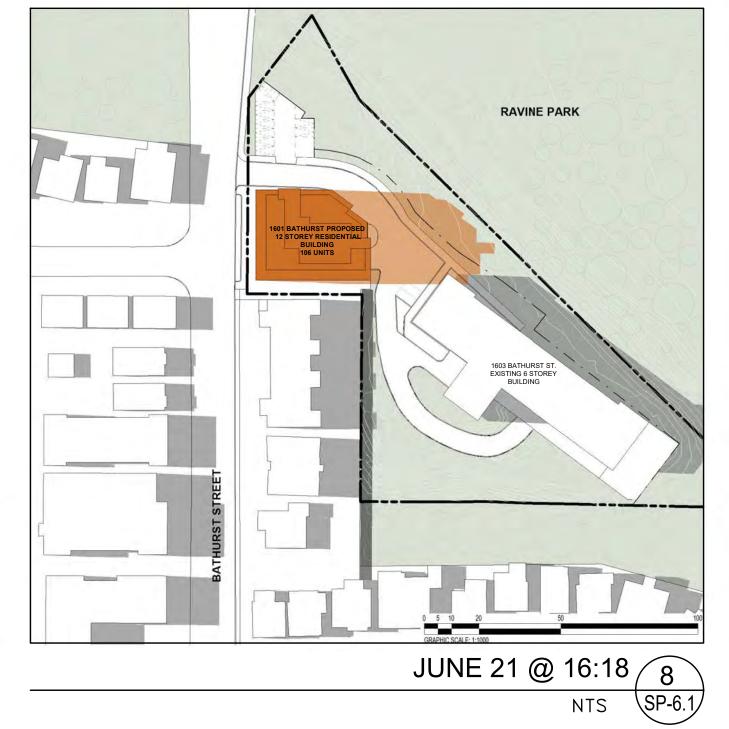

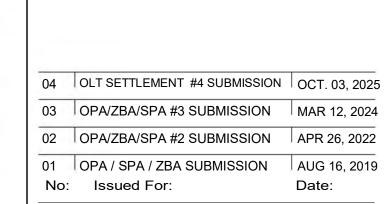

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JUNE SUN SHADOW STUDY (12 STOREYS)

Project:


1601 BATHURST STREET

TORONTO, ON 1:200 Checked by: 23-035 Oct. 03, 2025

SHADOW LEGEND 10 SP-6.1





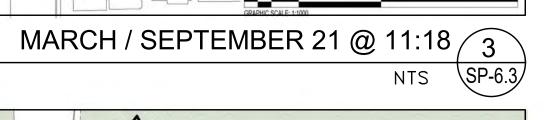

MARCH / SEPTEMBER 21 @ 15:18 7



MARCH / SEPTEMBER 21 @ 16:18 8 NTS SP-6.3



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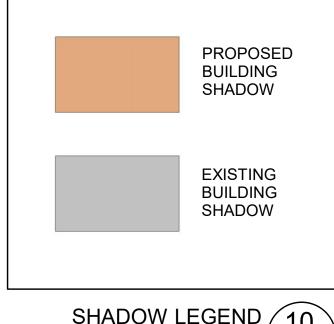
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MARCH / SEPTEMBER SUN SHADOW STUDY


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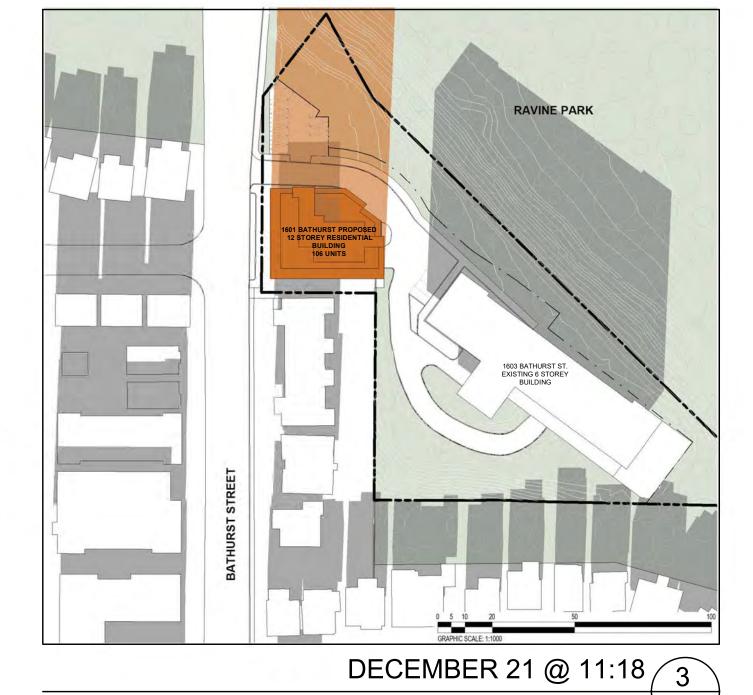


SHADOW LEGEND 10 SP-6.3








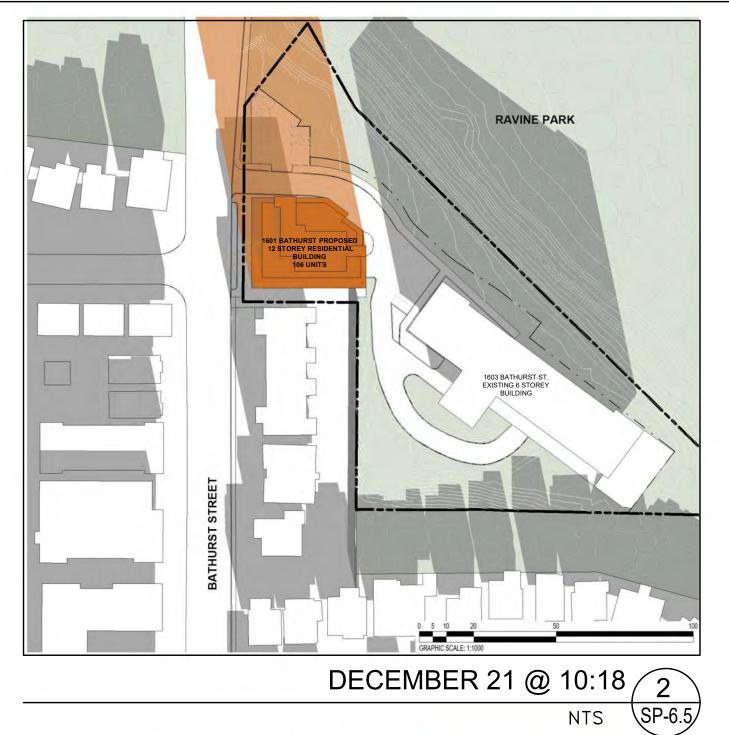

DECEMBER 21 @ 15:18 7 NTS SP-6.5

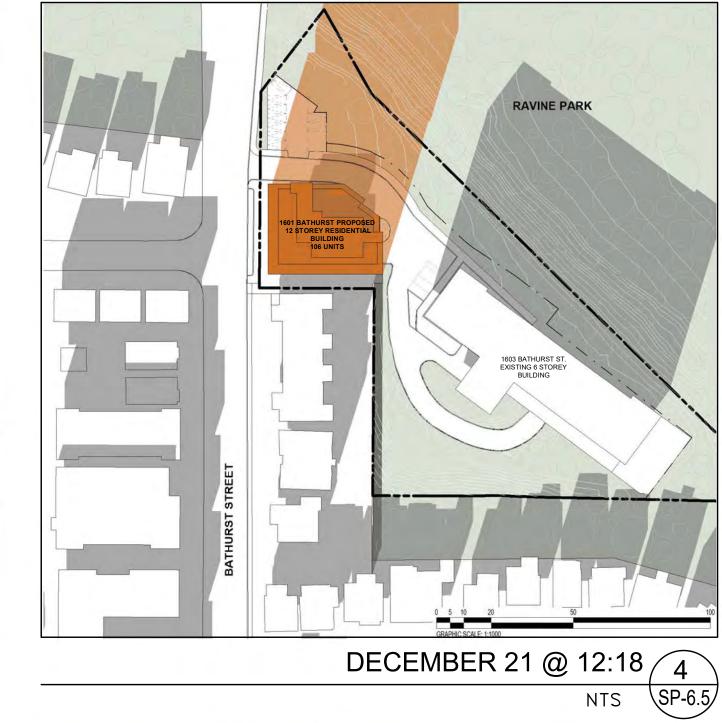



DECEMBER 21 @ 16:18 8 NTS SP-6.5

PROPOSED BUILDING

SHADOW

EXISTING BUILDING

SHADOW

SHADOW LEGEND 10 SP-6.5

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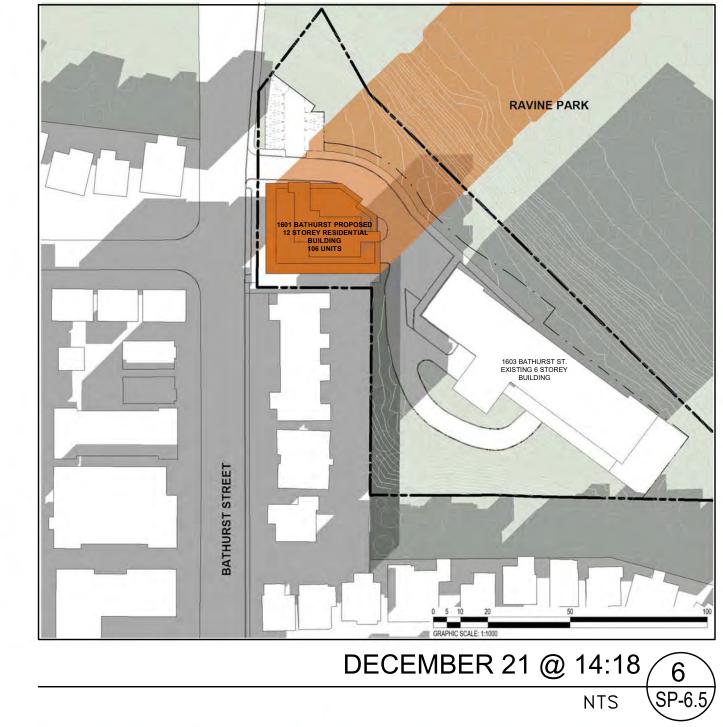
DECEMBER SUN SHADOW STUDY (12 STOREYS)

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DECEMBER 21 @ 18:18 10

DECEMBER 21 @ 17:18 9

DECEMBER 21 @ 13:18 5 NTS SP-6.5

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