

Toronto Local Appeal Body

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Email: tlab@toronto.ca

Website: www.toronto.ca/tlab

DECISION AND ORDER

Decision Issue Date Wednesday, April 25, 2018

PROCEEDING COMMENCED UNDER Section 45(12), subsection 45(1) of the

Planning Act, R.S.O. 1990, c. P.13, as amended (the "Act")

Appellant(s): JULIE WANG

Applicant: MARIN ZABZUNI

Property Address/Description: 14 GOUGH AVE

Committee of Adjustment Case File Number: 17 213505 STE 30 MV (A0865/17TEY)

TLAB Case File Number: 17 278520 S45 30 TLAB

Hearing date: Monday, April 23, 2018

DECISION DELIVERED BY Ian James LORD

APPEARANCES

Name	Role	Representative
Julie Wang	Appellant	Meaghan McDermid
Edmond Wang	Owner	Meaghan McDermid
Martin Rendl	Expert Witness	J
John Trumpener	Party	
David Chang	Participant	
Kathryn Fisher	Participant	

INTRODUCTION

This was a Motion for a Settlement Hearing in respect of 14 Gough Avenue (the 'subject property') in respect of a Hearing scheduled for May 1, 2018. The Motion, dated April 6, 2018, was followed by a Notice of Electronic (Teleconference) Hearing, on April 10, 2018. That Notice provided for objections to the Hearing format and for the following direction:

IN THE EVENT THAT A SETTLEMENT HEARING IS NOT CONCLUDED OR IS UNSUCCESSFUL, THE HEARING ORIGINALLY SCHEDULED FOR MAY 1, 2018 AT 9:00 AM REMAINS AND NO FURTHER NOTICE OF HEARING SHALL BE PUBLISHED.

The Notice of Motion requested the Settlement Hearing, the allowance of revisions to the variances sought and the approval of revised variances, the latter in accordance with revised plans attached as Exhibit's 'C' and 'B' to the Affidavit of Martin Rendl, Planner, sworn April 6, 2018, respectively.

BACKGROUND

The subject property is located on the west side of Gough Avenue, east of Carlaw Avenue, north of Harcourt Avenue and south of Danforth Avenue in the Riverdale area of the City of Toronto ('City'). The applicant proposed, essentially, a demolition and rebuild of an existing one and one-half storey bungalow style residence built in the early 1900's. The Committee of Adjustment ('COA') refused the requested variances; both prior to the COA decision and on the applicants Appeal, revisions were made to the project as revealed in the Applicants Disclosure, filed February 5, 2018.

Those revisions moved the footprint of the building 0.57 m to the east; they also eliminated a rear carport, as shown is attached plans dated January 26, 2018.

Under the Rules of the Toronto Local Appeal Body (the 'TLAB'), one person apart from the applicant/Appellant, registered as a party and filed a Witness Statement, Mr. John Trumpener.

Another party status was elected but no further filings were received and no appearance was made.

Several Participants filed statements in support of the applicant, including Kathryn Fisher and David Chang, both of whom participated in support of the appeal on the return of the Motion.

The Appellant, Julie Wang, also attended and was represented by counsel, Ms. Meaghan McDermid.

MATTERS IN ISSUE

Ms. McDermid provided an overview of the settlement reached with Mr. Trumpener. In brief, it involved a further set of revision to the Appellants plans; however, the list of variances did not require further revision.

She asked for an oral decision.

I set as Exhibit 1 to the teleconference, the Witness Statement of Martin Rendl, dated February 14, 2018.

Decision of Toronto Local Appeal Body Panel Member: I. Lord TLAB Case File Number: 17 278520 S45 30 TLAB

I set as Exhibit 2 to the teleconference, the Affidavit of Martin Rendl, sworn April 6, 2018, in support of the Motion of the same date.

I set as Exhibit 3 to the teleconference, the further revised site plan, elevations and floor plans attached as Exhibit 'B' to the Rendl affidavit, Exhibit 3.

And I set as Exhibit 4 to the teleconference, the revised set of variances attached as Exhibit 'C' to the Rendl affidavit, Exhibit 3.

Mr. Rendl was present on the teleconference; his testimony was on affirmation.

It is these plans and variances, above, that were the subject matter of the Settlement Hearing.

JURISDICTION

Provincial Policy – S. 3

A decision of the Toronto Local Appeal Body ('TLAB') must be consistent with the 2014 Provincial Policy Statement ('PPS') and conform to the Growth Plan of the Greater Golden Horseshoe for the subject area ('Growth Plan').

Minor Variance - S. 45(1)

In considering the applications for variances form the Zoning By-laws, the TLAB Panel must be satisfied that the applications meet all of the four tests under s. 45(1) of the Act. The tests are whether the variances:

- maintain the general intent and purpose of the Official Plan;
- maintain the general intent and purpose of the Zoning By-laws;
- are desirable for the appropriate development or use of the land; and
- are minor.

EVIDENCE

Despite the discussion that had successfully concluded in the agreement of Mr. Trumpener, all the variances sought remained for disposition. Mr. Trumpener had, on Ms. McDermid's description, been satisfied with the modifications to the proposal to extend and fill out the second floor footprint while simultaneously reducing a near equivalent amount of building space on the third floor level. The reduction entailed a balcony and notch in the west and north limit of the subject property's third floor. The effect is to reduce the mass and allow better sunlight penetration into 16 Gough Avenue, the property to the immediate north owned by Mr. Trumpener.

Mr. Rendl confirmed that the settlement terms with Mr. Trumpener were represented in the Exhibit 3 plans. I include those plans as **Attachment 1** hereto.

The Participants present supported the revised plans.

Mr. Rendl is senior member of the planning profession and a Registered Professional Planner. He had supplied the attestation on Expert's Duties in Form 6 of the TLAB and affirmed his Witness Statement and Affidavit, Exhibits 1 and 2, hereto.

There was no contrary opinion evidence provided.

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Both documents, Exhibits 1 and 2, attest to a thorough canvass of area character, applicable provincial and City policy and the manner and means by which the variances sought in Exhibit 4 meet the four statutory tests, above recited.

It was his opinion that the variances in Exhibit 4 are consistent with the Provincial Policy Statement and conform to the Growth Plan, as expressed in paragraphs 32-36 of Exhibit 1.

It was further his opinion that the variances meet the four tests set out in section 45(1) of the Planning Act, as expressed in paragraphs 38-81 of Exhibit 1.

I have no reason to question his conclusion, in paragraph 82 of the Witness Statement, Exhibit 1, that the variances detailed in Exhibit 4, individually and collectively, "represent good planning and their approval in in the public interest."

This affirmation was reasserted in his later affidavit, Exhibit 2.

The requested variances detailed in Exhibit 4 are included as **Attachment 2** hereto.

Specifically, he said that the floor space index measurement (including arising from the space movement above described), in both applicable by-laws, from a .6 times coverage to 1.05 times, is contained in the concise built form of this narrow (6.0 m wide) lot. He notes that it is well represented by existing built form and approvals in the neighbourhood.

The flat roof structure proposed requires relief from By-law 569-2013's standard of 7.5 m for the front and rear exterior main wall heights, to 9.68 m. This height is consistent with adjacent buildings. The ultimate roof height of 9.88 m which falls below the maximum height permission of 10 m. Three storey buildings and buildings with flat rooves and a diversity of architectural styles, including recent approvals, are well represented in his neighbourhood analysis.

Finally, the building setbacks identified relative to By-law 438-86, in light of existing conditions of building proximity and neighbourhood examples, were described as 'technical' and compliant - without variance necessary to the new City By-law 569-2013.

Mr. Rendl described to me that these conclusions were reached on a consideration of all prescribed criteria under section 4.1.5 of the Official Plan and were consistent with the decision of the Ontario Municipal Board, dated March 1, 2018 in respect of By-law 569-2013 (PL30592). He maintained that it remained good practice to address all identified Plans Examiners' variance requirements.

He was of the view that the settlement with Mr. Trumpener, in the substitution of second and third floor enclosed spaces, did not require alteration in the floor space index and gross floor area calculations.

Having attended the site and rear lane, I enquired of Mr. Rendl the expectation for the large conifer tree in the front yard. Unexpectedly, he deferred to Ms. Wang, as no record of a tree application or assessment was made in any of the documentation that was pre-filed. Its absence promoted the expectation that its survival, without impact, might be anticipated.

Not so.

Ms. Wang indicated that she had had informal discussions with Urban Forestry and the local councilor's office on the subject of removal and possible replanting (with a maple tree), subject to a permit application and consideration.

The existing tree has a substantial and imposing presence.

Ms. McDermid acknowledged that a condition requiring a permitting process with Urban Forestry would be appropriate.

ANALYSIS, FINDINGS, REASONS

I find that, in the absence of anything to the contrary, proceeding with a settlement Hearing by way of teleconference is appropriate having due regard to the Motion materials and Rules 19.4 and 24.4 of the TLAB Rules.

I find as well that the reduced number of variances identified in Attachment 2 are compliant with an assessment of elimination or reduction. As Mr. Rendl opined and the Applicants Disclosure revealed, no further Notice of these revisions is necessary pursuant to section 45 (18.1.1) of the Planning Act.

The settlement of a variance appeal, even one resulting from the refusal of the COA is a desirable outcome. I expressed my appreciation to Ms. Wang for the diligence exhibited by her is canvassing and achieving the support of many neighbours. It is indeed refreshing to see independent letters of support and teleconference attendances speaking in support of a settlement.

I commend Mr. Trumpener, as well, for his co-operative approach to the resolution of matters of concern.

I accept the professional land use planning assessment and opinion evidence of Mr. Rendl and the terms of the settlement as expressed through the revised plans, Attachment 1 and the reduced Variances sought, Attachment 2, for the reasons above expressed.

I find that on the basis of this evidence and opinion advice, the variances sought should be approved in the interests of good community planning.

They meet the requisite provincial policy planning considerations and the statutory tests for variance approvals, individually and collectively. I reach this conclusion on the evidence before me having considered the decision of the COA and the material before that body.

DECISION AND ORDER

The appeal from the Committee of Adjustment mailed December 12, 2017 is allowed in part.

The variances identified in Attachment 2 hereto are approved, subject to the following conditions:

- Construction at 14 Gough Avenue shall be substantially in accordance with the site plan and elevation drawings, specifically, contained within Attachment 1 hereto;
- Prior to the issuance of a building permit, the applicant shall satisfy all
 conditions in an application for a permit concerning private or City owned
 trees in the proposed front yard on Gough Avenue, if required, to the
 satisfaction of the Director, Parks, Forestry & Recreation, Urban Forestry
 Services.

Decision of Toronto Local Appeal Body Panel Member: I. Lord TLAB Case File Number: 17 278520 S45 30 TLAB

The Hearing Date, currently scheduled for May 1, 2018 is hereby released. No attendance is required.

Ian Lord

Panel Chair, Toronto Local Appeal Body

Can James Lord

Signed by: Ian Lord


SURVEY INFORMATION:

INFORMATION TAKEN FROM: SURVEYOR'S REAL PROPERTY REPORT PART 1 - PLAN OF LOT 13 REGISTERED PLAN 306-E CITY OF TORONTO

PREPARED BY: AKSAN PILLER CORPORATION LTD.

ONTARIO LAND SURVEYORS

DATED: DECEMBER 23, 2016

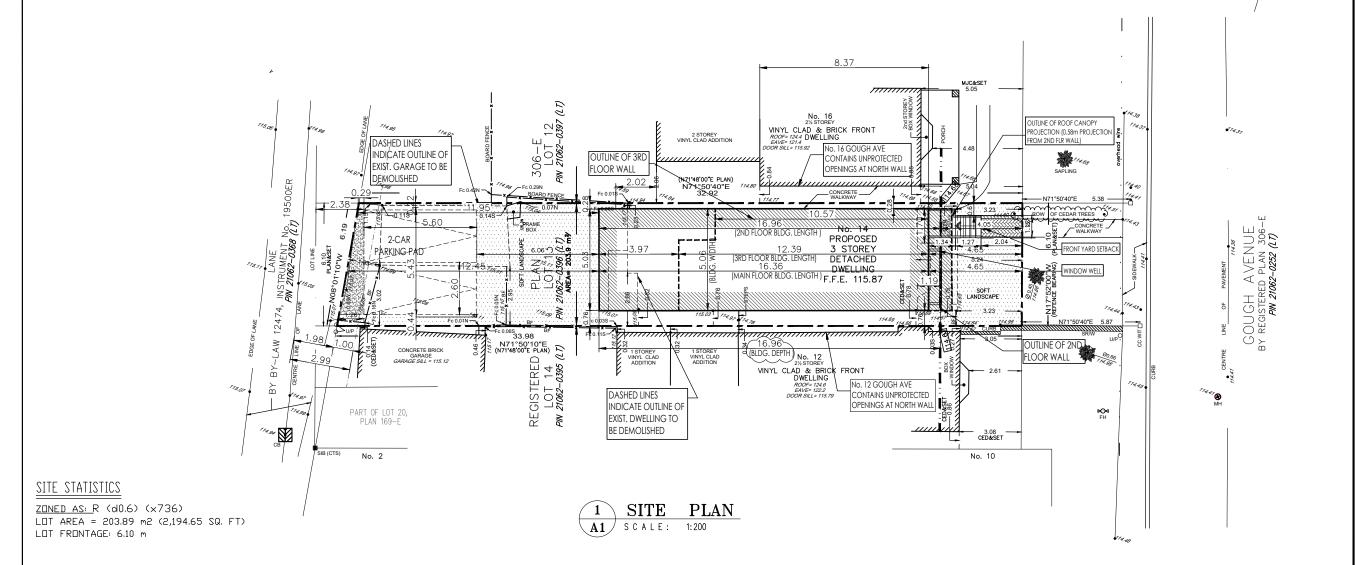

Attachment 1

PROPOSED FRONT YARD LANDSCAPE:

FRONT YARD AREA = 28.29 m2 (304.51 S.F.)
MIN. SOFT LANDSCAPE AREA REQUIRED (75%)=21.22m2 (228.41 S.F.)

3RD FLOOR PROJECTION = 5.87 m2 (63.18 S.F.)
PORCH & STAIRS AREA = 2.09 m2 (22.50 S.F.)
WALKWAY AREA = 2.76 m2 (29.71 S.F.)
PROPOSED SOFT LANDSCAPE AREA = 17.57 m2 (189.12 S.F.) (62.11%)

PROPOSED REAR YARD LANDSCAPE:

REAR YARD AREA = 75.90 m2 (816.98 S.F.)
MIN. SOFT LANDSCAPE AREA REQUIRED (50%)
= 37.95 m2 (408.49 S.F.)

PROPOSED PARKING PADS = 29.10m2 (313.23 S.F.) PROPOSED REAR ASPHALT AREA =3.96m2 (42.62 S.F.)


PROPOSED SOFT LANDSCAPE AREA = 42.84 m2 (461.12 S.F.) (56.44%)


ROPOSED G.F.A.:	EXIST. A	AREA	PROP. A	AREA	TOTAL.	AREA	
	m2	SQ.FT	m2	SQ.FT	m2	SQ.FT	
IST FLOOR AREA:	73.20	787.91	9.69	104.28	82.89	892.19	
2ND FLOOR AREA:	36.78	395.95	37.59	404.64	73.45	790.59	
3RD FLOOR AREA:	0.00	0.00	57.72	621.29	57.72	621.29	
TOTAL AREA:	109.98	1,183.86	104.99	1,130.21	214.08	1 2:3(24:3:2	1.05 TIN

	DRAWN BY M.Z.	APPROVED BY M.Z.	DRAWING No.	- - - -
DRAWING SITE PLAN	SCALE AS-NOTED	DATE MAR.24,2018	PROJECT No.	10-/102
DO NOT SCALE DRAWNINGS. ON DOT SCACLE DRAWNINGS. COUTRACTOR SHALL CHECK AND VEREY ALL DIMENSIONS AND REPORE TANY OMISSIONS OR DISCREPANCIES TO CONTEMPO STUDIO BEFORE PROCEEDIN SHIT WORK. ALL PRIVIS AND SPECIFICATIONS ARE THE PROPERTY OF CONTEMPO	STUDIO AND SHALL NOT BE COPIED. IN PART OR WHOLE WITHOUT PROBLEM WRITTEN PERMISSION PROJECT. PROJECT. 2. CT. DIT. A. D. DIT. A. D. DIT. A. D.	rkolosed s sioret addition & interior alterations At	14 GOUGH AVE	





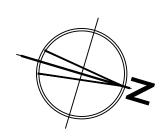

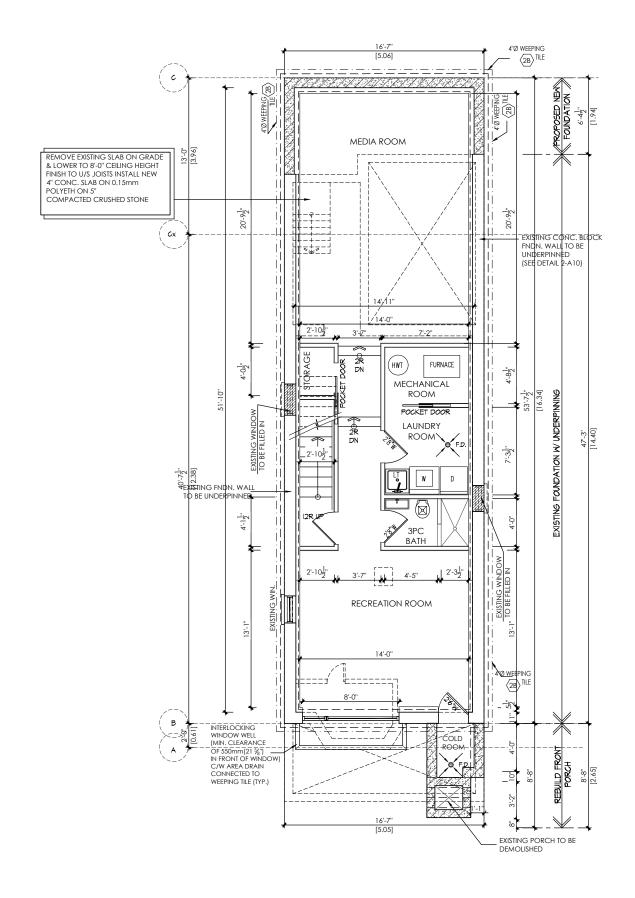

S.B. SOLID WOOD BEARING

F.D. FLOOR DRAIN

A.D. AREA DRAIN

NEW PARTITIONS

I.S.A. INTERCONNECTED SMOKE ALARM

C.M.D CARBON MONOXIDE DETECTOR \odot

MECHANICAL VENTILATION

BASEMENT PLAN A-2 SCALE: 3/16"=1'-0"

46972 BCIN

EXISTING PERIMETER TO REMAIN			
EXISTING WALL	EXISTING WALL	EXISTING WALL	% OF WALL AREA TO
LXISTINO PALL	LENGTH	LENGTH REMAINING	REMAIN
EAST (FRONT)	228"	0	0%
WEST (REAR)	219"	0	0%
NORTH	567"	567"	100%
SOUTH	567"	567"	100%
TOTAL:	1581"	1134"	<u>71.72%</u>

contempostudio



14 ARNOLD AVE. TORONTO, ONT., M6N 4M9 INFO@CONTEMPOSTUDIO.CA W. CONTEMPOSTUDIO.CA T. (416) 836-1042 F. (416) 485-1042

The undersigned has reviewed and takes responsibility for this design, and has the qualifications and meets the requirements set out in the Ontario Building Code to design the work shown on the attached documents:


QUALIFICATION INFORMATION
Required unless design is exempt under 3.2.4.3.(5) Division C of the Ontario Building Code.

MARIN ZABZUNI NAME SIGNATURE NAME SIGNATURE
REGISTRATION INFORMATION
Required unless design is exempt under 3.2.4.7. Division C of the Ontario Building Code.

CONTEMPO STUDIO FIRM NAME

CONTRACTOR SHALL CHECK AND VERIFY ALL DIMENSIONS AND	DRAWING		
REPORT ANY OMISSIONS OR DISCREPANCIES TO CONTEMPO STUDIO BEFORE PROCEEDING WITH WORK. ALL PRINTS AND SPECIFICATIONS ARE THE PROPERTY OF CONTEMPO	BASEMENT PLAN		
STUDIO AND SHALL NOT BE COPIED, IN PART OR WHOLE WITHOUT PRIOR WRITTEN PERMISSION	SCALE	DRAWN BY	
PROJECT	AS-NOTED	M.Z.	
PROPOSED 3 STOREY ADDITION	DATE	APPROVED BY	
&INTERIOR ALTERATIONS AT	MAR.24,2018	M.Z.	
14 GOUGH AVE	PROJECT No.	DRAWING No.	
CITY OF TORONTO	2017-01	Δ-2	



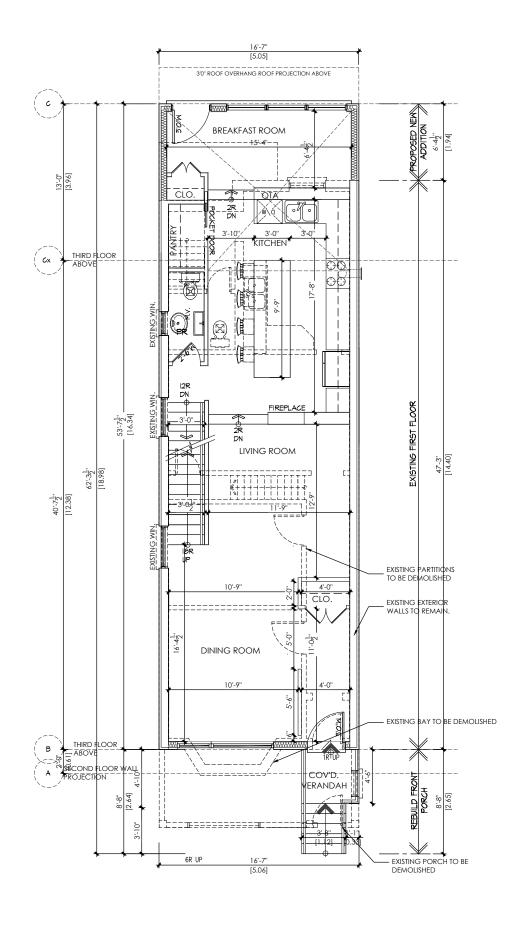

S.B. SOLID WOOD BEARING

F.D. FLOOR DRAIN

A.D. AREA DRAIN

NEW PARTITIONS I.S.A.

INTERCONNECTED SMOKE ALARM

C.M.D CARBON MONOXIDE DETECTOR \odot

MECHANICAL VENTILATION

FIRST FLOOR PLAN A-3 SCALE: 3/16"=1'-0"

EXISTING FIRST FLOOR AREA: 73.20 m2 (787.91 SQ. FT.) PROPOSED FIRST FLOOR AREA: 9.69 m2 (104.28 SQ. FT.) TOTAL FIRST FLOOR AREA: 82.89 m2 (892.19 SQ. FT.)

	EXISTING PERIMETER TO REMAIN			
EVICTING MALL	EXISTING WALL	EXISTING WALL	% OF WALL AREA TO	
LAIDIINO MALL	LENGTH	LENGTH REMAINING	REMAIN	
EAST (FRONT)	228"	0	0%	
WEST (REAR)	219"	0	0%	
NORTH	567"	567"	100%	
SOUTH	567"	567"	100%	
TOTAL:	1581"	1134"	71.72%	
	WEST (REAR) NORTH SOUTH	EXISTING WALL EAST (FRONT) PEST (FRONT) PEST (REAR) NORTH SOUTH 561" SOUTH 261"	EXISTING WALL EAST (FRONT) WEST (REAR) NORTH SOUTH 567" 567" 567"	

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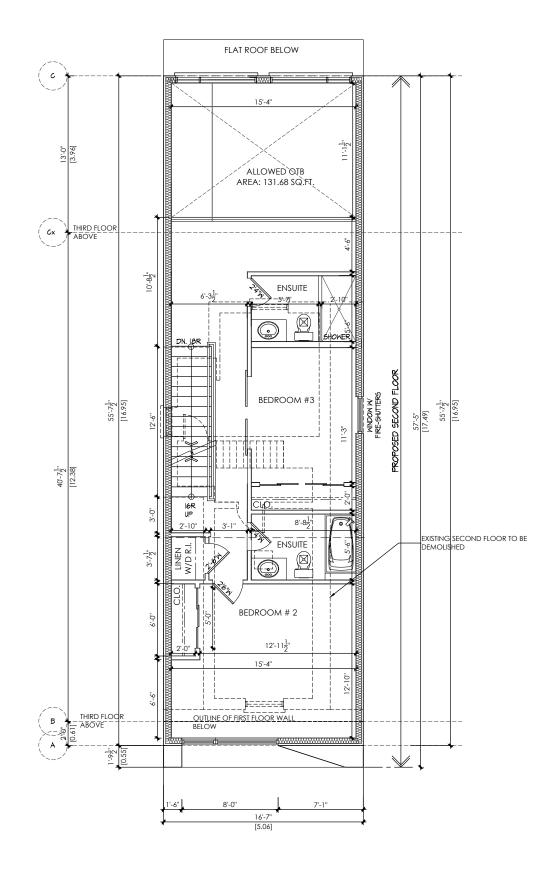
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MARIN ZABZUNI NAME SIGNATURE

NAME SIGNATURE
REGISTRATION INFORMATION
Required unless design is exempt under 3.2.4.7. Division C of the Ontario Building Code. CONTEMPO STUDIO FIRM NAME 46972 BCIN

DO NOT SCALE DRAWINGS CONTRACTOR SHALL CHECK AND VERIFY ALL DIMENSIONS AND REPORT ANY OMISSIONS OR DISCREPANCIES TO CONTEMPO STUDIO BEFORE PROCEEDING WITH WORK. ALL PRINTS AND SPECIFICATIONS ARE THE PROPERTY OF CONTEMPO	DRAWING FIRST FLOOR PLAN		
STUDIO AND SHALL NOT BE COPIED, IN PART OR WHOLE WITHOUT PRIOR WRITTEN PERMISSION	SCALE	DRAWN BY	
PROJECT	AS-NOTED	M.Z.	
PROPOSED 3 STOREY ADDITION &INTERIOR ALTERATIONS	DATE	APPROVED BY	
AT	MAR.24,2018	M.Z.	
14 GOUGH AVE	PROJECT No.	DRAWING No.	
CITY OF TORONTO	2017-01	A-3	





S.B. SOLID WOOD BEARING

F.D. FLOOR DRAIN

A.D. AREA DRAIN

NEW PARTITIONS

I.S.A.

INTERCONNECTED SMOKE ALARM

C.M.D \odot

CARBON MONOXIDE DETECTOR

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MECHANICAL VENTILATION

SECOND FLOOR PLAN SCALE: 3/16"=1'-0"

EXISTING 2ND FLOOR AREA: 36.78 m2 (395.95 SQ. FT.) PROPOSED 2ND FLOOR AREA: 49.82 m2 (536.32 SQ. FT.) ALLOWED OTB AREA: 12.23 m2 (131.68 SQ. FT.) TOTAL 2ND FLOOR AREA: 73.45 m2 (790.59 SQ. FT.)

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QUALIFICATION INFORMATION

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MARIN ZABZUNI NAME SIGNATURE NAME SIGNATURE
REGISTRATION INFORMATION
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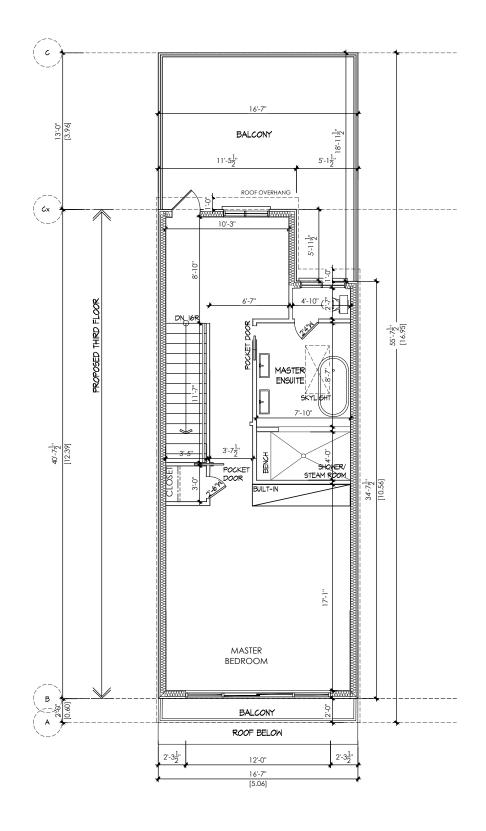
CONTEMPO STUDIO FIRM NAME 46972 BCIN

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STUDIO AND SHALL NOT BE COPIED, IN PART OR WHOLE WITHOUT PRIOR WRITTEN PERMISSION	SCALE	DRAWN BY	
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&INTERIOR ALTERATIONS	DATE	APPROVED BY	
	MAR.24,2018	M.Z.	
AT			
14 GOUGH AVE	PROJECT No.	DRAWING No.	

2017-01

A-4





S.B. SOLID WOOD BEARING

F.D. FLOOR DRAIN

A.D. AREA DRAIN

NEW PARTITIONS I.S.A.

INTERCONNECTED SMOKE ALARM

C.M.D CARBON MONOXIDE DETECTOR \odot

MECHANICAL VENTILATION

THIRD FLOOR PLAN A-5 SCALE: 3/16"=1'-0"

3RD FLOOR AREA: 57.72 m2 (621.29 SQ. FT.) GFA: 214.08 m2 (2,304.33 SQ. FT.)

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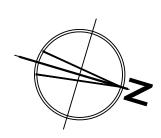
MARIN ZABZUNI NAME


SIGNATURE NAME SIGNATURE
REGISTRATION INFORMATION
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FIRM NAME 46972 BCIN

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STUDIO AND SHALL NOT BE COPIED, IN PART OR WHOLE WITHOUT PRIOR WRITTEN PERMISSION	SCALE	DRAWN BY
PROJECT	AS-NOTED	M.Z.
PROPOSED 3 STOREY ADDITION	DATE	APPROVED BY
&INTERIOR ALTERATIONS		
AT	MAR.24,2018	M.Z.
14 GOUGH AVE	PROJECT No.	DRAWING No.

2017-01

A-5



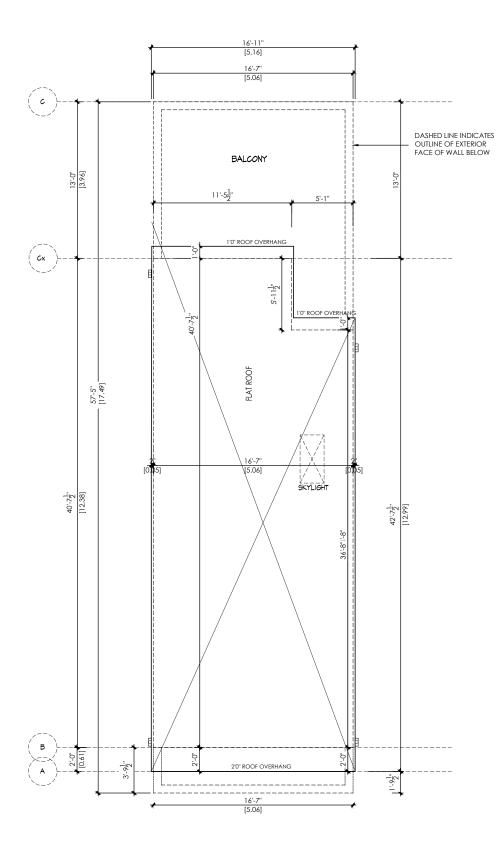

S.B. SOLID WOOD BEARING

F.D. FLOOR DRAIN

A.D. AREA DRAIN

NEW PARTITIONS

I.S.A. INTERCONNECTED SMOKE ALARM

C.M.D CARBON MONOXIDE DETECTOR

 \odot MECHANICAL VENTILATION

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QUALIFICATION INFORMATION

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ROOF PLAN

A-6 SCALE: 3/16"=1'-0"


CITY OF TORONTO

MARIN ZABZUNI
NAME SIGNATURE
REGISTRATION INFORMATION
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FIRM NAME 46972 BCIN

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STUDIO AND SHALL NOT BE COPIED, IN PART OR WHOLE WITHOUT PRIOR WRITTEN PERMISSION	SCALE	DRAWN BY	
PROJECT PROPOSED 3 STOREY ADDITION & INTERIOR ALTERATIONS AT	AS-NOTED	M.Z.	
	DATE	APPROVED BY	
	MAR.24,2018	M.Z.	
14 GOUGH AVE	PROJECT No.	DRAWING No.	

2017-01

A-6

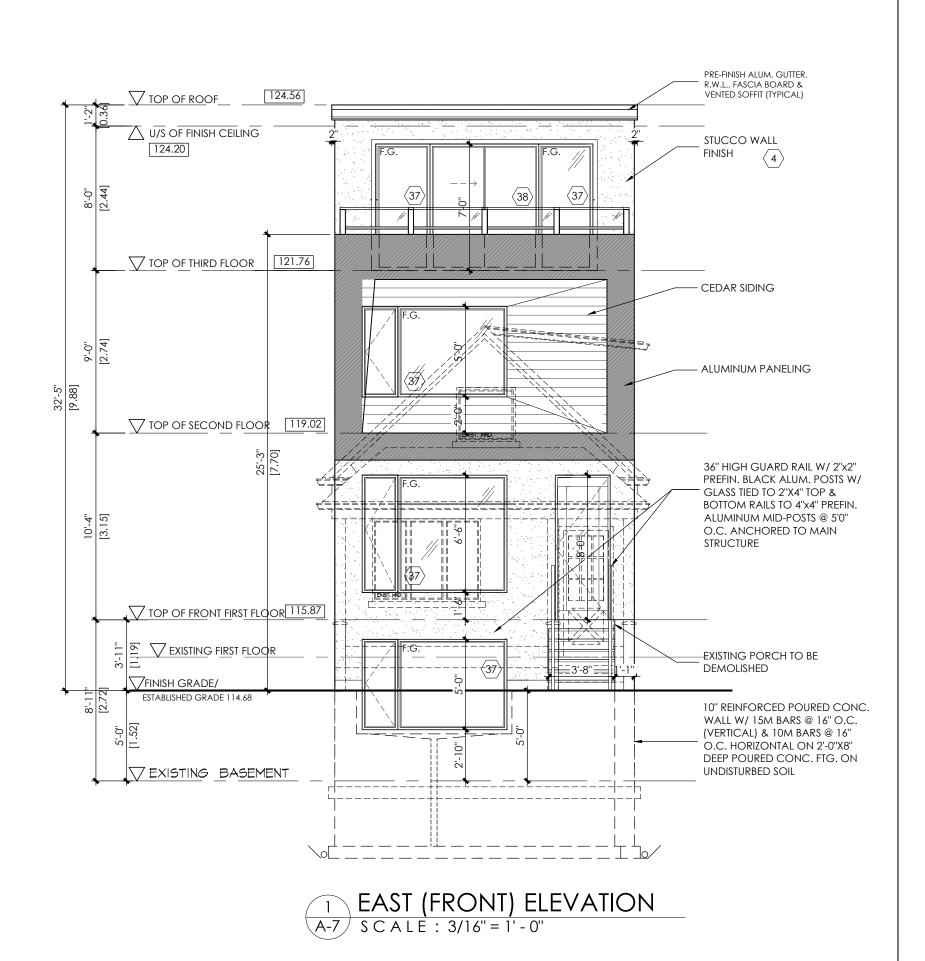

S.B. SOLID WOOD BEARING

F.D. FLOOR DRAIN

A.D. AREA DRAIN I.Ş.A.

 \bigcirc

INTERCONNECTED SMOKE ALARM

C.M.D CARBON MONOXIDE DETECTOR MECHANICAL VENTILATION

EXISTING EAST WALL AREA TO REMAIN			
EXISTING WALL AREA	WALL AREA	EXISTING WALL AREA	% OF WALL AREA TO
	REMOVED	REMAINING	REMAIN
380.02 SQ.FT.	380.02 SQ.FT.	0	0%
TOTAL EXISTING	TOTAL DEMOLISHED	TOTAL WALL AREA	TOTAL % OF WALL
WALL AREA	WALL AREA	REMAINING	AREA TO REMAIN
2628.39 SQ.FT.	1078.63 SQ.FT.	1549.76 SQ.FT.	58.96%

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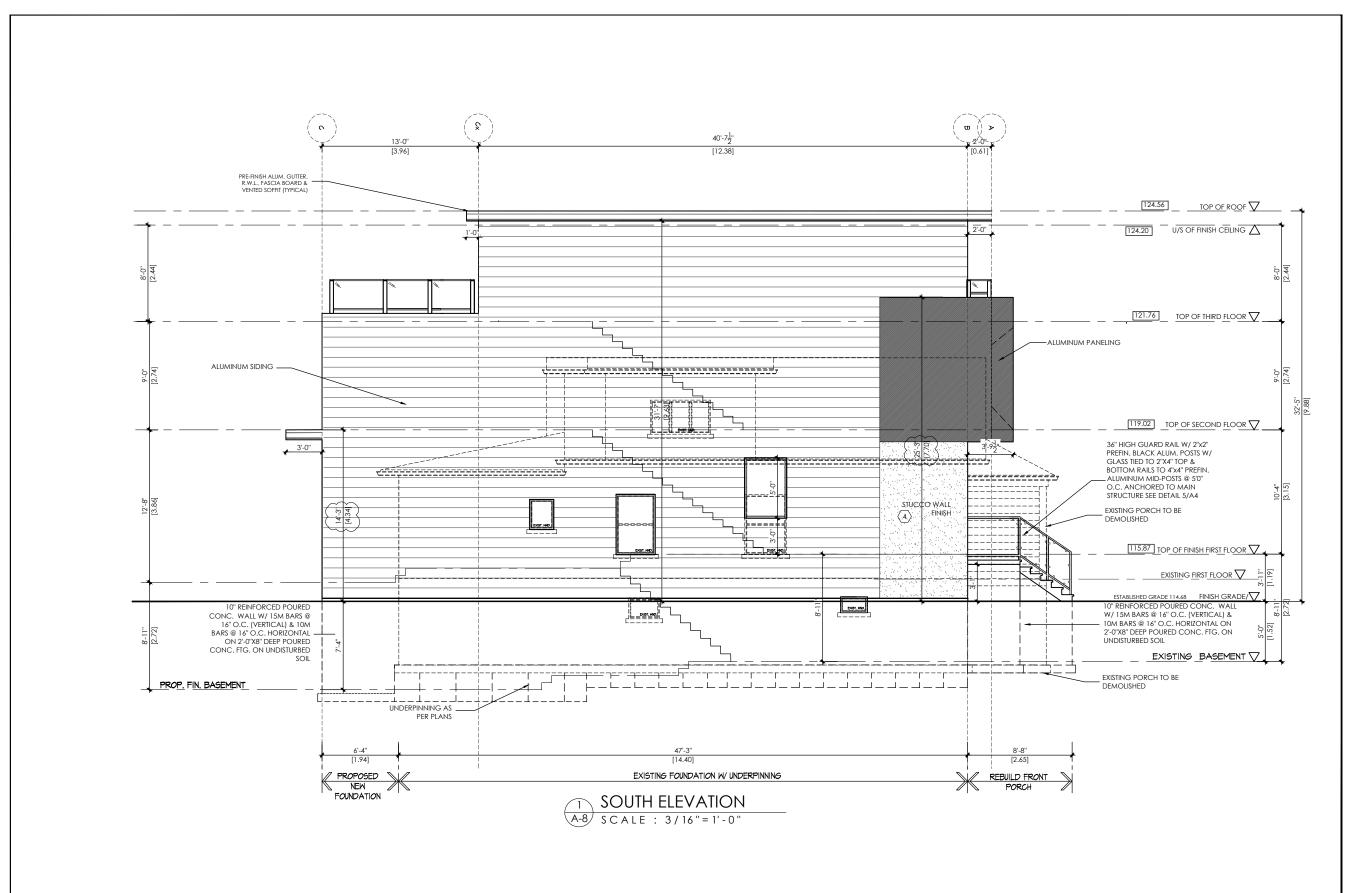
14 ARNOLD AVE. TORONTO, ONT., M6N 4M9 INFO@CONTEMPOSTUDIO.CA W. CONTEMPOSTUDIO.CA T. (416) 836-1042 F. (416) 485-1042

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QUALIFICATION INFORMATION Required unless design is exempt under 3.2.4.3.(5) Division C of

the Ontario Building Code.	
MARIN ZABZUNI	45250
NAME SIGNATURE	BCIN
REGISTRATION INFORMATION	
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CONTEMPO STUDIO	46972
FIRM NAME	BCIN

DO NOT SCALE DRAWINGS CONTRACTOR SHALL CHECK AND VERIFY ALL DIMENSIONS AND REPORT ANY OMISSIONS OR DISCREPANCIES TO CONTEMPO STUDIO BEFORE PROCEEDING WITH WORK. ALL PRINTS AND SPECIFICATIONS ARE THE PROPERTY OF CONTEMPO	DRAWING EAST ELEVATION		
STUDIO AND SHALL NOT BE COPIED, IN PART OR WHOLE WITHOUT PRIOR WRITTEN PERMISSION	SCALE	DRAWN BY	
PROJECT	AS-NOTED	M.Z.	
PROPOSED 3 STOREY ADDITION &INTERIOR ALTERATIONS	DATE	APPROVED BY	
AT	MAR.24,2018	M.Z.	
14 GOUGH AVE	PROJECT No.	DRAWING No.	
CITY OF TORONTO	2017-01	A-7	



EXISTING WALL AREA WALL AREA REMOVED REMAINING REMAIN REMAINING AREA TO REMAINING AREA TO REMAINING REMAININ	EXISTING SOUTH WALL AREA TO REMAIN				
TOTAL EXISTING TOTAL DEMOLISHED TOTAL WALL AREA TOTAL % OF WALL WALL AREA WALL AREA REMAINING AREA TO REMAIN	EXISTING WALL AREA				
WALL AREA WALL AREA REMAINING AREA TO REMAIN	993.30 SQ.FT.	218.81 SQ.FT.	774.46 SQ.FT.	77.97%	

4 7 E	46972 BCIN	Required unless design is exempt under 3.2.4.7. Division C of the Ontorio Building Code. CONTEMP STUDIO FIRM NAME
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≪	BCIN	NAME SIGNATURE
7 Y	45250	Marin zabzuni
PRC	c of	Required unless design is exempt under $3.2.4.3.(5)$ Division C of the Ontario Building Code.
STUD		attached documents: QUALIFICATION INFORMATION
REPO	nts set on the	design, and has the qualifications and meets the requirements set out in the Ontario Building Code to design the work shown on the
DO NO	his	The undersigned has reviewed and takes responsibility for this

14 ARNOLD AVE.
TORONTO, ONT., M6N 4M9
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W. CONTEMPOSTUDIO.CA
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F. (416) 485-1042

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V ZABZUNI 45250		
SIGNATURE BCIN	~	& INTERIOR ALTERATIONS
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NAME	5	

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MAR.24,201


SOUTH ELEVATION

E THE PROPERTY OF CONTEMPC N PART OR WHOLE WITHOUT

AS-NOTED

A-8

2017-01

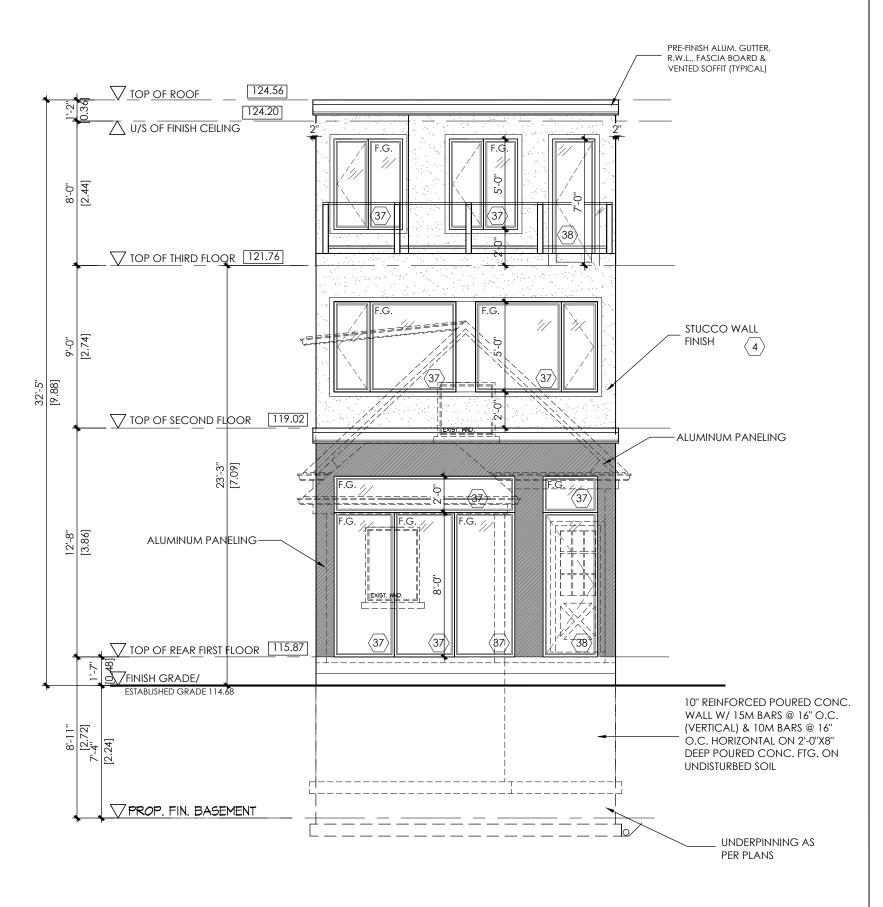

WEST (REAR) ELEVATION A-9 SCALE: 3/16"=1'-0"

LEGEND

 \triangleleft

S.B. SOLID WOOD BEARING

F.D. FLOOR DRAIN

A.D. AREA DRAIN

I.S.A. INTERCONNECTED SMOKE ALARM

C.M.D CARBON MONOXIDE DETECTOR MECHANICAL VENTILATION

EXISTING WEST WALL AREA TO REMAIN				
EXISTING WALL AREA	WALL AREA	EXISTING WALL AREA	% OF WALL AREA TO	
EXISTING TO LE TILET	REMOVED	REMAINING	REMAIN	
380.02 SQ.FT.	380.02 SQ.FT.	0	0%	
TOTAL EXISTING	TOTAL DEMOLISHED	TOTAL WALL AREA	TOTAL % OF WALL	
WALL AREA	WALL AREA	REMAINING	AREA TO REMAIN	
<u>2628.39 SQ.FT.</u>	1078.63 SQ.FT.	1549.76 SQ.FT.	<u>58.96%</u>	

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design, and has	the qualifications io Building Code to ents:	and mee	ts the re	quiremen	s set
	QUALIFICATION I	INFORMA'	TION		
Required unless the Ontario Build	design is exempt u ling Code.	under 3.2	1.4.3.(5)	Division C	of
MARIN ZABZUNI					45250
NAME		SIGNATU	JRE		BCIN
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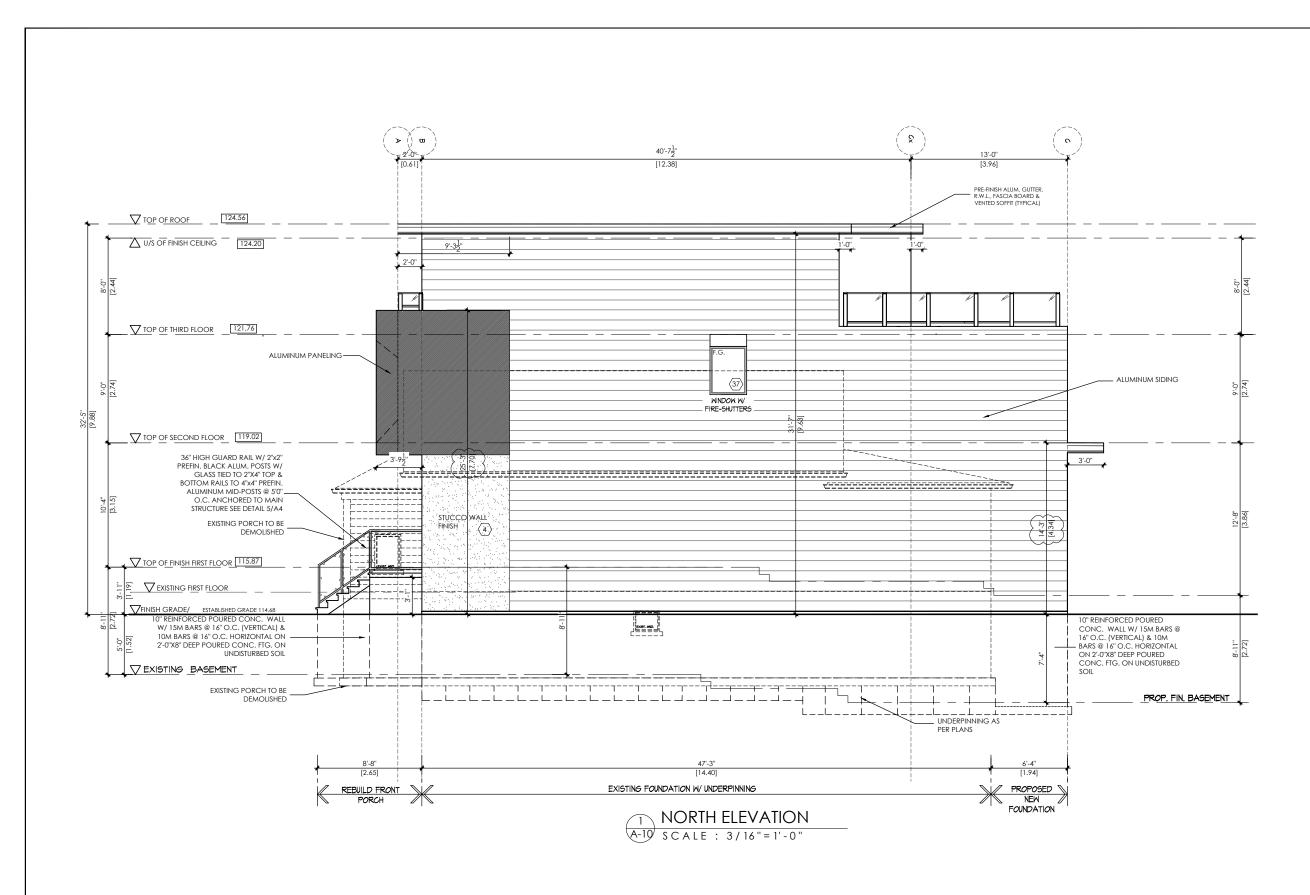
Required unless design is exempt under 3.2.4.7. Division C of the Ontario Building Code.

46972 BCIN


CONTEMPO STUDIO FIRM NAME

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14 GOUGH AVE	PROJECT No.	DRAWING No.	
CITY OF TORONTO	2017-01	A-9	



EXIS	STING NORTH WA	LL AREA TO REN	MAN
EXISTING WALL AREA	WALL AREA	EXISTING WALL AREA	% OF WALL AREA TO
EXISTING MALL AREA	REMOVED	REMAINING	REMAIN
875.09 SQ.FT.	99.78 SQ.FT.	775.30 SQ.FT.	88.60%
TOTAL EXISTING	TOTAL DEMOLISHED	TOTAL WALL AREA	TOTAL % OF WALL
WALL AREA	WALL AREA	REMAINING	AREA TO REMAIN
2628.39 SQ.FT.	1078.63 SQ.FT.	1549.76 SQ.FT.	58.96%

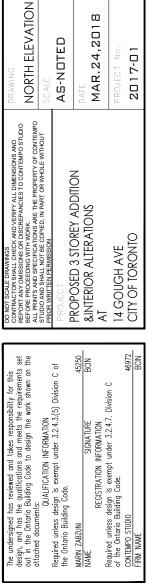

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Attachment 2

14 Gough Avenue Requested Minor Variances

Zoning By-law 569-2013

1. Chapter 10.10.40.40.(1)(A)

The maximum permitted floor space index of a detached dwelling is 0.6 times the area of the lot (122.33 m^2) .

The altered detached dwelling will have a floor space index of 1.05 times the area of the lot (214.08 m^2) .

2. Chapter 10.10.40.10.(2)(A)(i) & (ii)

The maximum permitted height of all front and rear exterior main walls is 7.5 m.

The height of the front and rear exterior main walls will be 9.68 m.

Zoning By-law 438-86

3. <u>Section 6(3) Part I 1</u>

The maximum permitted gross floor area of a detached dwelling is 0.6 times the area of the lot (122.33 m^2) .

The altered detached dwelling will have a gross floor area of 1.05 times the area of the lot (214.08 m^2) .

Section 6(3) Part II 3(II)

The minimum required setback from the side wall of an adjacent building that contains openings is 1.2 m.

The altered detached dwelling will be located 1.12 m from the side wall of the north adjacent building (16 Gough Avenue) and 1.08 m from the side wall of the south adjacent building (12 Gough Avenue).

Section 6(3) Part II 3.B(II)

The minimum required side lot line setback for the portion of a detached dwelling not exceeding a depth of 17 m is 0.9 m.

The portion of the altered detached dwelling not exceeding a depth of 17m will be located 0.28 m from the north side lot line.